


"Korean BBQ"

435 E Big Beaver Rd Troy, MI 48083 06/28/2022 Permit Submission

			FLOOR	E	BASE	WALL		CEILING			_
NO.	ROOM NAME	MAT'L	FIN.	MAT'L	FIN.	MAT'L	FIN.	MAT'L	FIN.	HEIGHT	REMARKS
01	EXISTING VESTIBULE	-	•	EXISTI	NG AND TO REM	лаіn. clean to "Like-nev	V" CONDITIOI	N. —			
02	DINING AREA	EPOXY	PRE-FIN.	VINYL	PRE-FIN.	BRICK TILE/ DRYWALL	PRE-FIN/ PAINTED	EXPOSED JOISTS	PAINTED		
03	PICK UP / CASHIER	EPOXY	PRE-FIN.	VINYL	PRE-FIN.	CERAMIC TILE	PRE-FIN	EXPOSED JOISTS	PAINTED		
04	SERVICE LINE	QUARRY TILE	PRE-FIN.	TILE	PRE-FIN.	DRYWALL	PAINTED	EXISTING AND TO REMAIN. CLEAN TO "LIKE-NEW" CONDITION			
05	PREP AREA	QUARRY TILE	PRE-FIN.	TILE	PRE-FIN.	DRYWALL	PAINTED	EXISTING AND TO REMAIN. CLEAN TO "LIKE-NEW" CONDITION			
06	WALK IN COOLER	-			В\	COOLER CONTRACTOR			-		
07	STORAGE AREA	QUARRY TILE	PRE-FIN.	TILE	PRE-FIN.	DRYWALL	PAINTED	2x2 LAY-IN TILE IN 2x2 GRID	PRE-FIN	8'-0"	
80	HALLWAY	EPOXY	PRE-FIN.	VINYL	PRE-FIN.	DRYWALL	PAINTED	EXPOSED JOISTS	PAINTED		
09	B.F. LAV.	CERAMIC TILE	PRE-FIN.	TILE	PRE-FIN.	DRYWALL	PAINTED	DRYWALL	PAINTED		
10	EXISTING LAV.	-	EXISTING AND TO REMAIN. CLEAN TO "LIKE-NEW" CONDITION.								
11	EXISTING ELEC. RM.	-	EXISTING AND TO REMAIN. CLEAN TO "LIKE-NEW" CONDITION.								

NOTE:
1. FINISHES TO COMPLY WITH TYPICAL NOTES 2 & 3 ON SHEET A101.
2. VERIFY FINISH SCHEDULE WITH TENANT / OWNER.

		M	OUNTING SCHED	ULE			ADA
		WA	LL MOUNTED ACCESS	ORIES			
VARIES VARIES FIRE EXTINGUISHER VABIES FIRE EXTINGUISHER	FIN.FLR.LINE KEY SWITCH or	YAM FIN.FLR.LINE KEY SWITCH or	FIRE ALARM	ROOM NO. Text Graphic to be a min. of 1" & must be approved by Architect. FIN.FLR.LINE ROOM NAME	Text Graphic to be a min. of 1" & must be approved by Architect. FIN.FLR.LINE FIRE EXIT SIGN	XAM FIN.FLR.LINE	18" MIN.
& PANEL CABINETS	PUSH BUTTON FORWARD APPROACH	PUSH BUTTON PARALLEL APPROACH	PULL BOX	SIGN	@ ELEVATORS		
4" MIN. †† \ . — □ □	.84 ⊕ ⊕ ⊕	6'-8" MIN.	CLG. LINE	DESK - 4-10"	188"		48" MIN.
FIN.FLR.LINE ELECTRICAL OUTLETS	FIN.FLR.LINE MECH. CONTROLS	FIN.FLR.LINE EXIT LIGHT	CLOCK OUTLET	TELEPHONE WALL JACKS	LIGHT SWITCH or DIMMER		X=12" IF DOOR HAS BOTH A CLOSER & LATCH

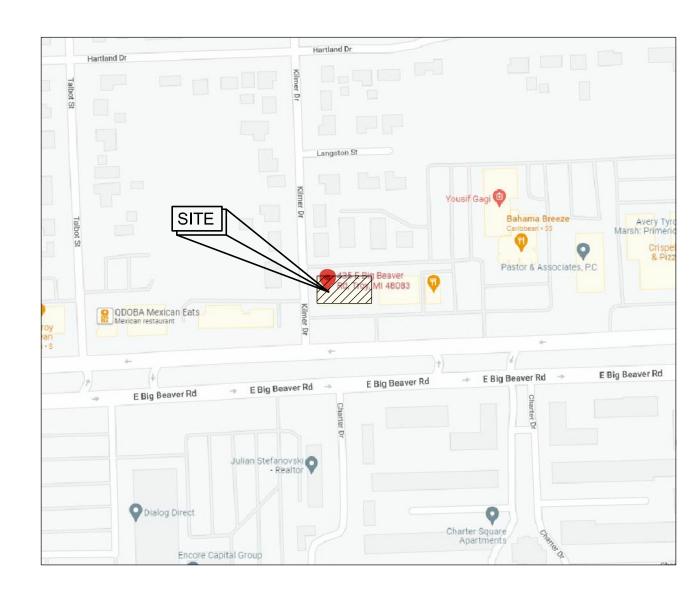



CODE COMPLIANCE:

2015 MICHIGAN BUILDING CODE (2015 IBC AS AMENDED)
2017 MICHIGAN ELECTRICAL CODE (NEC-2017 W/ PART 8
AMENDMENTS)
2015 MICHIGAN UNIFORM ENERGY CODE (CHAPTER 5 & PART
10A RULES (ASHRAE 90.1-2007))
2015 MICHIGAN MECHANICAL CODE (2015 IMC AS AMENDED)
2018 MICHIGAN PLUMBING CODE (2018 IPC AS AMENDED)
2015 INTERNATIONAL FUEL GAS CODE, IFGC 2015 ACCESSIBILITY:
MICHIGAN BARRIER FREE DESIGN LAW, P.A. 1966 AS AMENDED AND
THE 2009 ICC/ANSI 117.1 STANDARD AS REFERENCED FROM
CHAPTER 11 OF THE 2015 MBC.
2013 NFPA 13 FIRE SUPPRESSION,
2013 NFPA 72 FIRE ALARM,
2018 NFPA 1 FIRE CODE

FIRE PROTECTION NOTES:

1. BUILDING AREA IS FULLY FIRE SUPPRESSED.

2. TENANT SPACE TO BE ADJUSTED AS REQUIRED BY TENANT LAYOUT,

CONTRACTOR TO SUBMIT PLANS TO BUILDING DEPARTMENT AND OWNER FOR APPROVAL.

3. FIRE ALARM PLANS TO BE SUBMITTED TO THE BUILDING DEPARTMENT, FIRE DEPARTMENT, OWNER AND OTHER AGENCIES FOR APPROVAL.

NOTE:
FIRE SUPPRESSION DRAWINGS FOR THE KITCHEN HOODS TO BE
SUBMITTED BY FIRE SUPPRESSION CONTRACTOR UNDER A SEPARATE
PERMIT.

OCCUPANCY CALCULATION (BASED ON 2015 MICHIGAN BUILDING CODE):

BY CODE:

DINING AREA = 32 SEATS = 32 PERSONS

PICK UP/ CASHER = 338 S.F. / 100 = 3 PERSON

STORAGE = 86 S.F. / 300 = 1 PERSON

PREP AREA = 262 S.F. / 100 = 3 PERSONS

SERVICE LINE = 207 S.F. / 100 = 2 PERSONS

WALK-IN COOLER = 68 S.F. / 300 = 1 PERSON

TOTAL = 42 PERSONS

SHEET S	SHEET SCHEDULE						
SHT. NO.	DESCRIPTION						
G001	COVER SHEET						
A100	EXISTING / DEMO FLOOR PLAN						
A101	PROPOSED FLOOR PLAN						
A102	EQUIPMENT PLAN						
A103	FINISH PLAN						
A111	BATHROOM DETAILS						
P101	PLUMBING FLOOR PLANS						
P102	PLUMBING SPECS & SCHEDULES						
P103	PLUMBING RISER DIA & DETAILS						
P104	GAS PLAN & DETAILS						
M101	MECHANICAL PLANS						
M102	MECHANICAL SPECS & SCHEDULES						
M103	ALTERNATE MECHANICAL PLAN						
E101	ELECTRICAL POWER PLAN						
E102	LIGHTING/ REFLECTED CEILING PLAN						
1	CAPTIVE AIR						
2	CAPTIVE AIR						
3	CAPTIVE AIR						
4	CAPTIVE AIR						
5	CAPTIVE AIR						
6	CAPTIVE AIR						



PROJECT NAME: KOREAN BBQ

Troy, MI 48083


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PERMIT SUBMISSION 06-28-22

435 E. BIG BEAVER TROY MI 48083



THE FIELD BY THE CONTRACTOR. THE CONTRACTOR IS SOLELY RESPONSIBLE FOR COORDINATION OF ALL DIMENSIONS.

JOB NO.	22-0987
D.B/C.B	R.A./P.D
ISSUANCES	
NO DESCRIPTION	DATE
1 PERMIT SUBMISSION	06/28/22

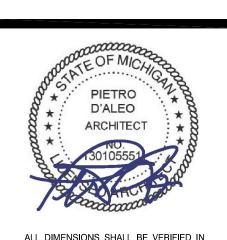SHEET TITLE
COVER SHEET

DWG. NO.


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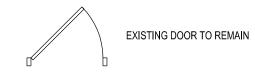
DEMO WALL LEGEND

_____ EXISTING WALL TO BE REMOVED

EXISTING WALL TO REMAIN

DEMO DOOR LEGEND



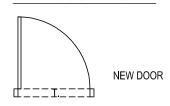






NOTES: GENERAL DEMOLITION

1. FIELD VERIFY ALL EXISTING CONDITIONS AND DIMENSIONS.

- 2. PROVIDE APPROPRIATE BARRICADES, SIGNAGE, AND OTHER SAFETY PRECAUTIONS SO AS TO PROTECT VISITORS, TRADESMAN, AND EXISTING REMAINING
- COMPLETELY REMOVE ALL WORK AND RELATED WORK IN AREAS DESIGNATED ON THE PLAN.
- 4. DISCONNECT, REMOVE, AND CAP ALL EXISTING UTILITIES AS INDICATED AND REQUIRED TO PERMIT NEW WORK. ALL WORK TO BE COMPLETED BY APPROPRIATE, EXPERIENCED TRADES (I.E. ELECTRICAL DEMOLITION BY ELECTRICIANS, ETC.)
- RESTORE EXISTING AREAS WHICH ARE DAMAGED DURING CONSTRUCTION. MATCH 5. EXISTING MATERIAL AND FINISHES.
- DO NOT USE EXPLOSIVES OR UNSAFE DEMOLITION METHODS.
- REMOVE ALL DEBRIS FROM THE SITE. DO NOT BURN REFUSE ON SITE. MATERIAL TO 7. BE DISPOSED TO AN APPROVED SITE.
- COORDINATE SALVAGEABLE ITEMS WITH THE OWNER. STORE SALVAGEABLE ITEMS 8. WITHIN DESIGNATED AREAS.

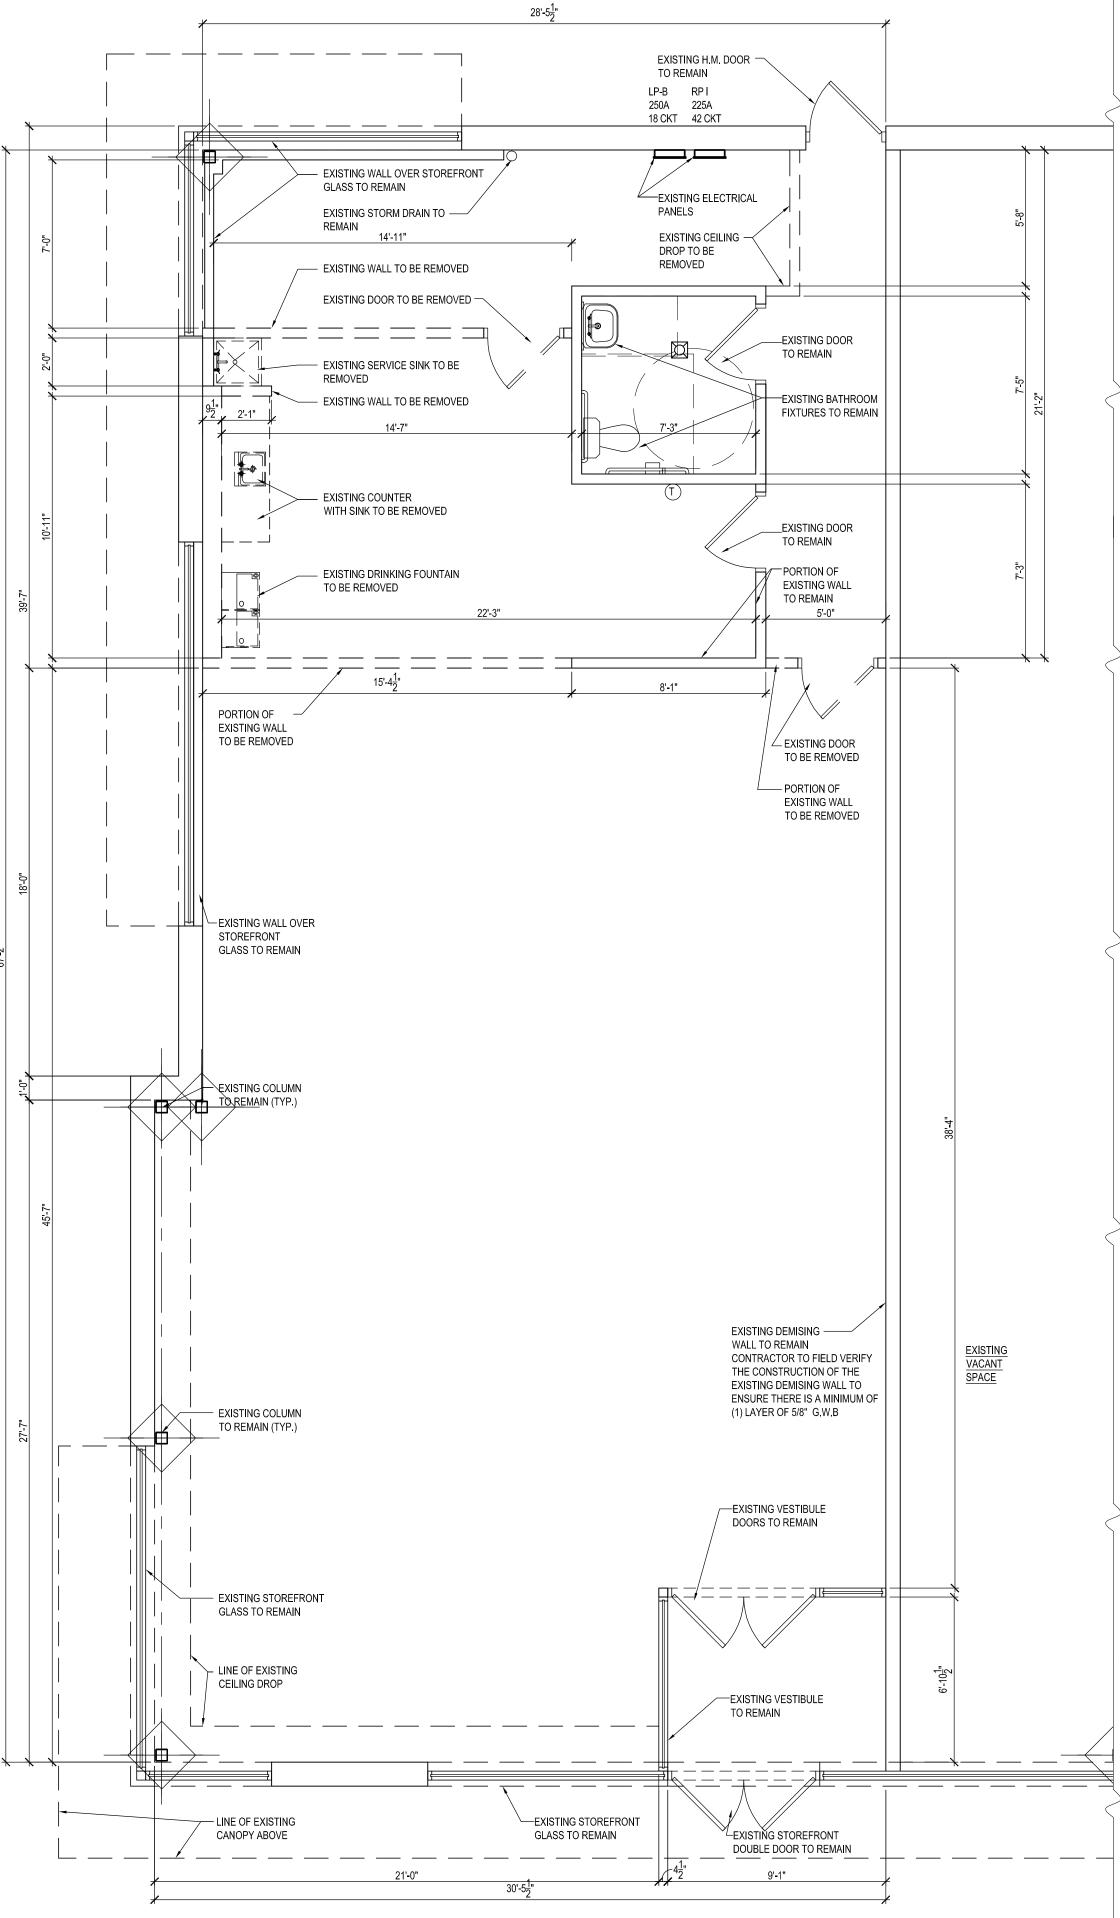

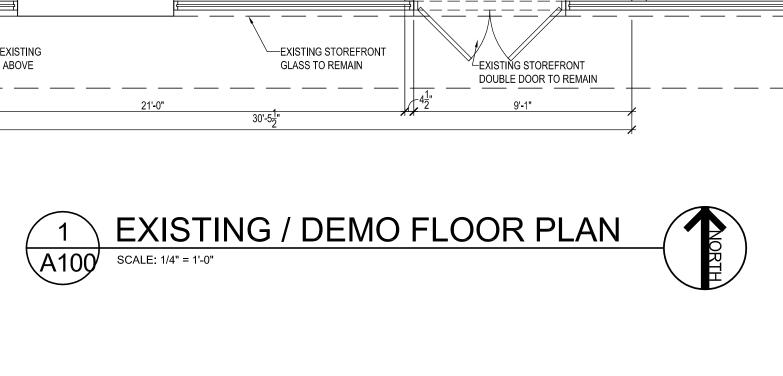

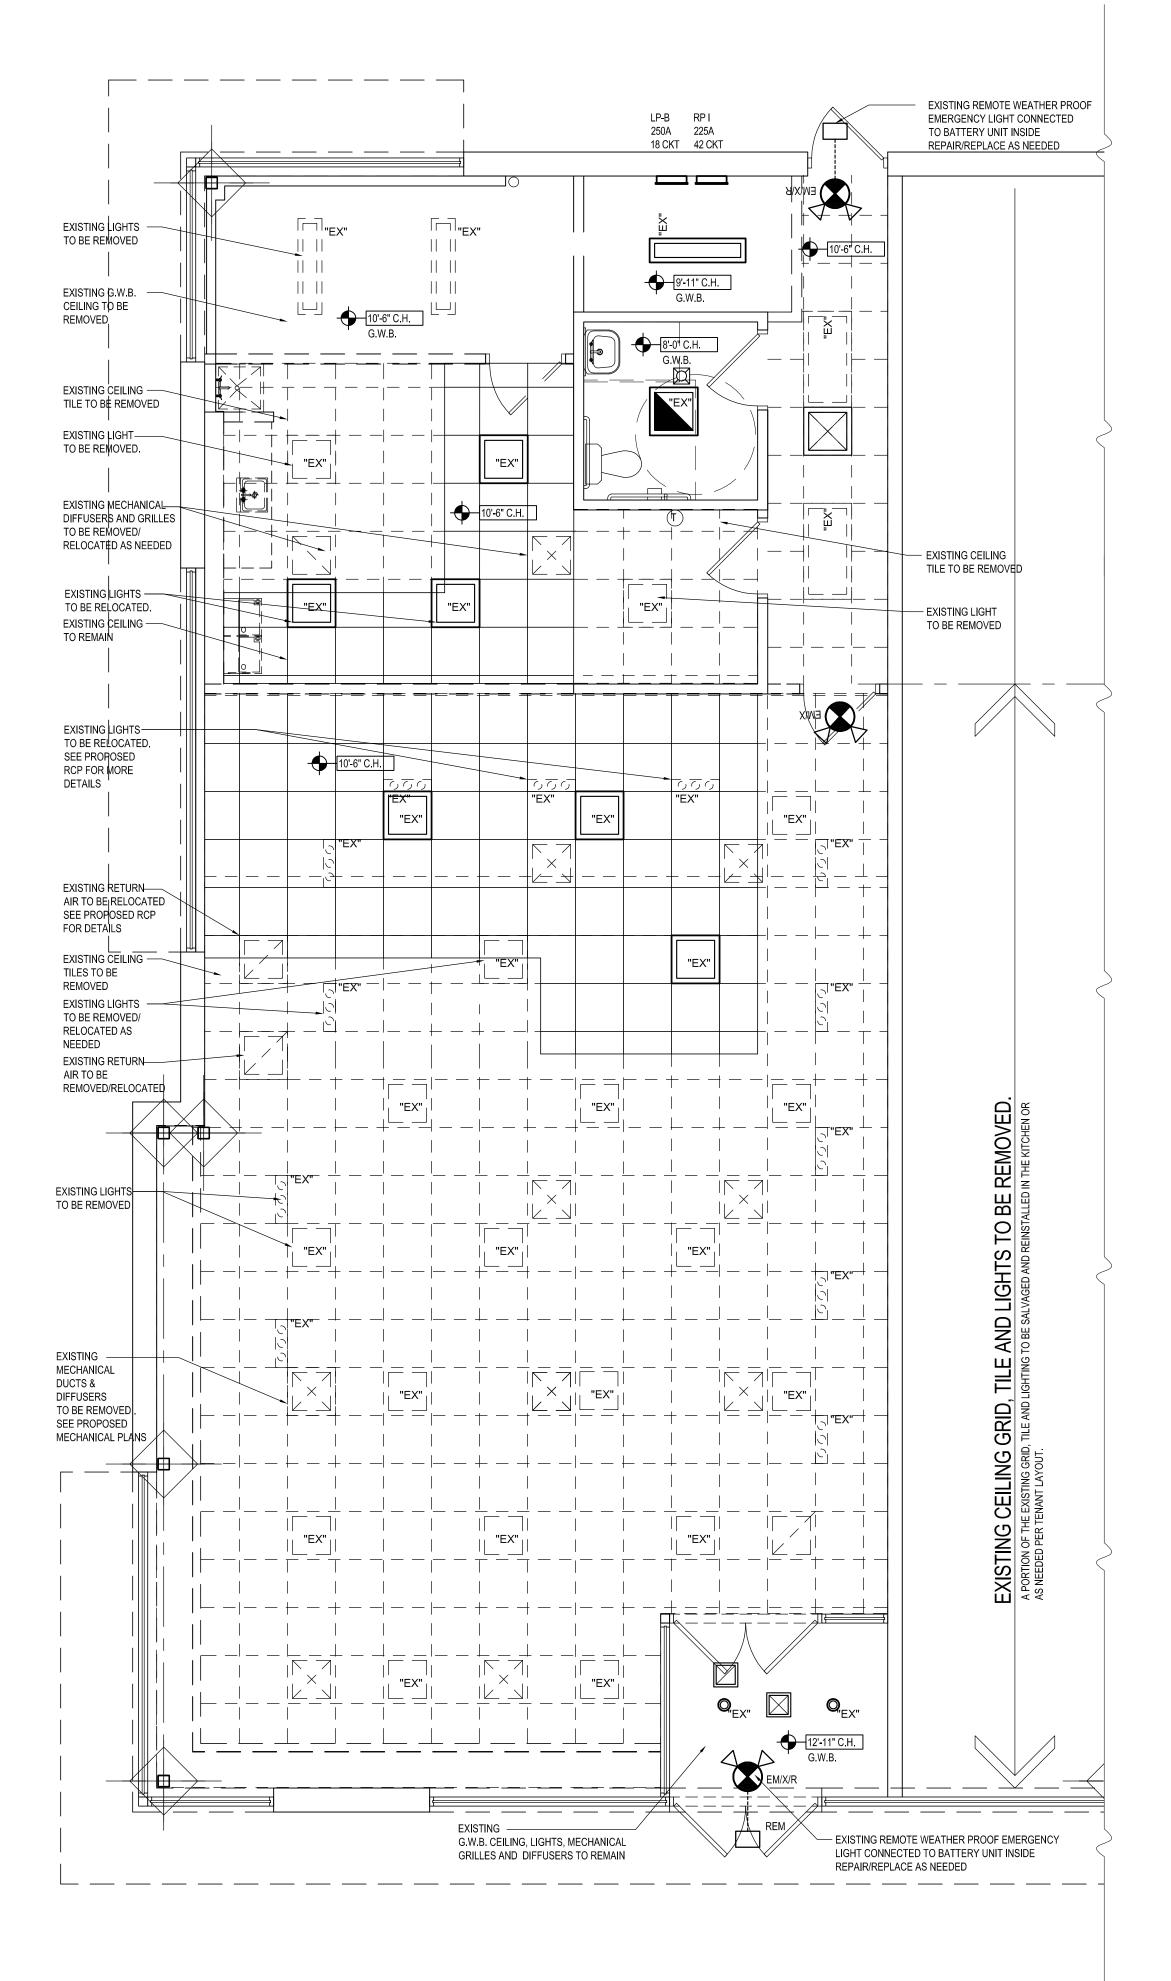



PROJECT NAME: **KOREAN BBQ**

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JOB NO.

R.A./P.D D.B/C.B ISSUANCES NO DESCRIPTION 1 PERMIT SUBMISSION 06/28/22

SHEET TITLE
EXISTING / DEMO FLOOR PLAN

DWG. NO.

2 EXISTING / DEMO REFLECTED CEILING PLAN
SCALE: 1/4" = 1'-0" A1.0.0

		WALL LEGEND		
SYMBOL	DESCRIPTION	ASSEMBLY	DETAIL	REMARKS
			SCALE: ½"=1'-0"	
P1	PROPOSED INTERIOR WALL	5/8" G.W.B. OVER 3-5/8" METAL STUDS @ 16" O.C. OVER 5/8" G.W.B.		
P2	PROPOSED INTERIOR WALL	5/8" G.W.B. OVER 3-5/8" 20 GA. METAL STUDS @ 16" O.C. W/ 3" SOUND INSULATION OVER 5/8" G.W.B.		
P3	PROPOSED WALL	WALK-IN COOLER / WALK-IN FREEZER WALL BY COOLER CONTRACTOR		

PARTITION CONDITION CODE
PARTITION TYPE SYMBOL
P1 PARTITION TYPE - SEE WALL LEGEND
FIRE RESISTANCE RATING (IN HOURS)
PARTITION CONDITION CODE - SEE ABOVE


DOOF	RSCHEDULE							
NO.	SIZE	THICK	MATERIAL	TYPE	FRAME	TYPE	HARDWARE SET	REMARKS
05	3'-0" x 7'-0"	1-3/4"	ALUMINUM	FLUSH	ELIASON	A	HARDWARE SUPPLIED AS PART OF DOOR PACKAGE	
06 3'-0" x 7'-0" BY COOLER CONTRACTOR								
11	3'-0" x 7'-0"	1-3/4"	WOOD	FLUSH	H.M.	В	#1	

NOTE:
1. DOORS & HARDWARE TO COMPLY WITH GENERAL NOTES ON SHEET A101. 2. ALL DOORS AND HARDWARE TO BE SELECTED & VERIFIED BY THE TENANT & OWNER. 3. DOOR HARDWARE BASED ON ALLEGION, PLC. OR EQUAL.

HARDWARE SETS

HARDWARE SET #1

1 17 (1	(011711)	<u> </u>			
3	EA	HINGE	5BB1 4.5 X 4.5	652	IVE
1	EA	STOREROOM LOCK	T581P DANE	626	FAL
1	EA	SURFACE CLOSURE	SC71 RW/PA	689	FAL
1	EA	WALL STOP	WS407CCV	626	IVE

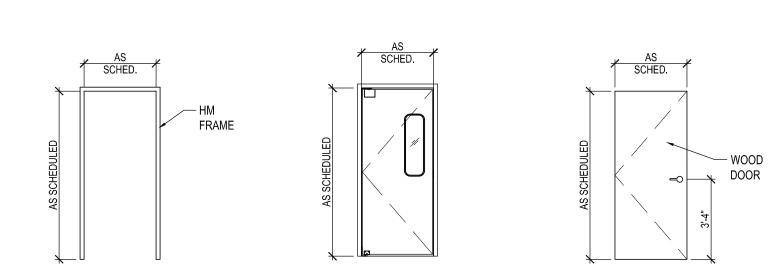

DOOR FRAME TYPE A: ELIASON TYPE B: WOOD 3 ELEVATION 4 DOOR ELEV. 5 DOOR ELEV. A101 SCALE: 1/4" = 1'-0" A101 SCALE: 1/4" = 1'-0" A101 SCALE: 1/4" = 1'-0"

TYPICAL NOTES:


- 1. HARDWARE SELECTED BY OWNER
- 2. ALL INTERIOR FINISH AND TRIM SHALL COMPLY W/ LOCAL ORDINANCES, CURRENT 2015 MICHIGAN BUILDING CODE SECTION, CHAPTER 8
- 3. CLASS C: FLAME SPREAD 76-200, SMOKE DEVELOPMENT 0-450. CONTRACTOR TO
- SUBMIT DOC'S AS REQUIRED. PRIOR TO INSTALLATION OF ANY PROPOSED APPLICABLE INTERIOR WALL AND CEILING FINISHES, PROVIDE TO THE CITY'S FIELD INSPECTOR
- DOCUMENTATION SHOWING THEIR CLASS, FLAME SPREAD AND SMOKE DEVELOPED INDEXES. 4. INSULATION FLAME SPREAD INDEX REQUIREMENTS SHALL
- BE IN ACCORDANCE WITH ASTM E 84. A. CONCEALED OR EXPOSED INSTALLATION SHALL HAVE RATING OF NOT MORE THAN 25. INSULATION BETWEEN 2 LAYERS OF NONCOMBUSTILE MATERIALS

W/O INTERVENING AIRSPACE SHALL BE ALLOWED TO HAVE A FLAME SPREAD INDEX OF NOT MORE THEN 100.


- B. SMOKE DEVELOPMENT INDEX RATING OF NOT
- C. ALL INSULATION TO BE PROPERLY LABELED
- 5. CONTRACTOR TO PROVIDE FIRE EXTINGUISHER
- ON JOB AS REQUIRED BY BUILDING INSPECTOR. 6. PROVIDE MIN. (2) 5# ABC EXTINGUISHES IN ACCORDANCE WITH NFPA 10 IN EACH TENANT SPACE. LOCATION TO BE VERIFIED WITH BUILDING INSPECTOR.
- 7. PROVIDE INTERNATIONAL SYMBOL FOR HANDICAPPED SIGNS FOR DIRECTION ON RESTROOM ACCESSIBILITY.
- 8. ALL GLAZING IN HAZARDOUS AREA SHALL BE SAFETY GLASS AND COMPLY WITH CURRENT M.B.C. SEC 2406.2 LABELS AND GLASS COMP. WITH CPSC 16CFR PART 1201.


GENERAL NOTES:


- 1. DOOR HANDLES, PULLS, LATCHES, LOCKS, AND OTHER OPERATIONS TO BE AT 48" A.F.F. MAX. AND 34" A.F.F. MIN.
- 2. DOORS TO HAZARDOUS AREAS TO HAVE HARDWARE W/ ROUGH FINISH
- 3. ALL EXIT DOORS TO HAVE PANIC DEVICE CLOSERS AND SHALL NOT LOCK AGAINST EGRESS OR OTHER HARDWARE COMPLYING W/ SEC. 008.1.8.
- 4. LOCKING DEVICES TO BE ACTIVATED BY NO MORE THEN ONE-HALF TURN, ACTIVATED BY LEVER TYPE.
- 5. ALL DOOR HANDLES TO BE LEVER TYPE.
- 6. ALL VERTICAL CHANGES IN FLOOR ELEVATION, INCLUDING DOOR THRESHOLDS, SHALL BE LIMITED TO 1/4" UNLESS A 1 TO 2 RISE-TO-RUN RATIO PROVIDED IN THE TRANSITION BETWEEN ELEVATIONS; IN WHICH A 1/2" MAX. DIFFERENCE IS ALLOWED. SAID CHANGES IN ELEVATION SHALL COMPLY WITH ICC/ANSI A117.1-2003.
- 7. ALL MILLWORK/CASEWORK COUNTERTOPS HAVE A MAXIMUM 34" HEIGHT A.F.F. UNLESS NOTED OTHERWISE.

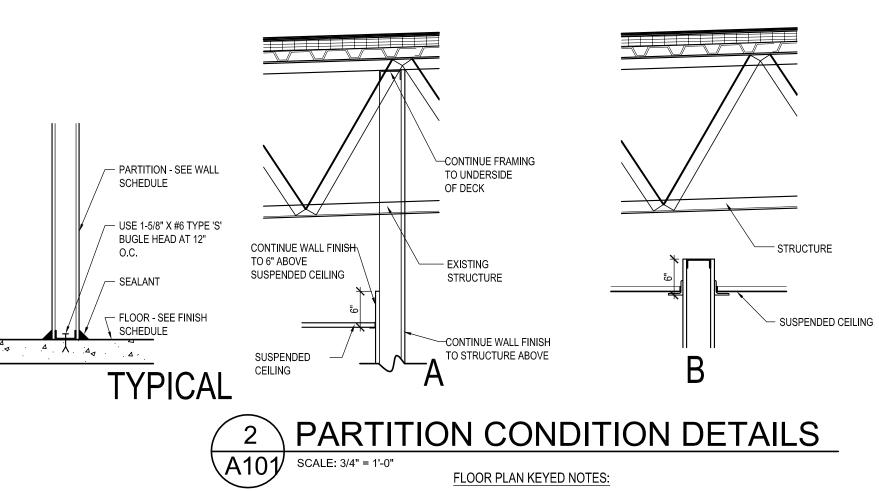


- EXISTING ELECTRICAL PANELS. SEE ELECTRICAL DRAWING FOR DETAILS.
- DINING SEATING BY OWNER/TENANT.
- WATER HEATER ABOVE. SEE PLUMBING DRAWINGS. KITCHEN HOOD, SEE EQUIPMENT & VENTILATION DRAWINGS.
- MILLWORK BY OWNER/TENANT. PROVIDE A MIN. 3'-0"W X 12"D B.F. COUNTER @ 34" A.F.F.
- 36"W x 12" H PASS THROUGH OPENING.
- REGISTER BY OWNER/TENANT. PRINTER BY OWNER/TENANT.
- PROVIDE PRIVACY LOCK AND SELF-CLOSURE FOR EXISTING DOOR.
- EXISTING RTU TO REMAIN.

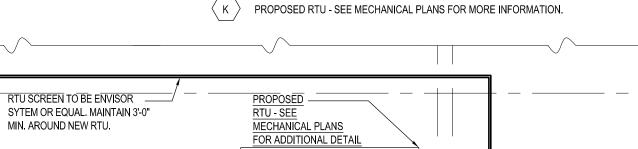

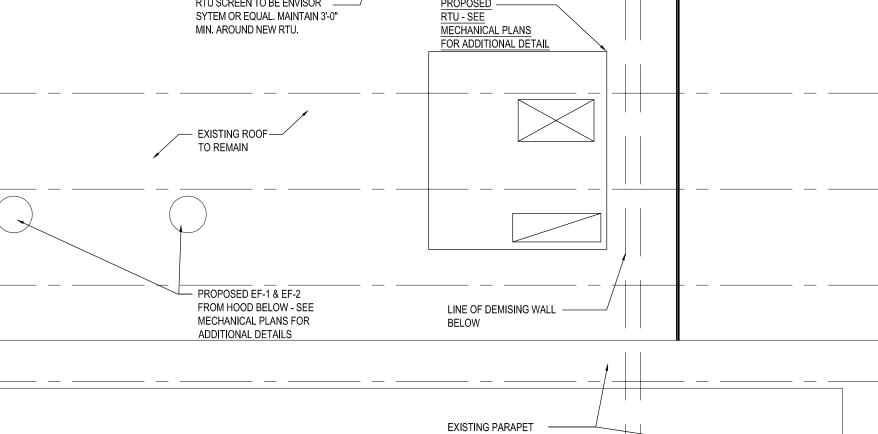

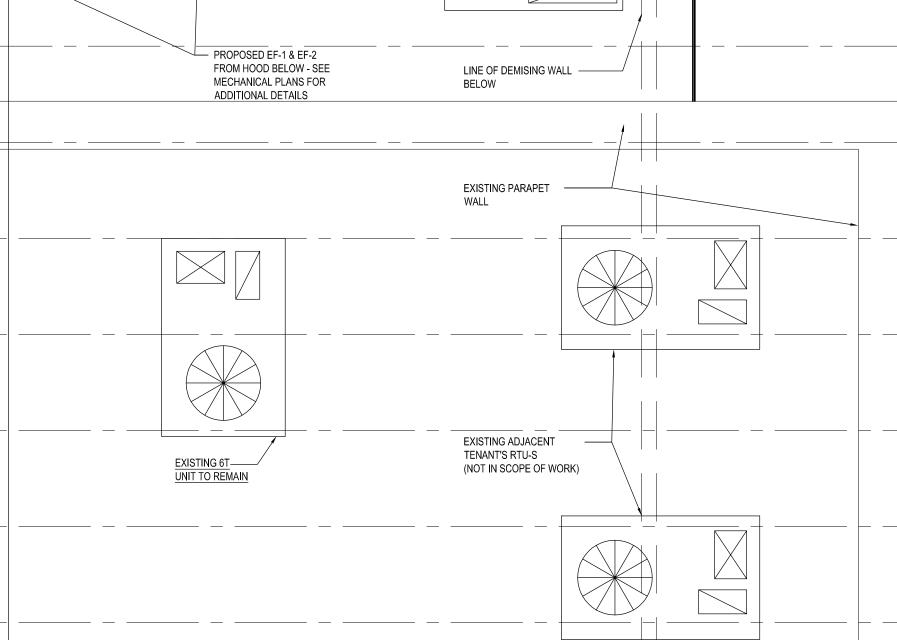

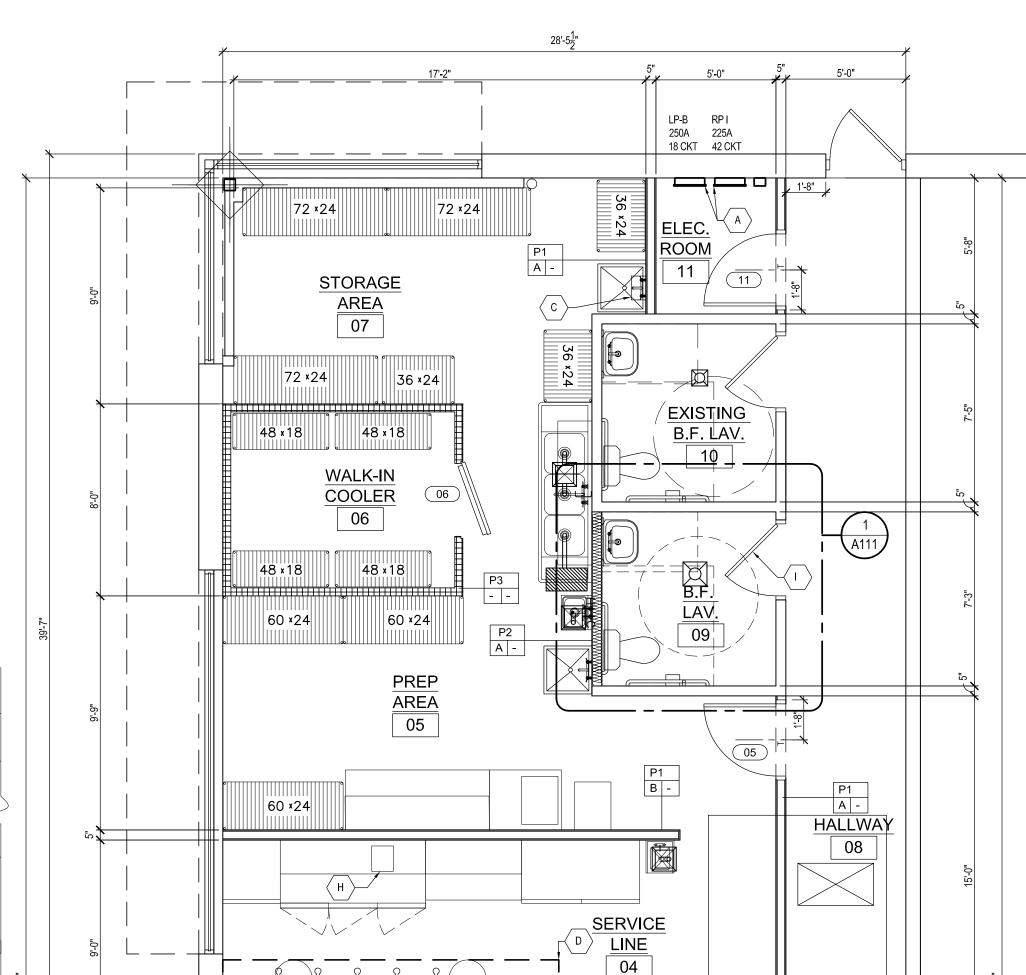

PICK UP/ CASHIER 03

EXISTING VESTIBULE

01



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PROJECT NAME: **KOREAN BBQ**

PERMIT SUBMISSION 06-28-22

435 E. BIG BEAVER TROY MI 48083



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JO	B NO.	22-0987		
D.B	/C.B	R.A./P.D		
ISS	SUANCES			
NO	DESCRIPTION	DATE		
_1	PERMIT SUBMISSION	06/28/22		
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SHEET TITLE PROPOSED FLOOR PLAN

DWG. NO.









02

(SEATING = 32 SEATS)


NO	ITEM NAME	MODEL	SIZE (W x D x H)	MANUFACTURER	BTU	QT	VOLTAGE	LOAD	PLUG
1	75LB FRYER	SG-18s	19.7 x 34.5 x 46.2	PITCO	140,000	5			
2	6 BURNER	ATHP-36-6	36.0 × 27.6 × 13.1	ATOSA	150,000	1			
3	48" CHEFBASE	ECB48D2	48.375 x 32.125 x 20	EVEREST		1	115V/ 60 HZ/ 1-PH	3.5 AMP	NEMA 5-15P
4	72" MEGA TOP	EPBR3	71.125 x 35.25 x 38.5	EVEREST		1	115V/ 60 HZ/ 1-PH	3 AMP	NEMA 5-15P
5	1 DOOR REACH IN FREEZER	ESF1	29.25 x 31.625 x 74.25	EVEREST		1	115V/ 60 HZ/ 1-PH	5 AMP	NEMA 5-15P
6	2 DOOR REACH IN FREEZER (60")	ESWF2	59.0 x 31.625 x 74.25	EVEREST		1	115V/ 60 HZ/ 1-PH	7.5 AMP	NEMA 5-20P
7	90" KEG COOLER	EBD4	89.25 x 27.0 x 37.25	EVEREST		1			
8	2 DOOR BEER 53"	EMGR48B	53.125 x 30.75 x 80.125	EVEREST		1	115V/ 60 HZ/ 1-PH	6 AMP	NEMA 5-15P
9	18 X 30" S/S WORK TABLE		18 x 30 x 34			1			
10	36 X 30" S/S EQUIPMENT STAND		36 x 30 x 26			1			
11	48 X 30" S/S WORK TABLE		48 x 30 x 34			1			
12	72 X 30" S/S WORK TABLE		72 x 30 x 34			1			
13	36 X 30" S/S WORK TABLE		36 x 30 x 34			1			
14	3 COMBINE SINK	TSA-3-12-D1	90 x 24 x 44.5	Turbo Air		1			
15	HAND SINK	HS-1615S	15.75 x 15.25 x 13.375	GSW USA		2			
16	1 PREP SINK	TSB-1-N	24 x 24	Turbo Air		1			
17	MOP SINK	TSA-1	18 x 18	Turbo Air		1			
18	BAR 3 SINK		48 x 18.75	Regency		1			
19	BAR HAND SINK					1			
20	ICE MAKER- L	UC-280-FA	26 x 27 x 39	Avantco		1	115V/ 60 HZ/ 1-PH	8.6 AMP	NEMA 5-15P
21	24 X 60" EPOXY WIRE SHELVES					3			
22	24 X 72" EPOXY WIRE SHELVES					5			
23	18 X 48" EPOXY WIRE SHELVES					4			
24	72" DOUBLE OVER SHELVES					3			
25	48" DOUBLE OVER SHELVES					1			
26	36" DOUBLE OVER SHELVES					1			
27	72" Wire Wall Shelves					1			
28	Vacuum Tumbler	VTS 42		Biro		1	115V/ 60 HZ/ 1-PH	DRIVE 0.61 AMP PUMP 4.20 AMP	3-PRONG PLUG
29	Oil Filter	PF80		Frymaster		1	120V/ 60HZ/ 1-PH	6.2 AMP	
30	COOKLINE HOOD LIGHTING	SEE VENTILATION		CAPTIVEAIRE CUSTOM		1	120V / 60HZ/ 1-PH/		
30A	EXHAUST	SEE VENTILATION		CAPTIVEAIRE CUSTOM		2	120V / 60HZ/ 1-PH/	8.9 FLA	
30B	MUA	SEE VENTILATION		CAPTIVEAIRE CUSTOM		1	208V / 3-PH/ 3-HP/	63.4 MCA	(DIRECT CONN.)
31	WALK-IN COOLER	SEE MANUF. DWG.		AMERIKOOLER		1	208V 1-HP		

NOTE:
VERIFY ALL EQUIPMENT AND EQUIPMENT
REQUIREMENTS WITH TENANT/OWNER.
CONTRACTOR TO FIELD VERIFY ALL WORK AND
NOTIFY THE OWNER, ARCHITECT AND FOOD
SERVICE SUPPLIER OF ANY DISCREPANCIES IN
THE DOCUMENTS, SPECIFICATION SHEETS AS
WELL AS ANY UNSEEN OR CHANGED FIELD
CONDITIONS. FOOD SERVICE EQUIPMENT
SUPPLIER TO VERIFY THAT SIZES INDICATED ON
THE DRAWING AND SITE CONDITIONS MEET THE
CRITERIA OF ITEMS SPECIFIED.

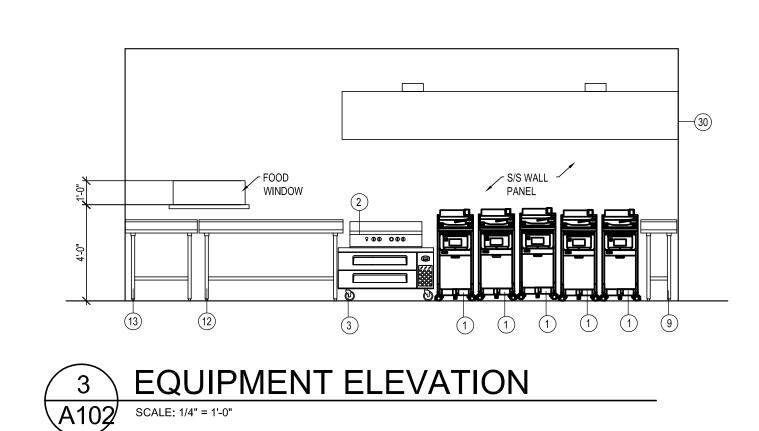

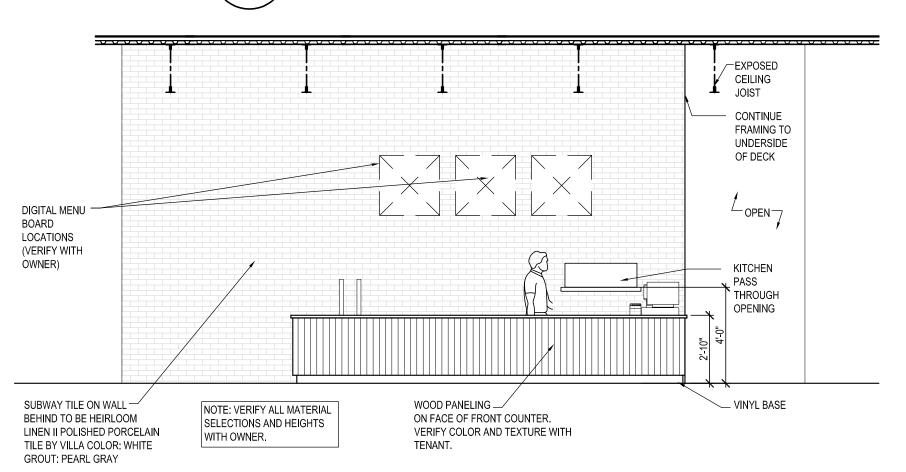



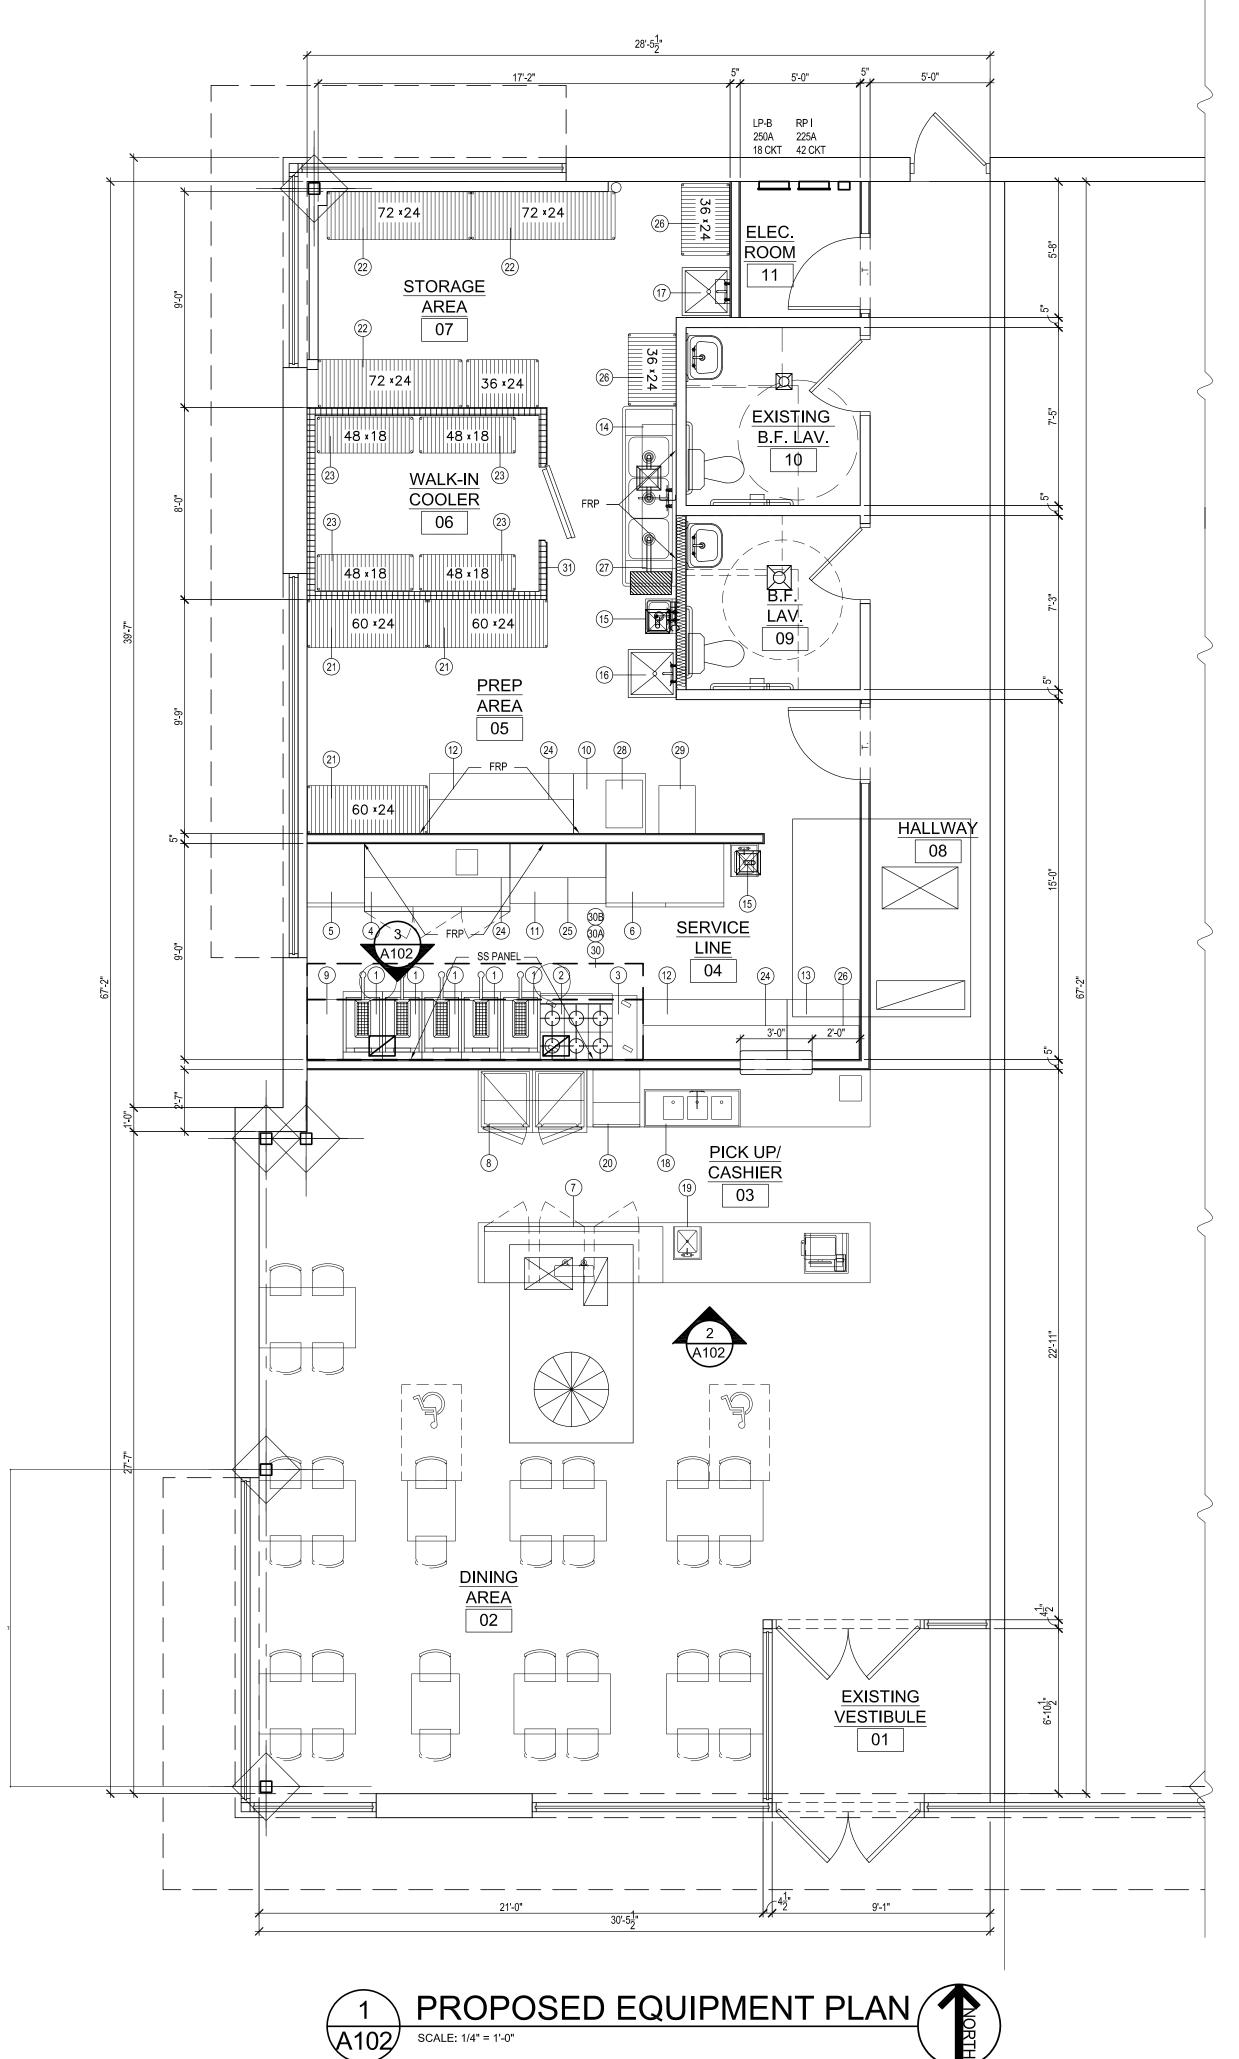

Architects

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PERMIT SUBMISSION

Troy, MI 48083

248.457.6903

PROJECT NAME:

KOREAN BBQ

06-28-22

435 E. BIG BEAVER

PIETRO D'ALEO ARCHITECT

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1 PERMIT SUBMISSION 06/28/22

22-0987

R.A./P.D

DATE

TROY MI 48083

JOB NO.

D.B/C.B

ISSUANCES

NO DESCRIPTION

SHEET TITLE
PROPOSED

DWG. NO.


EQUIPMENT PLAN

A1.0.2

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	FINISH SCHEDULE									
CODE	MATERIAL	MANUFACTURER	STYLE	NUMBER	COLOR	COMMENTS				
PA-01	PAINT	BENJAMIN MOORE	SCRUBBABLE EGGSHELL	2143-70	SIMPLY WHITE	WALLS				
PA-02	PAINT	BENJAMIN MOORE	SCRUBBABLE FLAT	1615	ROCK GRAY	CEILING				
PA-03	PAINT	MEODED	GOLMEX PLASTER	-	CONCRETE LOOK					
TL-01	BRICK TILE	BRICK IT	NEW YORK USED	-	NEW YORK USED	2-1/4"H x 7-5/8"L x 3/4" THICK				
TL-02	CERAMIC TILE	FLOOR & DECOR	CORTA GRAY CERAMIC TILE	-	GRAY	15" x 30", MATTE FINISH, GROUT & MORTAR INSTALLATION TYPE				
TL-03	TILE	FLOOR & DECOR	HEIRLOOM LINEN II POLISHED PORCELAIN TILE	-	WHITE	3" x 9", HIGH GLOSS FINISH, GROUT & MORTAR INSTALLATION TYPE				
G-1	GROUT	FLOOR & DECOR	19 PEARL GRAY KERACOLOR SANDED GROUT	-	PEARL GRAY					
QZ-01	QUARTZ	URBAN COUNTERTOP	METEOR SHOWER	-	BLACK					
W-01	WAINSCOT	CUSTOM	-	-	-	WAINSCOT UP TO 42" A.F.F.				
WC-01	WALL COVERING	CUSTOM	WALL GRAPHIC	-	-					

NOTE: COORDINATE WITH INSTALLER AS REQUIRED. VERIFY ALL MATERIALS WITH THE OWNER.



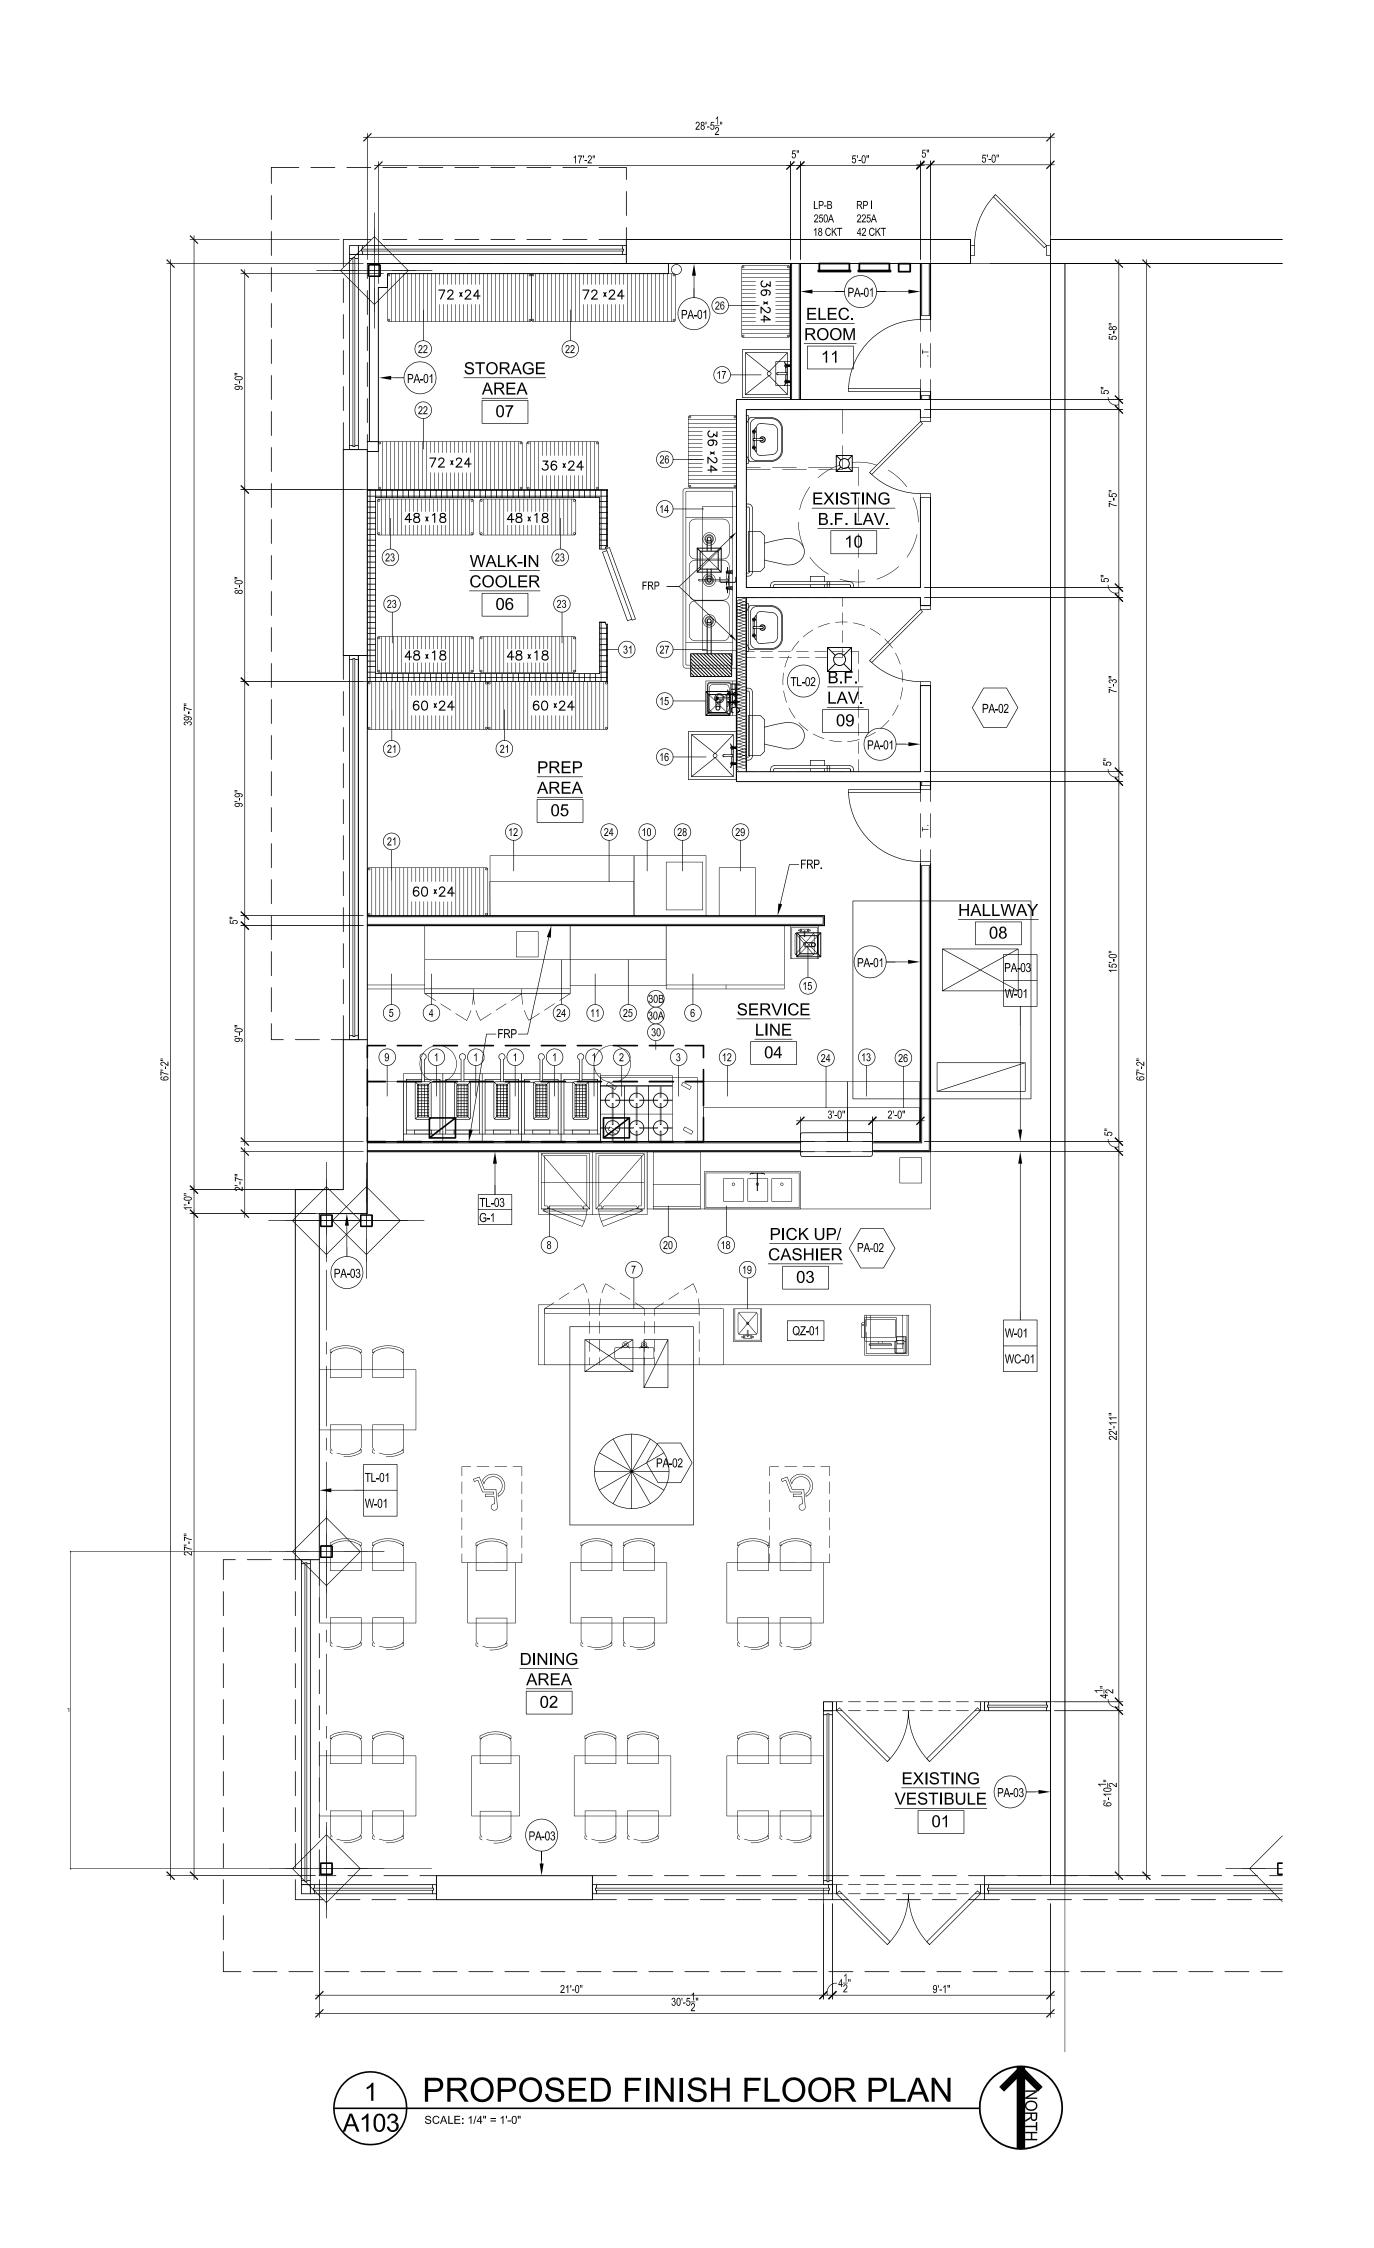

Architects
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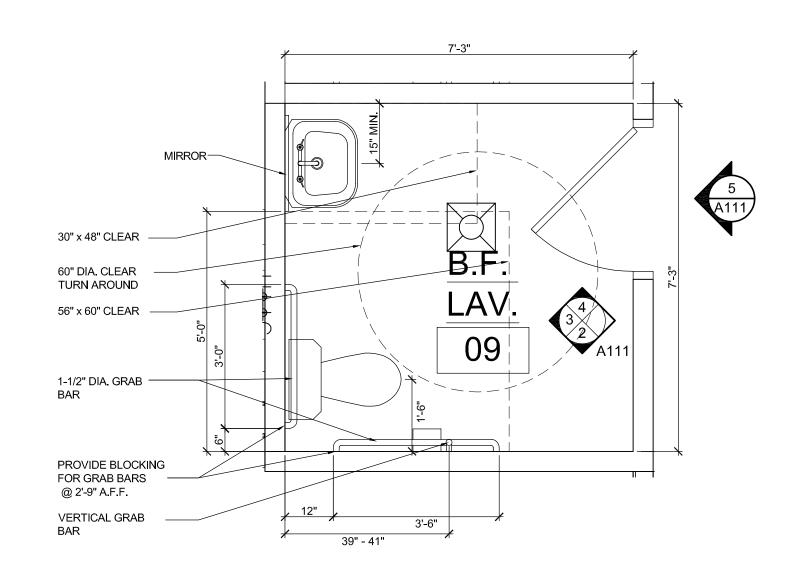
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D.B/C.B	R.A./P.
ISSUANCES	
NO DESCRIPTION	DATE
1 PERMIT SUBMISSION	06/28/2


PROPOSED
FINISH FLOOR
PLAN


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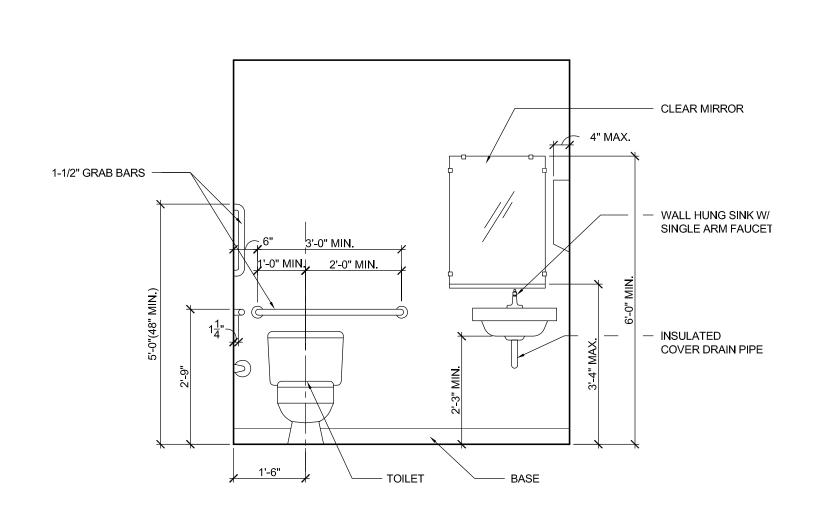









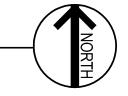


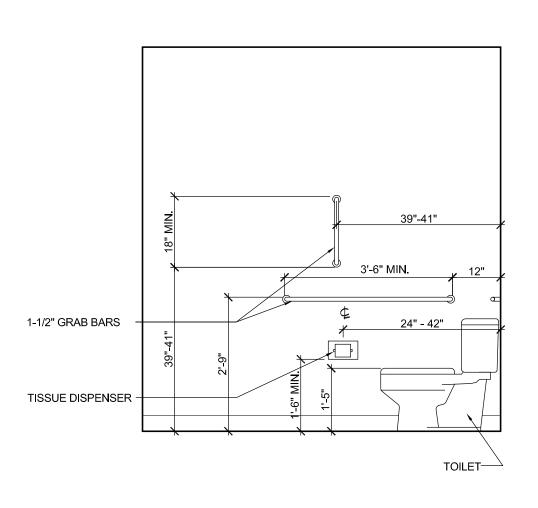



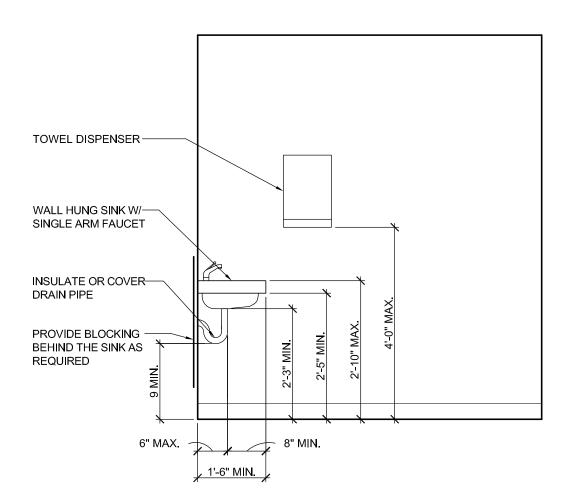



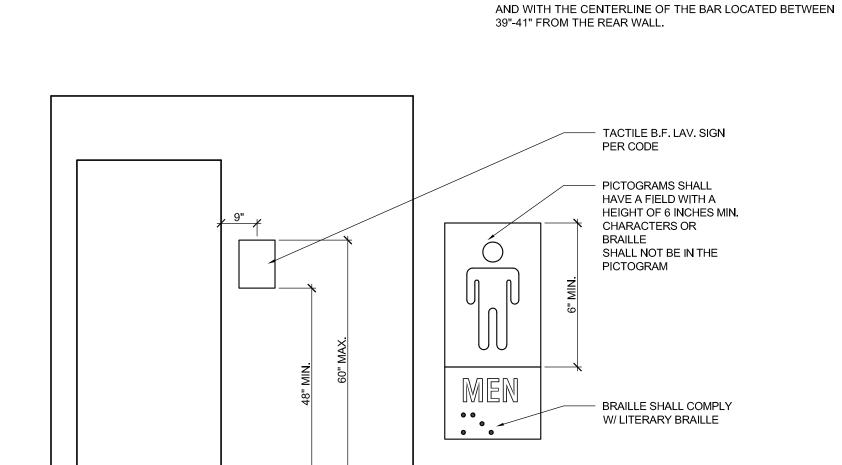

BARRIER FREE DESIGN NOTES FOR LAV'S:

3. WATER CLOSET MUST BE LOCATED 18" TO THE

PLUMBING CODE.

1. REQUIRED ACCESSIBLE TOILET FACILITIES SHALL

COMPLY WITH THE CHAPTER 11 OF MICHIGAN BUILDING CODE - 2015, ICC / ANSI A117.1-2015 AND MICHIGAN

2. PROVIDE TOILET ROOM ACCESS FOR MEN AND WOMEN WOMEN BARRIER FREE WITH A 5' X 5' CLEAR FLOOR SPACE AND 32" MINIMUM CLEAR DOOR OPENING.

CENTERLINE FROM THE ADJACENT WALL: THE SEAT MUST BE 17" ABOVE FINISH FLOOR AND FLUSH CONTROLS NOT HIGHER THAN 36" A.F.F.

4. LAVATORIES SHALL PROJECT A MINIMUM OF 17" FROM THE WALL WITH THE BOTTOM EDGE NOT LESS THAN 29" ABOVE THE FLOOR AND WITH A FRONT OPENING NOT LESS THAN 30" WIDE. MAXIMUM WATER TEMPERATURE OUTLETS NOT TO EXCEED 120 DEGREES FAHRENHEIT. FAUCETS SHALL BE LEVER OR PUSH-BUTTON TYPE. EXPOSED HOT WATER & DRAIN LINES TO BE INSULATED. 5. TOILET ROOM ACCESSORIES SHALL BE MOUNTED WITH

THE CONTROLS NO MORE THAN 40" ABOVE THE FLOOR.

MIRRORS SHALL BE INSTALLED NO MORE THAN 38" ABOVE THE FLOOR. ACCESSORIES SHALL NOT BE

6. TOILET PAPER DISPENSER SHALL BE MOUNTED 18" -

48" A.F.F. IF MOUNTED ABOVE GRAB BARS, LOCATE 24"-36" FROM REAR WALL. IF MOUNTED BELOW GRAB

7. PROVIDE SIGNS SHOWING INDICATION OF GENDER AND THE INTERNATIONAL SYMBOL FOR THE HANDICAPPED ON THE EXTERIOR OF THE DOORS; INSTALL ADJACENT

8. HORIZONTAL GRAB BARS ARE TO BE POSITIONED 33" TO 36"

ON THE NEAREST SIDE WALL, 12" FROM THE REAR WALL AND A MINIMUM 36" GRAB BAR ON THE REAR WALL, 6" FROM THE SIDE WALL, VERTICAL GRAB BARS SHALL BE 18" MIN. IN LENGTH AND SHALL BE MOUNTED WITH THE BOTTOM OF THE BAR LOCATED BETWEEN 39" AND 41" ABOVE THE FLOOR


MAXIMUM ABOVE THE FINISH FLOOR AND SHALL BE 42" LONG

LOCATED WITHIN 24" OF A CORNER.

BAR, LOCATE 24"-42" FROM REAR WALL.

TO THE LATCH SIDE OF THE DOOR.



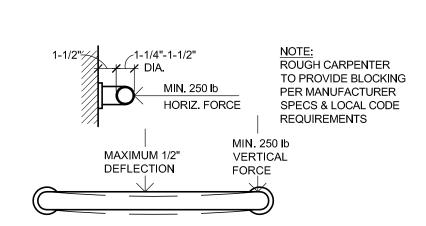





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PROJECT NAME: **KOREAN BBQ**

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435 E. BIG BEAVER TROY MI 48083



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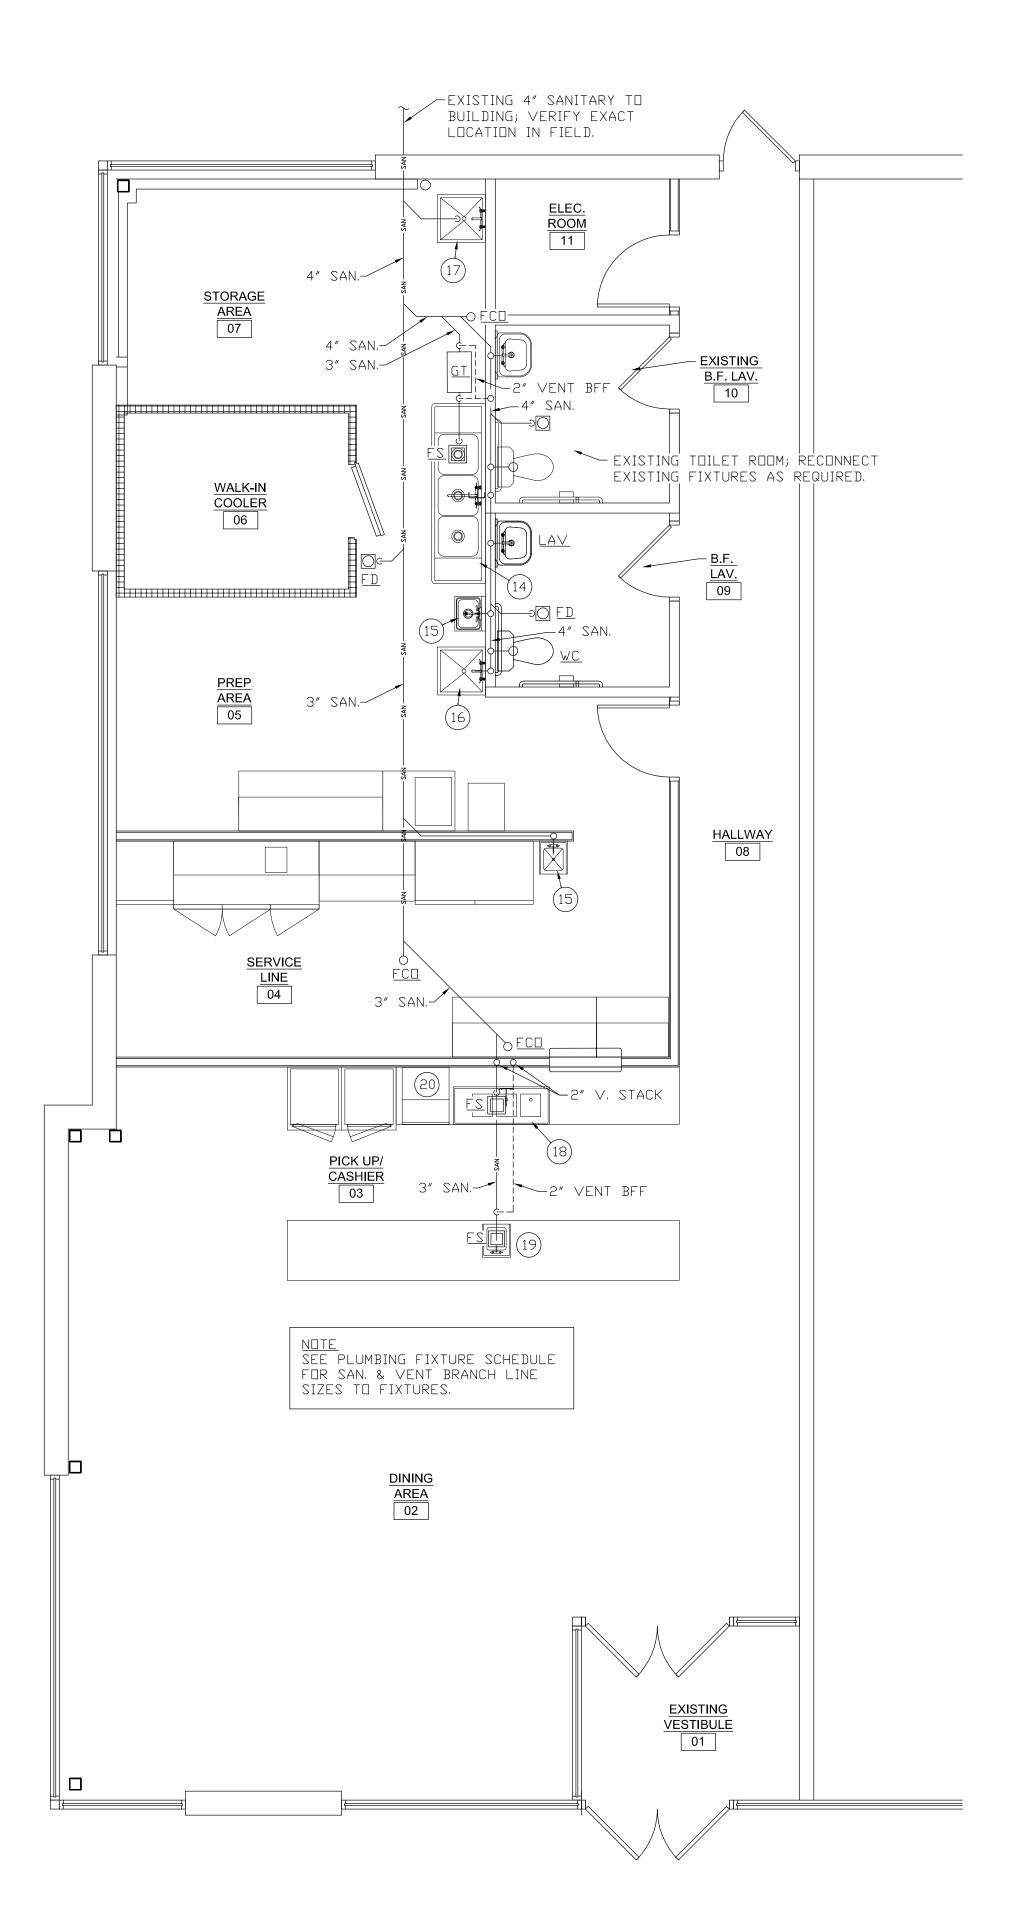
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SHEET TITLE


BATHROOM **DETAILS**

DWG. NO.

A1.1.1





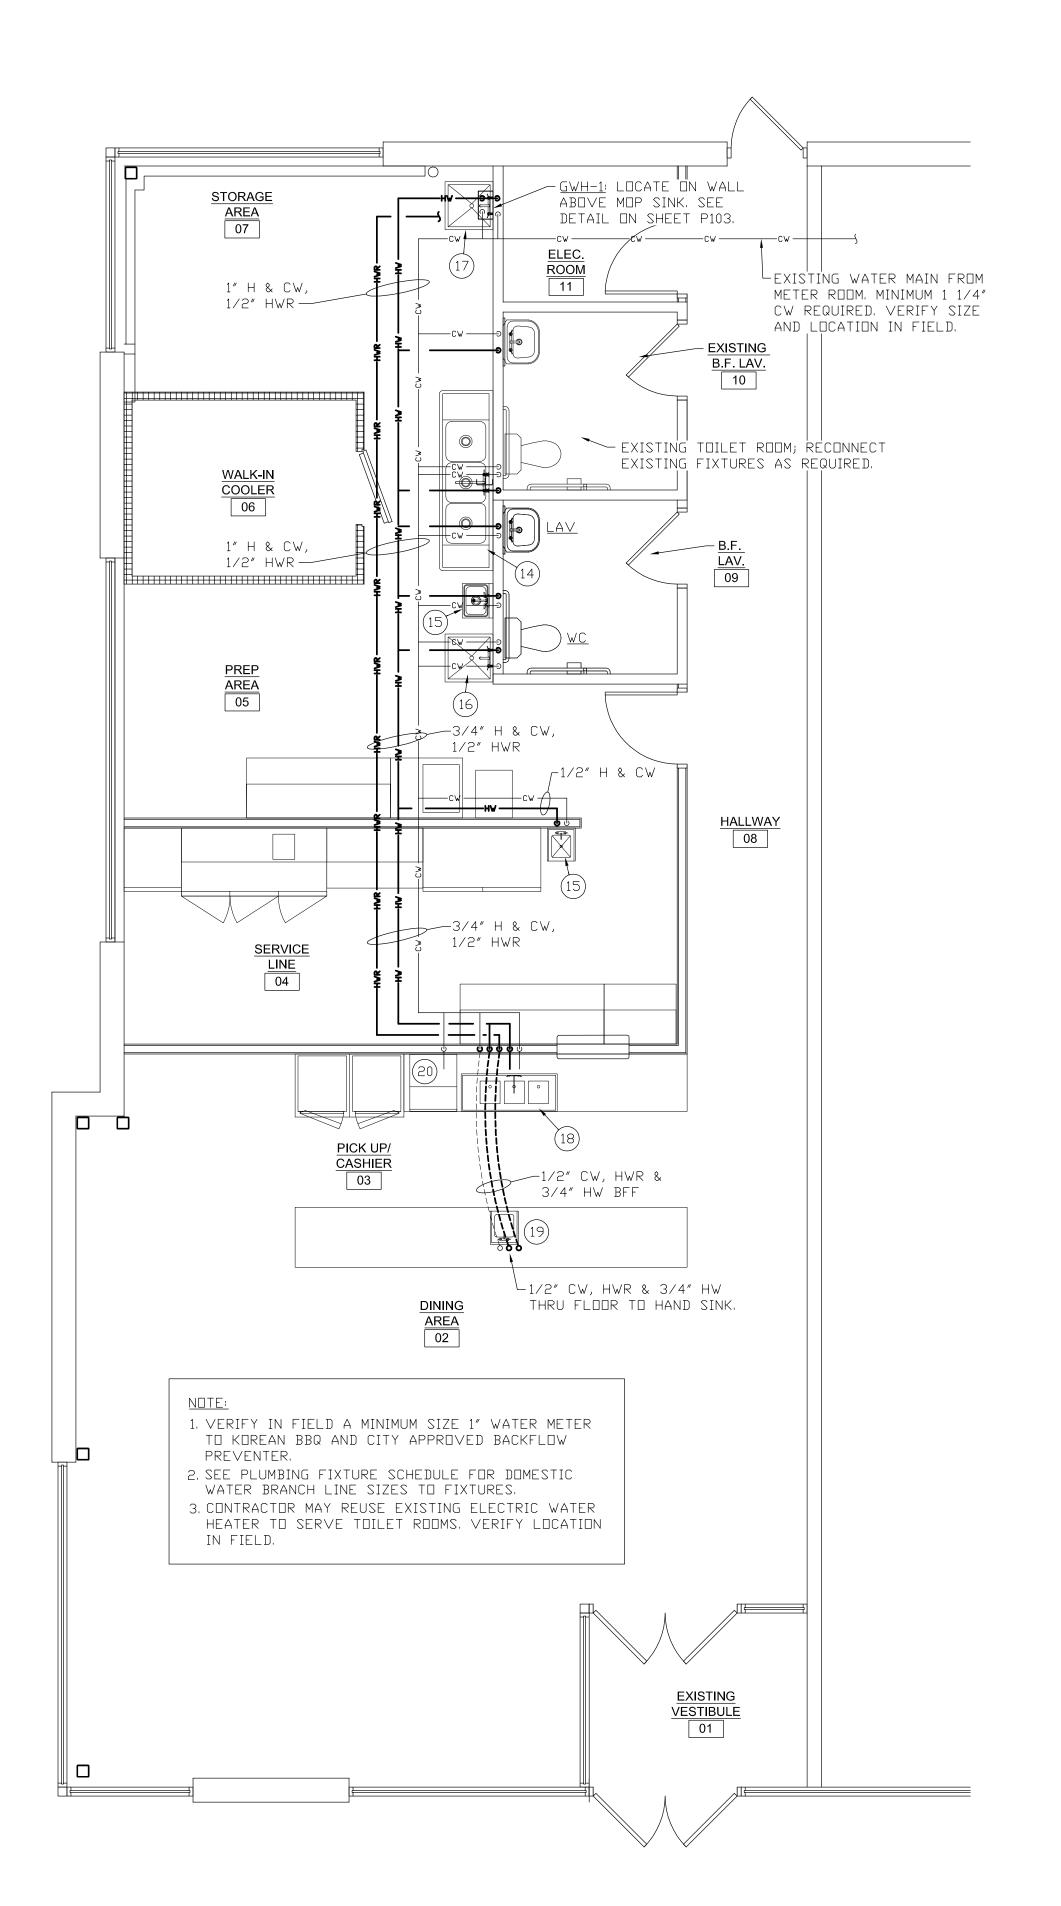

DOMESTIC WATER PLAN

SCALE: 1/4" = 1'-0"

PLUMBING ABBREVIATION LIST

AIR CONDITIONING UNIT ABOVE FINISHED FLOOR **AMPERES** APPROX APPROXIMATE BELOW FINISHED FLOOR BRITISH THERMAL UNITS PER HOUR CAPACITY CUBIC FEET PER MINUTE CAST IRON CLEAN OUT COMBINATION WASTE & VENT COMP COMPRESSOR COND CONDENSATE CONTR CONTRACTOR DOMESTIC COLD WATER DRY BULB DOWN ELECTRIC WATER COOLER EXHAUST EXIST EXISTING FAHRENHEIT FCO FLOOR CLEAN OUT FLOOR DRAIN FULL LOAD AMPERES FLEXIBLE FIRE PROTECTION FLOOR SINK FEET GAS GREASE WASTE GUTTER DRAIN GALLONS PER MINUTE GAS UNIT HEATER HOSE BIBB HORSEPOWER HOT WATER HOT WATER RETURN HERTZ INVERT ELEVATION INCHES KILOWATTS MANUFACTURER MAXMAXIMUM LAVATORY LAV MEZZANINE MINIMUM POWER EXHAUSTER PANEL PRESSURE RELIEF VALVE POUNDS PER SQUARE INCH - GAUGE PRESSURE VACUUM BREAKER RETURN AIR RETURN AIR FAN RATED LOAD AMPERES SANITARY TYPICAL URINAL

VOLTS

WASTE WET BULB

VENT THRU ROOF

WATER CLOSET

WALL CLEANOUT

WATER HEATER

CONNECT NEW TO EXISTING

VENT

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JOB NO. 22-0987

D.B/C.B R.A./P.D

ISSUANCES

NO DESCRIPTION DATE

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SHEET TITLE
PLUMBING
FLOOR PLANS


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	PLUMBING FIXTURE SCHEDULE									
EQUIPMENT	WASTE	VENT	CW	HW	MANUFACTURER	MODEL	REMARKS			
<u>wc</u> ada water closet (tank type)	4"	2"	1/2″	_	KOHLER	K-3493	INCLUDE TANK COVER LOCKS, PROVIDE BENEKE 523SS SEAT.			
<u>Lav</u> wall hung lavatory	1-1/2"	1-1/2"	1/2″	1/2"	AMERICAN STANDARD	2093.100	PROVIDE TANK COVER LOCKS, BENEKE 523SS SEAT AND ZURN FIXTURE HANGER.			
<u>FD</u> FLOOR DRAIN	3"	1-1/2"	_	_	J.R. SMITH	2005-A-B-PB-U	PROVIDE INLINE TRAP SEAL AT FLOOR DRAIN (SEE NOTE BELOW).			
<u>FS</u> FLOOR SINK	3″	-	_	_	J.R. SMITH	3100 SERIES	12" SQUARE TOP, 6" DEEP, DOME STRAINER AND 1/2 GRATE			
WCD WALL CLEAN DUT	_	_	_	_	J.R. SMITH		WALL CLEAN OUT WITH ROUND ACCESS COVER.			
<u>FCD</u> FLOOR CLEAN OUT	_	_	_	_	J.R. SMITH	4020 SERIES	WITH ROUND, POLISHED BRONZE TOP.			
<u>GT</u> GREASE TRAP	3"	2"	_	_	ZURN	GT2700-50	50 GPM FLOW, 100 LBS. GREASE CAPACITY; FULLY RECESSED IN FLOOR.			
(14) 3 COMPARTMENT SINK	_	1-1/2″	1/2″	1/2"	_	-	PROVIDED BY OWNER, INDIRECT WASTE			
(15) HAND SINK	2″	1-1/2″	1/2″	1/2"	_	_	PROVIDED BY OWNER.			
(16) 1 COMP'T PREP SINK	_	1-1/2"	1/2″	1/2"	_	_	PROVIDED BY OWNER, INDIRECT WASTE			
(17) MOP SINK	3″	1-1/2"	1/2″	1/2"	_	-	PROVIDED BY OWNER.			
(18) 3 COMP'T BAR SINK	_	_	1/2″	1/2"	_	_	PROVIDED BY OWNER. INDIRECT WASTE			
(19) BAR HAND SINK	_	_	1/2″	1/2"	-	-	PROVIDED BY OWNER. INDIRECT WASTE			
(20) ICE MAKER	_	_	1/2″	_	_	_	PROVIDED BY OWNER. INDIRECT WASTE			

TEMPERING VALVE NOTE:

PROVIDE A HOT WATER TEMPERING VALVE AT EACH HAND
SINK FAUCET. TEMPERING VALVE SHALL LIMIT WATER
TEMPERATURE TO 110 DEG F AND COMFORMS WITH ASSE 1070
AND 2012 MICHIGAN PLUMBING CODE.

<u>FLOOR DRAIN TRAP SEAL NOTE:</u> CONTRACTOR SHALL INSTALL SURESEAL INLINE TRAP SEAL MODEL SS3000 AT ALL FLOOR DRAINS.

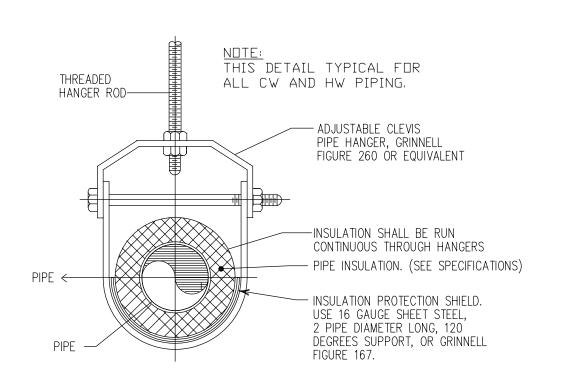

PIPING SUPPORT DETAIL SCALE: NONE

HOT WATER CALCULATION								
EQUIPMENT	QUANTITY	USAGE GPH	TOTAL					
THREE COMPARTMENT SINK	1	60	60					
1 COMP'T PREP SINK	1	30	30					
HAND SINK	3	5	15					
LAVATORY	2	5	10					
MOP SINK	1	10	10					
TOTAL			125					

NATURAL GAS
REQUIRED FOR = 125 GPH × 100 DEG F X 8.33 = 108,460 BTUH
WATER HEATER = 0.96 (OPERATING EFF.)

WATER HEATER SCHEDULE									
SYMBOL	SERVICE	MANUFACTURE R& MODEL	TYPE	INTAKE & VENT PIPE	ELE	CTRICAL PH HZ	GAS INPUT (MBH)	WATER CONN.	MAXIMUM GPM
GWH-1	RESTAURANT	STATE MODEL GTS-240X3-NIH	INSTANTANEOUS	3″ PVC	120	1 60	160	3/4″	6.6

NOTES/ACCESSORIES

- A. VENT AND COMBUSTION AIR INTAKE PIPING MATERIALS SHALL BE SCHEDULE 40 PVC INSTALLED PER MANUFACTURER'S RECOMMENDATIONS.
- B. PROVIDE 3" VENT AND AIR INTAKE LINES WITH JOINT SEALED IN ACCORDANCE WITH THE WATER HEATER MANUFACTURER'S INSTRUCTIONS.
- C. PROVIDE TEMP. & PRESSURE RELIEF TAPPING AND VALVE.

PLUMBING SPECIFICATIONS:

GENERAL

- 1. PLUMBING CONTRACTOR SHALL FIELD VERIFY ALL EXISTING CONDITIONS.
- 2. PLUMBING INSTALLATION SHALL COMPLY WITH ALL LOCAL CODES.
- 3. INSTALL NEW PLUMBING LINES TO CONNECT NEW PLUMBING EQUIPMENT AND FIXTURES INDICATED ON PLANS. NEW FIXTURES SHALL BE INSTALLED PER ADA REQUIREMENTS, LOCAL CODES AND MANUFACTURERS REQUIREMENTS.
- 4. INCLUDE ALL NECESSARY ANCHORS, BRACES, MISCELLANEOUS STEEL, WALL BRACKETS AND RISER CLAMPS REQUIRED FOR A PROPER INSTALLATION.
- 5. VENT LINES THRU ROOF SHALL BE 3" MINIMUM AND SHALL TERMINATE 24" ABOVE ROOF.
- 6. PLUMBING CONTRACTOR SHALL FURNISH AND INSTALL SHOCK ABSORBERS OR AIR CHAMBERS AT EACH HOT AND COLD WATER FIXTURE CONNECTION. CHAMBERS SHALL BE 18" HIGH AND OF THE SAME DIAMETER AS THE FIXTURE CONNECTION BUT NOT LESS THAN 1/2".
- 7. SUPPORT ALL RISERS AT BASE.
- 8. MAKE FINISHED PIPING CLEAN, FREE FROM FOREIGN MATTER AND WITH NO BURRS, WELDING ICICLES OR OTHER OBSTRUCTIONS.
- 9. INSTALL ALL PIPING TO PERMIT EASY DRAINING. ADJUST HANGERS AND SUPPORTS TO ELIMINATE SAG POCKETS. PROVIDE HOSE END DRAIN VALVES AT ALL LOW POINTS TO PERMIT DRAINING OF THE ENTIRE DOMESTIC WATER SYSTEM.
- 10. INSTALL PIPING TO PERMIT EXPANSION AND CONTRACTION WITHOUT UNDUE STRESS, PARTICULARLY AT FLASHING AND EQUIPMENT.
- 11. SUPPORT PIPING FROM ROOF BEAMS, TRUSSES OR JOIST. DO NOT HANG OR SUPPORT PIPING FROM ROOF DECK.
- 12. NEW PIPING SHALL RUN CONCEALED IN FINISHED AREAS.
- 13. WHERE PIPES PASS THRU FINISHED WALLS OR CEILING, INSTALL A STEEL OR BRASS ESCUTCHEON PLATE WITH SET SCREW.
- 14. PERMANENTLY LABEL AND TAG ALL VALVES INDICATING THE PART OF THE SYSTEM CONTROLLED.
- 15. WARRANTY ALL WORKMANSHIP, MATERIALS AND PERFORMANCE FOR A PERIOD OF ONE (1) YEAR FROM DATE OF FINAL ACCEPTANCE.
- 16. INSTALL ALL PIPING PARALLEL OR AT RIGHT ANGLES WITH BEAMS, WALLS, OR OTHER BUILDING LINES. INSTALL ALL EXPOSED PIPING AS CLOSE AS PRACTICAL TO WALLS, COLUMNS, OR OVER HEAD CONSTRUCTION TO PROVIDE MAXIMUM HEAD ROOM AND MINIMUM INTERFERENCE WITH USABLE BUILDING SPACE.

WATER

- 1. ABOVE GROUND DOMESTIC WATER LINES SHALL BE TYPE "L" HARD COPPER WITH SOLDERED COPPER JOINTS AND FITTINGS.
- 2. BELOW GROUND DOMESTIC WATER LINES SHALL BE TYPE "K" SEAMLESS TUBE TYPE SOFT COPPER, NO FITTINGS ALLOWED BELOW GRADE,
- 3. SHOCK ABSORBERS AND SHUT-OFF VALVES ARE TO BE PROVIDED AT EACH FIXTURE OR GROUP OF FIXTURES.
- 4. PROVIDE 1/2" THICK, HEAVY DUTY FIBERGLAS PIPE INSULATION WITH VAPOR BARRIER JACKET ON NEW WATER LINES. COLD WATER LINES SHALL HAVE 1/2" THICK INSULATION. HOT WATER LINES SHALL HAVE 3/4" THICK INSULATION.
- 5. DOMESTIC WATER LINES SHALL BE THOROUGHLY TREATED AND STERILIZED WITH A LIQUID CHLORINE GAS, WATER SOLUTION IN AMOUNTS OF 250PPM CHLORINE CALCULATED ON THE VOLUME OF WATER IN THE NEW PIPING SYSTEM OR AS DIRECTED BY THE LOCAL HEALTH DEPARTMENT.
- 6. AFTER STERILIZING, FLUSH ALL LINES THOROUGHLY.

SANITARY & VENT

- 1. PRIOR TO INSTALLATION OF NEW SANITARY LINES, CHECK AND CONFIRM INVERT ELEVATIONS REQUIRED FOR SEWER CONNECTIONS AND ENSURE THAT THESE CAN BE PROPERLY CONNECTED WITH SLOPE FOR DRAINAGE.
- 2. NEW SANITARY AND VENT PIPING SHALL BE PVC SCHEDULE 40 ASTM 1488. SANITARY LINES BELOW FLOOR SHALL BE 3" MINIMUM.
- 3. SANITARY AND WASTE LINES 2 1/2" AND SMALLER SHALL PITCH NOT LESS THAN 1/4" TO THE FOOT. LARGER PIPE SHALL PITCH NOT LESS THAN 1/8" TO THE FOOT.
- 4. CONTRACTOR SHALL PROVIDE A CLEAN OUT FOR THE SANITARY LINE EVERY 90 FT AND EVERY CHANGE IN DIRECTION.

GAS

- 1. GAS PIPING SHALL BE SCHEDULE 40 BLACK STEEL ASTM A-120-84 PIPE. PIPE SIZES LARGER THEN 2" SHALL HAVE BUTT WELDED JOINTS, PIPE SIZES 2" AND UNDER SHALL HAVE THREATED JOINTS,
- 2, PROVIDE DRIP LEGS AND CAPS FOR MOISTURE REMOVAL AT ALL EQUIPMENT.
- 3, PROVIDE AND INSTALL MAXITROL TYPE 325 GAS PRESSURE AT ALL GAS FIRED APPLIANCE, INSTALL REGULATORS SIZED PER EQUIPMENT PRESSURE REQUIREMENTS.



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435 E. BIG BEAVER TROY MI 48083



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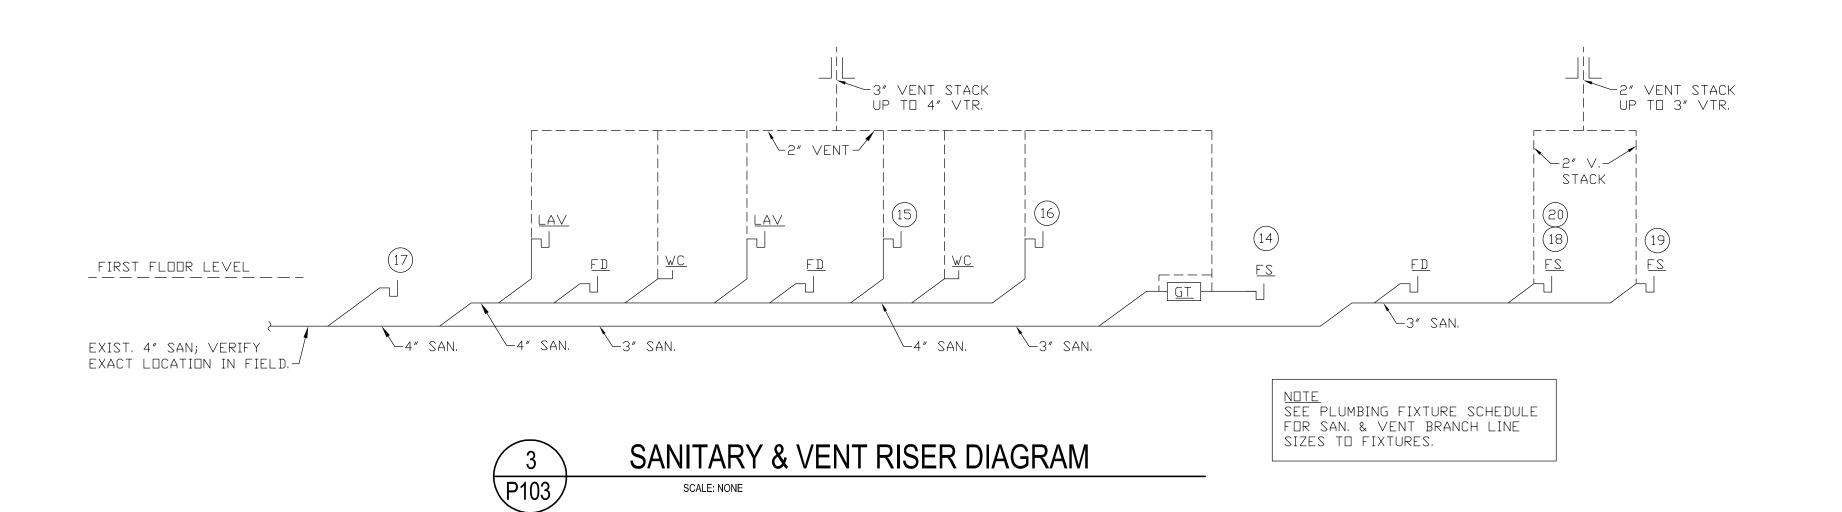
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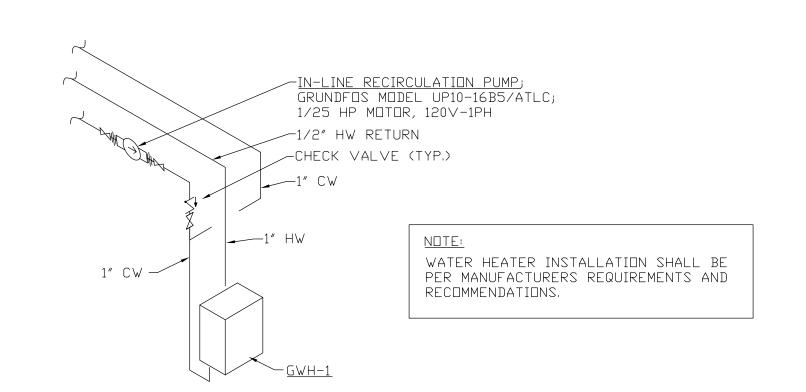
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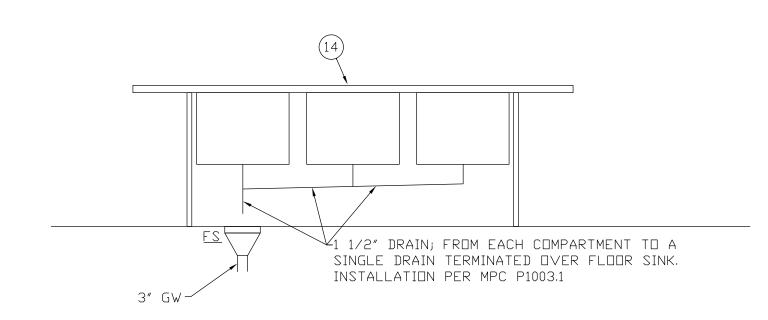
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PLUMBING SPEC'S AND SCHEDULES

DWG. NO.










3 COMP'T SINK WASTE ELEVATION

SCALE: NONE



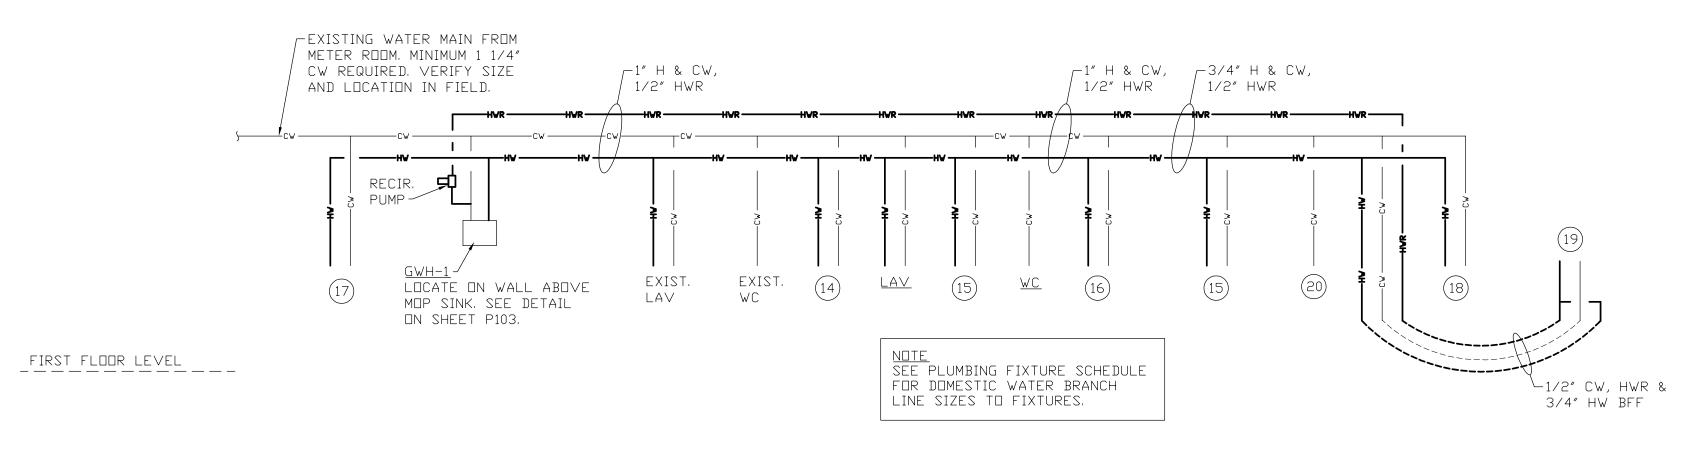



UNIT	BACKFLOW DEVICE
BEVERAGE DISPENSER	VDC
MOP SINK FAUCET	HB
ICE MAKER	VDC
3-COMPARTMENT SINK	AB
OVERHEAD SPRAY HOSE	AB
TOILET (WATER CLOSET)	ASV
SYMBOLS: AVB: ATMOSPHERIC VACUUM BR VDC: VENTED DOUBLE CHECK V HB: HOSE BIB VACUUM BREAKEF ASV: ANTI SIPHON VALVE. AB: AIR BREAK.	ALVE.
MANUFACTURER, MODEL,	OTECTION DEVICES WITH SIZE AND EQUIPMENT PLUMBING INSPECTOR

WATER SUPPLY	FIXTL	JRE UN	ITS	
EQUIPMENT	WSFU	QUANITY	TOTAL	
WATER CLOSET (TANK TYPE)	5	2	10	
LAVATORY	2	2	4	
3 COMPARTMENT SINK	4	4		
3 COMPARTMENT BAR SINK	4	1	4	
1 COMPARTMENT PREP SINK	4	4		
HAND SINK	2	2 3		
MDP SINK	3 1		3	
ICE MACHINE	1	1	1	
		TOTAL WSFU	36	

WATER SUPPLY LOAD SUMMARY:
1 1/4" WATER MAIN TO KOREAN BBQ IS
ADEQUATE FOR DESIGN LOAD OF 36 WSFU
PER ILLINOIS PLUMBING CODE.



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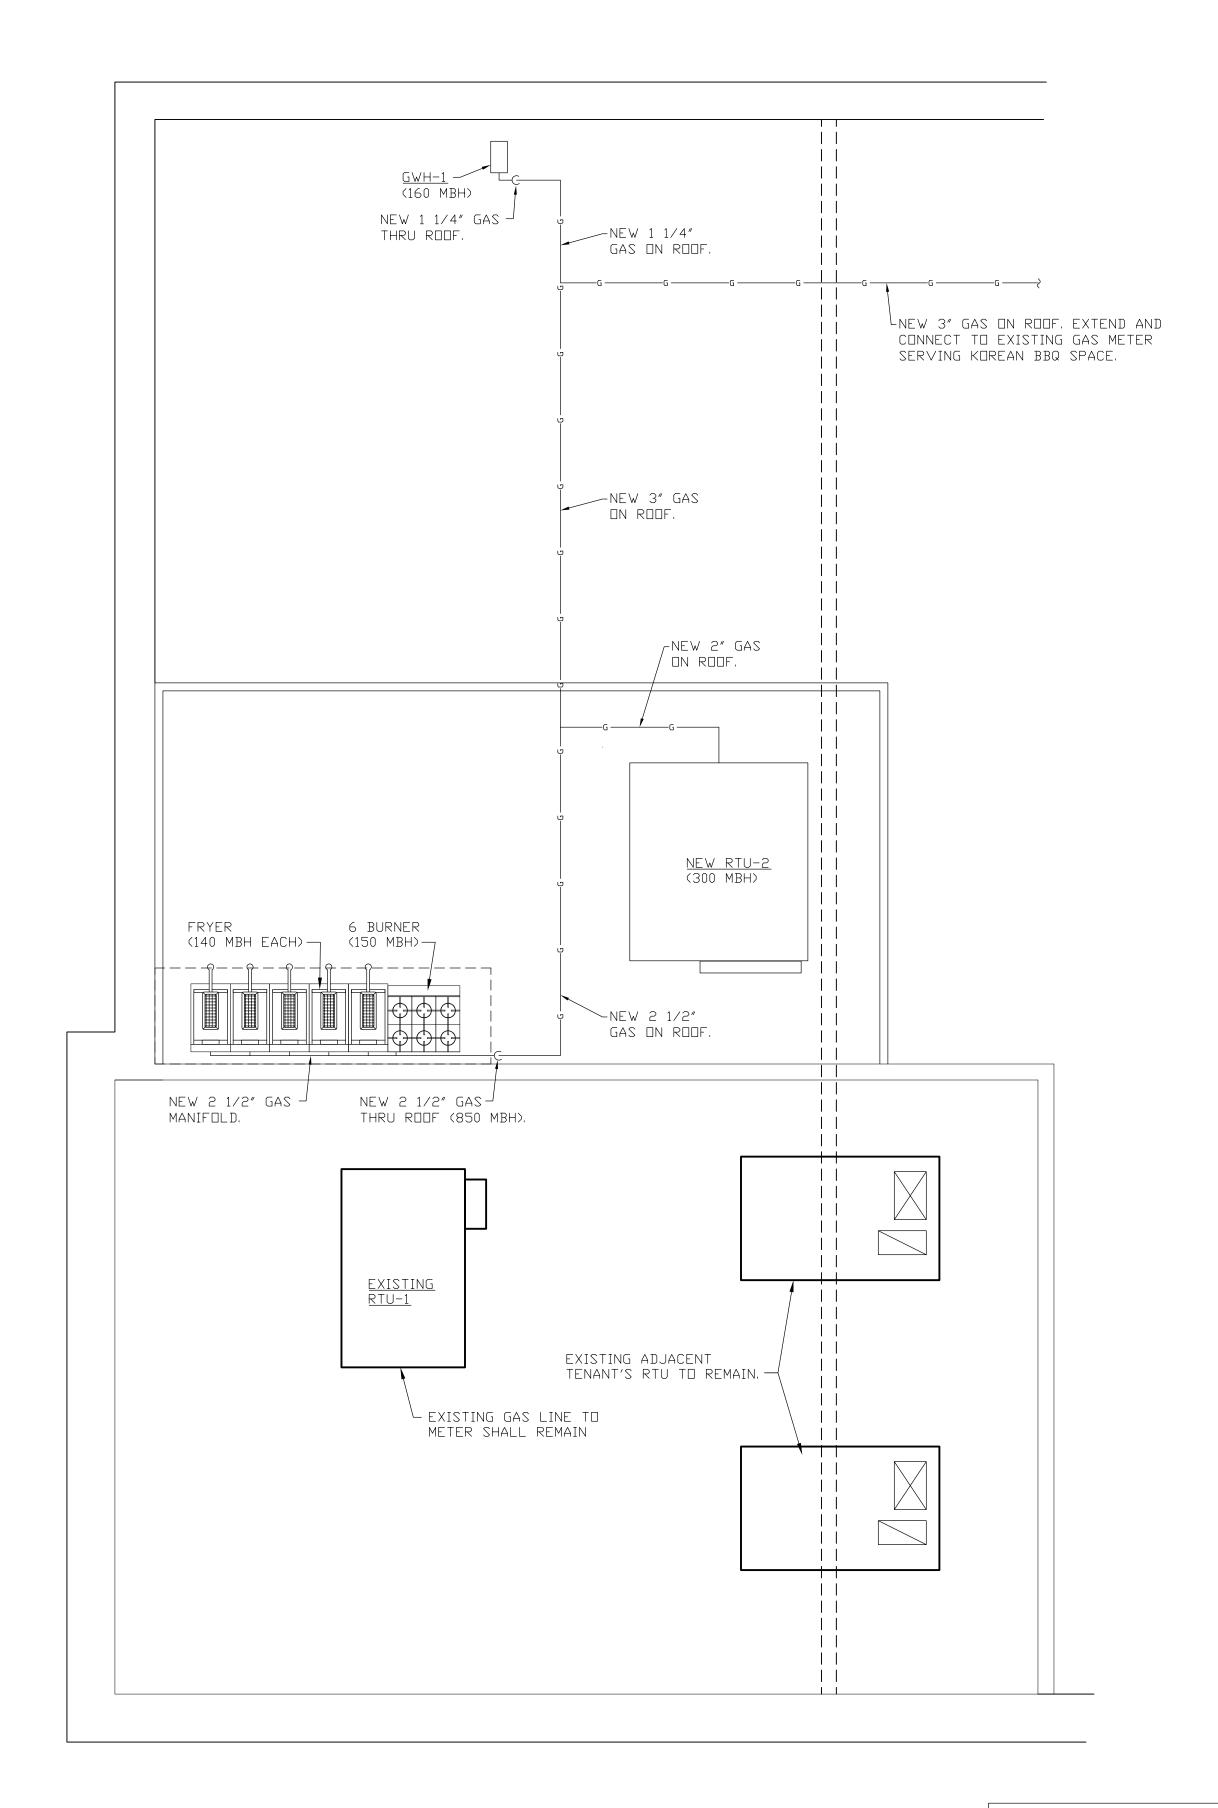



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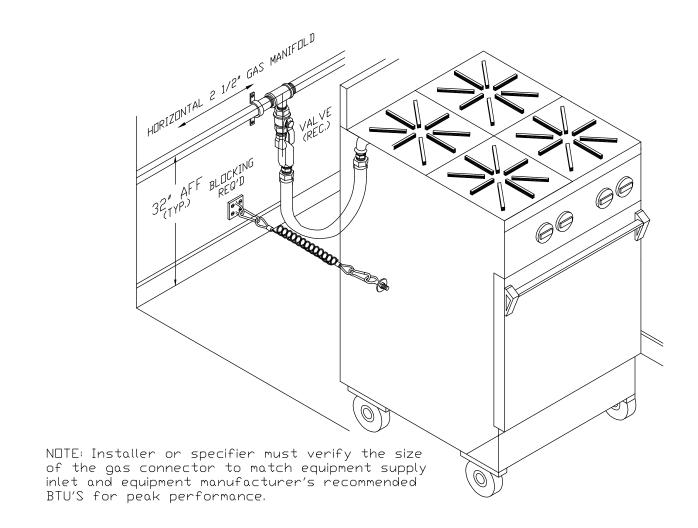
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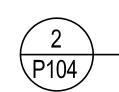
PLUMBING RISER
DIAGRAMS AND
DETAILS

DWG. NO.







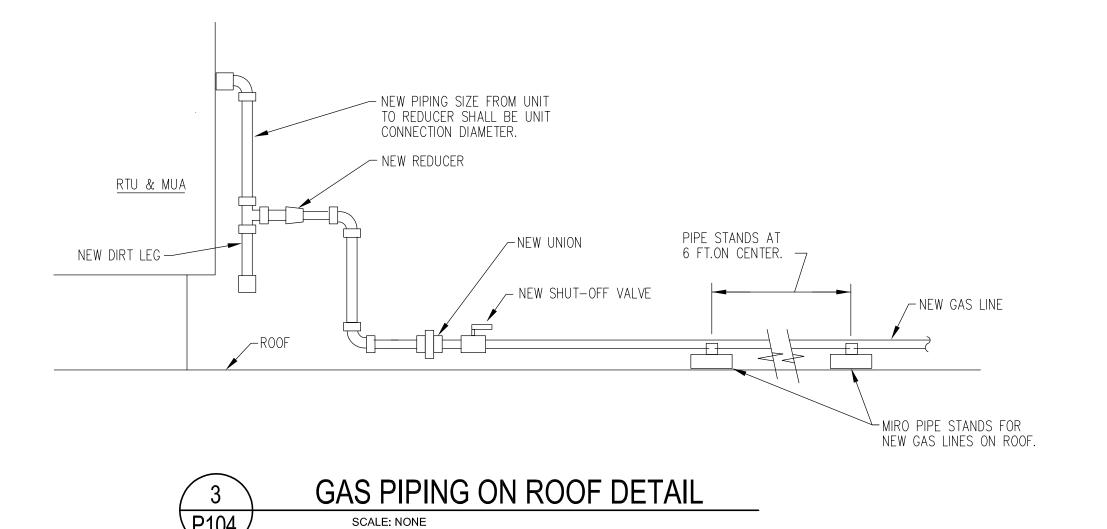

GAS MANIFOLD CONNECTION DETAIL

SCALE: NONE



NOTE:
BASED ON 1,310 MBH GAS
LOAD, 1 PSI AT METER, .5"
WC PRESSURE DROP AND
500 FT. MAX. LENGTH.



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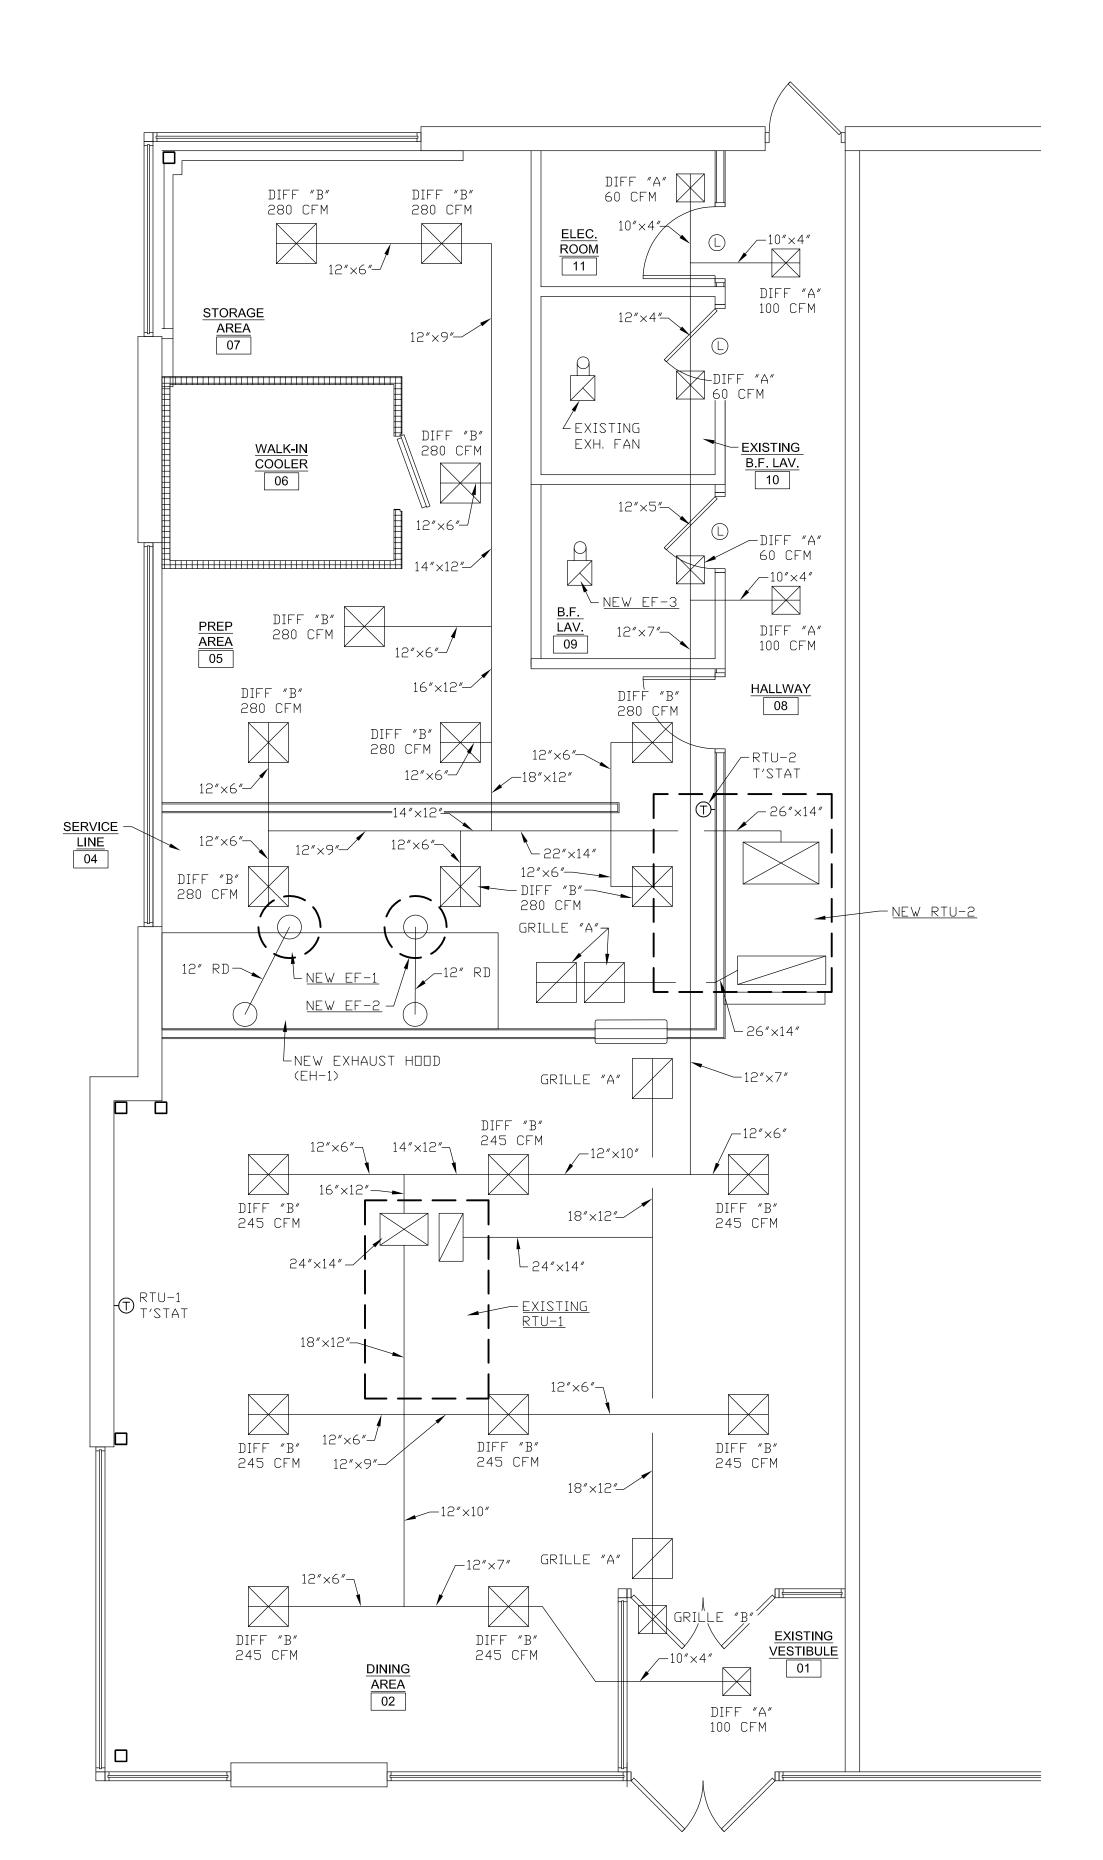


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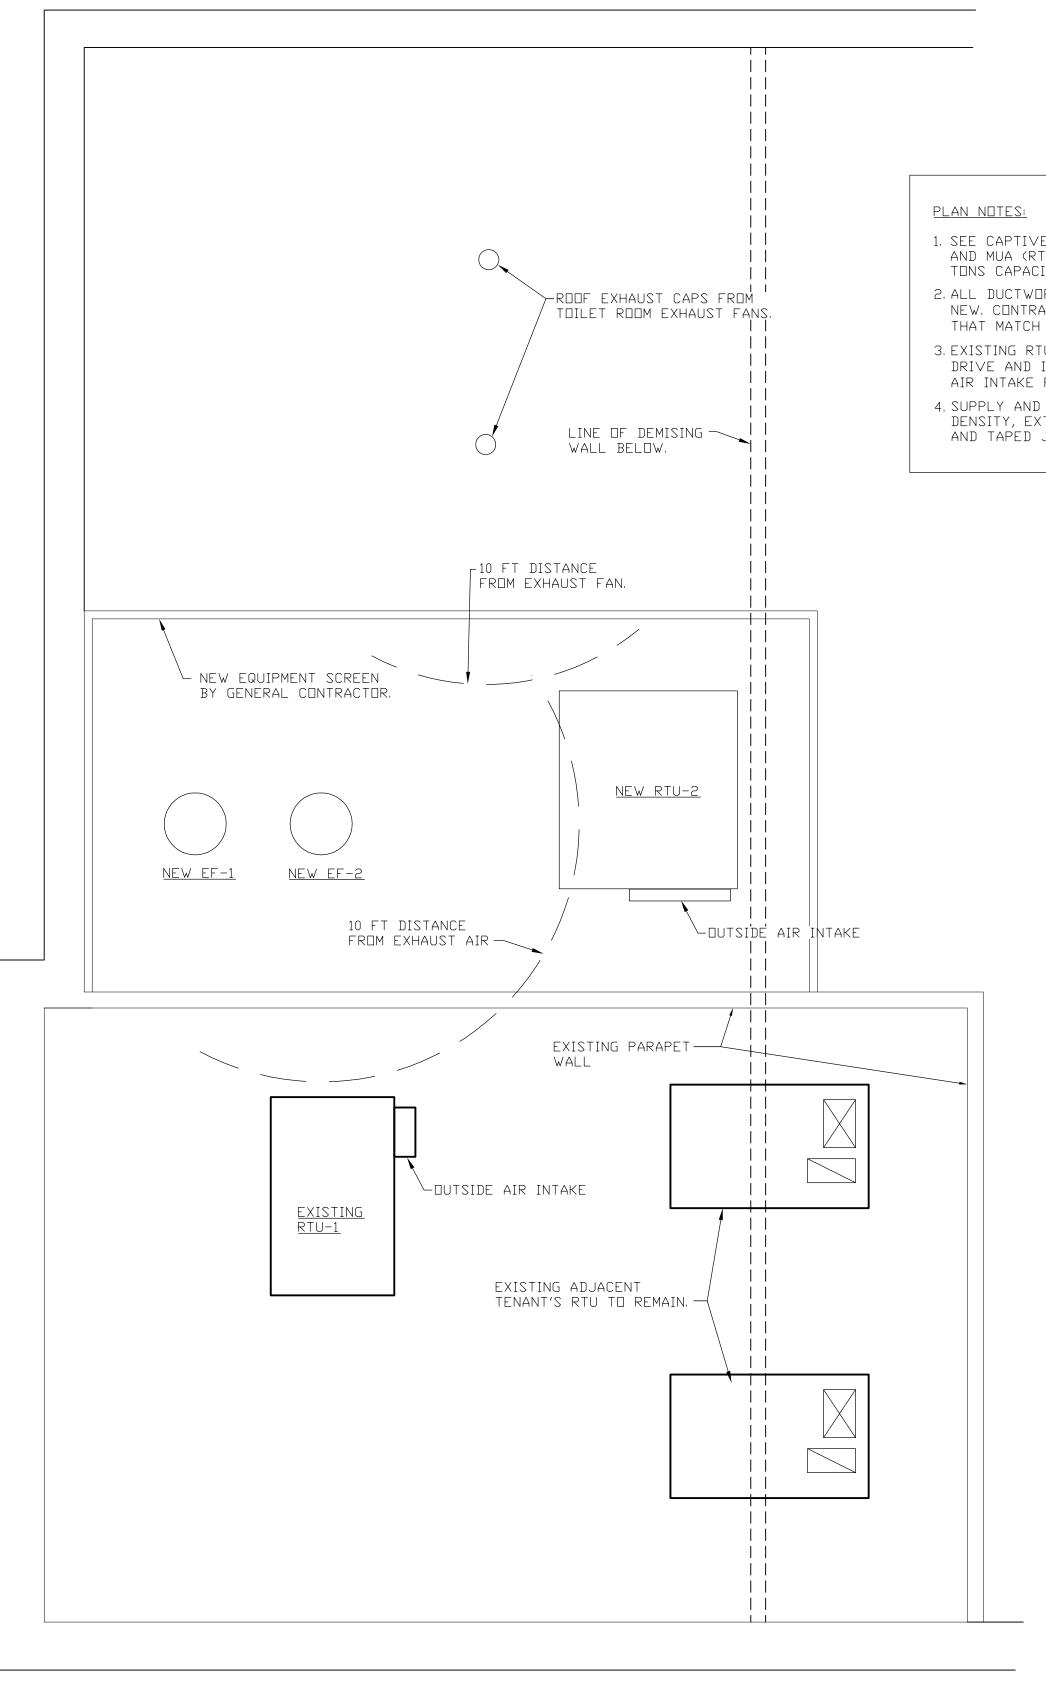
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GAS PLAN AND DETAILS

DWG. NO.



M101





- 1. SEE CAPTIVEAIRE DRAWING 1 THRU 19 FOR NEW HOOD, EXHAUST FANS AND MUA (RTU-2) FOR FOOD PREPARATION AREA. EXISTING RTU-1 IS 6 TONS CAPACITY AND SHALL SERVE DINING AREA.
- 2. ALL DUCTWORK AND AIR OUTLETS INDICATED ON FLOOR PLAN ARE NEW, CONTRACTOR MAY REUSE EXISTING DUCTWORK AND AIR OUTLETS THAT MATCH DESIGN SIZES INDICATED ON PLAN.
- 3. EXISTING RTU-1; SET SUPPLY AIR FOR 2,400 CFM. ADJUST FAN DRIVE AND INSTALL NEW EVAPORATOR FAN MOTOR IF REQUIRED, SET AIR INTAKE FOR 500 CFM OUTSIDE AIR.
- 4. SUPPLY AND RETURN AIR DUCTWORK SHALL HAVE 1" THICK, 3/4 LB DENSITY, EXTERNAL FIBERGLAS DUCT INSULATION WITH VAPOR BARRIER AND TAPED JOINTS.

MECHANICAL ABBREVIATION LIST AC UNIT AIR CONDITIONING UNIT ABOVE FINISHED FLOOR **AMPERES** APPROX APPROXIMATE BELOW FINISHED FLOOR CAP CAPACITY CUBIC FEET PER MINUTE COMPRESSOR CONDENSATE CONTRACTOR DRY BULB DOWN EXHAUST AIR FAN EXHAUST HOOD EVAPORATOR EXH EXHAUST EXIST **EXISTING** FAHRENHEIT FLOOR CLEAN OUT

D.B/C.B ISSUANCES NO DESCRIPTION

1 PERMIT SUBMISSION 06/28/22

SHEET TITLE **MECHANICAL** FLOOR PLANS

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PROJECT NAME:

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06-28-22

435 E. BIG BEAVER

PIETRO D'ALEO

ARCHITECT

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22-0987

R.A./P.D

DATE

JOB NO.

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DWG. NO.

M1.0.1

MECHANICAL ROOF PLAN SCALE: 1/4" = 1'-0"

MECHANICAL FLOOR PLAN SCALE: 1/4" = 1'-0"

FLA FULL LOAD AMPERES FLEXIBLE

FEET HORSEPOWER HERTZ INVERT ELEVATION INCHES

KILOWATTS ΚW MANUFACTURER MEZZANINE

MINIMUM POWER EXHAUSTER

RETURN AIR RETURN AIR FAN RATED LOAD AMPERES

DOOR LOUVER

REVOLUTIONS PER MINUTE TRANSFER AIR

THERMOSTAT TYPICAL

VOLTS

VENTILATION SCHEDULE (PER MMC 403.3)									
SERVICE	PEOPLE O.A. RATE	PEOPLE	PEOPLE O.A.	AREA D.A. RATE	AREA	AREA D.A.	AREA+PEOPLE Code o.a.	DESIGN D.A. RATE	
DINING AREA	7.5 CFM/PR	47	353 CFM	.18 CFM/SQ.FT.	672 SQ.FT.	121 CFM	474 CFM	500 CFM	

POWER EXHAUSTER										
SYMBOL	SERVICE	TYPE	DRIV E	CFM	EXT. STAT. PRESSURE	HP	ELECT VOLT	RICAL	HZ	MANUFACTURER, MODEL AND REMARKS
NEW EF-3	TOILET ROOM	CEILING MTD.	DIRECT	70	.25″ WG	50 WATTS	120	1	60	COOK MODEL GC-146 INTERLOCK WITH LIGHTS.

PROVIDE OPTIONAL ROOF CURB AND BACKDRAFT DAMPER FOR EF-3.

DIFFUSER, REGISTER AND GRILLE SCHEDULE									
SYMBOL	TYPE	MODEL	NECK SIZE	REMARKS					
DIFF "A"	S.A. DIFFUSER	TMSA	6″ RD.	TYPE 1 PATTERN A4; WITH DAMPER AND GRID					
DIFF "B"	S.A. DIFFUSER	TMSA	8″ RD.	TYPE 1 PATTERN A4; WITH DAMPER AND GRID					
GRILLE "A"	R.A. GRILLE	TYPE 50F	24″×24″						
GRILLE "B"	R.A. GRILLE	TYPE 50F	10"×10"						

SELECTION BASED ON "TITUS" MODELS. ALTERNATE MANUFACTURER SHALL BE KRUEGER OR METALAIRE.

	ΑI	R BALANCE	SCHEDULE
SERVICE	OUTSIDE AIR	EXHAUST AIR	COMMENT
EXISTING RTU-1	500 CFM		6 TON CAPACITY SERVING DINING AREA.
NEW RTU-2 (MUA)	2,800 CFM		15 TON CAPACITY MAKE-UP AIR UNIT; SEE CAPTIVEAIRE PLANS.
NEW EXHAUST FAN #1		1,400 CFM	SEE CAPTIVEAIRE PLANS FOR FAN INFORMATION.
NEW EXHAUST FAN #2		1,400 CFM	SEE CAPTIVEAIRE PLANS FOR FAN INFORMATION.
TOILET ROOMS		140 CFM	
TOTAL	3,300 CFM	2,940 CFM	

POSITIVE AIR PRESSURE IN BUILDING SHALL BE RELIEVED BY EXISTING RTU-1 RELIEF AIR HOOD.

EXHAUST SYSTEM SPECIFICATIONS:

- 1. DO NOT SCALE DRAWINGS, USE DIMENSIONS AS INDICATED.FIELD VERIFY ALL EXISTING CONDITIONS.
- 2. IT IS THE RESPONSIBILITY OF THE INSTALLING CONTRACTOR TO OBTAIN ALL PERMITS AND APPROVALS FROM ALL STATE AND LOCAL OFFICIALS PRIOR TO PROCEEDING WITH INSTALLATION. THESE DRAWINGS ARE TO SERVE AS BASIC DESIGN ONLY AND ANY STATE OR LOCAL ORDINANCE WHICH IS MORE RESTRICTIVE SHALL PREVAIL.
- 3. IT IS THE RESPONSIBILITY OF THE INSTALLING CONTRACTOR TO CHECK BUILDING ACCESS AND FIELD CONDITIONS TO ALLOW FOR ADEQUATE CLEARANCES FOR THE EQUIPMENT TO BE BROUGHT IN AND INSTALLED.
- 4. AIR INTAKES MUST BE NO CLOSER THAN 10 FEET FROM ANY EXHAUST OR VENT
- 5. EXHAUST DUCT MUST BE CONSTRUCTED FROM A MINIMUM OF 16 GAUGE LIQUID-TIGHT WELDED STEEL FITTED TIGHTLY INTO HOOD COLLAR AND CONTINUOUSLY WELDED TO HOOD. DUCT CLEAN OUTS SHALL BE PROVIDED AT EVERY CHANGE IN DIRECTION. INSTALLING CONTRACTOR SHALL VERIFY ANY REQUIREMENTS FOR INSULATION OF THE EXHAUST DUCT. EXHAUST FAN SHALL EXTEND A MINIMUM OF 40 INCHES ABOVE ROOF SURFACE AND BE PROPERLY FLASHED TO ADJOINING
- 6. ALL NEW EXHAUST DUCTORK SHALL IS COVERED WITH 3M FIRE BARRIER DUCT WRAP TYPE 615 TO SERVE AS A FIRE RATED ENCLOSURE. INSTALL DUCT WRAP PER 3M REQUIREMENTS + RECOMMENDATIONS.
- 7. EXHAUST FAN AND SOURCE OF MAKE-UP AIR SHALL BE ELECTRICALLY INTERLOCKED. ELECTRICAL CONTRACTOR TO PROVIDE AND INSTALL ALL NECESSARY STARTERS, RELAYS, SWITCHES, ETC., AS REQUIRED.
- 8. THESE DRAWINGS ARE TO SERVE AS A BASIC DESIGN ONLY AND ANY STATE OR LOCAL ORDINANCE WHICH IS MORE RESTRICTIVE SHALL PREVAIL.
- 9. IT IS THE RESPONSIBILITY OF THE CONTRACTOR TO ENSURE THE HOOD CLEARANCE FROM COMBUSTIBLES (AND NON OR LIMITED COMBUSTIBLES) IS IN COMPLIANCE WITH THE LATEST EDITION OF THE NATIONAL FIRE PROTECTION ASSOCIATION BULLETIN #96.
- 10. HOOD CONSTRUCTION SHALL BE IN ACCORDANCE WITH 2018 MMC, 2015 IMC, LOCAL CODE, STATE BUILDING CODE, NFPA AND NSF. CONSTRUCTION SHALL BE 18 GAUGE ALUMINIZED STL. OR 18 GAUGE ST. STL. ALL EXTERIOR SEAMS TO BE WELDED LIQUID TIGHT.

NFPA #96 CLEARANCES FROM COMBUSTIBLES:

SURFACE **CLEARANCE** COMBUSTIBLE 3' INSULATED 3"UN-INSULATED LIMITED-COMBUSTIBLE NON-COMBUSTIBLE 0" REQUIRED

2009 INTERNATIONAL CODE FROM COMBUSTIBLES:

COMBUSTIBLE SURFACE REDUCTION TO 7" AS FOLLOWS -24 GA. MINIMUM UNPAINTED SHEET METAL(0.024) SPACED 1" OFF THE COMBUSTIBLE ASSEMBLY.

MECHANICAL SPECIFICATIONS:

<u>GENERAL</u>

- 1. ALL WORK SHALL BE IN ACCORDANCE WITH EQUIPMENT MANUFACTURER'S REQUIREMENTS AND RECOMMENDATIONS.
- 2.THE MECHANICAL PLANS ARE DIAGRAMMATIC. CONTRACTOR SHALL FIELD VERIFY AND DETERMINE EXISTING CONDITIONS AND LIMITATIONS UNDER WHICH THE WORK IS TO BE PERFORMED. THE SUBMISSION OF A BID SHALL BE CONTURED AS INDICATING SUCH KNOWLEDGE THAT SUCH EXAMINATION HAS BEEN MADE AND VERIFIED.
- 3.ALL WORK SHALL BE PERFORMED IN ACCORDANCE WITH THE STATE AND LOCAL BUILDING, MECHANICAL CODES.
- 4.THE CONTRACTOR SHALL BE RESPONSIBLE FOR OBTAINING AND PAYING FOR ALL NECESSARY PERMITS REQUIRED TO COMPLETE THE
- 5. IT IS THE CONTRACTOR'S RESPONSIBILITY TO FOLLOW ALL APPLICABLE SAFETY CODES AND REGULATIONS DURING ALL PHASES OF CONSTRUCTION.
- 6. CONTRACTOR SHALL WARRANTY ALL WORKMANSHIP, MATERIALS AND PERFORMANCE FOR A PERIOD OF ONE YEAR FROM DATE OF FINAL ACCEPTANCE.

<u>hvac equipment</u>

1. INSTALL NEW HVAC EQUIPMENT PER THE MANUFACTURER'S REQUIREMENTS AND RECOMMENDATIONS.

2. THE CONTRACTOR SHALL BE RESPONSIBLE FOR PERFORMING THE EQUIPMENT START-UP PER THE MANUFACTURER'S INSTRUCTIONS, THE FOLLOWING ITEMS SHALL BE RECORDED AT THE TIME OF START-UP AND 30 DAYS AFTER START-UP;

> EVAPORATOR FAN MOTOR AMP. DRAW CONDENSER FAN MOTOR AMP, DRAW REFRIGERANT CHARGE EVAPORATOR FAN CONDITION EVAPORATOR COIL CONDITION CONDENSER COIL CONDITION CONDENSER FAN CONDITION GAS HEAT EXCHANGER CONDITION DUTSIDE AIR INTAKE

- 3. CONTRACTOR SHALL PROVIDE ONE-YEAR LABOR WARRANTY FOR ALL WORK ASSOCIATED WITH THIS PROJECT, EQUIPMENT MANUFACTURER SHALL PROVIDE ONE YEAR PARTS WARRANTY.
- 4.NEW EQUIPMENT SHALL BE SECURED IN ACCORDANCE WITH STATE BUILDING AND ENERGY CODE.

AIR BALANCE

- 1. CONTRACTOR SHALL PROVIDE PROPER TESTING, ADJUSTING AND BALANCING OF THE SYSTEM TO ACHIEVE SPECIFIED PERFORMANCE.
- 2. AIR BALANCE REPORT SHALL INCLUDE ROOF TOP A/C UNIT (RTU) PERFORMANCE WITH A LIST OF SCHEDULED RTU ZONE AIR FLOW, REPORT SHALL INCLUDE THE FOLLOWING INFORMATION;
 - A)RTU MANUFACTURER, MODEL SERIAL NUMBER AND COMPLETE NAMEPLATE DATA.
 - B)RTU DESIGN SUPPLY AND DUTSIDE AIR CFM AND FINAL TEST
 - SUPPLY AND DUTSIDE AIR CFM. C)FAN MOTOR VOLTAGE, HORSEPOWER, COMPLETE NAMEPLATE DATA
 - D) DESIGN AIR FLOW AND FINAL TEST AIR FLOW AT EACH DIFFUSER, REGISTER AND GRILLE.

AND MOTOR SERVICE FACTOR.

3. ALL TESTING PROCEDURES SHALL BE PER ASSOCIATED AIR BALANCING COUNCIL (AABC) PROCEDURAL STANDARDS FOR TESTING, ADJUSTING AND BALANCING OF ENVIROMENTAL SYSTEMS THROUGH AN APPROVED CERTIFIED AGENCY AND TECHNICIAN COMPLETE WITH SUBMITTAL REPORT.

WARRANTY

- 1. CONTRACTOR SHALL WARRANTY ALL WORKMANSHIP, MATERIALS AND PERFORMANCE FOR A PERIOD OF ONE YEAR FROM DATE OF FINAL
- 2. NEW ROOFTOP A.C. UNIT SHALL HAVE A 5 YEAR COMPRESSOR WARRANTY BY THE MANUFACTURER.

IDENTIFICATION

1. PROVIDE PLASTIC ENGRAVED EQUIPMENT TAGS ON ALL NEW EQUIPMENT. 2. PROVIDE A PLASTIC NAMEPLATE ON ELECTRICAL PANEL NEAR FUSE SWITCH TO IDENTIFY EQUIPMENT SERVED.

SHEET METAL

- 1. ALL SHEET METAL WORK SHALL BE IN ACCORDANCE WITH INDUSTRY STANDARDS, PUBLISHED BY THE SHEET METAL & AIR CONDITIONING CONTRACTORS NATIONAL ASSOCIATION, INC., AND THE LATEST ASHRAE GUIDE, APPLICABLE TO LOW PRESSURE SYSTEMS.
- 2. NEW DUCTWORK SHALL BE MINIMUM 26 GAUGE GALVANIZED SHEET METAL. DUCTWORK SHALL SECURELY BRACED TO PREVENT VIBRATION.
- 3. PROVIDE TURNING VANES IN ALL 90 DEGREE ELBOWS AND AIR EXTRACTORS AT ALL BRANCH DUCT TAKE-OFFS.
- 4. SUPPLY AND RETURN AIR DUCTWORK IN CEILING SPACES SHALL HAVE 1" THICK, 3/4 LB DENSITY, EXTERNAL FIBERGLAS DUCT INSULATION WITH VAPOR BARRIER AND TAPED JOINTS.

TEMPERATURE CONTROL SYSTEM

- 1. ROOF TOP A/C UNITS SHALL BE CONTROLLED THROUGH HONEYWELL MODEL T7300 ROOM THERMOSTAT.
- 2. ROOM THERMOSTATS SHALL BE MOUNTED AT 48" AFF.
- 3. IN UNDCCUPIED MODE THE DUTSIDE AIR DAMPERS SHALL CLOSE AT RTU-1 & 2 AND UNITS SHALL RUN ON 100% RETURN AIR.



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PROJECT NAME: KOREAN BBQ

PERMIT SUBMISSION 06-28-22


435 E. BIG BEAVER TROY MI 48083



ALL DIMENSIONS SHALL BE VERIFIED IN THE FIELD BY THE CONTRACTOR. TH CONTRACTOR IS SOLELY RESPONSIBLE FOR COORDINATION OF ALL DIMENSIONS.

JOB NO.	22-0987
D.B/C.B	R.A./P.D
ISSUANCES	
NO DESCRIPTION	DATE
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SHEET TITLE **MECHANICAL** SCHEDULES AND **SPECIFICATIONS**

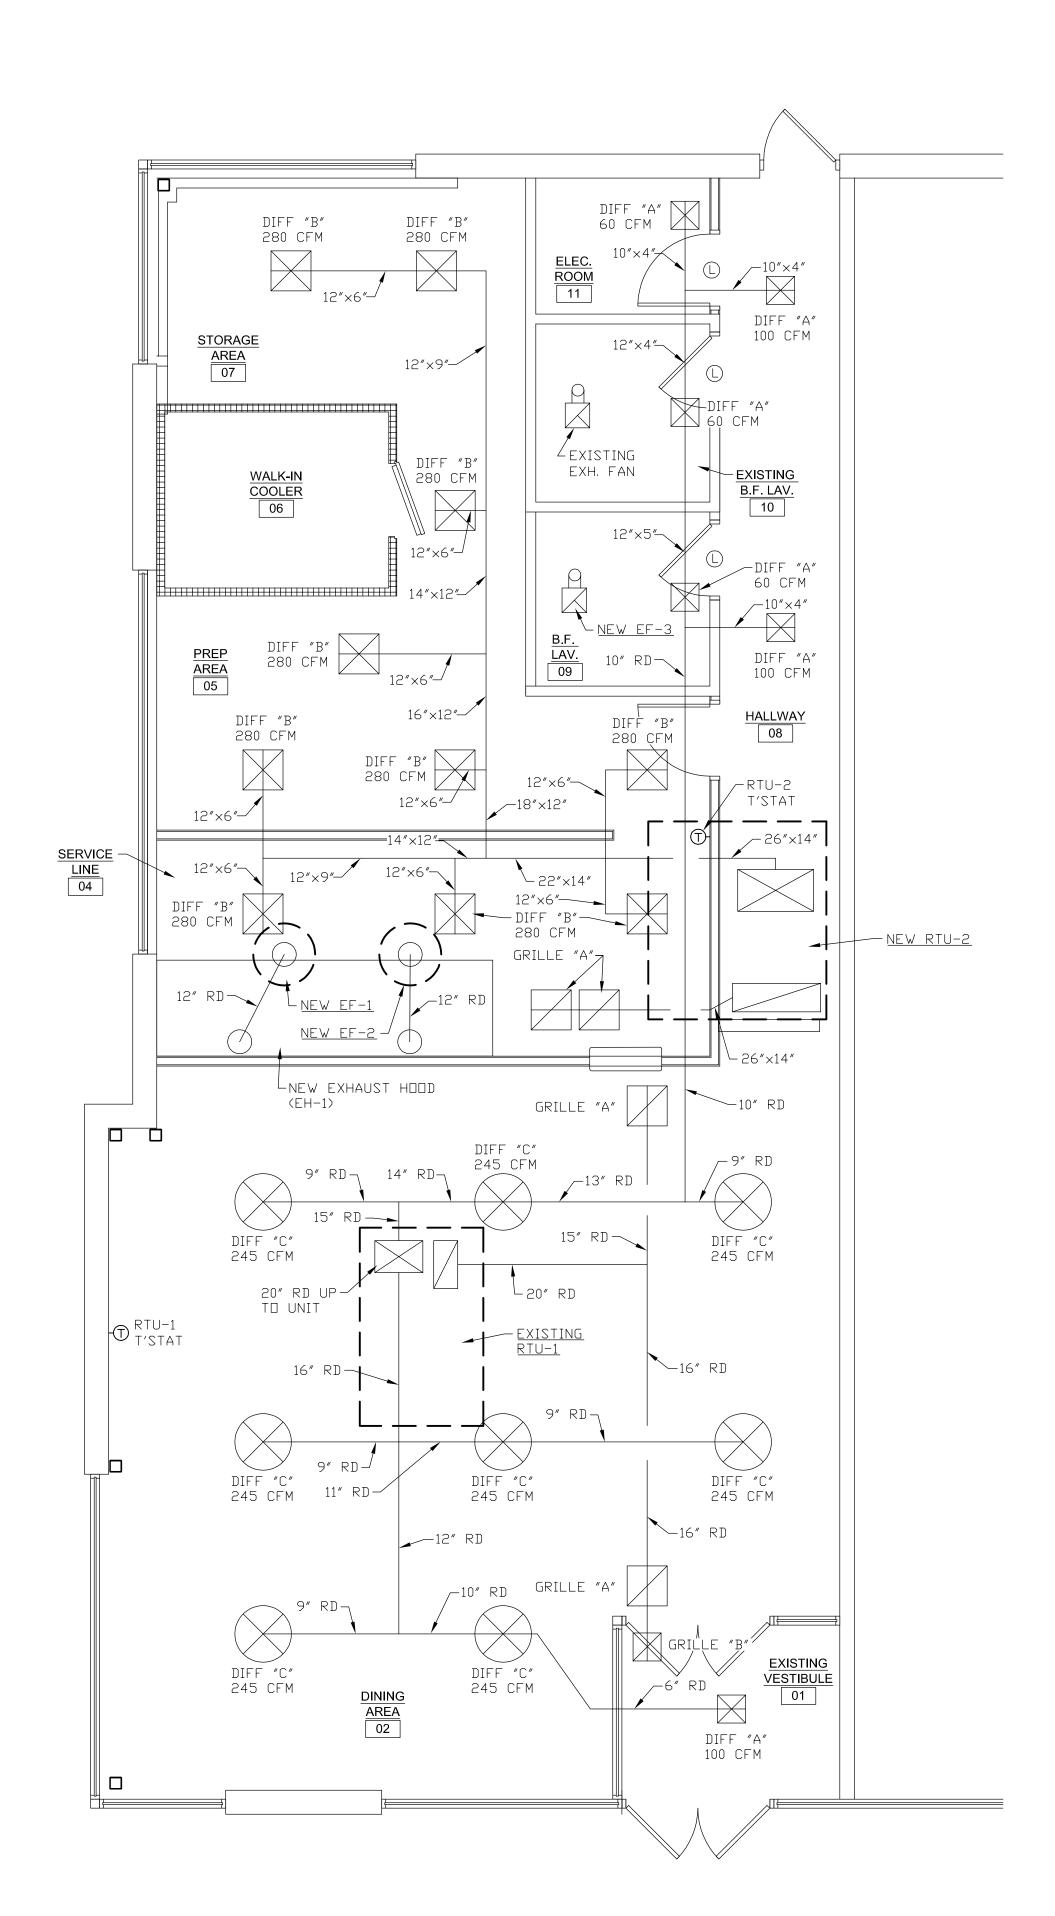

DIF	FUSER, R	EGISTER	AND GR	RILLE SCHEDULE
SYMBOL	TYPE	MODEL	NECK SIZE	REMARKS
DIFF "A"	S.A. DIFFUSER	TMSA	6″ RD.	TYPE 1 PATTERN A4; WITH DAMPER AND GRID
DIFF "B"	S.A. DIFFUSER	TMSA	8″ RD.	TYPE 1 PATTERN A4; WITH DAMPER AND GRID
DIFF "C"	S.A. DIFFUSER	TMRA	8″ RD.	TYPE 1 PATTERN A4; WITH DAMPER AND GRID
GRILLE "A"	R.A. GRILLE	TYPE 50F	24″×24″	
GRILLE "B"	R.A. GRILLE	TYPE 50F	10"×10"	

<u>NOTE:</u> SELECTION BASED ON "TITUS" MODELS. ALTERNATE MANUFACTURER SHALL BE KRUEGER OR METALAIRE.

ALTERNATE PLAN: CONTRACTOR SHALL PROVIDE AN ALTERNATE BID FOR ROUND DUCT AND DIFFUSERS IN DINING AREA.



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JOB NO.	22-098
D.B/C.B	R.A./P
ISSUANCES	
NO DESCRIPTION	DATE
1 PERMIT SUBMISSION	06/28/

SHEET TITLE
ALTERNATE
MECHANICAL PLAN

DWG. NO.

M1.0.3



POWER	
=	DUPLEX OUTLET VERIFY FINAL LOCATION W/ TENANT
⊕ GFI	DUPLEX OUTLET W/ GROUND FAULIT INTERRUPTER VERIFY FINAL LOCATION W/ TENANT
 	QUADPLEX OUTLET VERIFY FINAL LOCATION W/ TENANT
∅ W	WINDOW RECEPTACLES, FOR WINDOW DISPLAY. VERIFY FINAL LOCATION W/ TENANT
igorplus	SPECIAL PURPOSE OUTLET. VERIFY CONFIGURATION PRIOR TO INSTALLATION
\$	LIGHT SWITCH
\$ D	DIMMER SWITCH
\$ 3	3-WAY SWITCH
\$м	OCCUPANCY SENSOR
\$ P	SWITCH WITH PILOT LITE
∇	TELEPHONE OR CABLE JACK - VERIFY FINAL LOCATION W/ TENANT.
J	JUNCTION BOX
WP	WEATHERPROOF
D-1	TYPICAL PANEL CIRCUIT NO. 1
M	CEILING MOUNTED OCCUPANCY SENSOR


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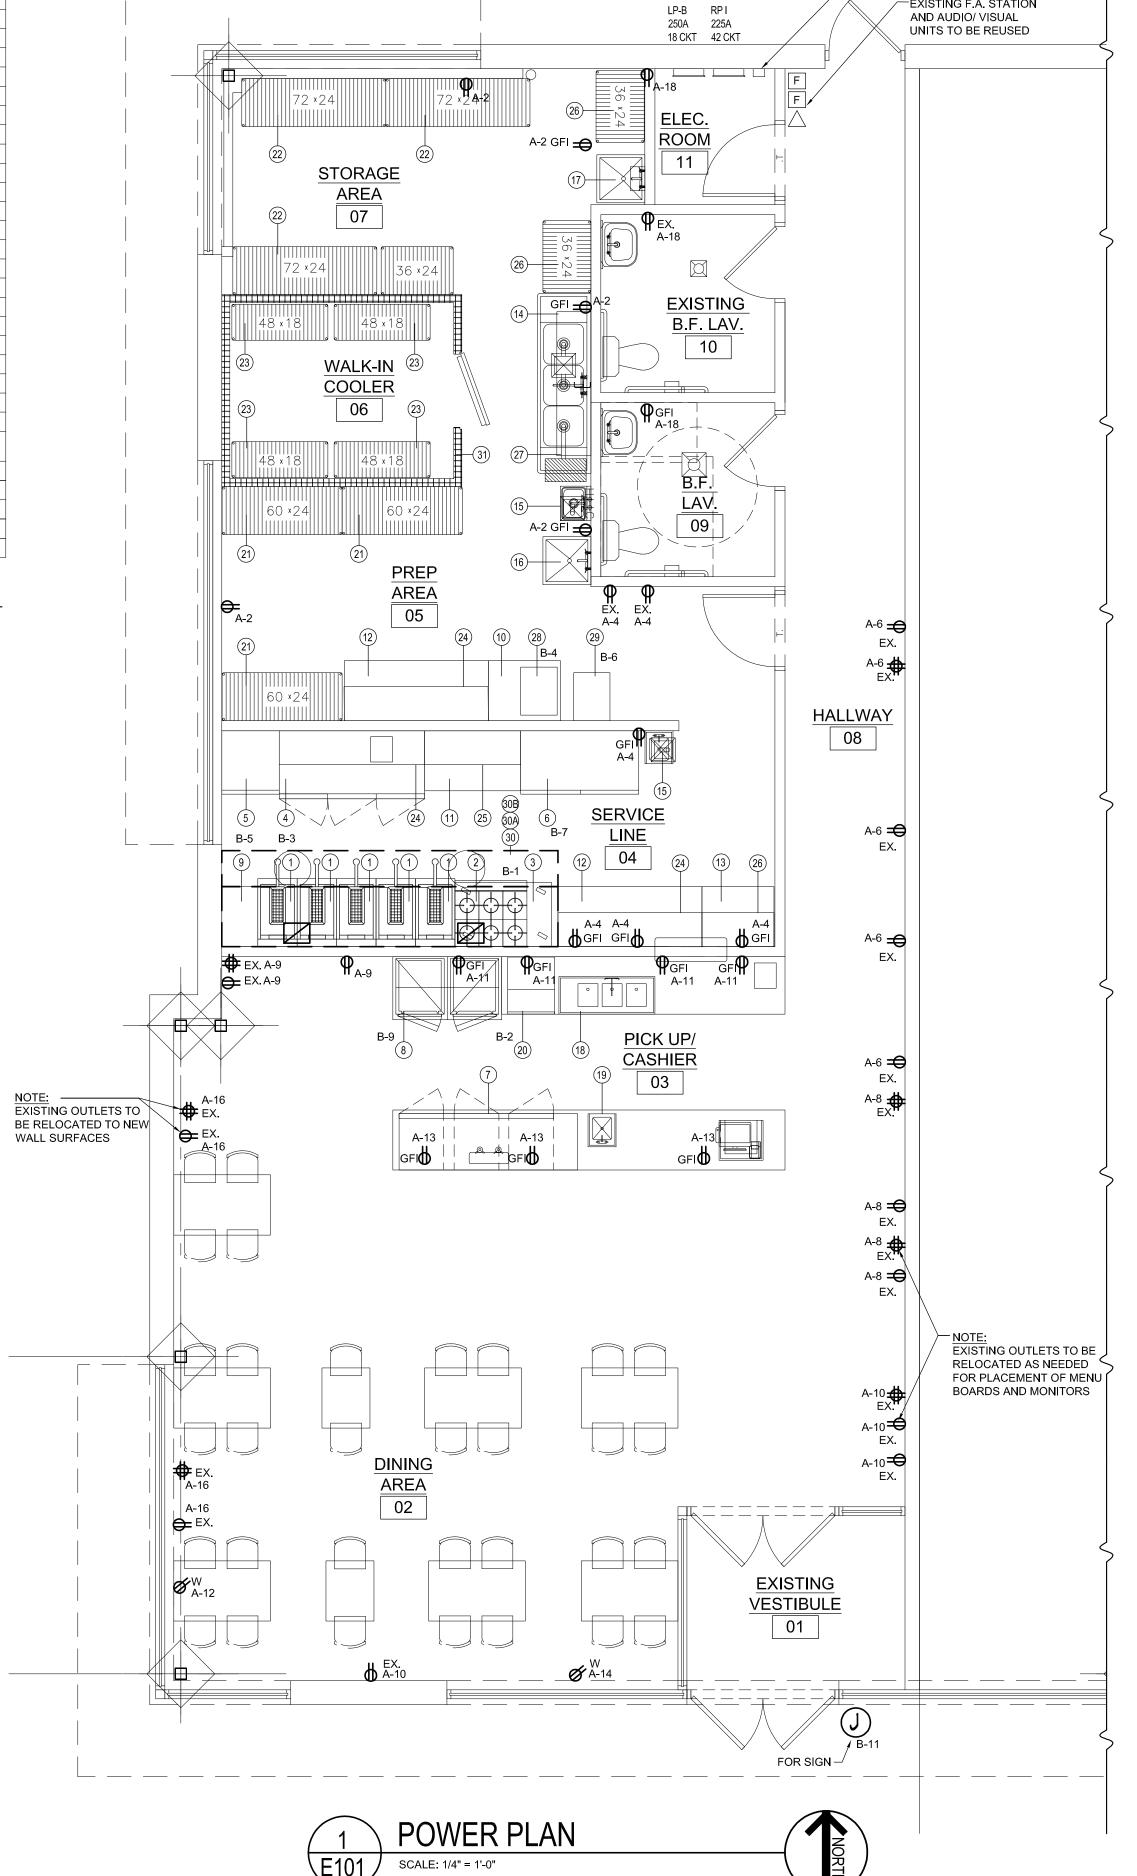
1. TELEPHONE SYSTEM TO BE PROVIDED BY TENANT. 2. VERIFY OUTLET LOCATION & HEIGHT W/ TENANT.

NOTES: ELECTRICAL

- 1. ELECTRICAL SERVICE SHALL BE VERIFIED ON SITE.
- 2. THE ELECTRICAL CONTRACTOR SHALL COMPLY WITH AND ALL WORK AND MATERIALS SHALL CONFORM TO THE REQUIREMENTS OF ALL APPLICABLE FEDERAL, STATE AND LOCAL LAWS, ORDINANCES REGULATIONS, AS WELL AS THE RULES AND STANDARDS OF THE NATIONAL BOARD OF FIRE UNDERWRITERS, THE NATIONAL ELECTRICAL CODE, THE NATIONAL SAFETY CODE, A.I.E.E. AND OSHA.
- 3. THE CONTRACTOR SHALL OBTAIN ALL PERMITS AND CERTIFICATES OF INSPECTION FOR ALL WORK.
- 4. SHOULD ANY FIELD CONDITIONS PREVENT THE INSTALLATION OF UTILITIES SHOWN, THE CONTRACTOR IS REQUIRED TO MAKE ANY MINOR DEVIATIONS THEREFROM AS DETERMINED BY THE OWNER WITHOUT ANY ADDITIONAL COST.
- 5. THE CONTRACTOR SHALL VISIT THE PROJECT SITE AND SHALL EXAMINE TO HIS SATISFACTION ALL OF THE PHYSICAL CONDITIONS.
- 6. ELECTRICAL CONTRACTOR SHALL GUARANTEE AGAINST MECHANICAL AND ELECTRICAL DEFECTS OF ANY OR ALL EQUIPMENT, MATERIALS AND WORKMANSHIP.
- 7. ELECTRICAL CONTRACTOR TO PROVIDE LAYOUTS AS SHOWN.
- 8. VERIFY ADDITIONAL UNITS REQUIRED BY OWNER/TENANT.
- 9. ALL FLUORESCENT FIXTURES TO HAVE T8 LAMPS & ELECTRONIC BALLAST.
- 10. PROVIDE OCCUPANCY SENSORS WHERE REQUIRED BY AHJ.

NO	ITEM NAME	MODEL	SIZE (W x D x H)	MANUFACTURER	BTU	QT	VOLTAGE	LOAD	PLUG
1	75LB FRYER	SG-18s	19.7 x 34.5 x 46.2	PITCO	140,000	5			
2	6 BURNER	ATHP-36-6	36.0 × 27.6 × 13.1	ATOSA	150,000	1			
3	48" CHEFBASE	ECB48D2	48.375 x 32.125 x 20	EVEREST		1	115V/ 60 HZ/ 1-PH	3.5 AMP	NEMA 5-15P
4	72" MEGA TOP	EPBR3	71.125 x 35.25 x 38.5	EVEREST		1	115V/ 60 HZ/ 1-PH	3 AMP	NEMA 5-15P
5	1 DOOR REACH IN FREEZER	ESF1	29.25 x 31.625 x 74.25	EVEREST		1	115V/ 60 HZ/ 1-PH	5 AMP	NEMA 5-15P
6	2 DOOR REACH IN FREEZER (60")	ESWF2	59.0 x 31.625 x 74.25	EVEREST		1	115V/ 60 HZ/ 1-PH	7.5 AMP	NEMA 5-20P
7	90" KEG COOLER	EBD4	89.25 x 27.0 x 37.25	EVEREST		1			
8	2 DOOR BEER 53"	EMGR48B	53.125 x 30.75 x 80.125	EVEREST		1	115V/ 60 HZ/ 1-PH	6 AMP	NEMA 5-15P
9	18 X 30" S/S WORK TABLE		18 x 30 x 34			1			
10	36 X 30" S/S EQUIPMENT STAND		36 x 30 x 26			1			
11	48 X 30" S/S WORK TABLE		48 x 30 x 34			1			
12	72 X 30" S/S WORK TABLE		72 x 30 x 34			1			
13	36 X 30" S/S WORK TABLE		36 x 30 x 34			1			
14	3 COMBINE SINK	TSA-3-12-D1	90 x 24 x 44.5	Turbo Air		1			
15	HAND SINK	HS-1615S	15.75 x 15.25 x 13.375	GSW USA		2			
16	1 PREP SINK	TSB-1-N	24 x 24	Turbo Air		1			
17	MOP SINK	TSA-1	18 x 18	Turbo Air		1			
18	BAR 3 SINK		48 x 18.75	Regency		1			
19	BAR HAND SINK					1			
20	ICE MAKER- L	UC-280-FA	26 x 27 x 39	Avantco		1	115V/ 60 HZ/ 1-PH	8.6 AMP	NEMA 5-15P
21	24 X 60" EPOXY WIRE SHELVES					3			
22	24 X 72" EPOXY WIRE SHELVES					5			
23	18 X 48" EPOXY WIRE SHELVES					4			
24	72" DOUBLE OVER SHELVES					3			
25	48" DOUBLE OVER SHELVES					1			
26	36" DOUBLE OVER SHELVES					1			
27	72" Wire Wall Shelves					1			
28	Vacuum Tumbler	VTS 42		Biro		1	115V/ 60 HZ/ 1-PH	DRIVE 0.61 AMP PUMP 4.20 AMP	3-PRONG PLUG
29	Oil Filter	PF80		Frymaster		1	120V/ 60HZ/ 1-PH	6.2 AMP	
30						1			
30A						2			
30B						1			
31						1			



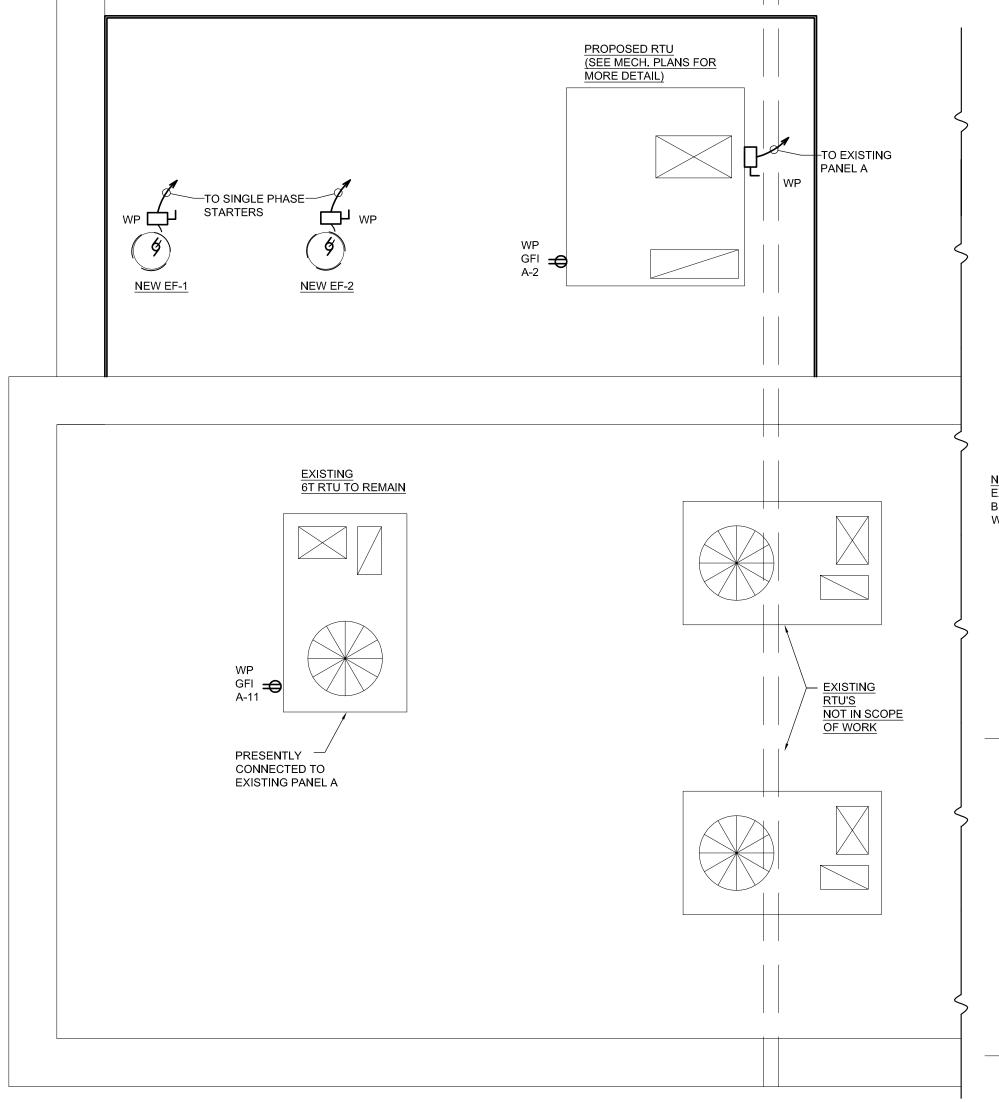



SINGLE PHASE
STARTERS FOR HOOD

EXISTING F.A. STATION
AND AUDIO/ VISUAL

EF-1 & EF-2

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PROJECT NAME: **KOREAN BBQ**

248.457.6903

PERMIT SUBMISSION 06-28-22

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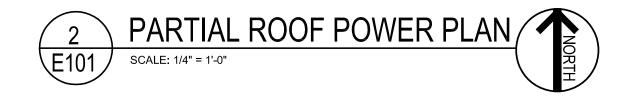
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JOB NO.	22-0987
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SHEET TITLE **POWER PLAN**

DWG. NO.

E1.0.1



ELECTRICAL	LIGHTING SCHEDULE	
LIGHTING		LOCATION
"A"	NEW 2'x2' SURFACE MOUNTED FIXTURE. SELECTED BY CONTRACTOR AND APPROVED BY OWNER.	B.F. LAV.
- 	WAREHOUSE PENDANT HANGING LED LIGHT LAMP 20W MAX LED.	DINING AREA
© "E © ⊘	TRACK LIGHTING WITH ADJUSTABLE HEADS, LAMP 20W MAX LED.	DINING AREA, PICK UP AREA
"ر" -	WALK IN COOLER LIGHT FIXTURE BY COOLER CONTRACTOR.	WALK IN COOLER
OO	HOOD LIGHT FIXTURE BY HOOD CONTRACTOR.	HOOD
"EX"	EXISTING 2'x2' LAY IN GRID FIXTURE. LIGHTING TO BE SALVAGED AND REINSTALLED AS SHOWN / AS NEEDED PER TENANT LAYOUT	SERVICE LINE, PREP AREA,
EX"	EXISTING 2'x2' LIGHT/EXHAUST COMBO FIXTURE.	B.F. LAV.
	EXISTING 1'x4' SURFACE MOUNTED FIXTURE.	STORAGE, ELECTRICAL ROOM
Q _{'EX"}	EXISTING RECESSED LIGHTING FIXTURE	EXISTING VESTIBULE
†	WALL OR CLG. MTD. SELF CONTAINED EXIT FIXTURE W/ ARROWS INDICATED. ISOLITE RS SERIES OR EQUAL.	
EM/X	EXIT LIGHT W/ EMERGENCY HEADS	
EM/X/R	COMBO EMERGENCY/EXIT LIGHT, 6 VOLTS WITH 22 WATT BATTERY CAPACITY FOR REMOTE HEAD. ISOLITE CMB SERIES OR EQUAL	
REM	REMOTE EMERGENCY HEAD - WEATHERPROOF ISOLITE SB12W OR EQUAL	
~	WALL OR CLG. MTD. EMERGENCY BATTERY UNIT W/ 2 SIDE MTD. ADJUSTABLE HEADS W/ BATTERY BACK-UP ISOLITE EL2 SERIES OR EQUAL.	

^{1.} EMERGENCY POWER SHALL HAVE A MINIMUM OPERATION OF 90 MINUTES. 2. EMERGENCY EXIT & BATTERY UNITS TO BE CONNECTED TO LOCAL LTG CIRCUIT


DISTRIBUTION	
	SUPPLY AIR GRILLE - SEE MECHANICAL PLAN
	SUPPLY AIR GRILLE - SEE MECHANICAL PLAN
	RETURN AIR GRILLE - SEE MECHANICAL PLAN
	EXHAUST FAN - SEE MECHANICAL PLAN

GENERAL NOTES

- SEE VENTILATION AND MECHANICAL EQUIPMENT DRAWINGS FOR ELECTRICAL WIRING OF HOOD, SUPPLY FANS, EXHAUST FANS AND ROOF TOP UNITS. PROVIDE ALL INTER-WING AND WIRING FOR HOOD FIRE PROTECTION SYSTEM AS NOTED. INTERCONNECT WITH BUILDING FIRE ALARM SYSTEM
- AS REQUIRED BY AHJ. COORDINATE WITH EQUIPMENT INSTALLER. 2. PROVIDE ALL STARTERS REQUIRED FOR FANS. STARTERS TO INCLUDE. CONTROL TRANSFORMERS, SWITCHES WITH AUXILIARY CONTACTS FOR EQUIPMENT CONTROL AND PILOT
- LIGHT. COORDINATE WITH EQUIPMENT INSTALLER. 3. MAINTAIN AND EXTEND EXISTING BUILDING FIRE ALARMS SYSTEM IN REMODELED AREAS AS REQUIRED BY AHJ. COORDINATE WITH SYSTEM REPRESENTATIVE.
- REMOVE ALL ELECTRICAL EQUIPMENT AND WIRING NOT REUSED IN REMODELED AREAS. 5. CLEAN AND RELAMP EXISTING LIGHTING FIXTURES REUSED. RECONNECT TO EXISTING CIRCUITS
- 6. RECONNECT EXISTING RECEPTACLES, REUSED, TO EXISTING CIRCUITS IF STABLE, PROVIDE NEW 7. CIRCUITS SHOWN ARE NOT, NECESSARY, CIRCUITS TO BE USED, BUT METHOD OF CIRCUITING.
- REUSE EXISTING IF SUITABLE. VERIFY IN FIELD. 8. ALL OUTLETS WITHIN 6' OF SINKS AND OUTLETS IN PREP, STORAGE AND SERVICE LINE AREAS TO
- 9. EXTEND EXISTING OUTLETS, REUSED, TO NEW WALL SURFACES WHERE REQUIRED. SEE ARCHITECTURAL DRAWINGS.


OAD DESCRIPTION	KVA	C.B. SIZE	Α	В	С	C.B. SIZE	KVA	LOAD DESCRIPTION
GEN & COOLER LTG	1.1	1	-			2	1.0	5 🗲
GEN LTG	1.0	3		\downarrow		4_	1.2	6 🗲
GEN LTG	2.4	5			\downarrow	6	1.2	6 🗲
GEN LTG	2.4	7	-			8	1.2	6 €
4 👄	0.8	9		-		10	1.0	5 €
4 🗲	0.8	11			+	12	1.1	WINDOW 👄
⊕	0.6	13				14	1.1	WINDOW 😝
		15		\perp		16	1.2	6 €
		17			\bot		0.8	4 🗲
		19	_					
		21		+				
NEW RTU		23			+			
3# 4 & 1# 8 (G)1-1/4"C	20.0	25 70	+	\perp	\bot			
		27		+	\bot			
		29		\perp	+	30		
		31				32		
		33		+		34		
		35		\perp	+	36		
EXISTING		37		+	\perp	38	_	EXISTING
RTU-1	11.0	39 60		+	+	60 40	8.8	PANEL B
		41 \		+	+	42		
	40.1		ļ	ļ	Å		18.6	
			(-	∥ SRD	Î	MAINS	: <u>200A-3P</u> I	MLO

LOAD DESCRIPTION	KVA	C.B. SIZE	Α	В	С	C.B. SIZE	KVA	LOAD DESCRIPTION
KIT ITEM #3	0.5	1				2	1.0	KIT ITEM #20
KIT ITEM #4	0.4	3				4_	0.6	KIT ITEM #28
KIT ITEM #5	0.6	5				6	0.8	KIT ITEM #29
KIT ITEM #6	0.9	7	-			8	1.0	EF-1
KIT ITEM #8	0.7	9		-		10	1.0	EF-2
SIGN	1.2	11				12	1.2	SHUNT TRIP BRK. HOOD FA PANE
WALK-IN COOLER		13	-			14		
3# 12 & 1# 12(G)-1/2"C	1.0	15 20		-		16		
VERIFY		17				18		
	5.3						5.6	
ALL CIRCUIT BREAKE BE 20A-1P UNLESS OT			°	GRD BUS	ا آ	TO'	3: 200A MLO TAL CONNECTAL DEMAND	CTED LOAD: 10.9 KVA

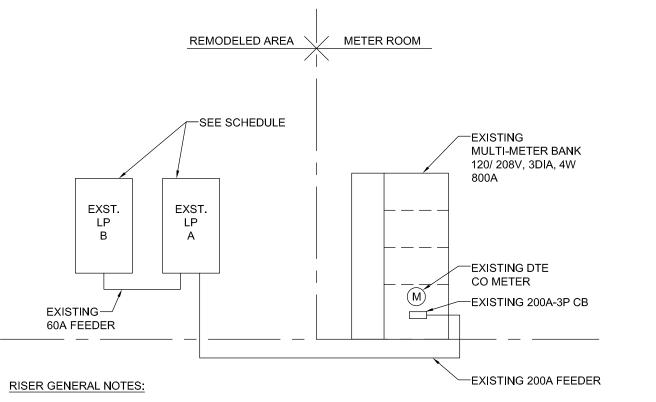

- ALL ELECTRICAL EQUIPMENT IS EXISTING UNLESS OTHERWISE NOTED. TIGHTEN ALL EXISTING CONDUCTORS WHEN REQUIRED. REMOVE CONDUCTORS NOT USED.
- SEE PANEL SCHEDULES FOR BRANCH CIRCUIT AND PANEL LOAD INFORMATION. PROVIDE NEW TYPE WRITTEN DIRECTORIES FOR EACH PANEL BOARD.
- PROVIDE ENGRAVED NAMEPLATES FOR ALL EQUIPMENT INCLUDING LP'S AND MAIN CIRCUIT BREAKER. NAMEPLATES TO IDENTIFY EQUIPMENT AND VOLTAGE. CO-ORDINATE WITH OWNER.
- REMOVE ALL EXISTING MARKINGS ON EQUIPMENT. CONTRACTOR SHALL VISIT THE SITE AND SHALL EXAMINE TO HIS SATISFACTION, ALL OF THE EXISTING PHYSICAL CONDITIONS. PROVIDE FULL MAINTENANCE OF ALL ELECTRICAL EQUIPMENT PER NETA STANDARDS.
- REPLACE ALL DEFECTIVE EQUIPMENT. VERIFY CONTINUITY OF ALL GROUNDING SYSTEMS. REPAIR OR REPLACE IF NEEDED.
- 11. REPLACE FUSES IN FUSIBLE SWITCHES, FOR REMODELED AREAS, WHICH ARE TO BE REUSED.



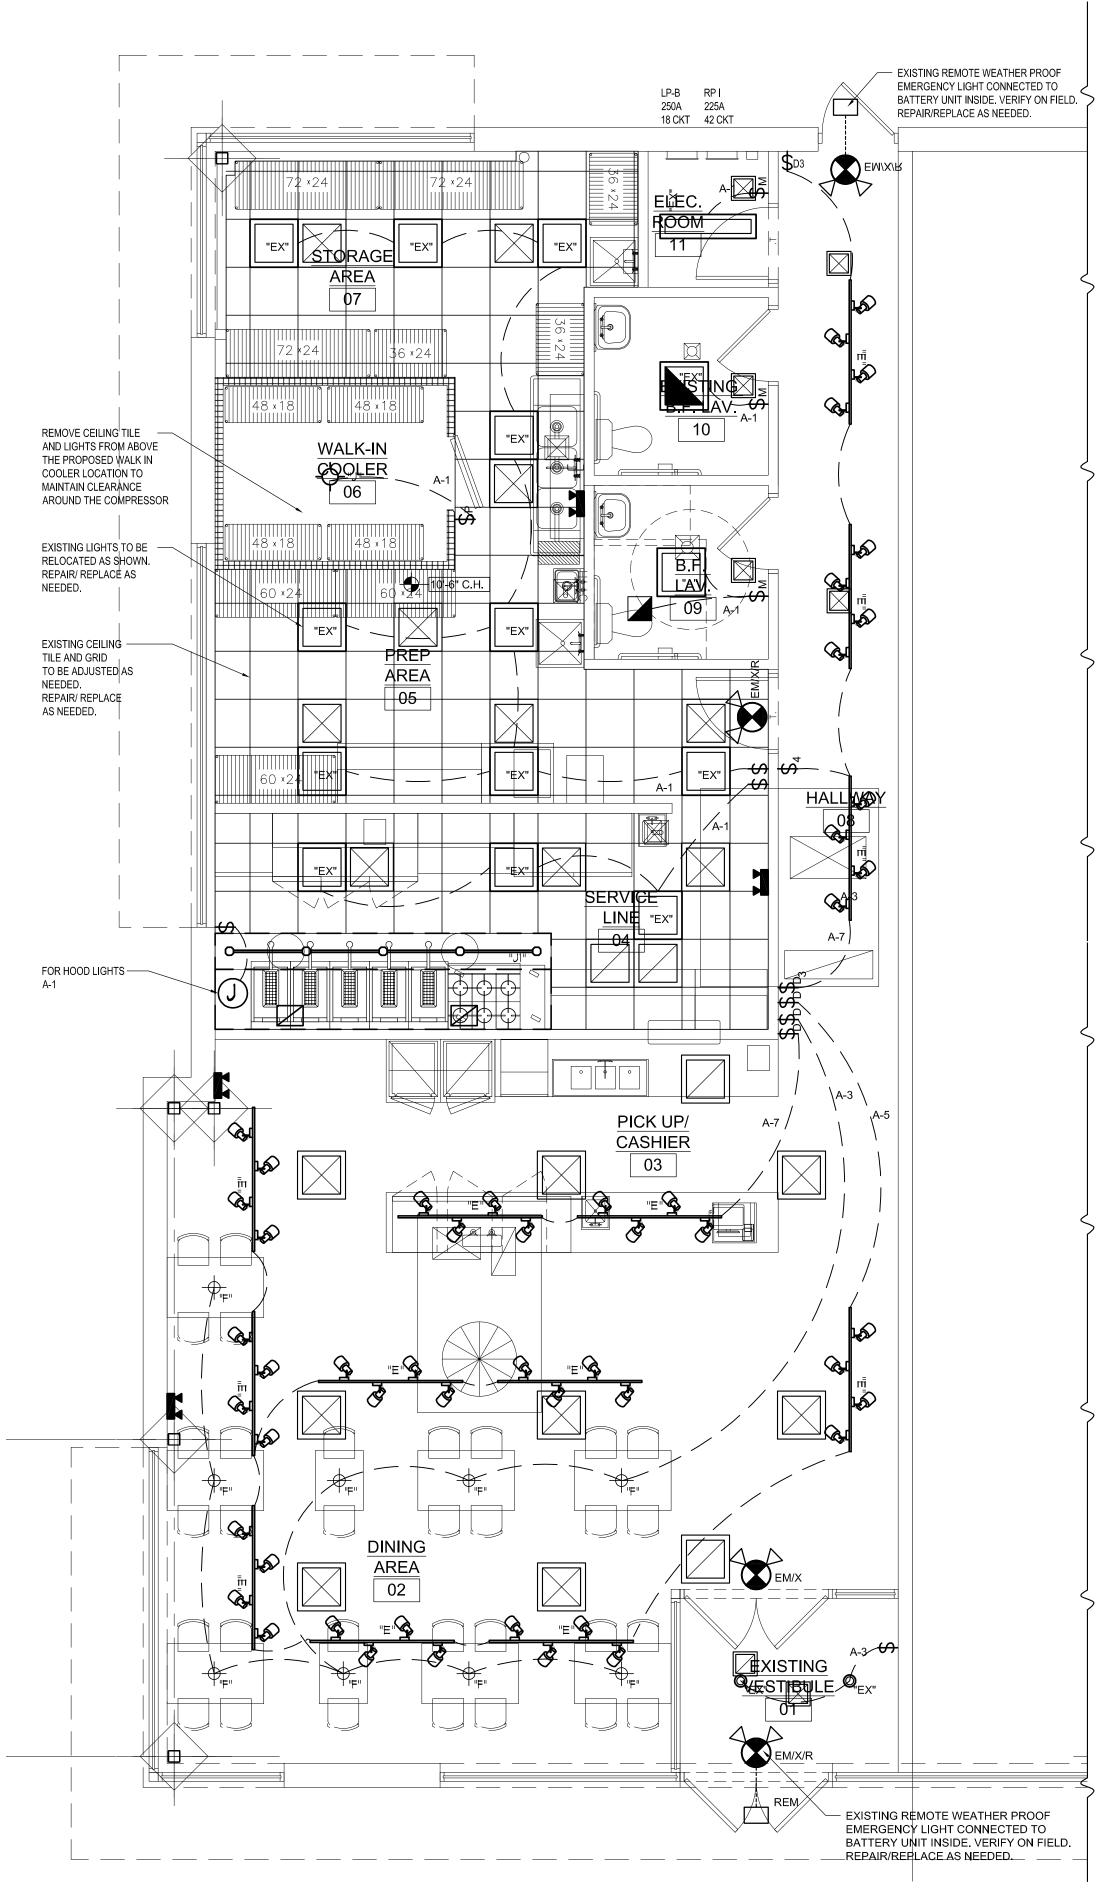

LIGHTING/ REFLECTED CEILING PLAN



Architects

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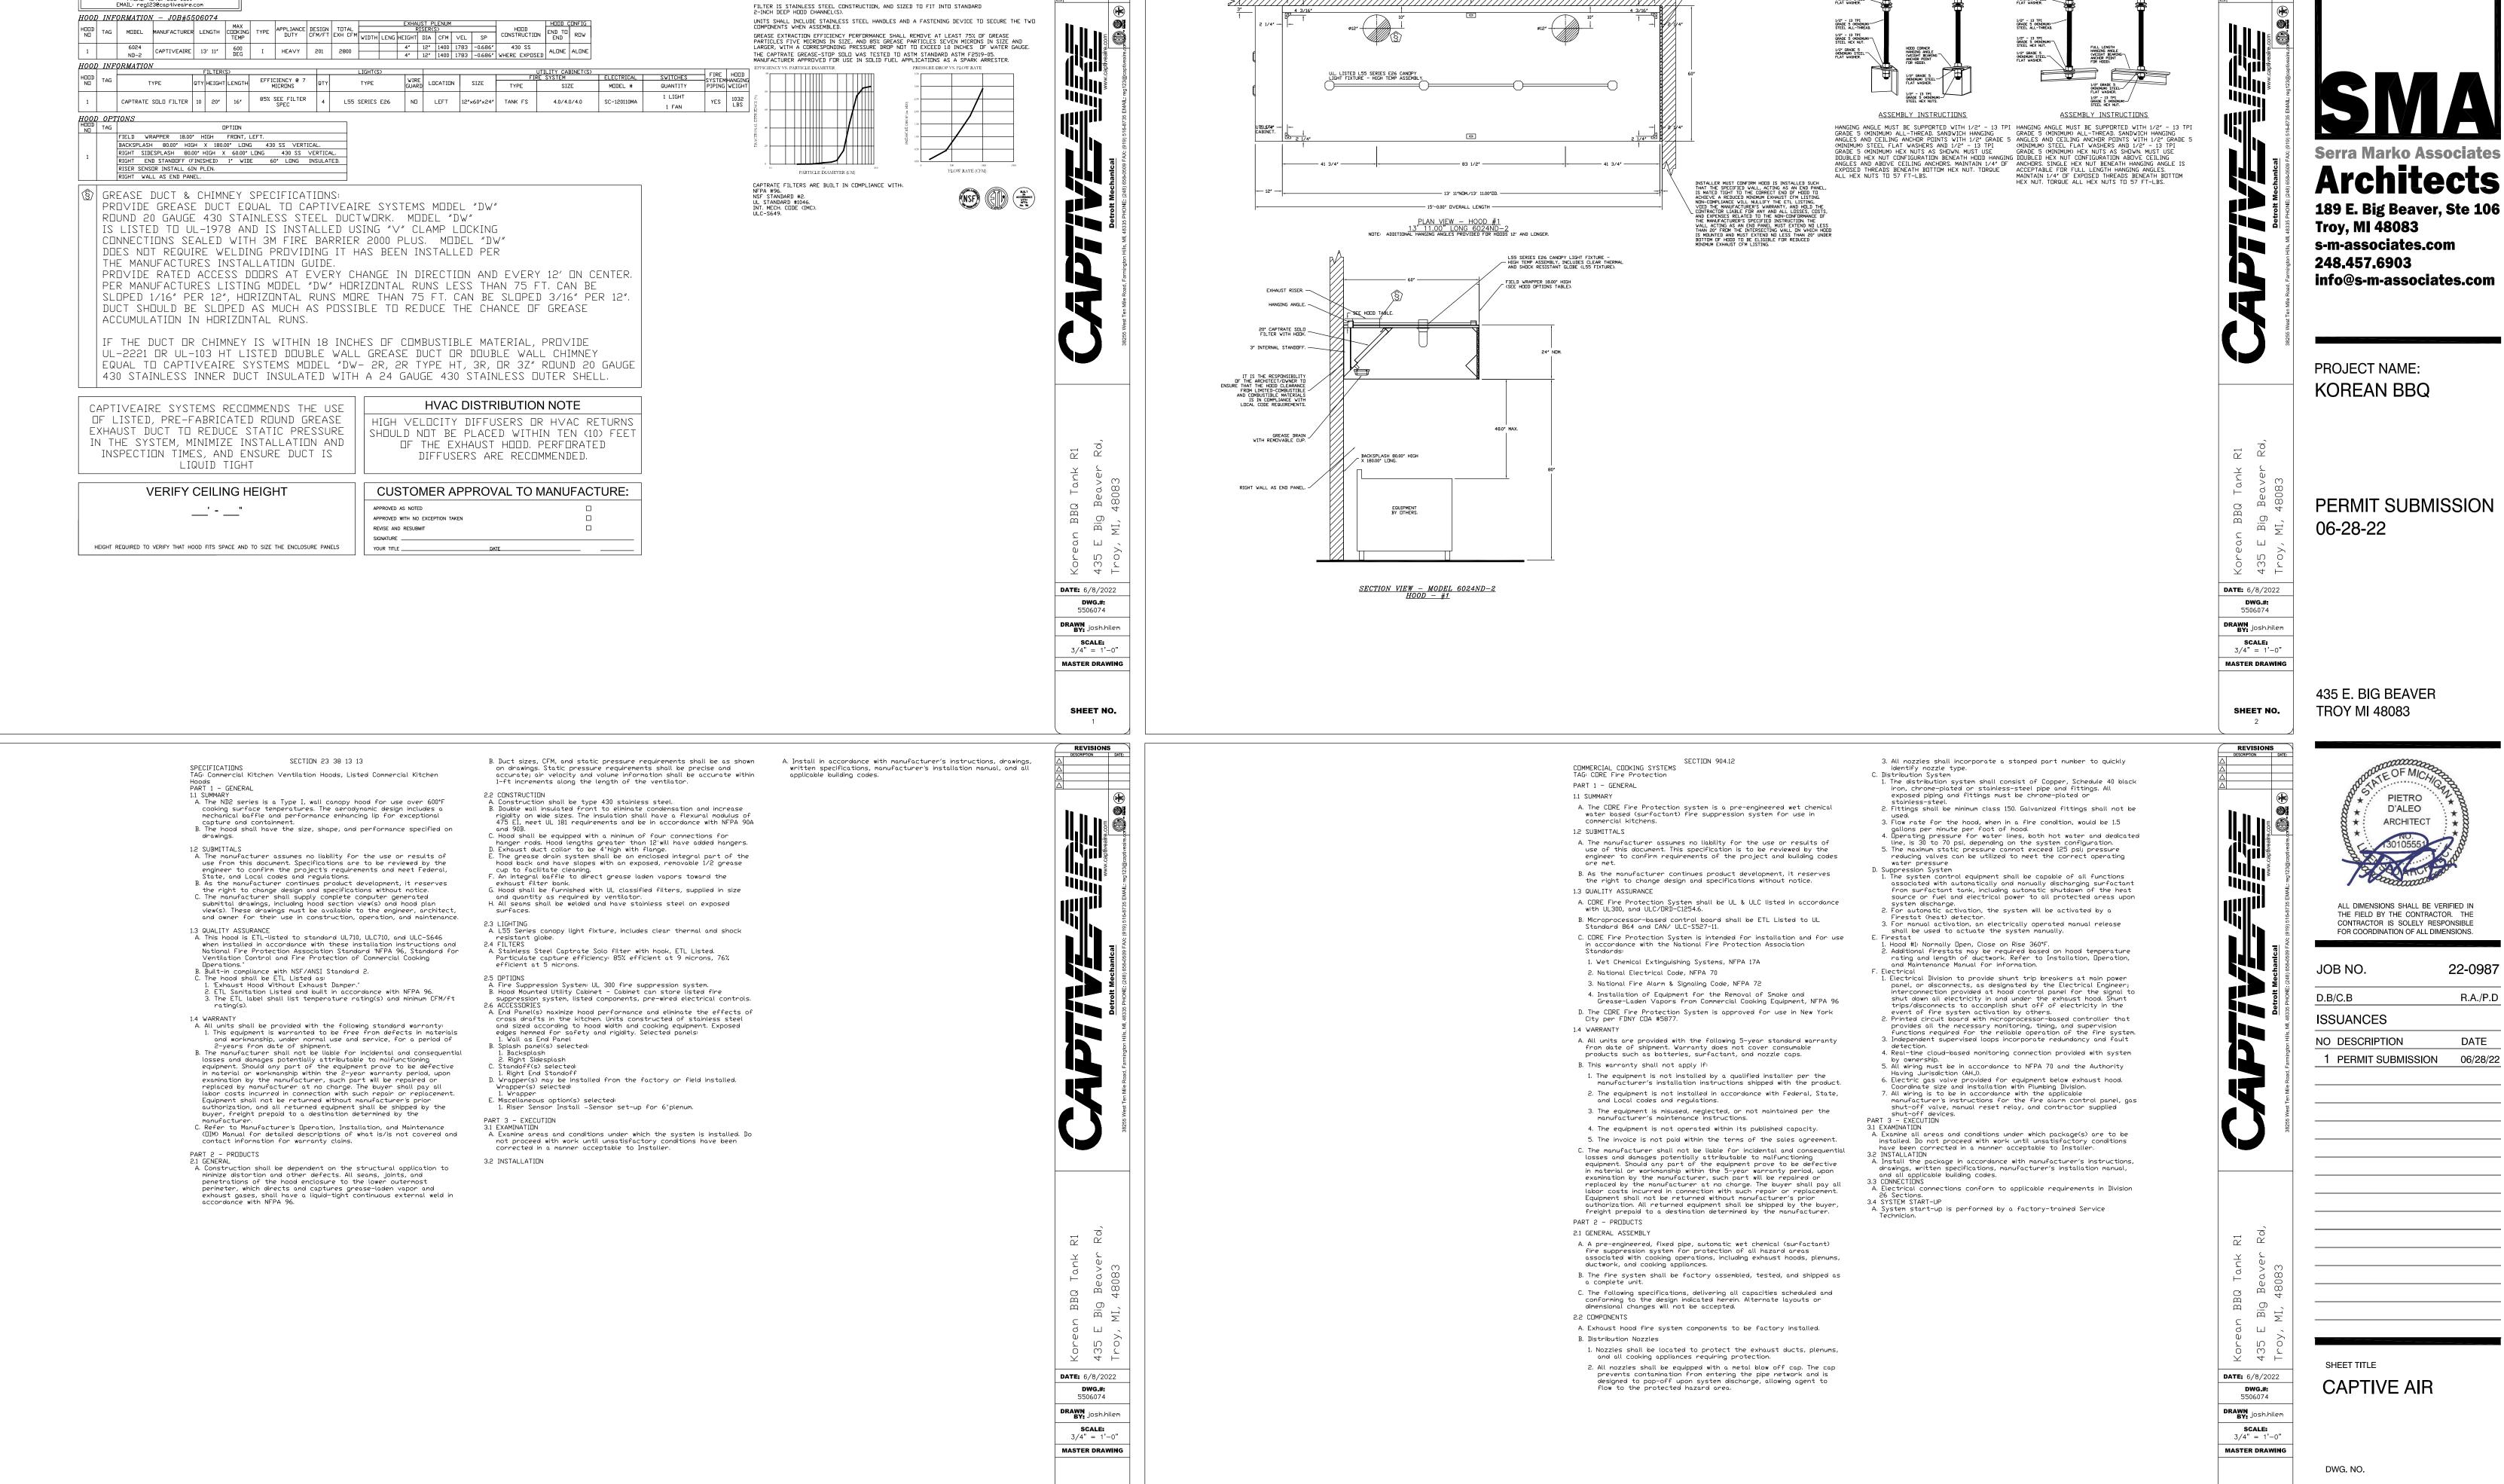


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FOR COORDINATION OF ALL DIMENSIONS.

JO	B NO.	22-0987
D.B	/C.B	R.A./P.[
ISS	SUANCES	
NO	DESCRIPTION	DATE
1	PERMIT SUBMISSION	06/28/2

SHEET TITLE LIGHTING/ REFLECTED **CEILING PLAN**



SHEET NO.

REVISIONS
DESCRIPTION DATE:

SPECIFICATION: CAPTRATE GREASE-STOP SOLD FILTER

THE CAPTRATE GREASE-STOP SOLO FILTER IS A SINGLE-STAGE FILTER FEATURING A UNIQUE S-BAFFLE DESIGN IN COUNCTION WITH A SLOTTED REAR BAFFLE DESIGN, TO DELIVER EXCEPTIONAL FILTRATION EFFICIENCY.

PATENT NUMBERS

EXHAUST HOODS ND-2/BD-2/SND-2 (CANADA) - CA PATENT 2520435 C

REVISIONS

DESCRIPTION DATE:

HANGING ANGLE HARDWARE BY INSTALLER

1/2" - 13 TPI GRADE 5 (MINIMUM) — STEEL HEX NUTS.

1/2' GRADE 5 (MINIMUM) STEEL— FLAT WASHER.


HANGING ANGLE ROWARE BY INSTALLER)


1/2" - 13 TPI GRADE 5 (MINIMUM) — STEEL HEX NUTS.

1/2' GRADE 5 (MINIMUM) STEEL-FLAT WASHER.

189 E. Big Beaver, Ste 106

SHEET NO.

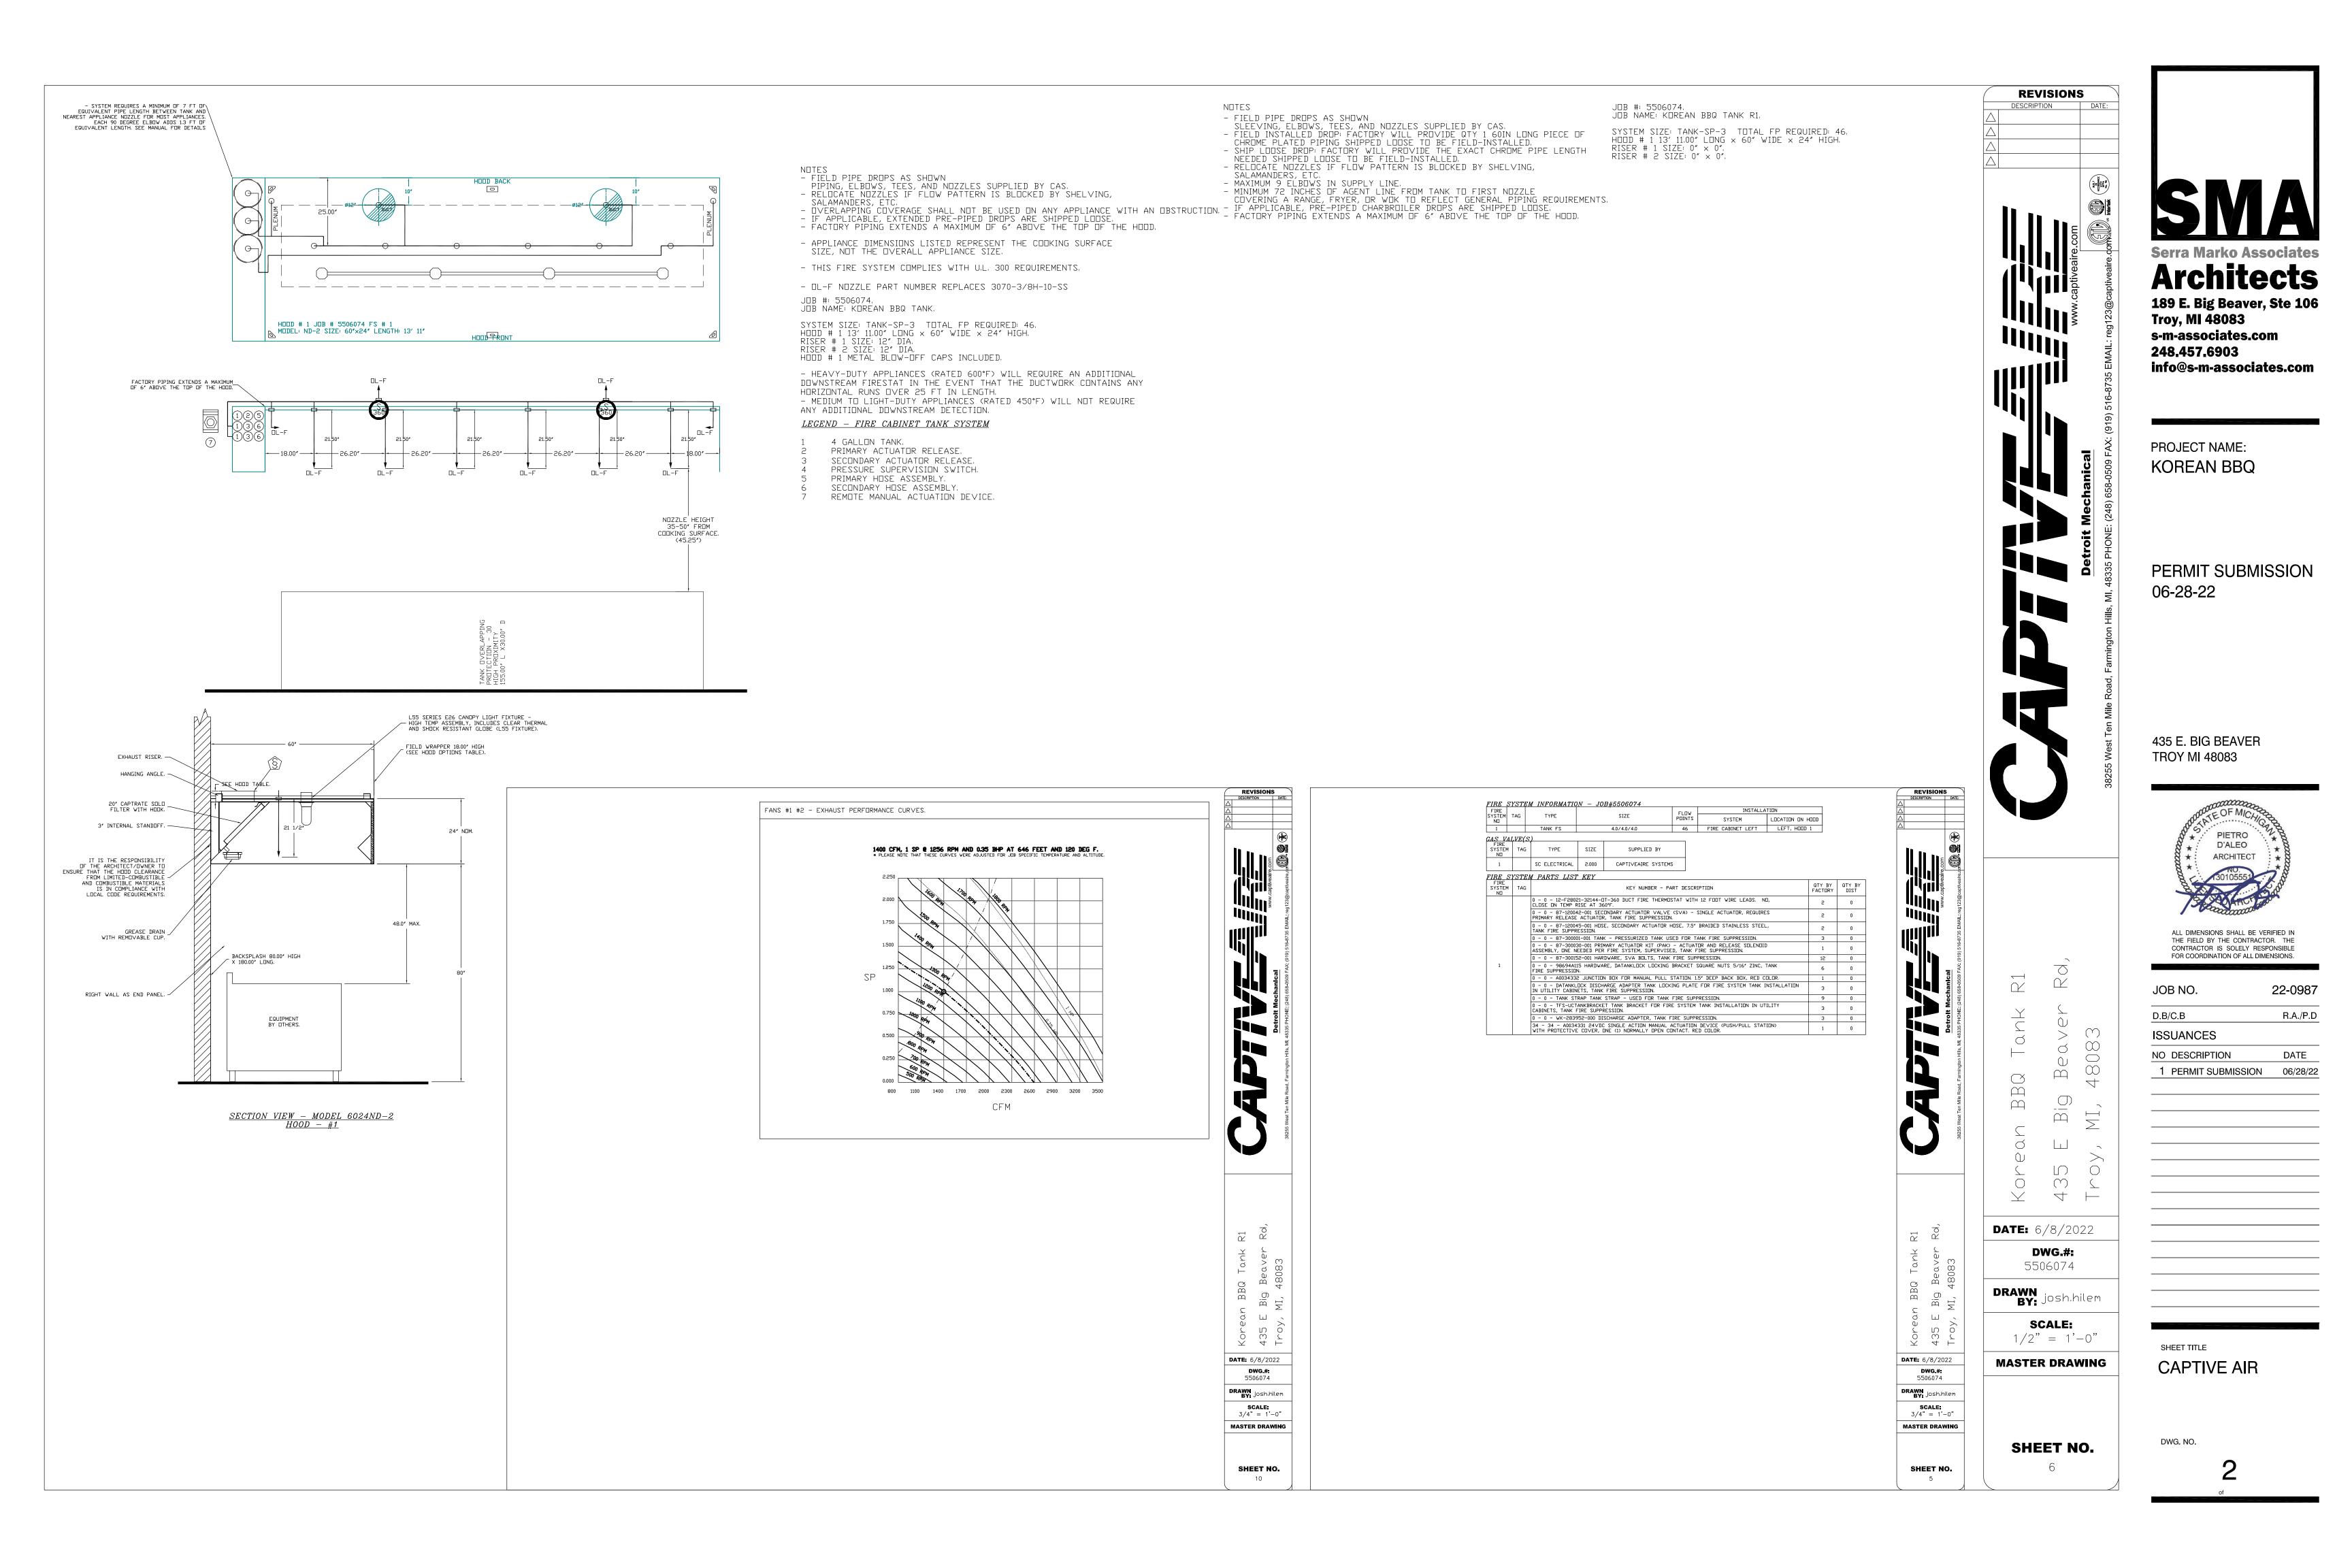

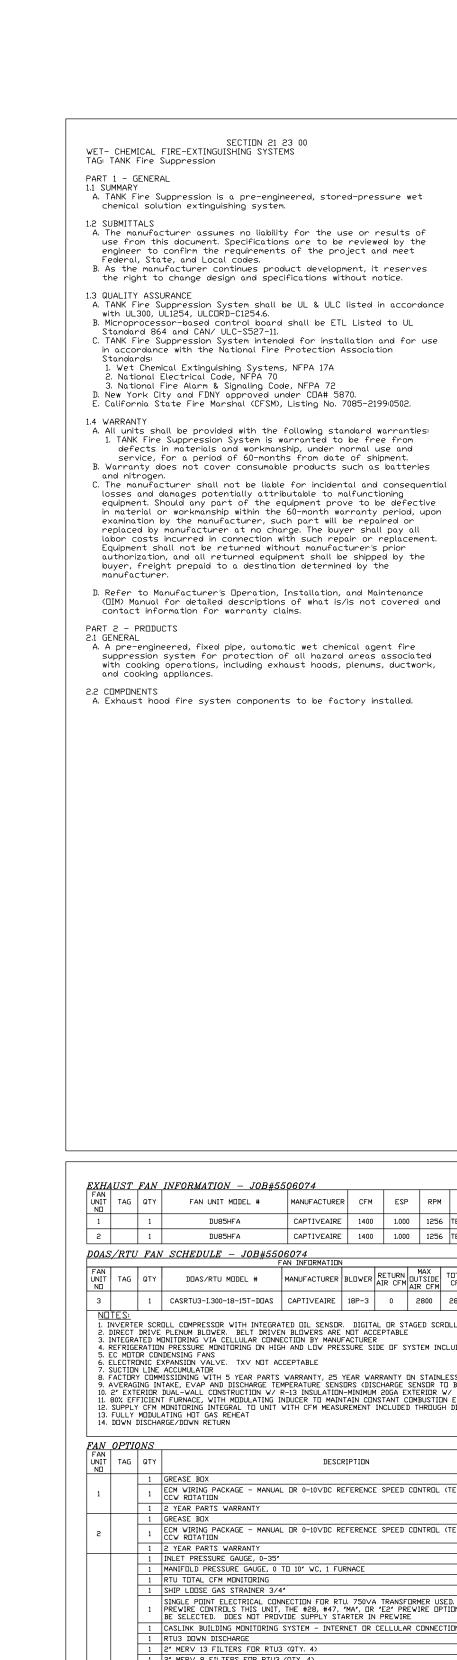

UNIT SOUND DATA

SOUND DATA

B. Cylinder and Valve Assembly
1. The cylinders shall have a tin-nickel alloy plated brass valve with

pressure gauge.

2. Wet chemical agent shall be contained in one or more stored pressure DOT/TC rated steel cylinder and valve assemblies.

3. Each cylinder is factory-filled with liquid fire suppressant and pressurized to 200 PSIG at 70°F.

C. Distribution Nozzles

1. Nozzles shall be located to protect the exhaust ducts, plenums, and all cooking appliances requiring protection.

2. All nozzles shall be equipped with a metal blow off cap. The cap prevents contamination from entering the pipe network and is designed to pop-off upon system discharge, allowing agent to flow to the protected hazard area.

3. All nozzles shall incorporate a stamped part number to easily identify nozzle type.

identify nozzle type.

D. Distribution System

1. The distribution system shall consist of Copper, Schedule 40 black iron, chrome-plated or stainless-steel pipe and fittings. All exposed piping and fittings must be chrome-plated or stainless

2. Fittings shall be minimum class 150. Galvanized fittings shall not be used.

E. Suppression System

1. The system control equipment shall be capable of all functions associated with automatically and manually discharging the wet chemical agent from all cylinder and valve assemblies, including automatic shutdown of the heat source or fuel and electrical

power to all protected areas upon system discharge.

2. Liquid Fire Suppressant shall be Aqueous Potassium Carbonate 3. All mechanical components of the actuator kit shall be enclosed. 4. The actuator kit shall be capable of automatic or manual

activation means.

5. Supervisory Pressure Switch added to monitor operating system 5. Supervisory Fressure Smitch added to holder specified, pressure.

6. For manual activation, an electrically operated manual release shall be used to actuate the system manually.

7. For automatic activation, the system will be activated by a Firestat (heat) detector.

F. Electrical
1. Electrical Division to provide shunt trip breakers at main power 1. Electrical division to provide shunt trip breakers at main power panel, or disconnects, as designated by the Electrical Engineer; interconnection provided at hood control panel for the signal to shut down all electricity in and under the exhaust hood. Shunt trips/disconnects to accomplish shut off of electricity in the event of fire system activation by others.

2. Printed circuit board with microprocessor-based controller that provides all the necessary monitoring, timing, and supervision functions required for the reliable operation of the fire system.

3. Independent supervised loops incorporate redundancy and fault

4. Real-time cloud-based monitoring connection provided with system by ownership.

5. Primary power supply, with battery backup for power loss.

6. All wiring must be in accordance to NFPA 70 and the Authority Having Jurisdiction (AHJ).

7. Electric gas valve provided for equipment below exhaust hood.

Coordinate size and installation with Plumbing Division.

8. All wiring is to be in accordance with the applicable manufacturer's instructions for the fire alarm control panel, gas shut-off valve, manual reset relay, and contractor supplied chut-off devices.

3.1 EXAMINATION

A. Examine areas and conditions under which the system is installed. Do not proceed with work until unsatisfactory conditions have been corrected in manner acceptable to Installer.

A. Wet chemical-based fire suppression system for use in commercial kitchens. It can be mounted in the integral cabinet located at the end of the hood or offered as a wall mount package.

A. As part of this item, provide wall mounted type K handheld portable fire extinguisher, placard, and mounting bracket as required in the immediate vicinity of each cooking area, per NFPA-96 and NFPA-10.

Additional fire extinguishers as required in the kitchen area are to e specified by the Architect and provided by the General

Contractor.
B. Install in accordance with manufacturer's instructions, drawings, written specifications, manufacturer's installation manual, and all applicable building codes.
C. Six-month and twelve-month inspections, servicing, and replacement of components as per NFPA 96 to be provided by the General

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DATE: 6/8/2022

5506074

DRAWN BY: josh.hilem

SCALE:

MASTER DRAWING

DRAWN BY: josh.hilem

3/4" = 1'-0'

MASTER DRAWING

SHEET NO.

GAS VALVES AND STRAINERS GAS VALVE SIZING

| TYPE | SIZE | VOLTAGE | MIN. INLET | PRESSURE -ELECTRIC GAS VALVE. FLOW.

ALL GAS VALVES/STRAINERS

PROPER CLEARANCE MUST BE PROVIDED IN ORDER TO SERVICE THE STRAINERS A MINIMUM OF 4" CLEARANCE DISTANCE MUST BE PROVIDED AT THE ASSE OF THE STRAINER OLSTOMER MUST VERIFY BTU CONSUMPTION AS WELL AS PRESSURE RATING SPECIFIC GRAVITY OF CONSUMPTION AS WELL AS PRESSURE RATING SPECIFIC GRAVITY OF NATURAL GAS = 0.64, SPECIFIC GRAVITY OF LP = 1.52.



DATE: 6/8/2022

5506074

DRAWNBY: josh.hilem

SCALE:

MASTER DRAWING

SHEET NO.

REVISIONS
DESCRIPTION DATE:

PROJECT NAME: **KOREAN BBQ**

Troy, MI 48083

248.457.6903

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PERMIT SUBMISSION 06-28-22

Architects

189 E. Big Beaver, Ste 106

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435 E. BIG BEAVER TROY MI 48083



D.B	/C.B	R.A.,
ISS	SUANCES	
NO	DESCRIPTION	DAT
1	PERMIT SUBMISSION	06/2

FOR COORDINATION OF ALL DIMENSIONS.

DATE: 6/8/2022 5506074 **DRAWN BY:** josh.hilem 3/4" = 1'-0" MASTER DRAWING

SHEET NO.

SHEET NO. DOAS/RTU FAN SCHEDULE - JOB#5506074

FAN INFORMATION FAN INFORMATION FAN INFORMATION FOR FAN INFORMATION F CASRTU3-1.300-18-15T-DDAS CAPTIVEAIRE 18P-3 0 2800 2800 2490 1.000 3.00 1.74 3 208 63.44 70A 90.0°F 73.0°F 90.0°F NOTES:

1. INVERTER SCROLL COMPRESSOR WITH INTEGRATED DIL SENSOR. DIGITAL OR STAGED SCROLL NOT AN APPROVED EQUAL

2. DIRECT DRIVE PLENUM BLOWER. BELT DRIVEN BLOWERS ARE NOT ACCEPTABLE

3. INTEGRATED MONITORING VIA CELLULAR CONNECTION BY MANUFACTURER

4. REFRIGERATION PRESSURE MONITORING DN HIGH AND LOW PRESSURE SIDE OF SYSTEM INCLUDED THROUGH DIGITAL INTERFACE

5. EC MOTION CONDENSING FANS

6. ELECTRONIC EXPANSION VALVE. TXV NOT ACCEPTABLE

7. SUCTION LINE ACCUMULATOR

8. FACTORY COMMISSIDNING WITH 5 YEAR PARTS WARRANTY, 25 YEAR WARRANTY ON STAINLESS STEEL HEAT EXCHANGER

9. AVERAGING INTAKE, EVAP AND DISCHARGE TEMPERATURE SENSORS (DISCHARGE SENSOR TO BE FACTORY MOUNTED WITHIN UNIT)

10. 2° EXTERIOR DUAL-WALL CONSTRUCTION W/ R-13 INSULATION-MINIMUM 20GA EXTERIOR W/ 14GA BASE

11. BOX EFFICIENT FURNACE, WITH MODULATING INDUCER TO MAINTAIN CONSTANT COMBUSTION EFFICIENCY ACROSS FIRING RANGE. 6:1 TURNDOWN WITH NG AND 5:1 TURNDOWN WITH LP

12. SUPPLY CFM MONITORING INTEGRAL TO UNIT WITH CFM MEASUREMENT INCLUDED THROUGH DIGITAL INTERFACE

14. DOWN DISCHARGE/DOWN RETURN ECM WIRING PACKAGE - MANUAL DR 0-10VDC REFERENCE SPEED CONTROL (TELCO MOTOR), CCW ROTATION FANS #1, #2 - DU85HFA EXHAUST FAN FEATURES: - DIRECT DRIVE CONSTRUCTION (NO BELTS/PULLEYS). - ROOF MOUNTED FANS. ECM WIRING PACKAGE - MANUAL OR 0-10VDC REFERENCE SPEED CONTROL (TELCO MOTOR), CCW ROTATION - RODF MOUNTED FANS.
- RESTAURANT MODEL.
- UL705 AND UL762 AND ULC-S645
- VARIABLE SPEED CONTROL.
- INTERNAL VIRING.
- THERMAL OVERLOAD PROTECTION (SINGLE PHASE). - HIGH HEAT OPERATION 300°F (149°C). GREASE CLASSIFICATION TESTING. - NEMA 3R SAFETY DISCONNECT SWITCH. NORMAL TEMPERATURE TEST
EXHAUST FAN MUST OPERATE CONTINUOUSLY
WHILE EXHAUSTING AIR AT 300°F (149°C)
UNTIL ALL FAN PARTS HAVE REACHED
THERMAL EQUILIBRIUM, AND WITHOUT ANY
DETERIORATING EFFECTS TO THE FAN WHICH
WOULD CAUSE UNSAFE OPERATION. CASLINK BUILDING MONITORING SYSTEM - INTERNET OR CELLULAR CONNECTION REQUIRED ABNORMAL FLARE-UP TEST
EXHAUST FAN MUST OPERATE CONTINUOUSLY
WHILE EXHAUSTING BURRING GREASE VAPORS
AT 600°F (316°C) FOR A PERIOD OF
15 MINUTES WITHOUT THE FAN BECOMING
DAMAGED TO ANY EXTERN THAT COULD CAUSE
AN UNSAFE CONDITION. PITCHED CURBS ARE AVAILABLE FOR PITCHED ROOFS. 1 DVERHEAT STAT
1 VFD FACTORY MOUNTED AND WIRED IN RTU COMMERCIAL CONTROL VESTIBULE
1 REMOTE TEMPERATURE AND HUMIDITY SPACE SENSOR
1 RTU3 CURB DUCT HANGER EXAMPLE: 7/12 PITCH = 30° SLOPE. VAV PACKAGE W/ MANUAL/DDC CONTROL (571 VFD INCLUDED)


15 TON MODULATING COOLING OPTION, 208/230V. R410A REFRIGERANT, VARIABLE SPEED COMPRESSOR, ECM CONDENSING FANS 22 1/2 ----15 TON MODULATING REHEAT OPTION - SPACE DEWPOINT CONTROL RTU3 DOWN RETURN 1 RTU INTAKE/RETURN DAMPER - MANUAL CONTROL VIA HMI
1 RTU RETURN MOUNTED SMOKE DETECTOR AND SAMPLING TUBE - FACTORY INSTALLED ______ 5 YEAR ENTIRE UNIT PARTS WARRANTY, 10 YEAR ENTIRE UNIT PARTS WARRANTY WITH REMOTE MONITORING AND CAPTIVEAIRE SERVICE CONTRACT, 25 YEAR STAINLESS STEEL FURNACE PARTS WARRANTY (SEE ADDITIONAL DETAILS) _____ 31 7/8 _____ 24 3/4 ----FAN ACCESSORIES EXHAUST CURB ASSEMBLIES NO ON WEIGHT ITEM CURB 23.000'W X 23.000'L X 20.000'H ALDNG LENGTH, RIGHT VENTED HINGED.


CURB 23.000'W X 23.000'L X 20.000'H ALDNG LENGTH, RIGHT VENTED HINGED.

CURB 59.500'W X 91.000'L X 20.000'H ALDNG WIDTH, RIGHT INSULATED. FAN SOUND DATA OCTAVE BAND SOUND DATA **DATE:** 6/8/2022 TOP VIEW LWA SONES DBA 0 DISTANCE (FT) 63 HZ 125 HZ 250 HZ 500 HZ 1 KHZ 2 KHZ 4 KHZ 8 KHZ DWG.#: 5506074

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OCTAVE BAND SOUND DATA



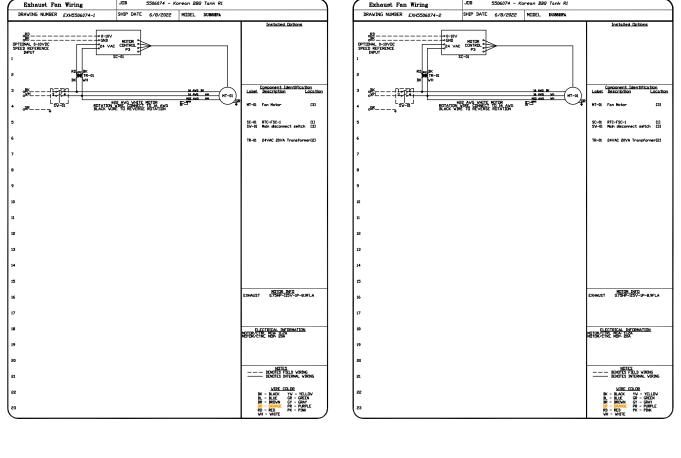

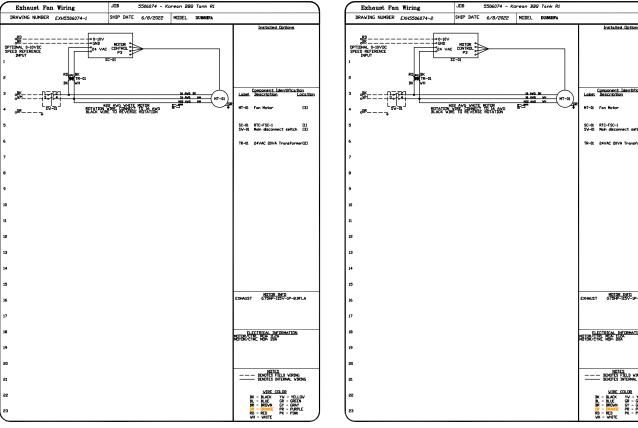SHEET TITLE **CAPTIVE AIR**


FAN #3 CASRTU3-I.300-18-15T-DOAS - HEATER


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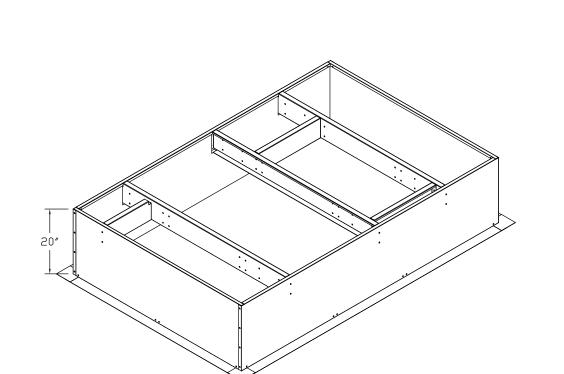
- 1. DO NOT OBSTRUCT OUTSIDE AIR INLET, OUTSIDE AIR COIL
- OR OUTSIDE AIR FAN.
- DENOTES CORNER WEIGHT.
- 3. ROOF OPENING MUST BE 2" SMALLER THAN CURB DIMENSIONS


IN BOTH DIRECTIONS.

*NOTE: SUPPLY DUCT MUST BE INSTALLED TO MEET SMACNA STANDARDS, A MINIMUM STRAIGHT DUCT LENGTH MUST BE *NOTE: SUPPLY DUCT MUST BE INSTALLED TO MEET SMACKA STANDARDS, A MINIMUM STRAIGHT DUCT LENGTH MUST BE MAINTAINED DOWNSTREAM OF UNIT DISCHARGE AS OUTLINED IN AMCA PUBLICATION 201, WHEN USING RECTANGULAR DUCTWORK, ELBOWS MUST BE RADIUS THROAT, RADIUS BACK WITH TURNING VANES, FLEXIBLE DUCTWORK AND SQUARE THROAT/SQUARE BACK ELBOWS SHOULD NOT BE USED. ANY TRANSITION AND/OR TURNS IN THE DUCTWORK WILL CAUSE SYSTEM EFFECT, SYSTEM EFFECT WILL DRASTICALLY INCREASE STATIC PRESSURE AND REDUCE AIRFLOW. DO NOT RELY ON UNIT TO SUPPORT DUCT IN ANY WAY, FAILURE TO PROPERLY SIZE DUCTWORK MAY CAUSE SYSTEM EFFECTS AND REDUCE PERFORMANCE OF THE EQUIPMENT. SUGGESTED STRAIGHT DUCT SIZE IS 21.5" × 39".




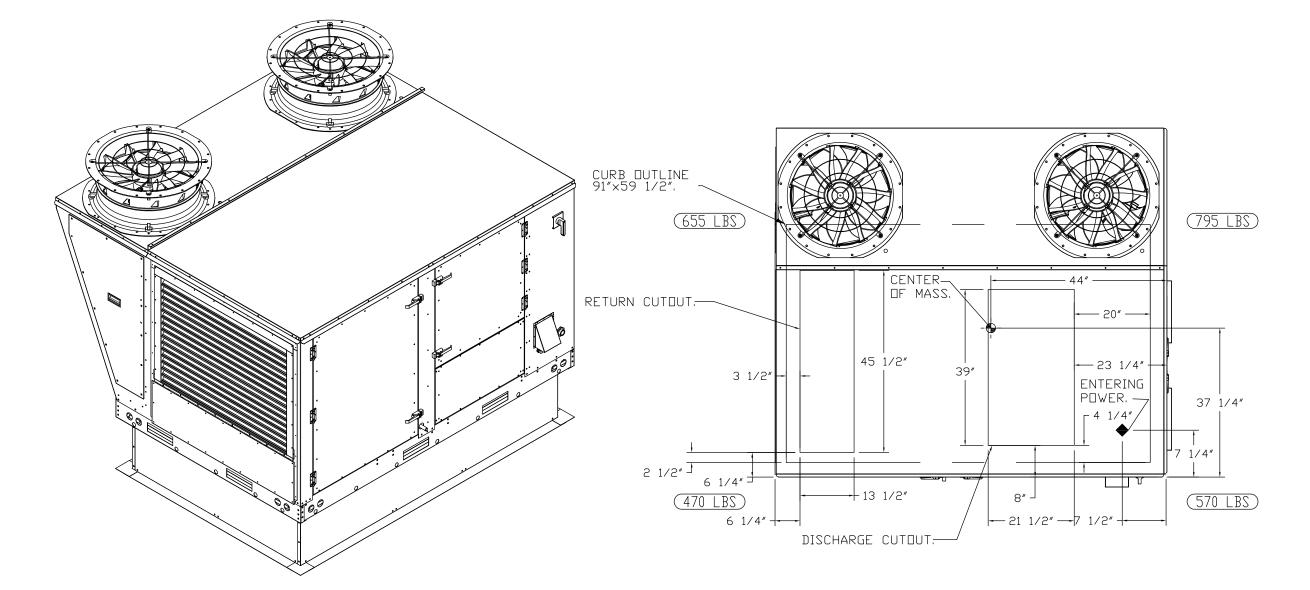


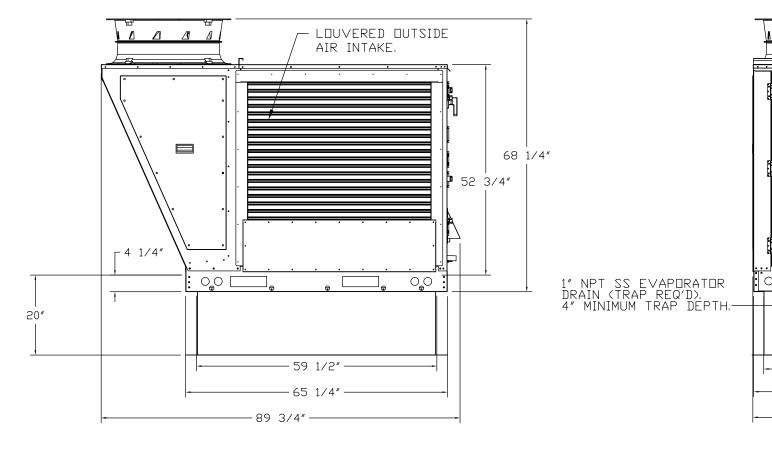


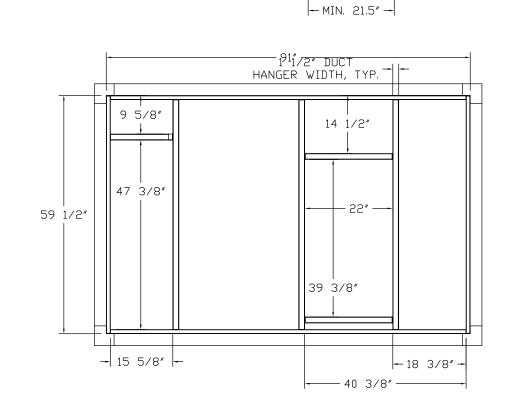

PER AMCA*

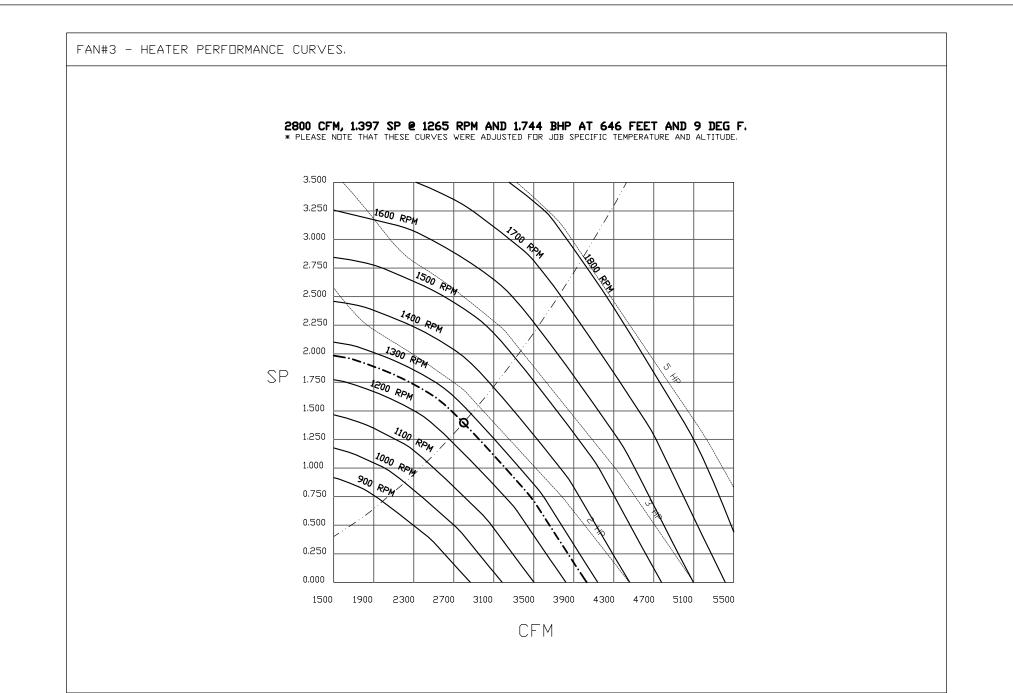

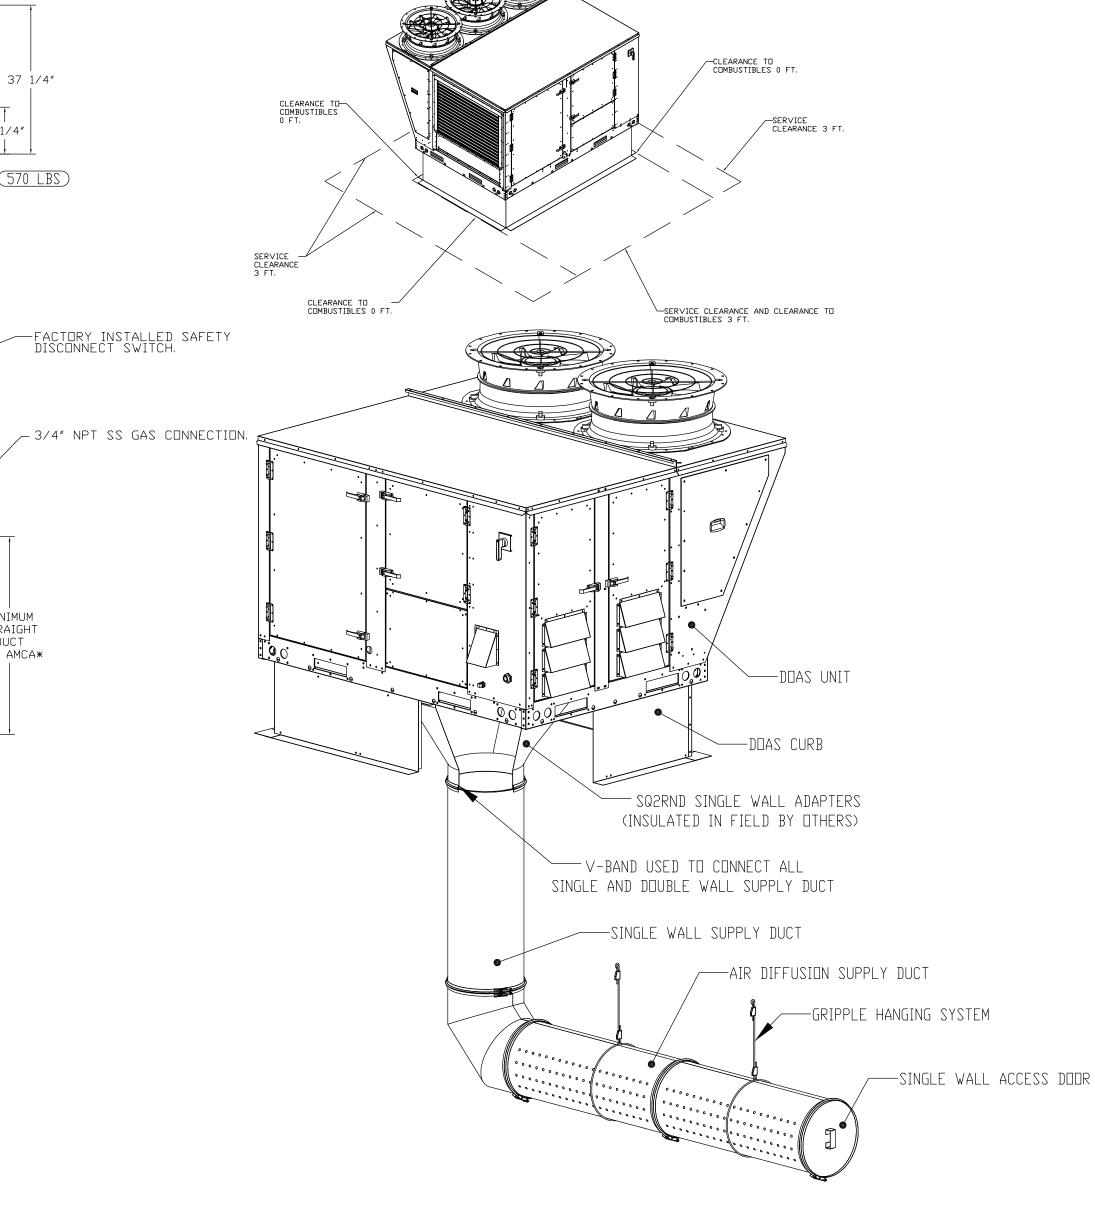

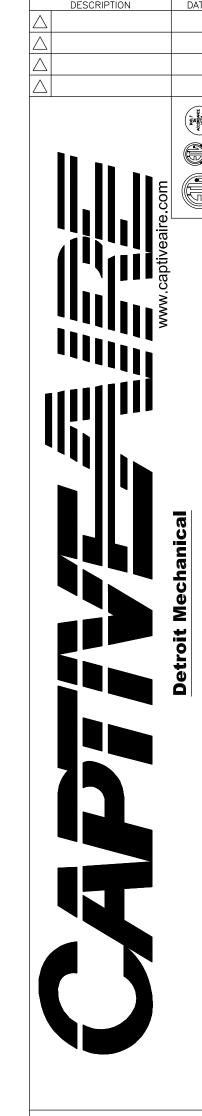

REVISIONS

Beaver 18083 BBO $\frac{\Box}{\Box}$ \bigcirc \subseteq 4 —

DATE: 6/8/2022 DWG.#:

5506074

DRAWN BY: josh.hilem

SCALE: 1/2" = 1'-0"

MASTER DRAWING

SHEET NO. 11

189 E. Big Beaver, Ste 106 Troy, MI 48083 s-m-associates.com 248.457.6903 info@s-m-associates.com

> PROJECT NAME: **KOREAN BBQ**

PERMIT SUBMISSION 06-28-22

435 E. BIG BEAVER TROY MI 48083



ALL DIMENSIONS SHALL BE VERIFIED IN THE FIELD BY THE CONTRACTOR. THE CONTRACTOR IS SOLELY RESPONSIBLE FOR COORDINATION OF ALL DIMENSIONS.

JOB NO.	22-0987
D.B/C.B	R.A./P.D
ISSUANCES	
NO DESCRIPTION	DATE
1 PERMIT SUBMISSION	06/28/22

SHEET TITLE **CAPTIVE AIR**

S AIR DIFFUSION SUPPLY DUCT SPECIFICATIONS: PROVIDE AIR DIFFUSION SUPPLY DUCT EQUAL TO CAPTIVEAIRE SYSTEMS MODEL DW-SO(HC), DW-S90(HC), & DW-S180(HC). THREE DISTINCT HOLE PATTERN OPTIONS TO COVER A VARIETY OF CEILING HEIGHTS. NO ADDITIONAL DIFFUSERS REQUIRED, AS THE DUCT ITSELF PROVIDES AIR DIFFUSION. MADE OF HIGH QUALITY STAINLESS STEEL DESIGNED TO LAST 20+ YEARS.

HIGH INDUCTION SUPPLY DUCT IS CONSTRUCTED USING 24 GAUGE, 430 SS - 5" THRU 24". HIGH INDUCTION SUPPLY DUCT IS CONSTRUCTED USING 20 GAUGE, 430 SS - 26" THRU 36".


QUICK DNSITE ASSEMBLY USING EPDM GASKETS & UNIVERSAL V-BANDS. DOUBLE WALL SUPPLY DUCT AVAILABLE FOR INTERIOR AND EXTERIOR SPACES, EITHER CONDITIONED OR UNCONDITIONED. DOUBLE WALL SUPPLY DUCT AVAILABLE IN DW-1S, DW-2S, & DW-3S TO MEET SPECIFIC REGIONAL "R" VALUE REQUIREMENTS.

Insulation R-Value Recommendations							
Supply Duct Type	Minimum R-value	Space Type					
Single Wall - S & -HC	N/A	Conditioned Space Only					
Double Wall - 1S	R-4	Unconditioned Interior Space Only					
Double Wall - 2S	R-8	Unconditioned Space Climate Zones 1-4					
Double Wall - 3S	R-12	Unconditioned Space Climate Zones 5-8					

DOUBLE WALL SUPPLY DUCT IS INSULATED WITH A 24 GAUGE 430 STAINLESS OUTER SHELL. AIR DIFFUSION SUPPLY DUCT COMPLIES WITH SMACNA (SHEET METAL AND AIR CONDITIONING CONTRACTORS) BEST PRACTICES. POSITIONING OF SPRINKLERS TO AVOID OBSTRUCTION TO DISCHARGE, SEE NFPA 13, TABLE 8.12.5.1.1.

SECURE THE CURB TO THE ROOF FRAMING MEMBERS BY DRILLING 1/4° PILOT HOLES IN THE CURB FLANGES AT LOCATIONS SHOWN IN THE DIAGRAM BELOW. USING 3/8° X 2° ZINC PLATED STEEL LAG BOLTS, AND ZINC PLATED WASHERS, SCREW THROUGH THE CURB FLANGES AND INTO THE ROOF FRAMING MEMBERS. A MINIMUM OF (5) LAG BOLTS ON EACH SHORT SIDE, AND (7) LAG BOLTS ON EACH LONG SIDE IS REQUIRED.

SECURE THE UNIT BASE TO THE SIDE WALLS OF THE CURB USING (24) 1/4'-14 X 2' SELF-DRILLING, STEEL ZINC PLATED SCREWS. PRE-PUNCHED HOLES HAVE BEEN PROVIDED FOR EACH SCREW LOCATION.

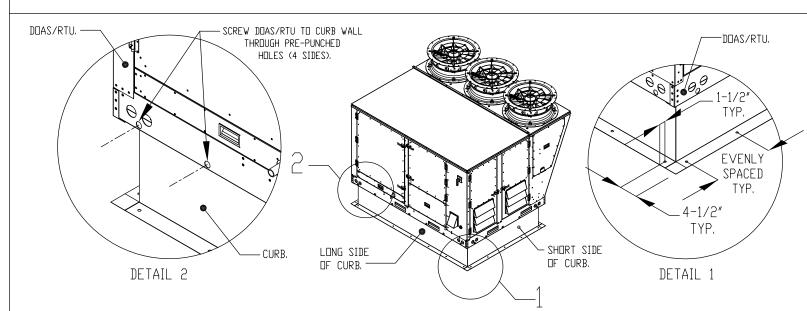


(\$) GREASE DUCT & CHIMNEY SPECIFICATIONS: PROVIDE GREASE DUCT EQUAL TO CAPTIVEAIRE SYSTEMS MODEL "DW" ROUND 20 GAUGE 430 STAINLESS STEEL DUCTWORK, MODEL "DW" IS LISTED TO UL-1978 AND IS INSTALLED USING "V" CLAMP LOCKING CONNECTIONS SEALED WITH 3M FIRE BARRIER 2000 PLUS. MODEL "DW" DOES NOT REQUIRE WELDING PROVIDING IT HAS BEEN INSTALLED PER THE MANUFACTURES INSTALLATION GUIDE

PROVIDE RATED ACCESS DOORS AT EVERY CHANGE IN DIRECTION AND EVERY 12' ON CENTER. PER MANUFACTURES LISTING MODEL "DW" HORIZONTAL RUNS LESS THAN 75 FT. CAN BE SLOPED 1/16" PER 12", HORIZONTAL RUNS MORE THAN 75 FT. CAN BE SLOPED 3/16" PER 12". | VENTED CURB DUCT SHOULD BE SLOPED AS MUCH AS POSSIBLE TO REDUCE THE CHANCE OF GREASE ACCUMULATION IN HORIZONTAL RUNS.

IF THE DUCT OR CHIMNEY IS WITHIN 18 INCHES OF COMBUSTIBLE MATERIAL, PROVIDE | UL-2221 OR UL-103 HT LISTED DOUBLE WALL GREASE DUCT OR DOUBLE WALL CHIMNEY | EQUAL TO CAPTIVEAIRE SYSTEMS MODEL "DW- 2R, 2R TYPE HT, 3R, OR 3Z" ROUND 20 GAUGE | 430 STAINLESS INNER DUCT INSULATED WITH A 24 GAUGE 430 STAINLESS DUTER SHELL.

CUSTOMER APPROVAL TO MANUFACTURE:

PPROVED AS NOTED	
PPROVED WITH NO EXCEPTION TAKEN	
REVISE AND RESUBMIT	
SIGNATURE	

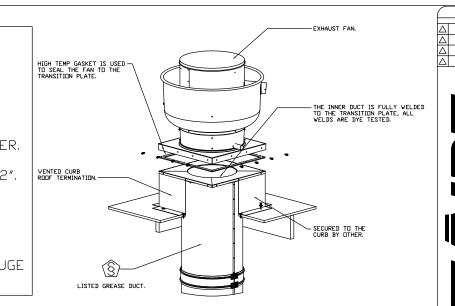



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248.457.6903


PROJECT NAME: **KOREAN BBQ**

PERMIT SUBMISSION 06-28-22

DATE: 6/8/2022 5506074 **DRAWN BY:** josh.hilem MASTER DRAWING

SHEET NO.

435 E. BIG BEAVER TROY MI 48083

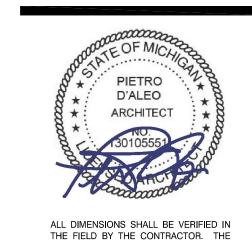

CONTRACTOR IS SOLI FOR COORDINATION OF	ELY RESPONSIBLE
B NO.	22-0987
C.B	R.A./P.[

ISSUANCES NO DESCRIPTION DATE 1 PERMIT SUBMISSION 06/28/22

DATE: 6/8/2022

CAPTIVE AIR

DWG. NO.

SHEET TITLE

DUCTWORK #1 FRONT VIEW DUCTWORK #1 PARTS - JOB#5506074 DOUBLE WALL TAG PART # -0.0508 16.53 1771.08 1 DDUBLE WALL DUCT - 12' INNER 45 DUCT - 2 LAYERS REDUCED CLEARANCE - 16' STAINLESS DW1245DWASY-2R-S 1391 DOUBLE WALL DUCT - 12' INNER 45 DUCT - 2 LAYERS REDUCED CLEARANCE - 16' STAINLESS STEEL DUTER SHELL. DW1245DWASY-2R-S 1391 DOUBLE WALL ADJUSTABLE DUCT - 12' INNER DUCT - 2 LAYERS REDUCED CLEARANCE - 16'
1 STAINLESS STEEL DUTER SHELL. MIN LENGTH = 11' / MAX LENGTH = 48.5' / ADJUSTMENT =
30.5' / ADJUSTABLE SECTION MAY NEED TO BE CUT. INCLUDES SINGLE AND DOUBLE WALL 'V'
CLAMPS. ----- 25.50° -----DW1247DWAJD-2R-S -0.025 53.52 1771.08 1 DDUBLE WALL DUCT - 12' INNER DUCT, 45.5' LONG - 2 LAYERS REDUCED CLEARANCE - 16' STAINLESS STEEL DUTER SHELL - USED WITH TRANSITION PLATE.

8.02 1771.08 1 DUCT TO CURB TRANSITION, 23' CURB TO 12' DUCT, 16 GA ALUMINIZED. MISC. NON-STANDARD TRANSITION PLATE. ASSEMBLED W/P5 DW124550DWLTTP-2R-S 1391 ASSEMBLED W/P4 DW2312TP SYSTEM AT P5 -0.0508 16.53 1771.08 1 DDUBLE WALL DUCT - 12' INNER 45 DUCT - 2 LAYERS REDUCED CLEARANCE - 16' STAINLESS STEEL DUTER SHELL.

-0.0725 16.53 1771.08 1 DDUBLE WALL DUCT - 12' INNER 45 DUCT - 2 LAYERS REDUCED CLEARANCE - 16' STAINLESS STEEL DUTER SHELL. DW1245DWASY-2R-S DW1245DWASY-2R-S SIEEL DUTER SHELL.

DDUBLE WALL ADJUSTABLE DUCT - 12' INNER DUCT - 2 LAYERS REDUCED CLEARANCE - 16'
STAINLESS STEEL DUTER SHELL. MIN LENGTH = 11' / MAX LENGTH = 48.5' / ADJUSTMENT =
30.5' / ADJUSTABLE SECTION MAY NEED TO BE CUT. INCLUDES SINGLE AND DOUBLE WALL 'V'
CLAMPS.

101.5'MAX
88' DW1247DWAJD-2R-S CLAMPS.

-0.025 53.52 1771.08 1 DDUBLE WALL DUCT - 12' INNER DUCT, 45.5' LONG - 2 LAYERS REDUCED CLEARANCE - 16' STAINLESS STEEL DUTER SHELL - USED WITH TRANSITION PLATE.

8.02 1771.08 1 DUCT TO CURB TRANSITION, 23' CURB TO 12' DUCT, 16 GA ALUMINIZED. MISC. NON-STANDARD -0.8453 0.00 ASSEMBLED W/P9 DW2312TP SYSTEM AT P10 3M-5000EL US 3 DUCT - 3M FIRE BARRIER 2000 PLUS SILICONE - USED AS SEALANT TO SEAL DUCT JOINTS. 2 DUCT - 12' DUCT - 16' DDUBLE 'V' CLAMP - 2R INSULATION & SINGLE 'V' CLAMP INCLUDED - REDUCED CLEARANCE. DW12DWCLASY-2R-S TOTAL WEIGHT DUCTWORK #1 SIDE VIEW DOUBLE WALL FACTORY BUILT DUCTWORK - ALL DUCTWORK IS REQUIRED TO BE INSTALLED WITH THE MAXIMUM SUPPORT SPACING LISTED BELOW. - FOR A COMPLETE LIST OF APPROVED SUPPORT METHODS, SEE THE ENTIRE INSTALLATION AND OPERATION MANUAL - DUCTWORK SHALL SLOPE NOT LESS THAN 1/16' PER LINEAR FOOT TOWARDS THE HOOD OR AN APPROVED GREASE COLLECTION RESERVOIR. - WHERE HORIZONTAL DUCTS EXCEED 75 FEET IN LENGTH, THE SLOPE SHALL NOT BE LESS THAN 3/16' PER LINEAR FOOT. ----- 25.50° -----SUPPORT SPACING (FT) WALL CURB FLOOR DUCTWORK #1 SE VIEW SUPPORT (FT) SUPPORT (FT) SUPPORT (FT 2R (18') 18' 24' 24' 3R & 3Z (5'-24') 10' 24' 24' 3Z (26' -36') 10' 20' 20' DO NOT LEAK TEST USING SMOKE BOMBS CONTAINING CHLORINES/CHLORIDES, CONSULT WITH CAPTIVEAIRE FOR PROPER LEAK TESTING METHODS. DUCTWORK #1 TOP VIEW

SYSTEM DESIGN VERIFICATION (SDV)

EQUIPMENT HAS HAD A COMPLETE START UP PER THE OPERATION AND INSTALLATION MANUAL. TYPICALLY, THE SDV WILL BE PERFORMED AFTER ALL INSPECTIONS ARE COMPLETE. ANY FIELD RELATED DISCREPANCIES THAT ARE DISCOVERED DURING THE SDV WILL BE BROUGHT TO ATTENTION OF THE GENERAL CONTRACTOR AND CORRESPONDING TRADES ON SITE. THESE ISSUES WILL BE DOCUMENTED AND FORWARDED TO THE APPROPRIATE SALES OFFICE. IF CAS SERVICE HAS RESOLVE A DISCREPANCY THAT IS A FIELD ISSUE, THE GENERAL CONTRACTOR WILL BE NOTIFIED AND BILLED FOR THE WORK. SHOULD A RETURN TRIP BE REQUIRED DUE TO ANY FIELD RELATED DISCREPANCY THAT CANNOT BE RESOLVED DURING THE SDV, THERE WILL BE ADDITIONAL TRIP

DURING THE SDV, CAS SERVICE WILL ADDRESS ANY DISCREPANCY THAT IS THE FAULT OF THE MANUFACTURER. SHOULD A RETURN TRIP BE REQUIRED, THE GENERAL CONTRACTOR AND APPROPRIATE SALES OFFICE WILL BE NOTIFIED, THERE WILL BE NO ADDITIONAL CHARGES FOR MANUFACTURER

IF ORDERED, CAS SERVICE WILL PERFORM A SYSTEM DESIGN VERIFICATION (SDV) ONCE ALL

SCALE: 3/4" = 1'-0"

MASTER DRAWING

SHEET NO.

DATE: 6/8/2022

DWG.#: 5506074

DRAWNBY: josh.hilem

MASTER DRAWING


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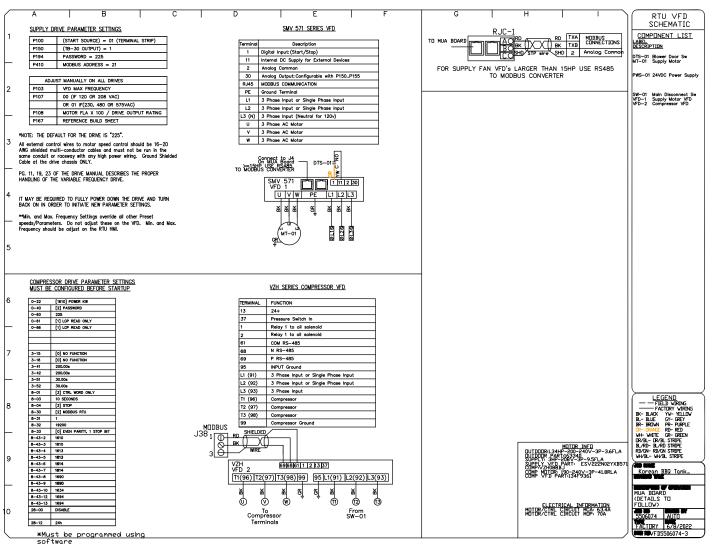
DATE: 6/8/2022


DWG.#: 5506074 **DRAWN BY:** josh.hilem


3/4" = 1'-0'MASTER DRAWING

SHEET NO.




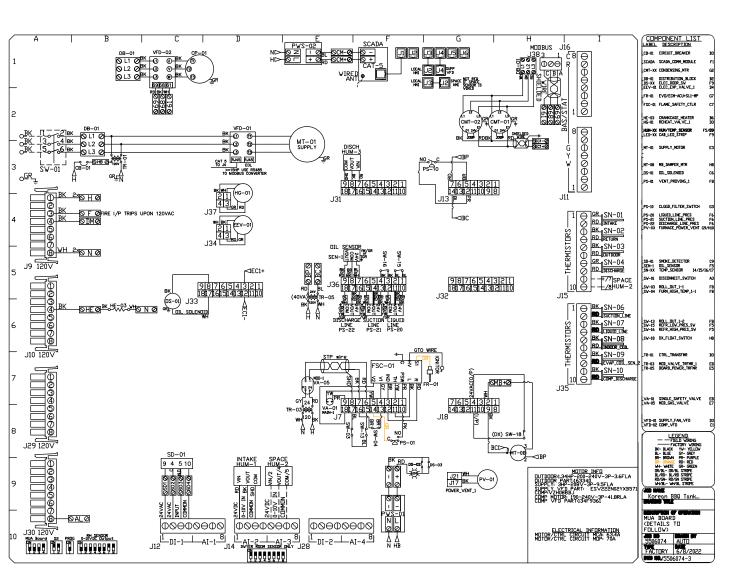

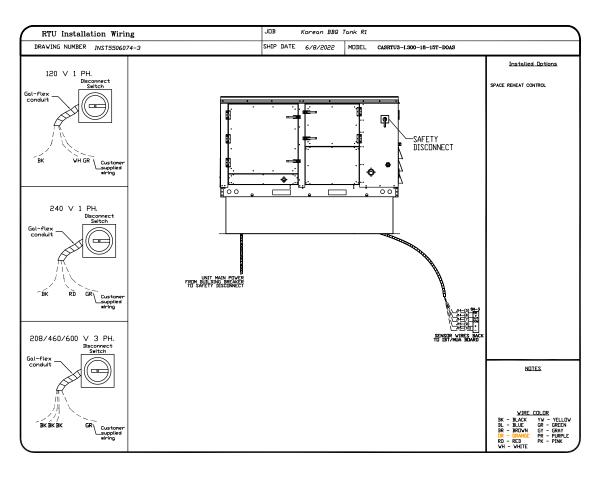


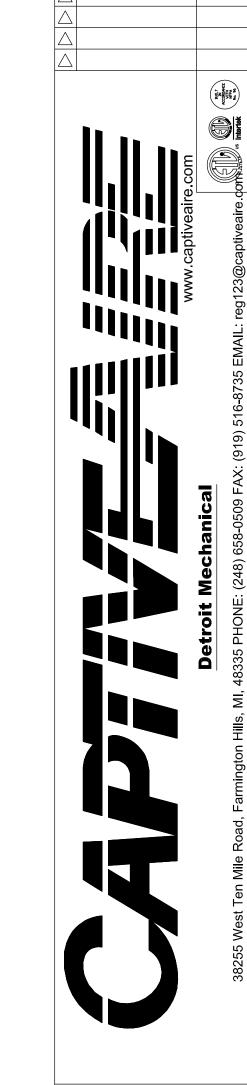

REVISIONS

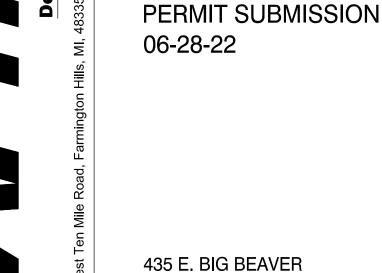

TROY MI 48083

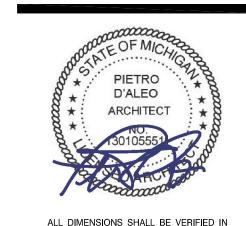

THE FIELD BY THE CONTRACTOR. THE

DESCRIPTION

CONTRACTOR IS SOLELY RESPONSIBLE FOR COORDINATION OF ALL DIMENSIONS.

PERMIT SUBMISSION 06/28/22

22-0987

R.A./P.D

DATE

Architects

189 E. Big Beaver, Ste 106

info@s-m-associates.com

Troy, MI 48083

248.457.6903

PROJECT NAME:

KOREAN BBQ

s-m-associates.com

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A A X	Beaver	$\stackrel{\textstyle \wedge}{\sim}$	D.B/C.B ISSUANC	ES
Korean BBQ T	E Big Bec	oy, MI, 4808	NO DESCR	
DATE: 6	7/8/30 M M	<u>\</u>		
D	WG.#: 06074)		

DRAWN

BY: josh, hilem

SCALE:

1/2" = 1'-0"

MASTER DRAWING

SHEET NO.

15

SHEET TITLE **CAPTIVE AIR**

