

STORAGE

169/300=1

OFFICE

36/100=1

**KITCHEN** 

# **BURGER KING** RESTAURANT # 9571

2110 EMMORTON ROAD BEL AIR, MARYLAND 21015

ACCOUNT NUMBER - 049801

GRID-0002D PARCEL-0220 SUBDIVISION-0000

DINING ROOM

92 FIXED SEATS

**MATERIALS** 

0 0 0

9 ( 1 9 9 )

CMU, CONCRETE

MASONRY UNIT

CAST STONE OR

CONCRETE

SAND OR GROUT

RIGID INSULATION

BATT INSULATION

\_\_\_\_\_ METAL DECKING

PRECAST CONCRETE

BRICK

**ZONING - B3 (GENERAL BUSINESS)** 


46


331


#### DRAWING SHEET INDEX ECTRICAL DEMOLITION DEMOLITION FLOOR PLAN IGHTING FIXTURE SCHEDUL DEMOLITION CEILING PLAN DEMOLITION ROOF PLAN POWER PLAN EXISTING BUILDING ELEVATION PANEL SCHEDULE NEW WORK FLOOR PLAN **NEW WORK CEILING PLAN** REFLECTED CEILING DETAILS **NEW WORK ROOF PLAN** XTERIOR BUILDING ELEVATION EXTERIOR FINISH SCHEDULE WALL SECTIONS WALL SECTIONS A304 WALL SECTIONS MISCELLANEOUS DETAIL DOOR SCHEDULE AND DETAIL: MANUFACTURERS AND SUPPLIER FOUNDATION PLAN ROOF FRAMING PLAN SECTIONS MECHANICAL DEMOLITION MECHANICAL PLAN **LOCATION MAP**

OFFICE ----ROOM NAME/FUNCTION 124/100=2 - TOTAL # OF OCC. -----IBC OCC AREA -ROOM SIZE (SF)

# EGRESS DOOR SYBMOL

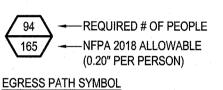

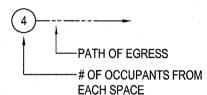

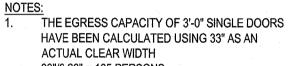

- THE EGRESS CAPACITY OF 3'-8" SINGLE DOORS HAVE BEEN CALCULATED USING 41" AS AN ACTUAL CLEAR WIDTH. 41"/0.20" = 205 PERSONS
- THE EGRESS CAPACITY OF 6'-0" DOUBLE DOORS HAVE BEEN CALCULATED USING 67.25" AS AN ACTUAL CLEAR WIDTH. 67.25"/0.20" = 336 PERSONS

PLYWOOD

(SMALL SCALE)

CRUSHED GRAVEL

COMPACT

FILL EARTH

**CUT STONE** 

& SHIMS

WOOD, BLOCKING


WOOD, FRAMING

**ENGINEERED WOOD** 


& FURRING

Reviewed for Code Compliance

4. ALL OF THE ABOVE CALCULATIONS ARE BASED

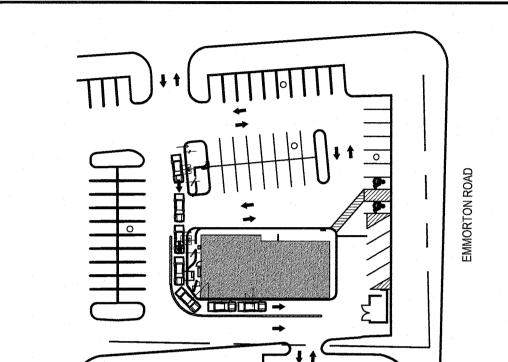



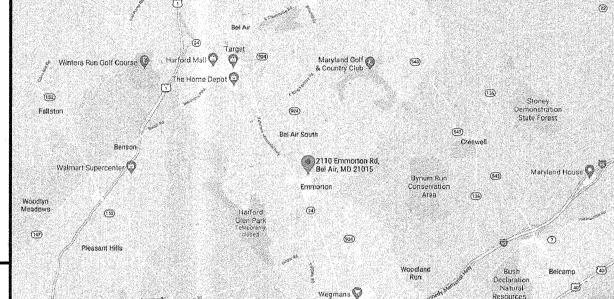

repared or approved by me, and that I am duly licensed professional architect under th aws of the State of Maryland.

icense # 6140 Expiration Date: 08/21/202

KING

BURGER

ERATIONS

SYMBOLS

DE &

CO

SOVERSHEET, CABBREVIATION

DESIGNED:

DRAWN:

SCALE:

DATE:

CHECKED:

MECHANICAL -8. PLUMBING -. ELECTRICAL -

2018 EDITION NFPA 1 2018 NFPA 101, STATE OF MARYLAND FIRE PREVENTION CODE, COMAR 29.06.01 2010 ADA STANDARDS FOR ACCESSIBILITY DESIGN MARYLAND ACCESSIBILITY CODE, COMAR 09.12.53 2018 INTERNATIONAL MECHANICAL CODE 2018 INTERNATIONAL PLUMBING CODE

2018 INTERNATIONAL EXISTING BUILDING CODE

12. AUTOMATIC SPRINKLER SYSTEMS CODE - 2019 NFPA 13

# **GENERAL NOTE**

- ALL DIMENSIONS, NOTES, FINISHES AND FIXTURES SHOWN ON TYPICAL FLOOR PLANS, SECTIONS, OR DETAILS SHALL APPLY TO ALL SIMILAR, SYMMETRICAL OR OPPOSITE HAND PLANS,
- CONTRACTOR TO PROVIDE AND INSTALL EXIT SIGNS AND EMERGENCY LIGHTING AS REQUIRED
- BY APPLICABLE CODES. COORDINATE WITH ELECTRICAL DRAWINGS. GENERAL CONTRACTOR TO VERIFY ALL EXISTING UTILITIES
- SEWER SERVICE E. ELECTRIC POWER SOURCE

8. COORDINATE WITH ALL EXISTING AND PROPOSED FLOOR WALL AND ROOF PENETRATIONS. 9. COORDINATE ALL NEW WORK WITH EXISTING CONDITIONS AND LANDLORD WORK.

05-25-2021 PERMIT SUBMISSION

# 33"/0.20" = 165 PERSONS PLYWOOD

# APPLICABLE CODES

ALL WORK ASSOCIATED WITH THIS PROJECT SHALL COMPLY WITH THE FOLLOWING AS AMENDED BY HARFORD COUNTY AND THE STATE OF MARYLAND. GENERAL CONTRACTOR AND ALL SUBCONTRACTORS & MATERIAL VENDORS SHALL COMPLY WITH CODES IDENTIFIED IN THIS CODE REVIEW.

BUILDING CODE -EXISTING BUILDING CODE -**ENERGY CODE -**FIRE PROTECTION CODE -LIFE SAFETY CODE -

ACCESSIBILITY -

11. FIRE ALARM CODE

2018 INTERNATIONAL FUEL GAS CODE

2018 INTERNATIONAL BUILDING CODE

2018 INTERNATIONAL ENERGY CODE

2020 NATIONAL ELECTRICAL CODE 2019 NFPA 72 NATIONAL FIRE ALARM CODE

ALL PLAN DIMENSIONS ARE TO FACE OF GWB OR EXISTING SHELL, VERIFY IN FIELD. CONTRACTOR TO VERIFY ALL DIMENSIONS PRIOR TO COMMENCEMENT TO CONSTRUCTION, AND NOTIFY ARCHITECT OF ANY DISCREPANCIES. DO NOT SCALE DRAWINGS. USE WRITTEN DIMENSIONS ONLY.

SECTIONS OR DETAILS.

ALL DOOR JAMBS SHALL BE LOCATED 2" FROM INTERSECTING WALL, UNLESS NOTED

A. GAS SERVICE DOMESTIC WATER

SERVICE SANITARY

PROJECT: DRAWING:

CTR CUBIC PLYWD PLYWOOD CU FT or CF **CUBIC FEET** POWDER ACTUATED FASTENER CU YD or CY **CUBIC YARD** PRE-ENG PRE-ENGINEERED DEEP, DEPTH PREFAB PREFABRICATE PREFIN DOUBLE PREFINISH PAINT, PRESSURE TREATED **DEMOLITION or DEMOLISH** PAPER TOWEL DISPENSER DETAIL **DRINKING FOUNTAIN QUARRY TILE** DIAMETER DIMENSION DOWN **RADIATOR or RADIUS** DOOR **DOWNSPOUT** ROOF DRAIN REFERENCE DISHWASHER REFR **DRAWING** REFRIGERATOR REINFORCE (ING) (ED) REQD REQUIRED EACH REVISION **EXPANSION JOINT** ROOM ELEVATION **ROUGH OPENING ELECTRIC or ELECTRICAL ELEVATION** SANITARY NAPKIN DISPENSER **ESTIMATE** SCHED SECT **EOUAL** SCHEDULE EQUIP EQUIPMENT SECTION **EQUIV** SHTG SHT **EQUIVALENT** SHEATHING **EACH WAY** SMU SILICONIZED MASONRY UNIT ELECTRIC WATER COOLE SIM EXIST EXISTING SIMILAR SPEC SQ EXPOSED SPECIFICATION EXP BT **EXPANSION BOLT** SOUARE SQ FT or SF EXTERIOR, EXTERNAL SQUARE FOOT SQ YD or SY SQUARE YARD FLOOR DRAIN STAIN (ED) STAINLESS STEEL FIRE EXTINGUISHER FIRE EXTINGUISHER CABINET STANDARD FINISHED FLOOR STRUCT STRUCTURE (AL) FLOOR DRAIN SUSPEND (ED) SYM FIRE EXTINGUISHER SYMBOL SYSTEM FIXTURE FLASHING TREAD FLOOR TELEPHONE TTD **TOILET TISSUE DISPENSER** FINISHED OPENING THK FOOTING THICK T&G TOS FEET, FIRE TREATED, FOOT TONGUE AND GROOVE FURNISH, FURNITURE TOP OF STEEL TOF TRD FURRING TOP OF FOOTING TREATED GALV GALVANIC, GALVANIZED TPL TDS TRIPLE GRAB BAR TURN DOWN SLAB TYP GLASS TYPICAL GLAZING GWB GYPSUM WALL BOARD **UNDERWRITERS LABORATORIES** GYP UNFIN GYPSUM UNFINISHED UNO UNLESS NOTED OTHERWISE HANDICAP HORIZONTAL CONTROL JOINT VCJ VERTICAL CONTROL JOINT HDPE VCT VINYL COMPOSITION TILE HIGH DENSITY POLYETHYLENE VERT HDW HARDWARE VERTICAL **HOLLOW CORE VERIFY IN FIELD HOLLOW METAL** WEST, WIDE HORIZ HORIZONTAL HEIGHT WITH WATER RESISTANT INSIDE DIAMETER WATERPROOF (ING) INSUL INSULATION WATER CLOSET INTER INTERMEDIATE WOOD INTERIOR

WWF

ALTERATION - LEVEL 2

TYPE 'V-B' (NO CHANGE)

1 STORY @ 40'-0" HIGH

3,580 SF

THE EXISTING BUILDING IS CURRENTLY

NON-SPRINKLERED (NO CHANGE)

ASSEMBLY USE - A-2' (NO CHANGE)

1 STORY @ 21'-0" HIGH, TOP OF PARAPET

1 STORY @ 21'-0" HIGH, TOP OF PARAPET

92 ('A' USE) + 7 = 99 OCCUPANTS

12'-9" HIGH, TOP OF ROOF

12'-9" HIGH, TOP OF ROOF

**ABBREVIATIONS** 

ACCESSIBLE

ALTERNATE

**ALUMINUM** 

ARCHITECT

BEAM

BEARING

BELOW

**BITUMINOUS** 

BUILDING

**BLOCKING** 

BULKHEAD

воттом

CHANNEL

CEILING **CENTER LINE** 

COLUMN

CONCRETE

COORDINATE

CERAMIC TILE

CENTER

**BOTTOM OF DECK** 

**BUILT UP ROOFING** 

CORNER GUARD

CONTROL JOINT

**CONCRETE MASONRY UNIT** 

**CONTINUE or CONTINUOUS** 

**BOTTOM OF FOOTING** 

BLOCK

**APPROXIMATE** 

ALUM

ARCH

BLDG

BLKG

BLKHD

CHAN

CONC

CONT

COORD

APPROX

**ACOUSTICAL CEILING TILE** 

ABOVE FINISHED FLOOR

**BABY CHANGING STATION** 

**BELOW FINISHED FLOOR** 

ADJACENT, ADJOING, ADJUSTABLE

**DETAIL SYMBOLS** WATER HEATER WELDED WIRE FABRIC WEIGHT

**ENLARGED** 

DETAIL SYMBOL

KITCHEN

LONG, LENGTH or ANGLI

LAVATORY

LINEAR FEET

LINEAR FEET

LIQUID SOAP DISPENSER

MATERIAL

MAXIMUM

MECHANICAL

**MANUFACTURER** 

MINIMUM, MINUTE

**MISCELLANEOUS** 

MOLDING

**MASONRY OPENING** 

METAL THRESHOLD

MOUNTED

NORTH

**NOT APPLICABLE** 

NOT IN CONTRACT

NOMINAL

NOT TO SCALE

ON CENTER

**OUTSIDE DIAMETER** 

OFFICE **OVERHEAD** 

OPENING

OPPOSITE

PERPENDICULAR

PLASTIC LAMINATE

PLATE

NUMBER

MODIFY, MODULAR

LAV

LSD

MATL

MAX

MECH

MFR

MIRR

MISC

MLDG

MOD

NIC

NOM

NTS

NO or #

OPNG

**PERP** 

LAMINATE (D)

- ADDITIONAL INSTRUCTION -DETAIL DRAWING NUMBER DETAIL SYMBOL SHEET NUMBER WHERE SECTION IS DRAWN -SHEET NUMBER WHERE SECTION IS TAKEN **ELEVATION SYMBOL** -INDICATES DIRECTION OF VIEWING PLANE INTERIOR ELEVATION SYMBOL WITH MULTIPLE VIEWS WALL SECTION SYMBOL -INDICATES DIRECTION OF **CUTTING PLANE** BUILDING SECTION SYMBOL

-INDICATES DIRECTION OF

CUTTING PLANE

205

DRAWING TITLE SYMBOL PROJECT NORTH PLAN NORTH SYMBOL FLOOR LEVEL ELEV. 00.00 FLOOR LEVEL SYMBOL **ROOM NAME** ROOM NAME & NUMBER ### TAG SYMBOL DOOR TAG SYMBOL WINDOW TAG SYMBOL <w#>-# KEYNOTE TAG SYMBOL **EQUIPMENT & FINISH** (P-##) -TAG SYMBOL X ---WALL TYPE TAG SYMBOL **REVISION TAG &** CLOUD SYMBOL

**Reviewed For Code Compliance** 

isions of Chapter 84 of the Harford County Code and, when applicable, ne Maryland Accessibility Code. Harford County Code is currently based on ne 2018 versions of the IBC, IRC and IECC. Electric, mechanical and plumbing reviews have not been performed at this

These plans have been reviewed for code compliance to the applicable provisions of Chapter 94 of the Harford County Code and, when applicable, the Man on Coessibility Code. Harford County Code is currently base 2018 Accode the IBC. IRC and 100 Electrical, mechanical and plumbing with are not been performed at this time. The approval of these than shall not performed at this time. The approval of these than shall not grant authority to violate any state of 1963 1989. Consultation must be in accordance with approved than 5 food be reviewed and amendments thereto. All agency comments should be reviewed and understood prest to commencing work. 1/2/202

ne approval of these plans shall not grant authority to violate any state or Approved By; Cady J. Danis, Senior Plans Examiner 07/12/2021

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JANITOR

**CODE INFORMATION** 

JOINT

INTERNATIONAL EXISTING BUILDING CODE

2018 EDITION, CHAPTER 8

STATE OF MARYLAND FIRE

PREVENTION CODE, COMAR 29.06.01

USE AND OCCUPANCY CLASSIFICATION

ALLOWABLE HEIGHT & BUILDING AREA

EXISTING HEIGHT AND BUILDING AREA

PROPOSED HEIGHT AND BUILDING AREA

CONSTRUCTION CLASSIFICATION

FIRE PROTECTION

(IBC 18-303.3)

(IBC 18 - TABLE 601)

(IBC 18 - TABLE 503)

OCCUPANT LOAD

(IBC 18 - TABLE 1004.1.2)


(NFPA 18 - TABLE 13.1.6)

SCB

AS NOTED


05/25/2021

2018.0375.04.0

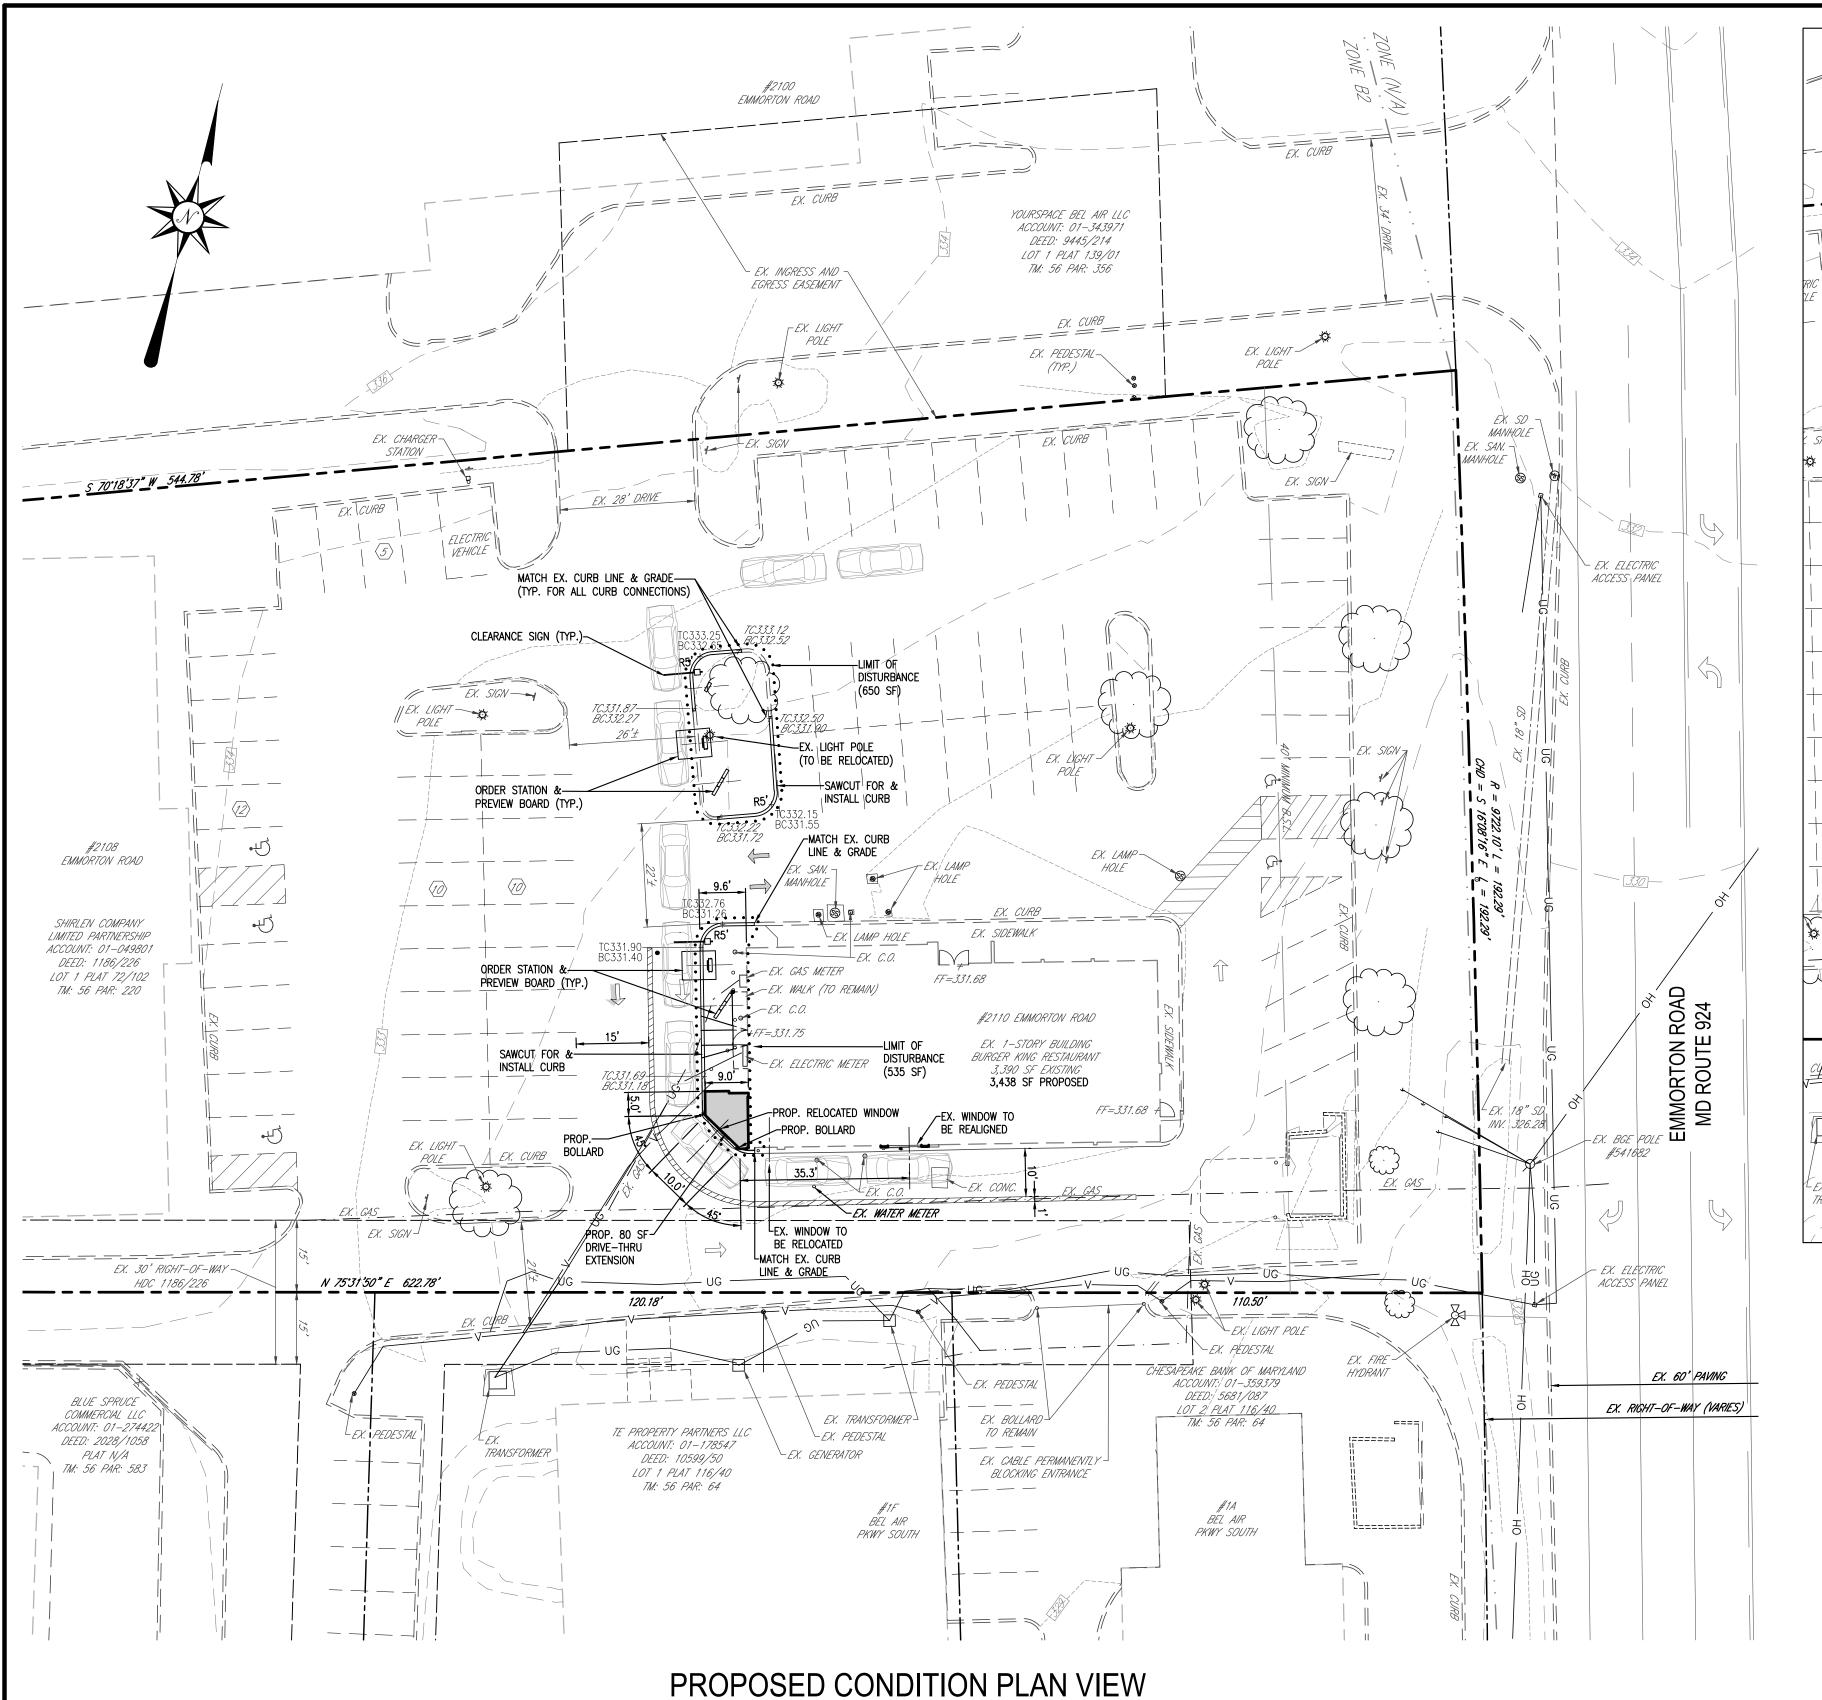

SCALE: 1" = 20'

DISTURBANCE (TO BE RELOCATED) EX. SIDEWALK EX. GAS METER FF=331.68 EX. WALK (TO REMAIN) #2110 EMMORTON ROAD ±>+FF=331.75 FX. 1-STORY BUILDING EX. ELECTRIC METER DISTURBANCE BURGER KING RESTAURANT 3,390 SF EXISTING (535 SF) (J----EX. DRIVE-THRU ORDER BOARD (TBR) FF=331.68 A EX. LIGHT POLE EX. TRANSFORMER -EX. BOLLARD Y TO REMAIN EX. PEDESTAL TRANSFORMER EX. GENERATOR EX. CABLE PERMANENTLY 🛚 BLOCKING ENTRANCE **EXISTING CONDITION PLAN VIEW** SCALE: 1" = 20'

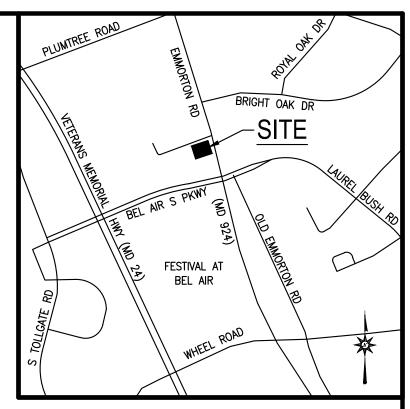

LOCATION MAP

SCALE: 1" = 1000'

# GENERAL NOTES

. SITE AREA: GROSS AREA= 101,840 SQ.FT. OR 2.34 AC±

GROSS AREA= 101,840 SQ.FT. OR 2.34 AC± NET AREA= 101,840 SQ. FT. OR 2.34 AC± DEED REFERENCE: 1186/226

DEED REFERENCE: 1186/226
 TAX ACCOUNT NO. 01049801
 TAX MAP 56, GRID 2D, PARCEL 220 LOT 01

PLAT REFERENCE: 79/102
 NEIGHBORHOOD: 19000.13
 ELECTION DISTRICT: 01-21

14. COUNCILMANIC DISTRICT: B15. LAND USE: HI (HIGH INTENSITY)16. WATERSHED: BUSH RIVER

18. UTILITIES: EX. PUBLIC WATER / PUBLIC SEWER

PROP. (NO CHANGE)
9. USE: EX. RESTAURANT

PROP.(NO CHANGE)
20. BUILDING COVERAGE: 3,438 SF

PERMITTED: 35%
PROVIDED: 30% COMBINED W/ #2108 EMMORTON RD

21. IMPERVIOUS COVERAGE: 81,430 SF
PERMITTED: 85%
PROVIDED: 86% COMPINIED W/ #2108 ENMADETON DE

PROVIDED: 80% COMBINED W/ #2108 EMMORTON RD 22. NO KNOWN PERMITS ON FILE.

23. THERE ARE NO HISTORICAL FEATURES ON SITE, NOR IS THE SITE ITSELF HISTORIC.24. ALL PROPOSED SIGNAGE SHALL CONFORM TO THE HARFORD COUNTY ZONING REGULATIONS

SECTION 267.33.

25. THIS SITE IS NOT WITHIN A FLOODPLAIN (CLASSIFIED AS FLOOD ZONE "X") PER PANEL

24025C0252E; EFF. 04/19/16.

26. BOUNDARY AND TOPOGRAPHIC INFORMATION SHOWN HEREON WAS PREPARED BY THOMPSON ASSOCIATES INC. ON APRIL 17, 2020, AND ALSO TAKEN FROM COUNTY CIS. TOPO

& ASSOCIATES INC. ON APRIL 17, 2020, AND ALSO TAKEN FROM COUNTY GIS TOPO.

27. PARKING CALCULATIONS (FAST-FOOD RESTAURANT):

EXISTING

EXISTING = 40 SPACES (2 HANDICAP SPACE)
STACKING = 10 (6 BEHIND THE ORDER BOARD)
REQUIRED (1 PER 200 SF FLOOR AREA)
3,438 SF / 200 SF = 18 SPACES

STACKING = 7 (5 MUST BE BEHIND ORDER BOARD)

PROVIDED

EXISTING = 39 SPACES (2 HANDICAP SPACE)

STACKING = 10 SPACES (5 BEHIND ORDER BOARD)

28. THIS PLAN IS SUBJECT TO A BUILDING PERMIT SINCE THE LIMIT OF DISTURBANCE IS LESS THAN 5.000 SQ.FT.

29. LIMIT OF DISTURBANCE = 1,185 S.F.
28. ON AUGUST 4, 2020, HARFORD COUNTY APPROVED THIS PROJECT FOR A DAC WAIVER.

# STORMWATER MANAGEMENT NOTE

THE PROPOSED COMMERCIAL REDEVELOPMENT CONSISTS OF A 48 SF BUILDING ADDITION ONTO AN EXISTING BUILDING AND REDESIGN OF THE DRIVE—THRU TO ALLOW FOR (2) ORDER STATIONS. THE TOTAL LIMIT OF DISTURBANCE (LOD) TO COMPLETE THE PROJECT IS 1,185 SF. AS A RESULT, THIS PROJECT WILL BE EXEMPT FROM STORMWATER MANAGEMENT REQUIREMENTS SINCE THE LOD IS LESS THAN 5,000 SF.

# DAILY STABILIZATION NOTE

CONTRACTOR SHALL ONLY DISTURB THAT AREA WHICH CAN BE STABILIZED BY THE END OF THE WORK DAY. STABILIZATION SHALL BE AS FOLLOWS:

1) FOR PAVED AREAS, THE APPLICATION OF STONE BASE.

2) FOR VEGETATED AREAS,


a) PERMANENT SEED AND SOIL STABILIZATION MATTING OR SOD FOR ALL STEEP

SLOPES, CHANNELS OR SWALES.

b) PERMANENT SEED AND MULCH FOR ALL OTHER AREAS. ANY AREAS WHICH CANNOT BE STABILIZED BY THE END OF EACH WORKING DAY MUST HAVE SILT FENCE

INSTALLED ON THE DOWNSLOPE SIDE, OR STEEL PLATES FOR TRAFFIC AREAS.

DISTURBED AREA: 1,185 Sq.Ft. or 0.03 Ac.±

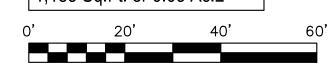



BURGERS OF BALTIMORE, LLC
811 KENSINGTON FARM COURT
FOREST HILL, MARYLAND 21050
PHONE: 410-893-1763

CONTACT


RICHARDSON ENGINEERING, LLC
30 EAST PADONIA ROAD
SUITE 500
TIMONIUM, MD 21093
ATTN: RICK RICHARDSON
PHONE: (410) 560-1502 x112

DEVELOPER /
APPLICANT

BURGERS OF BALTIMORE, LLC
811 KENSINGTON FARM COURT
FOREST HILL, MARYLAND 21050
ATTN: GARY EDWARDS
PHONE: (410) 893-1763

DESIGN AND DRAWINGS ARE BASED ON MARYLAND
COORDINATE SYSTEM (MCS).
HORIZONTAL - NAD 83/(2011)
VERTICAL - NAVD 88

PROFESSIONAL CERTIFICATION:
I HEREBY CERTIFY THAT THESE DOCUMENTS WERE PREPARED OR
APPROVED BY ME, AND THAT I AM A DULY LICENSED PROFESSIONAL
ENGINEER UNDER THE LAWS OF THE STATE OF MARYLAND, LICENSE
NUMBER 16597, EXPIRATION DATE: 08–15–2021

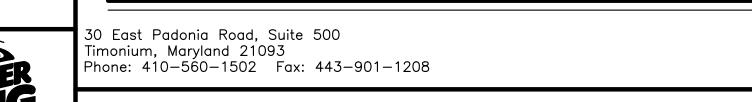

SITE PLAN
TO ACCOMPANY BUILDING PERMIT

BURGER KING

(STORE #9571)

2110 EMMORTON ROAD

BEL AIR, MD 21015

Richardson Engineering, LLC


HARFORD COUNTY
15th ELECTION DISTRICT
REVISIONS

19202

01 OF 01

06/05/20

NOTE:
THE CORRECTNESS OR COMPLETENESS OF EXISTING INFORMATION SHOWN ON THE DRAWINGS IS NOT WARRANTED OR GUARANTEED. THE CONTRACTOR SHALL VERIFY THE LOCATION OF UTILITIES AND UNDERGROUND FACILITIES, BY TEST PITS OR OTHER METHODS APPROVED BY THE OWNER'S REPRESENTATIVE, AS REQUIRED TO VERIFY EXACT LOCATIONS AND DEPTHS WITHIN THE LIMIT OF DISTURBANCE. ALL DISCREPANCIES BETWEEN INFORMATION SHOWN ON THE DRAWINGS AND THAT VERIFIED IN THE FIELD SHALL BE REPORTED TO THE OWNER'S REPRESENTATIVE PRIOR TO BEGINNING CONSTRUCTION.

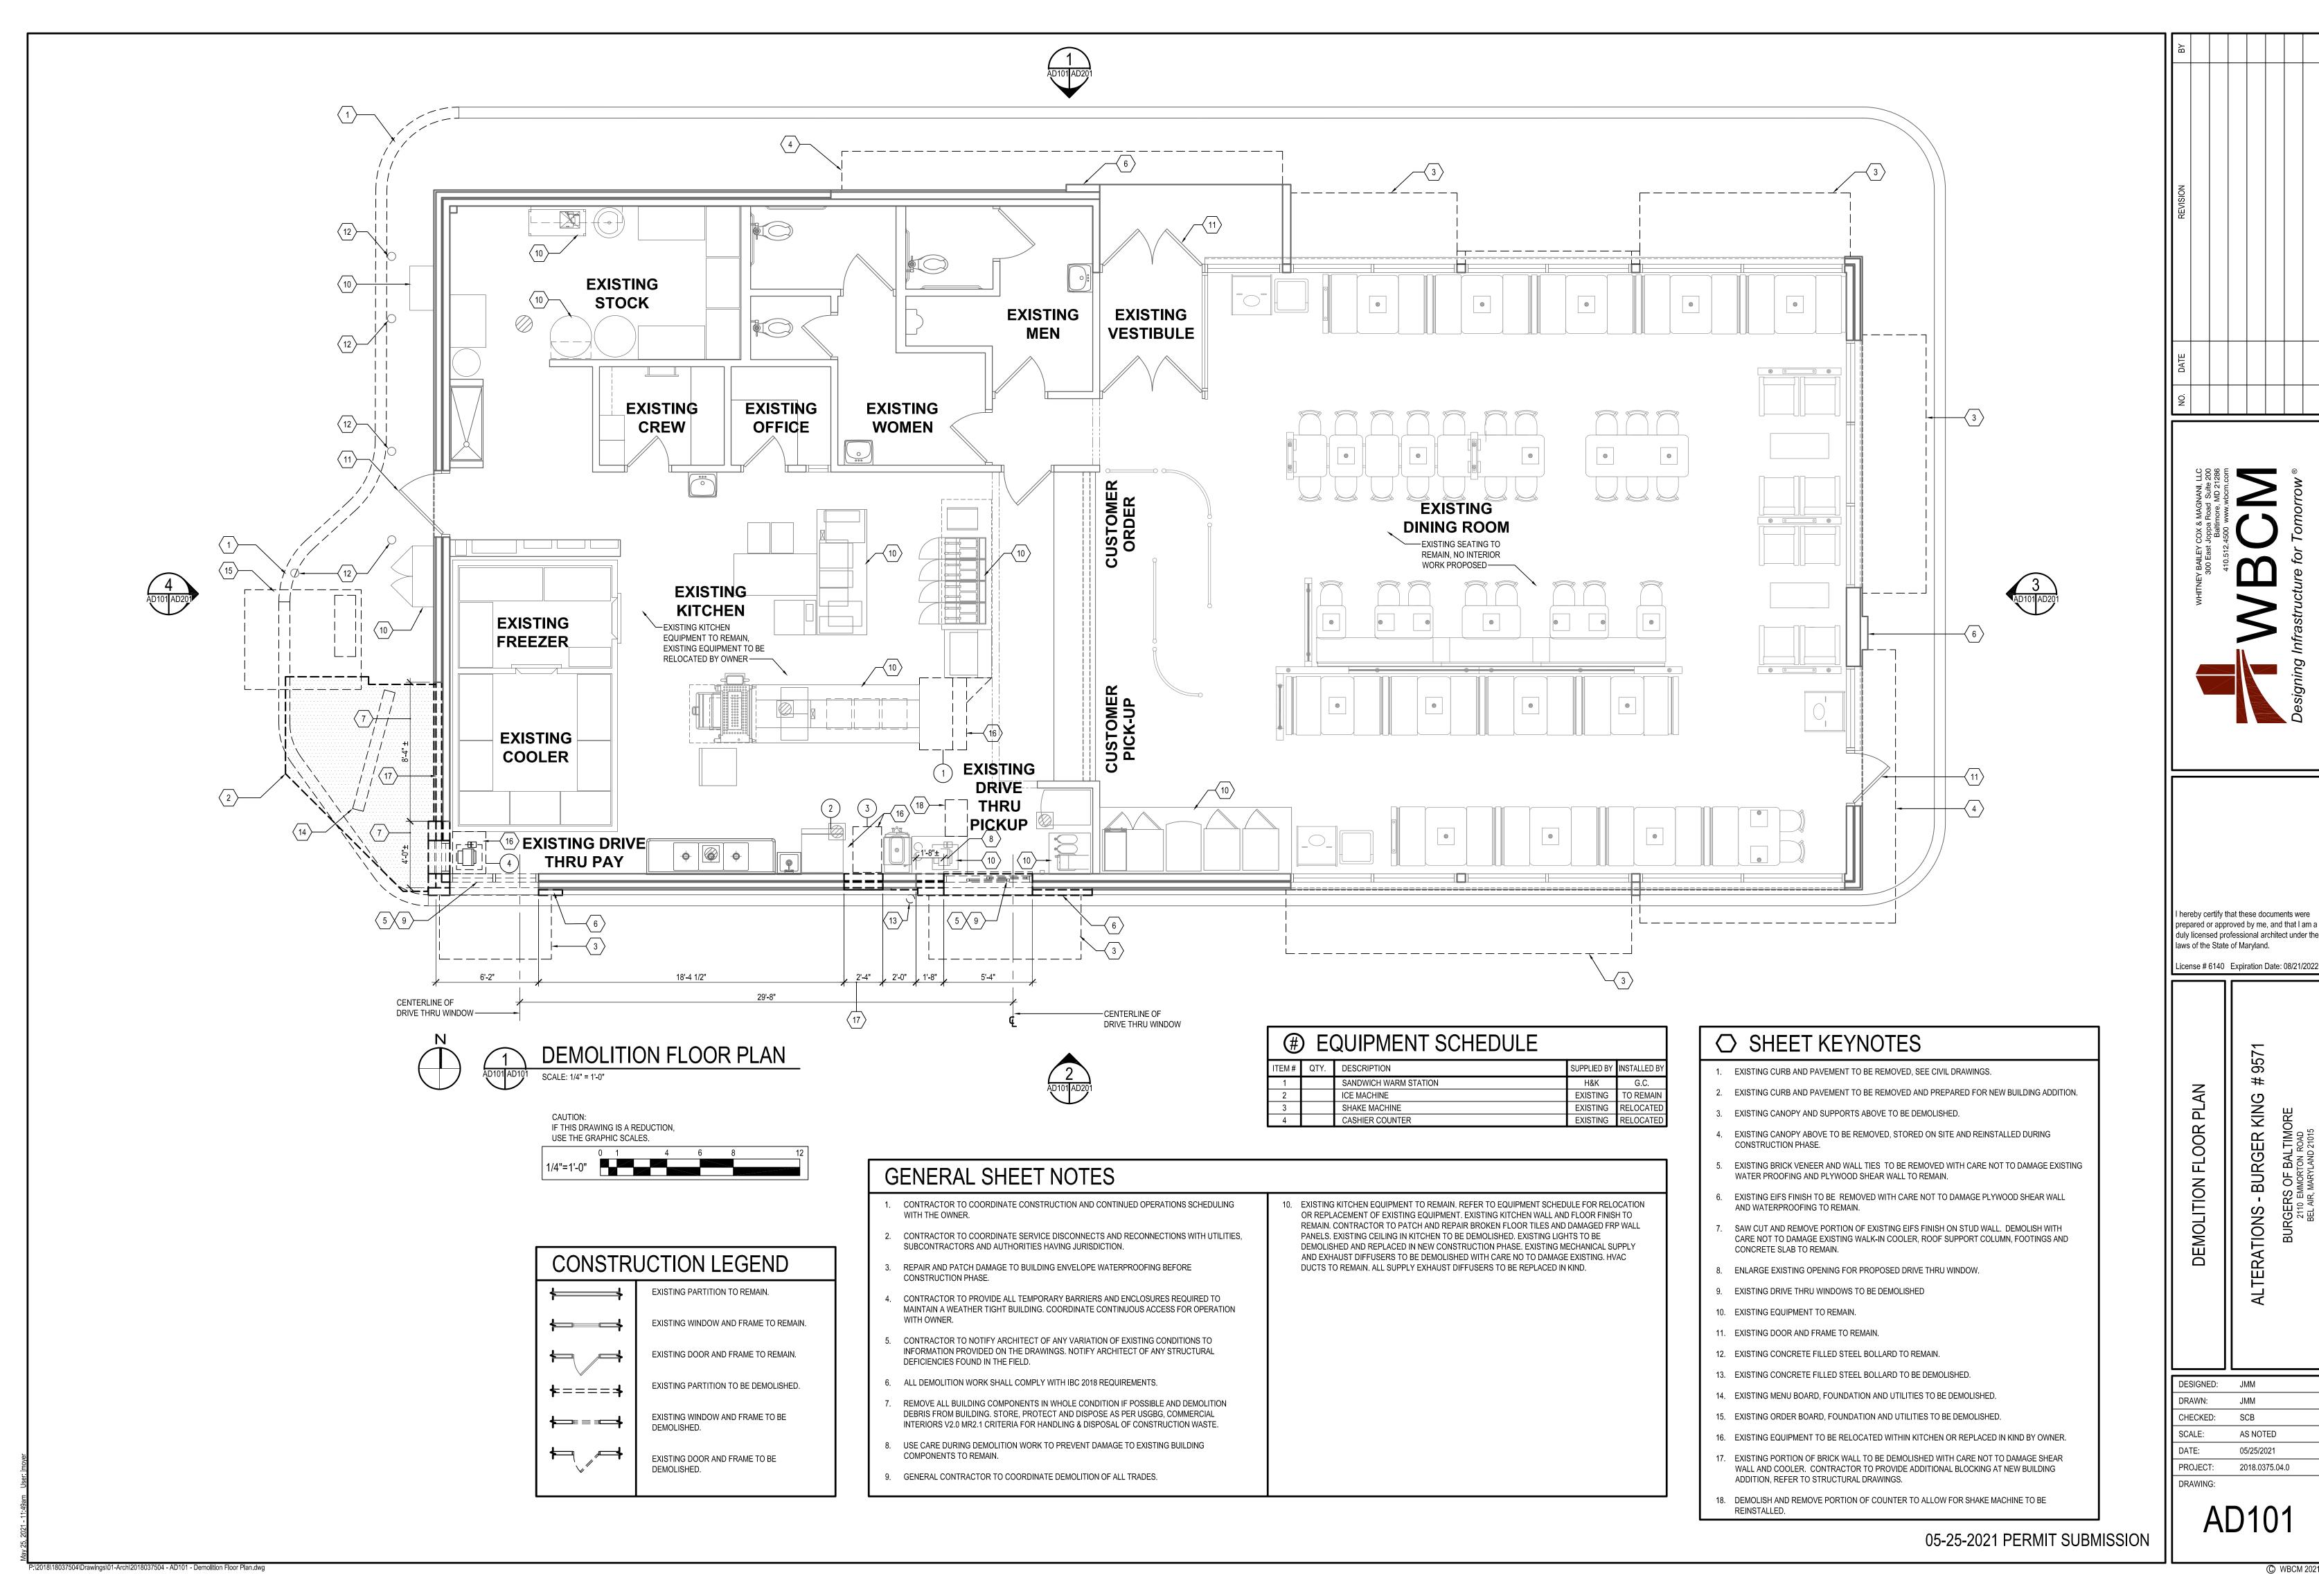


AS NOTED

05/25/2021

BURGER

TERATIONS .

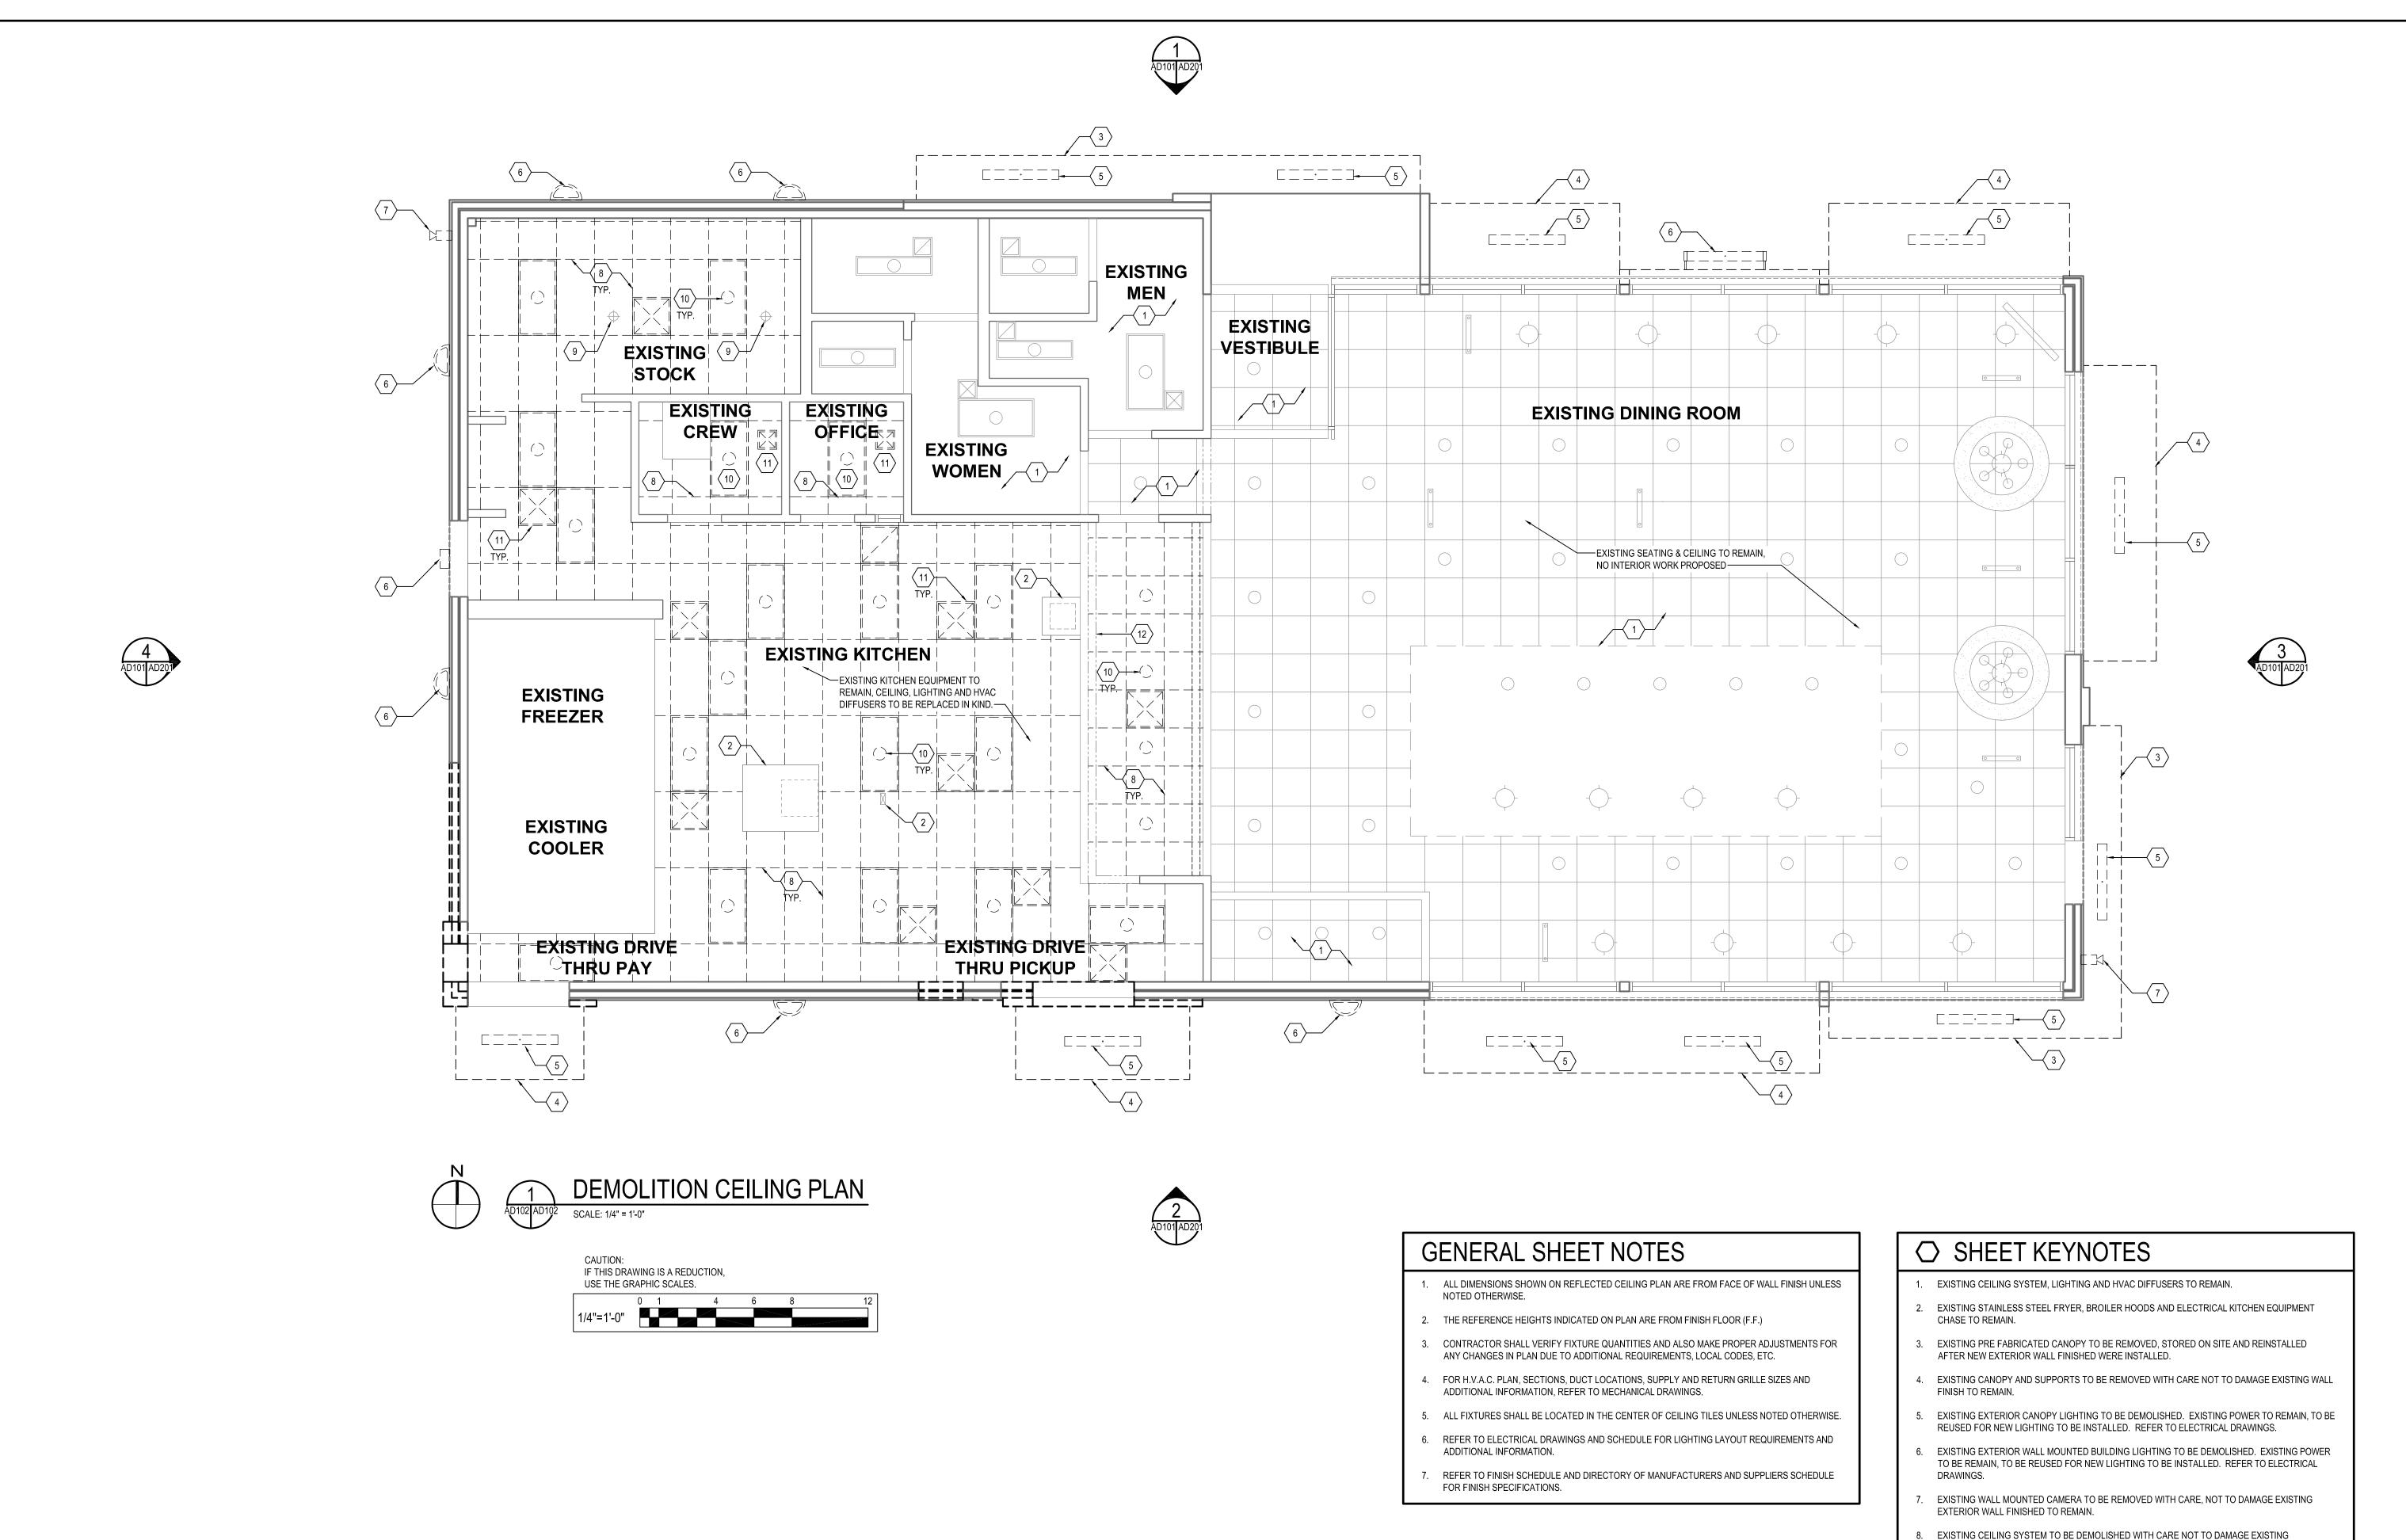

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- 8. EXISTING CEILING SYSTEM TO BE DEMOLISHED WITH CARE NOT TO DAMAGE EXISTING EQUIPMENT TO REMAIN.
- 9. EXISTING SPRINKLER HEADS TO REMAIN.
- 10. EXISTING INTERIOR LIGHTING TO BE DEMOLISHED. EXISTING POWER TO BE REMAIN, TO BE REUSED FOR NEW LIGHTING TO BE INSTALLED. REFER TO ELECTRICAL DRAWINGS.
- 11. EXISTING MECHANICAL SUPPLY AND EXHAUST DIFFUSERS TO BE DEMOLISHED WITH CARE NOT TO DAMAGE EXISTING HVAC DUCTS TO REMAIN. REFER TO MECHANICAL DRAWINGS.
- 12. EXISTING SURFACE MOUNTED MENU BOARD TO REMAIN.

License # 6140 Expiration Date: 08/21/2022 - BURGER KING LTERATIONS -

I hereby certify that these documents were

laws of the State of Maryland.

DEMOLITION CEILING PLAN

DESIGNED: JMM

JMM

SCB

AD102

AS NOTED

05/25/2021

2018.0375.04.0

DRAWN:

SCALE:


CHECKED:

PROJECT:

DRAWING:

prepared or approved by me, and that I am a duly licensed professional architect under the

05-25-2021 PERMIT SUBMISSION

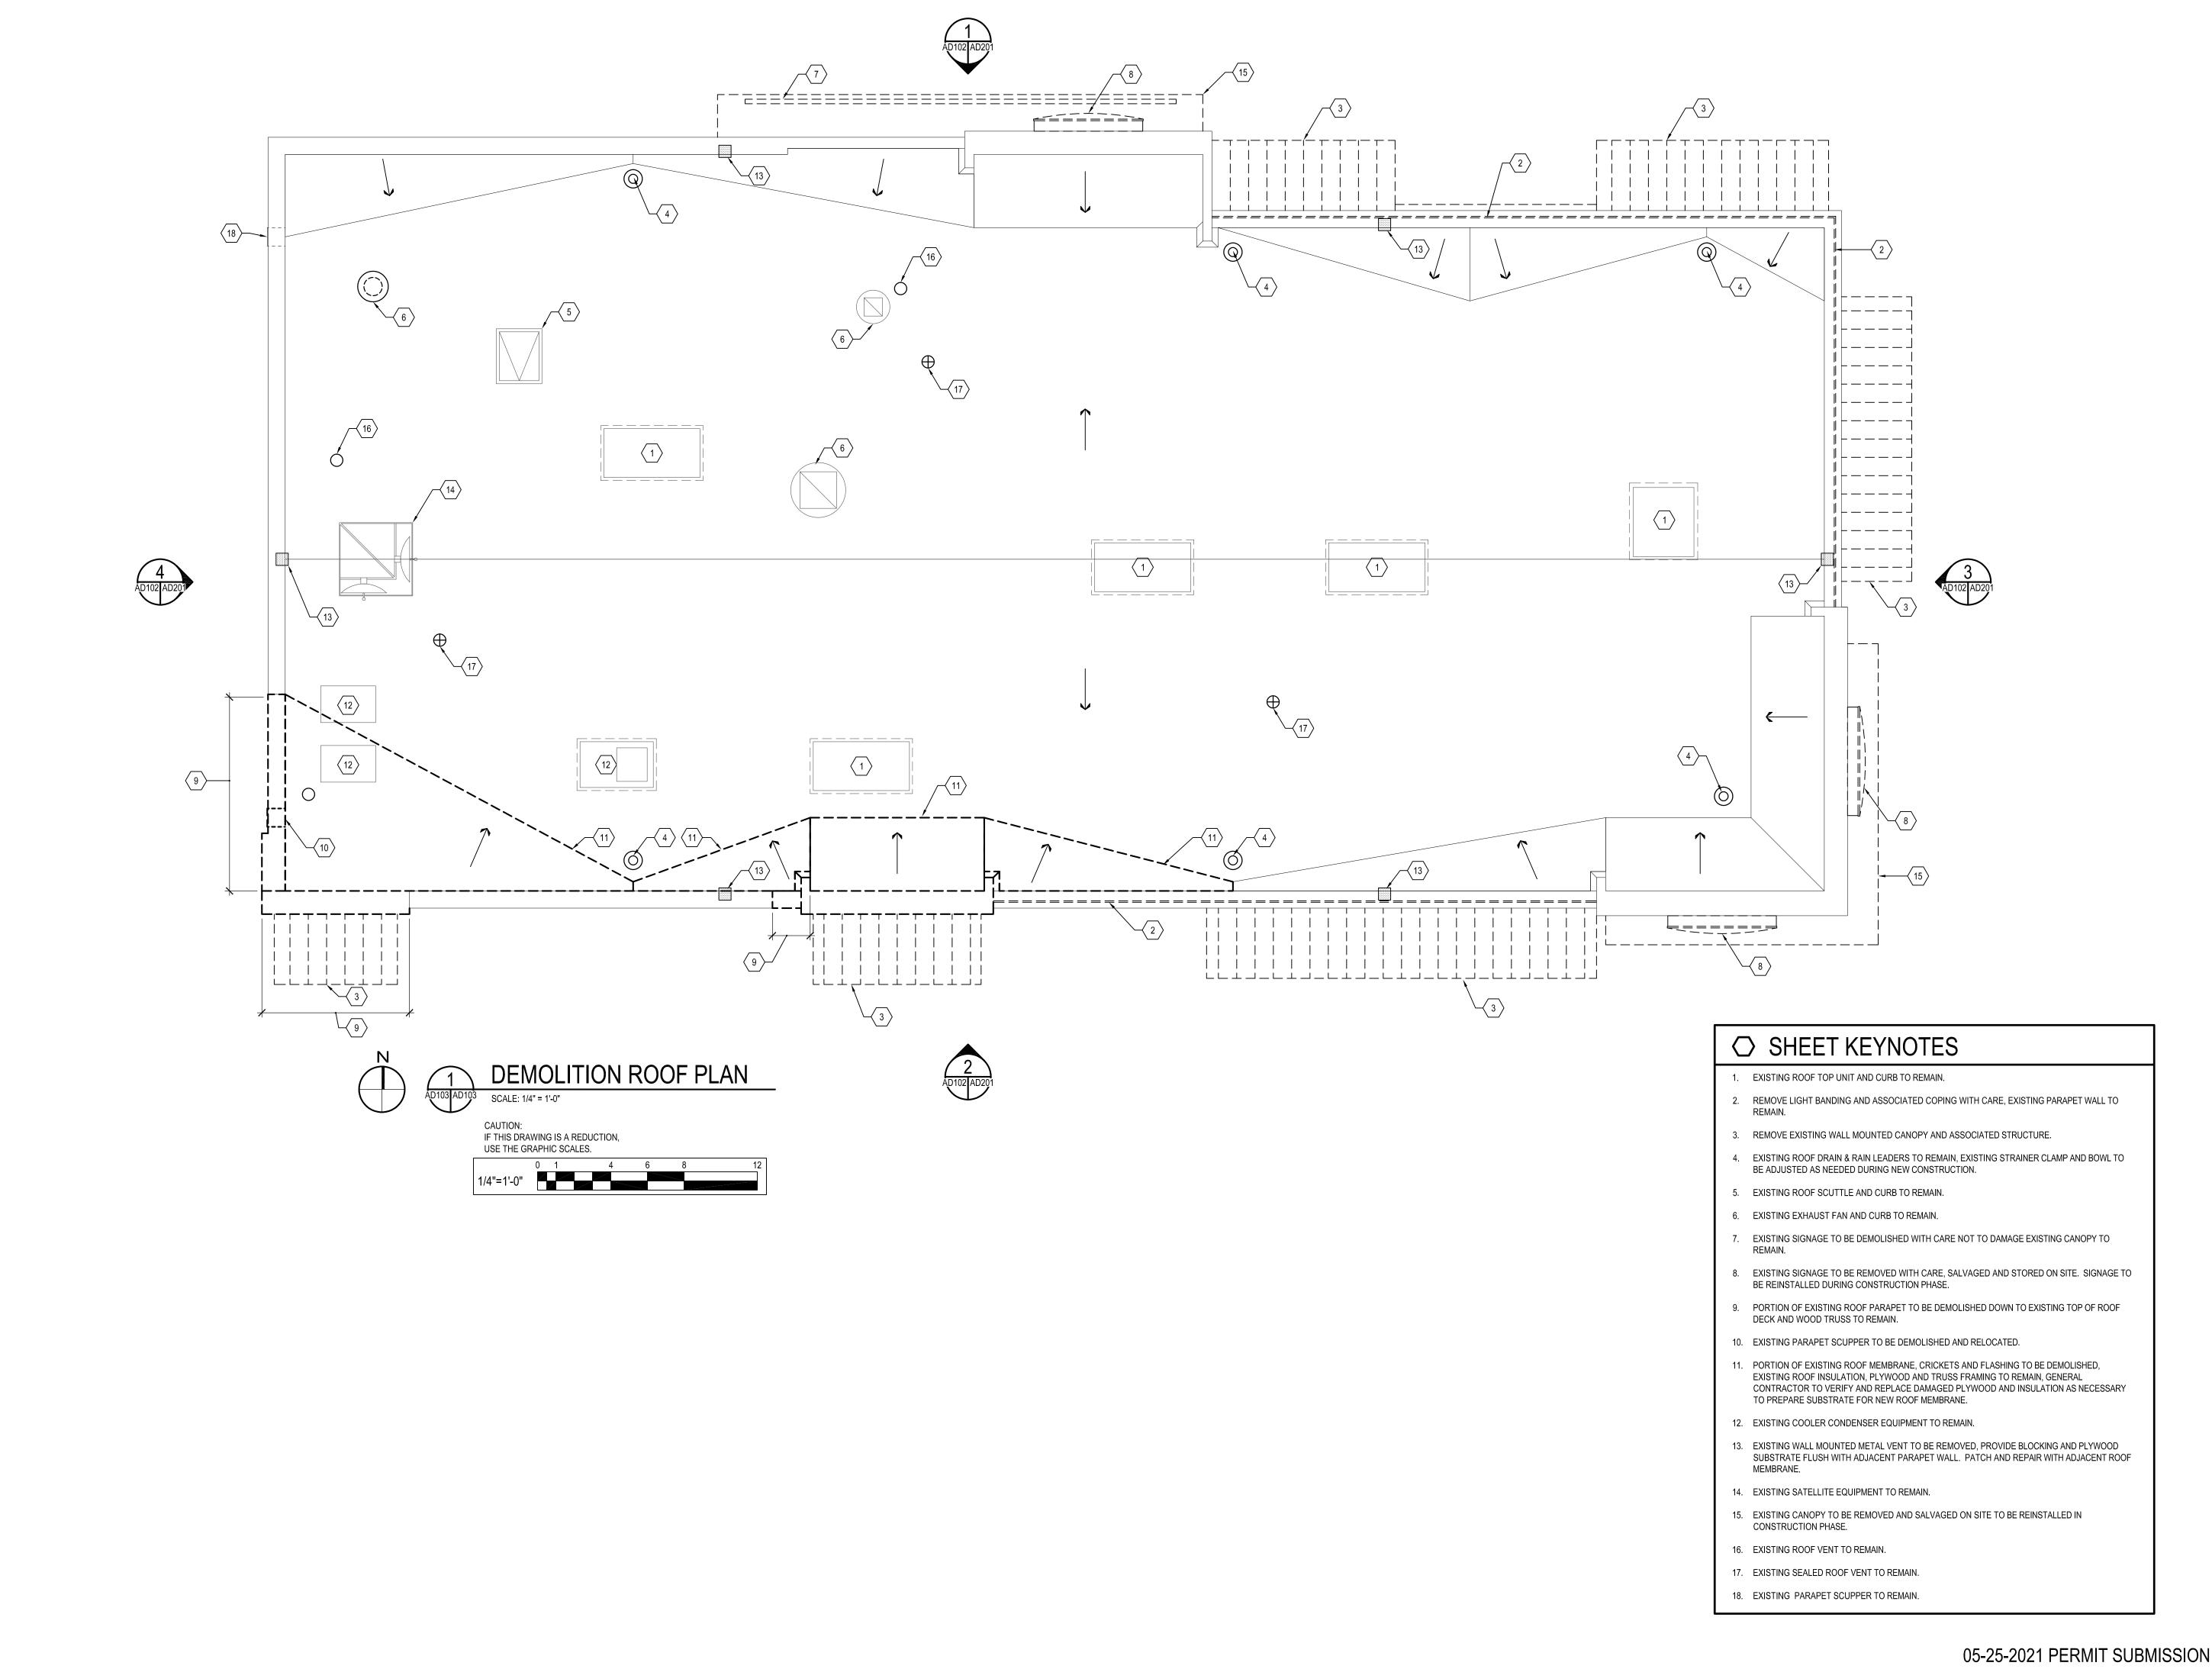


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I hereby certify that these documents were prepared or approved by me, and that I am a duly licensed professional architect under the laws of the State of Maryland.

License # 6140 Expiration Date: 08/21/2022

S - BURGER KING
ERS OF BALTIMORE
AIR MARYI AND 21015
AIR MARYI AND 21015 **DEMOLITION ROOF** LTERATIONS BURGER
2110
BEL AII

DESIGNED:	JMM
DRAWN:	JMM
CHECKED:	SCB
SCALE:	AS NOTED
DATE:	05/25/2021
PROJECT:	2018.0375.04.0
DDV/WING:	

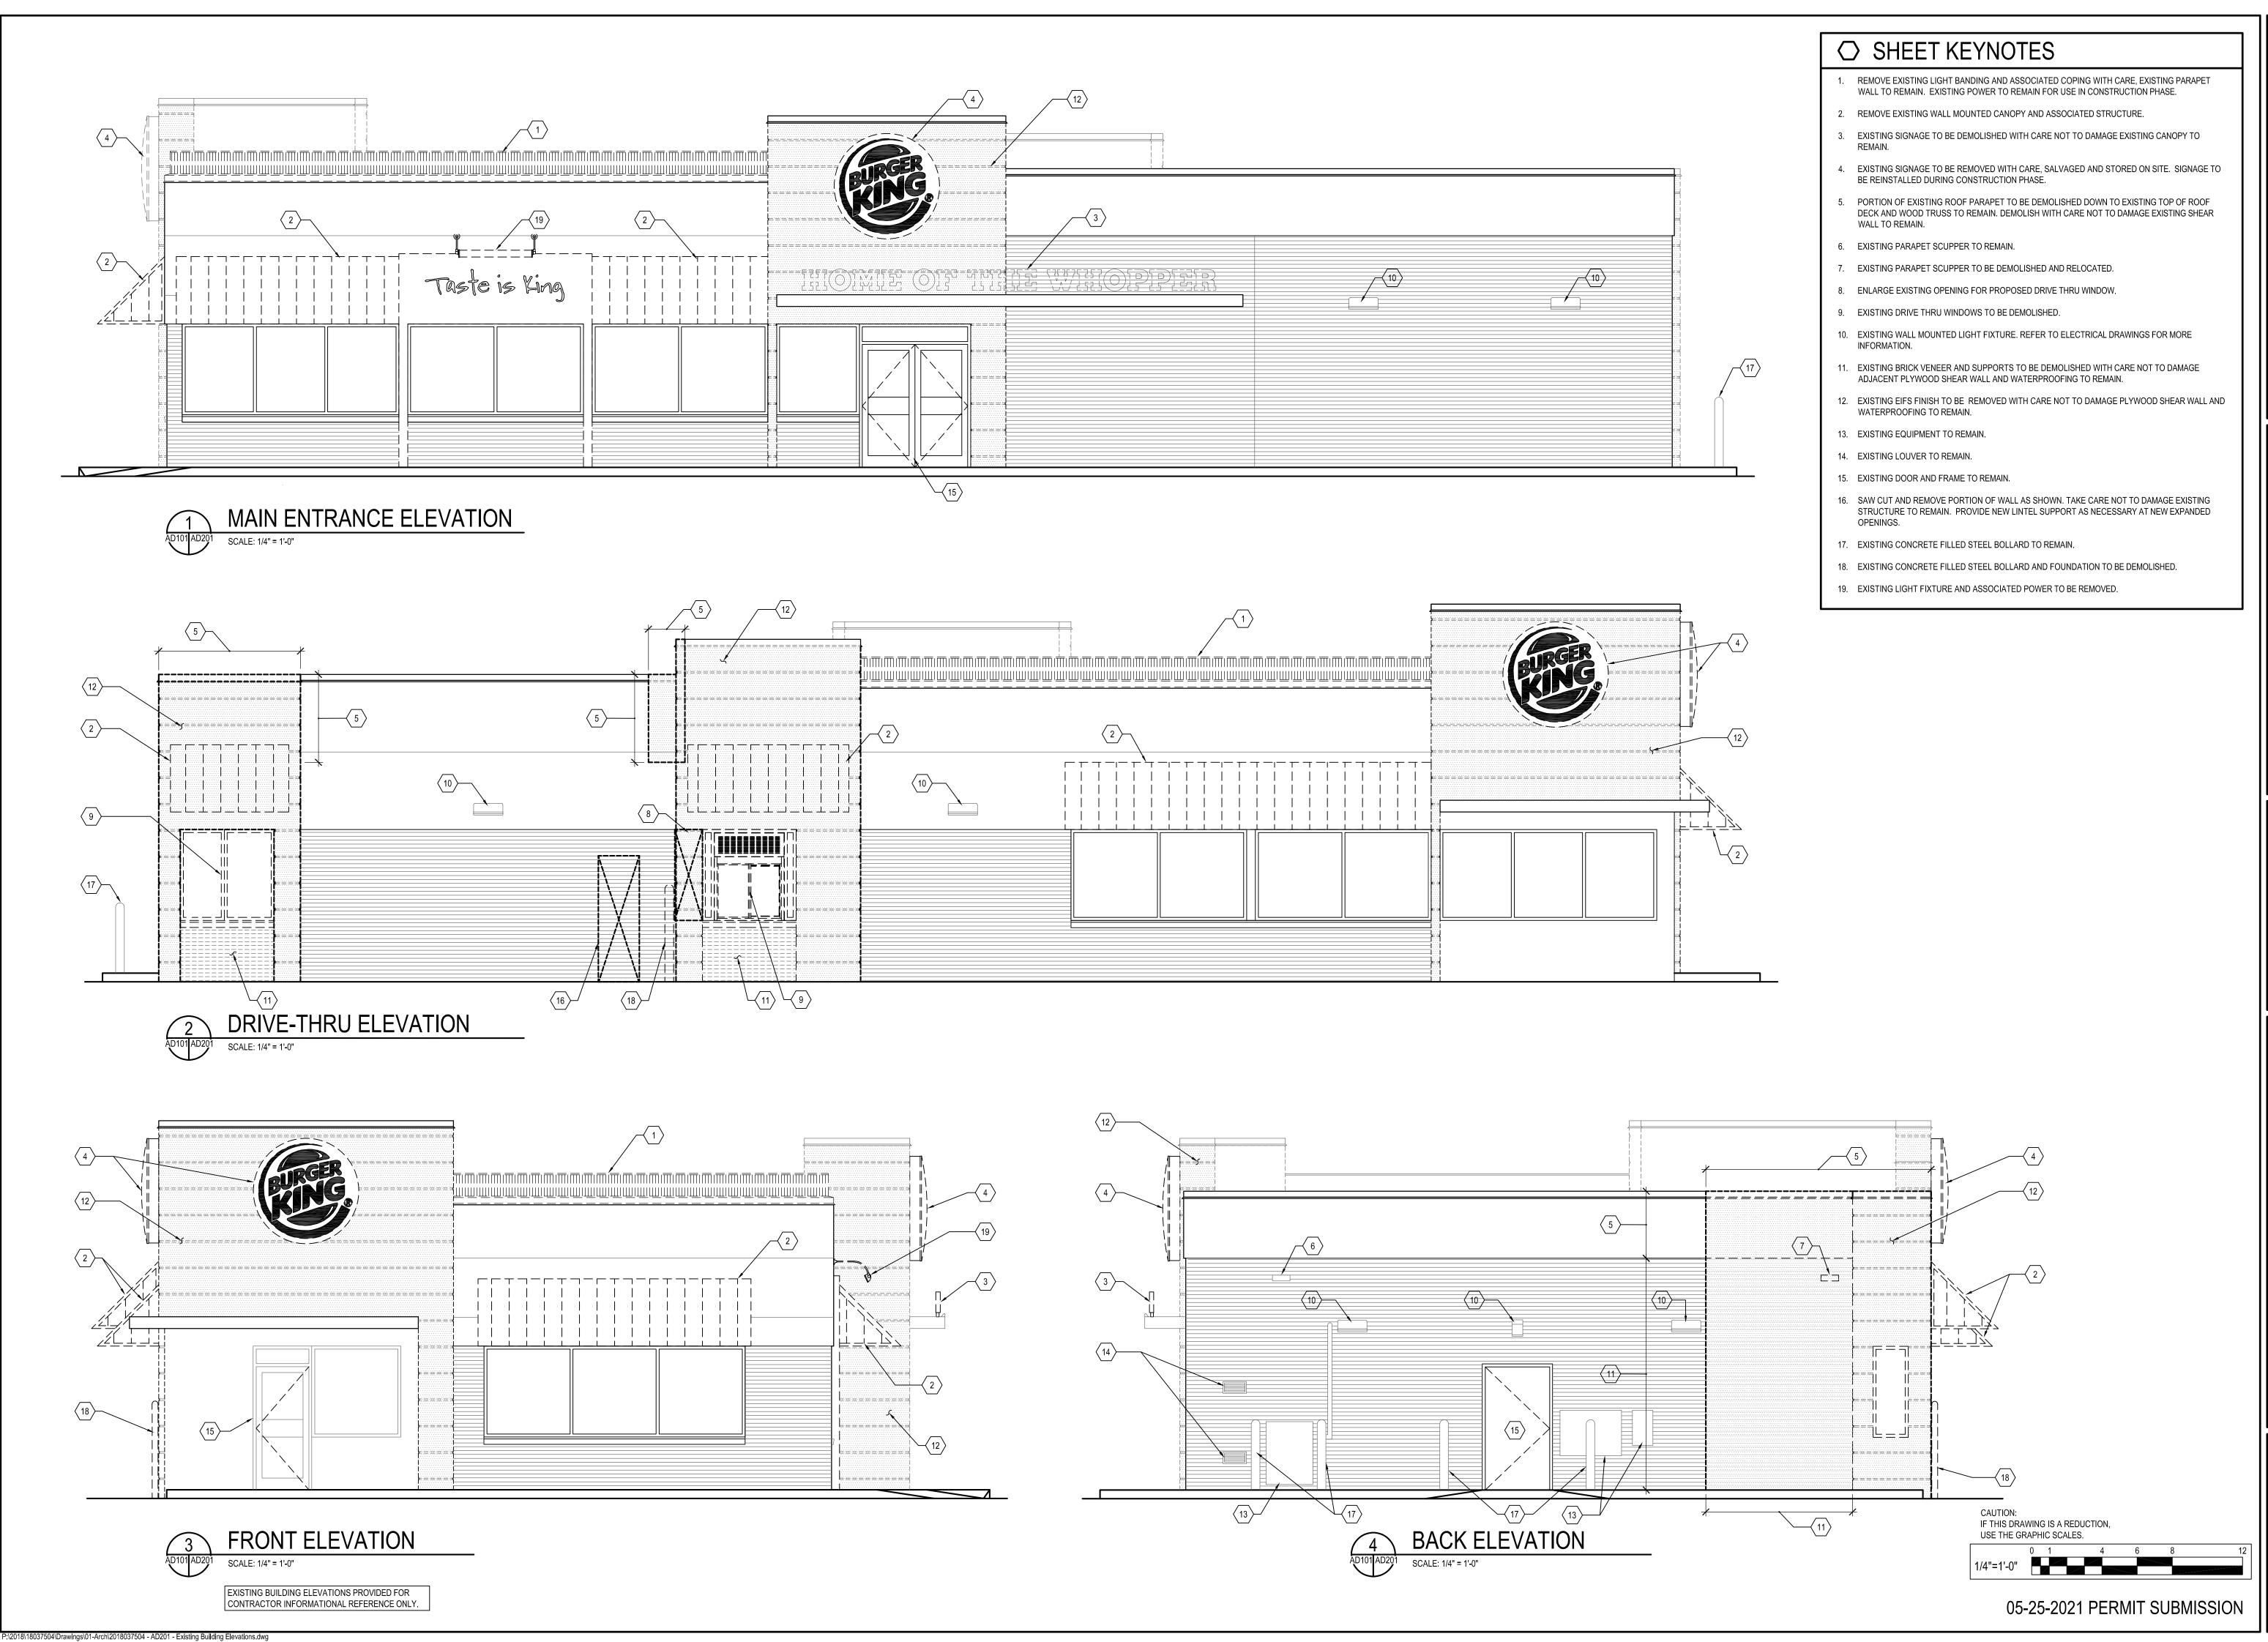

DATE REVISION BY



I hereby certify that these documents were prepared or approved by me, and that I am a duly licensed professional architect under the laws of the State of Maryland.

License # 6140 Expiration Date: 08/21/202

EXISTING BUILDING ELEVATIONS


ALTERATIONS - BURGER KING # 9571

BURGERS OF BALTIMORE
2110 EMMORTON ROAD

		_
DESIGNED:	JMM	
DRAWN:	JMM	
CHECKED:	SCB	_
SCALE:	AS NOTED	_
DATE:	05/25/2021	_
PROJECT:	2018.0375.04.0	_
		-

AD201

DRAWING:

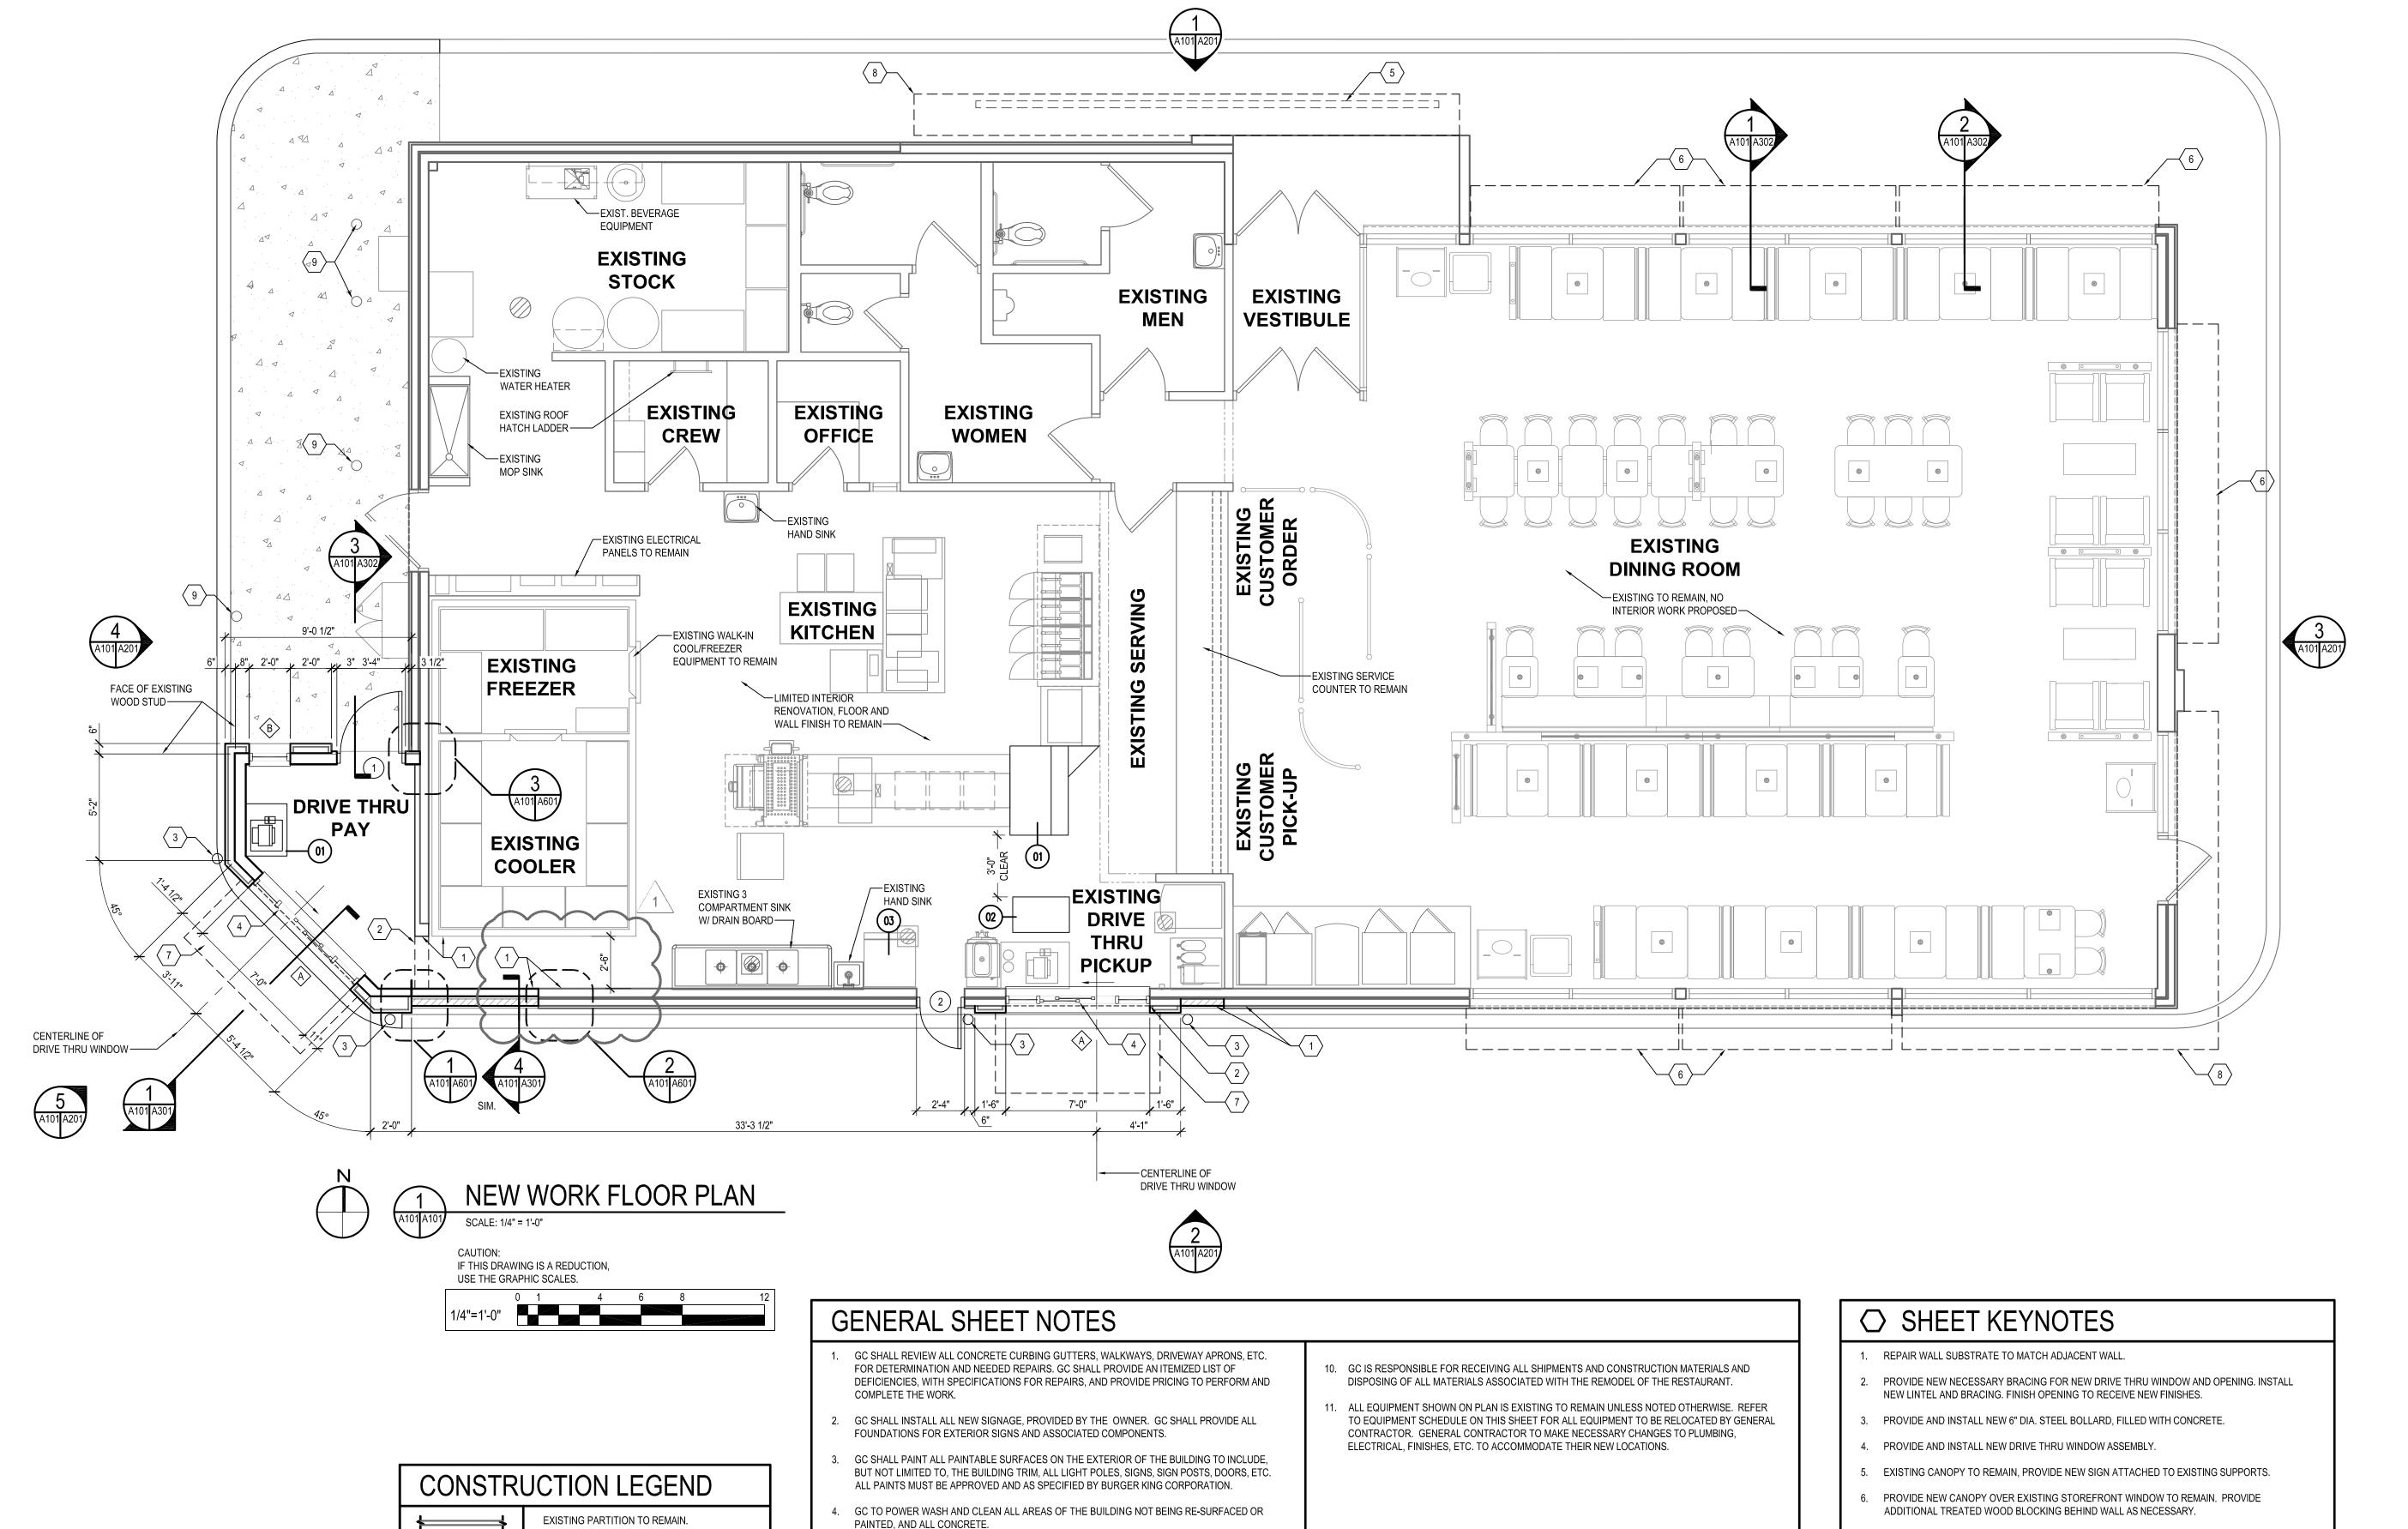

EXISTING WINDOW AND FRAME TO REMAIN. EXISTING DOOR AND FRAME TO REMAIN. NEW PARTITION TO BE CONSTRUCTED. NEW WINDOW AND FRAME TO BE CONSTRUCTED. NEW DOOR AND FRAME TO BE CONSTRUCTED.

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- 5. GC SHALL REPAIR/REPLACE FRP PANELS IN THE KITCHEN AREA AS NEEDED. INCLUDE THE WALL FINISH FRP SYMMETRIX REPLACEMENT OF UP TO 4 SHEETS OF NEW FRP PANELS. SUPPLY COST
- 6. GC SHALL CLEAN, REPAIR/REPLACE DAMAGED AND BROKEN QUARRY TILES IN THE KITCHEN AREA. REGROUT THE FLOOR AS REQUIRED/NEEDED.
- 7. GC SHALL INSTALL ALL CEILING MONITORS AND OTHER MISCELLANEOUS ITEMS DISTURBED AND OR REMOVED AS PART OF THE WORK. ANY ITEMS THAT CANNOT BE CLEANED / REFURNISHED TO LOOK AS NEW WILL BE REPLACED WITH NEW.
- 8. UNDER THE CONSTRUCTION WORK OF THIS PROJECT, GC SHALL INSTALL ALL BLOCKING, SUPPORT FRAMING, EMBEDS, CONCEALED OR OTHERWISE FOR ALL SIGNS, CANOPIES, AND BUILDING ATTACHMENTS. CHECK DRAWINGS AND FIELD CONDITIONS TO VERIFY PROPER SUPPORT FOR SUCH ITEMS.
- 9. ALL EXISTING AND REMAINING SIGNS SHALL BE CLEANED, RETROFITTED FOR LED AND RE-LAMPED AS NEEDED.

- 7. PROVIDE NEW CANOPY OVER DRIVE THRU WINDOW. PROVIDE ADDITIONAL TREATED WOOD BLOCKING BEHIND WALL AS NECESSARY.
- 8. EXISTING CANOPY TO BE REINSTALLED DURING CONSTRUCTION PHASE AFTER EXTERIOR FINISHES HAVE BEEN INSTALLED.
- 9. EXISTING BOLLARD TO REMAIN.

#	) E(	QUIPMENT SCHEDULE	
	0.77.4		

M #	QTY.	DESCRIPTION	SUPPLIED BY	INSTALLED BY
1		SANDWICH WARM STATION	H&K	G.C.
2		SHAKE MACHINE	EXISTING	RELOCATED
3		ICE MACHINE	EXISTING	TO REMAIN
1		CASHIER COUNTER	EXISTING	RELOCATED

05-25-2021 PERMIT SUBMISSION

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License # 6140 Expiration Date: 08/21/2022

- BURGER

TERATIONS .

JMM

SCB

AS NOTED

05/25/2021

2018.0375.04.0

WORK

NEW

DESIGNED:

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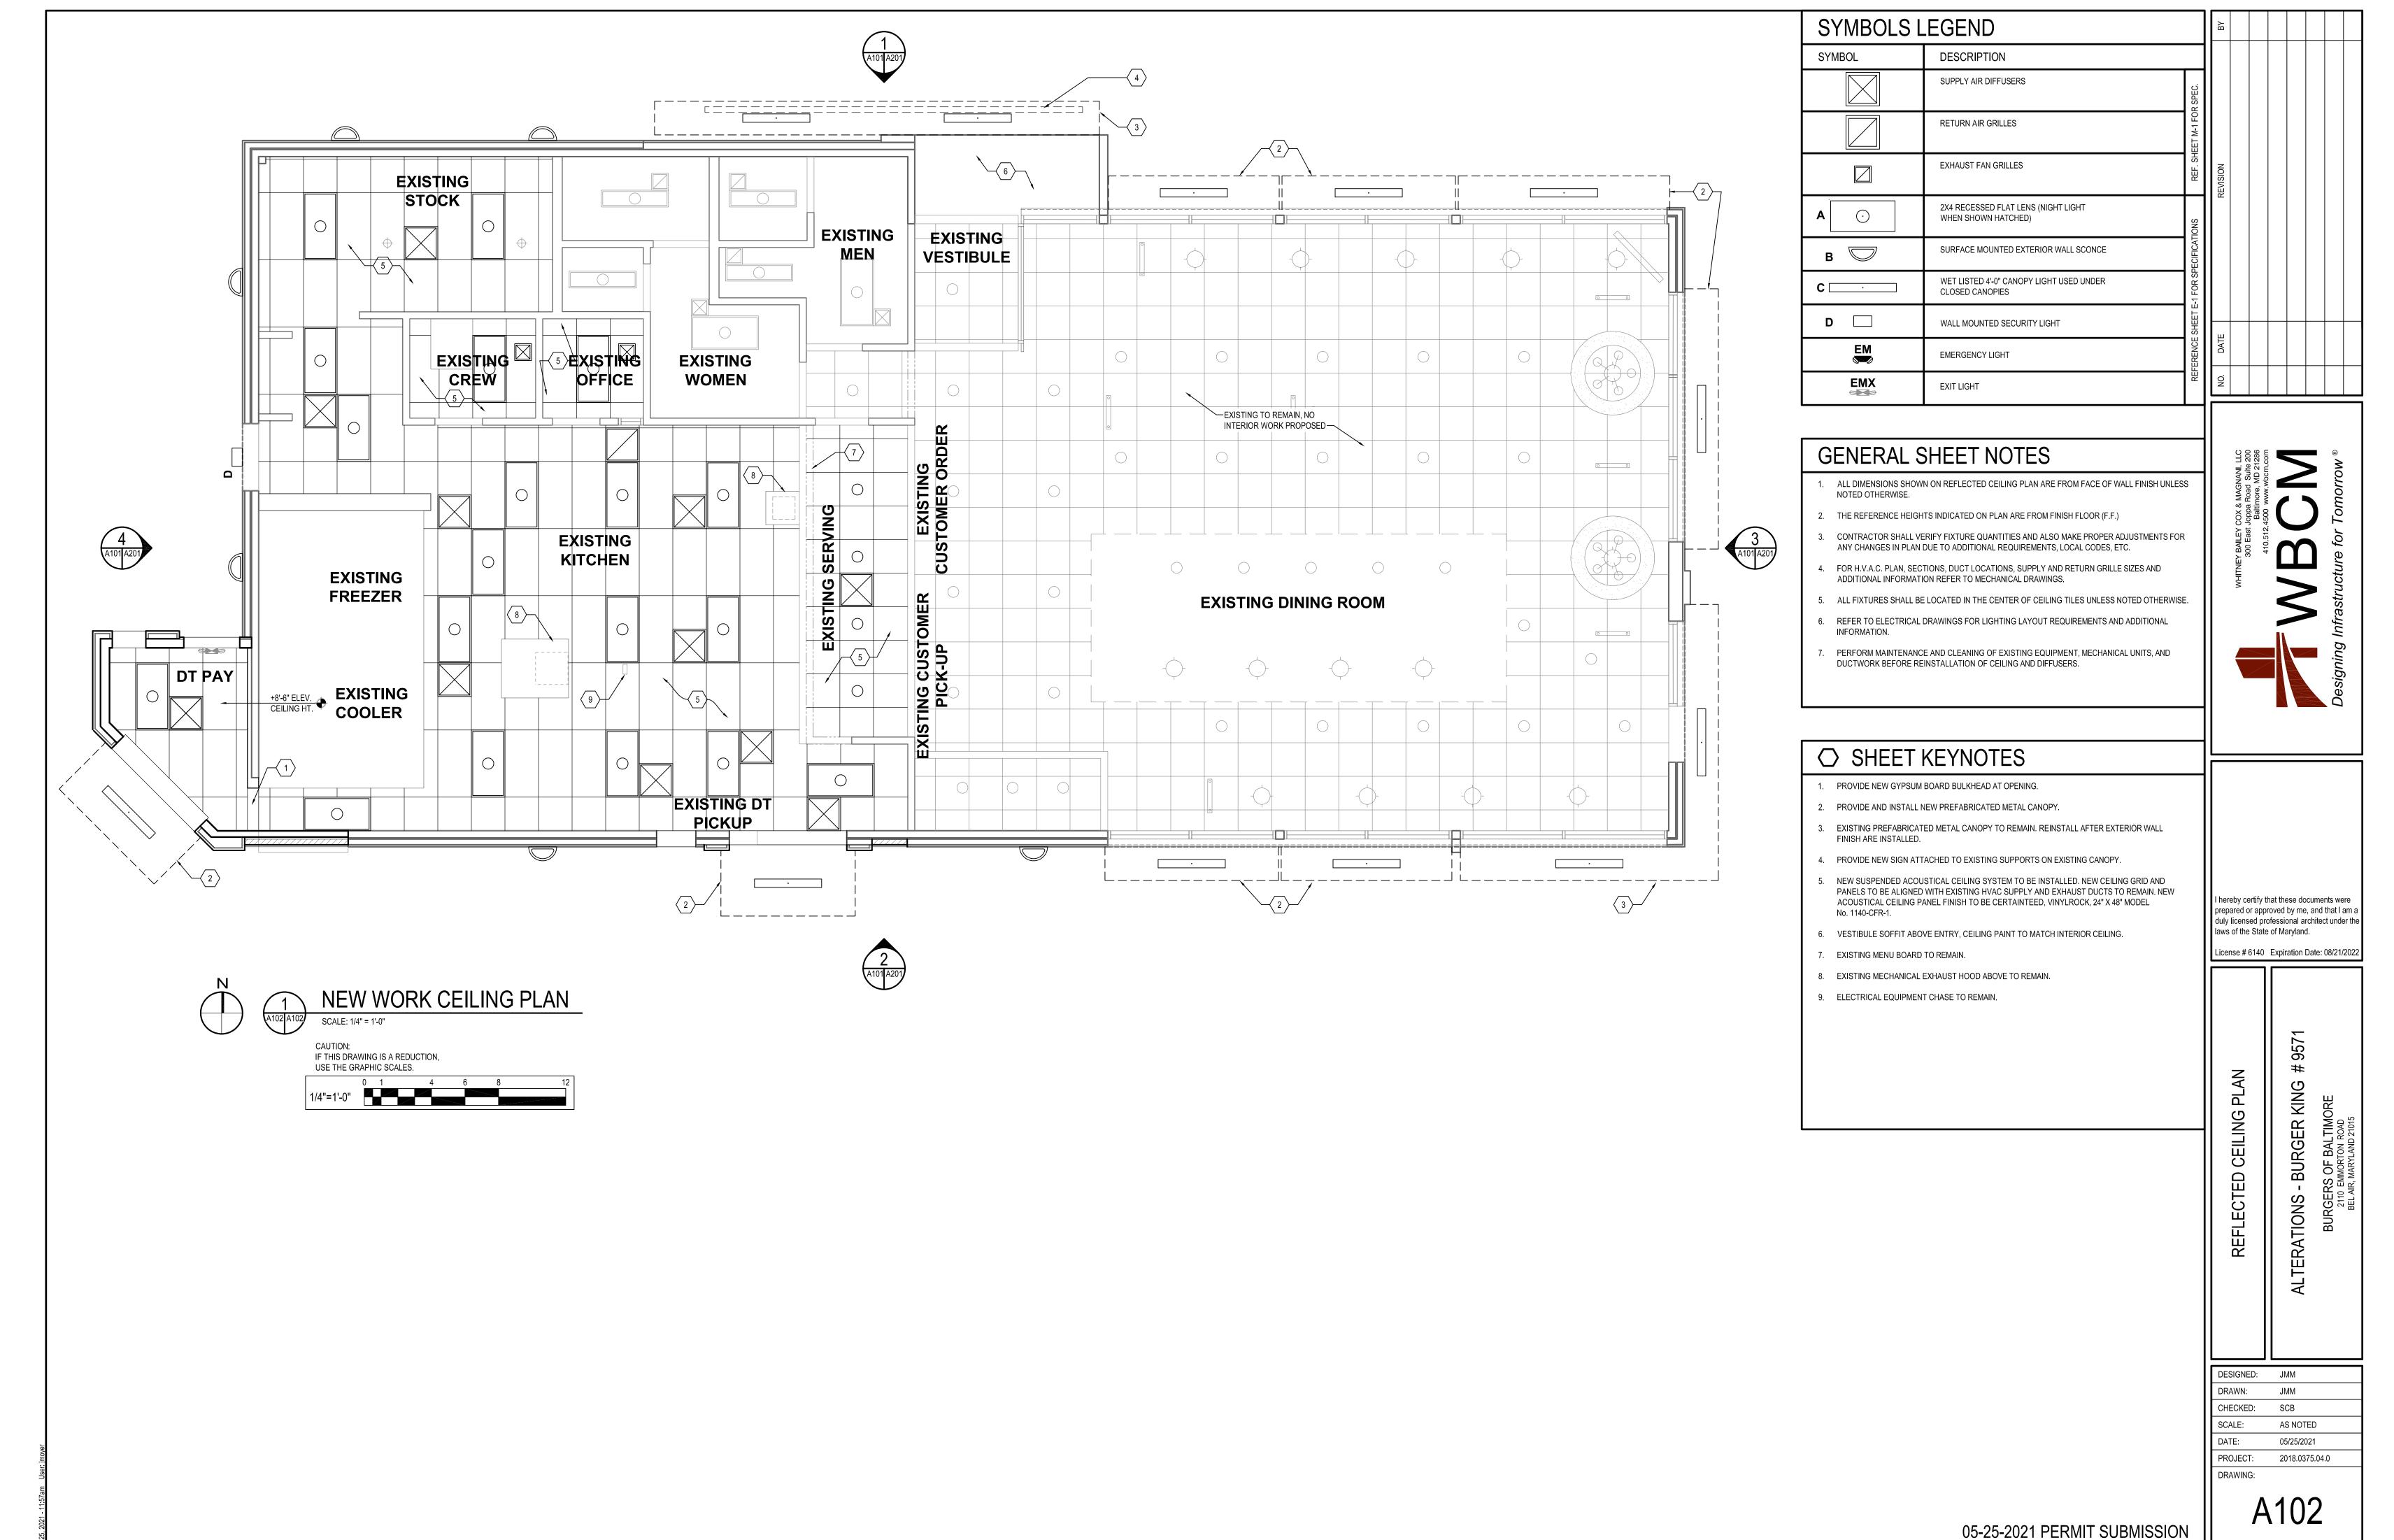
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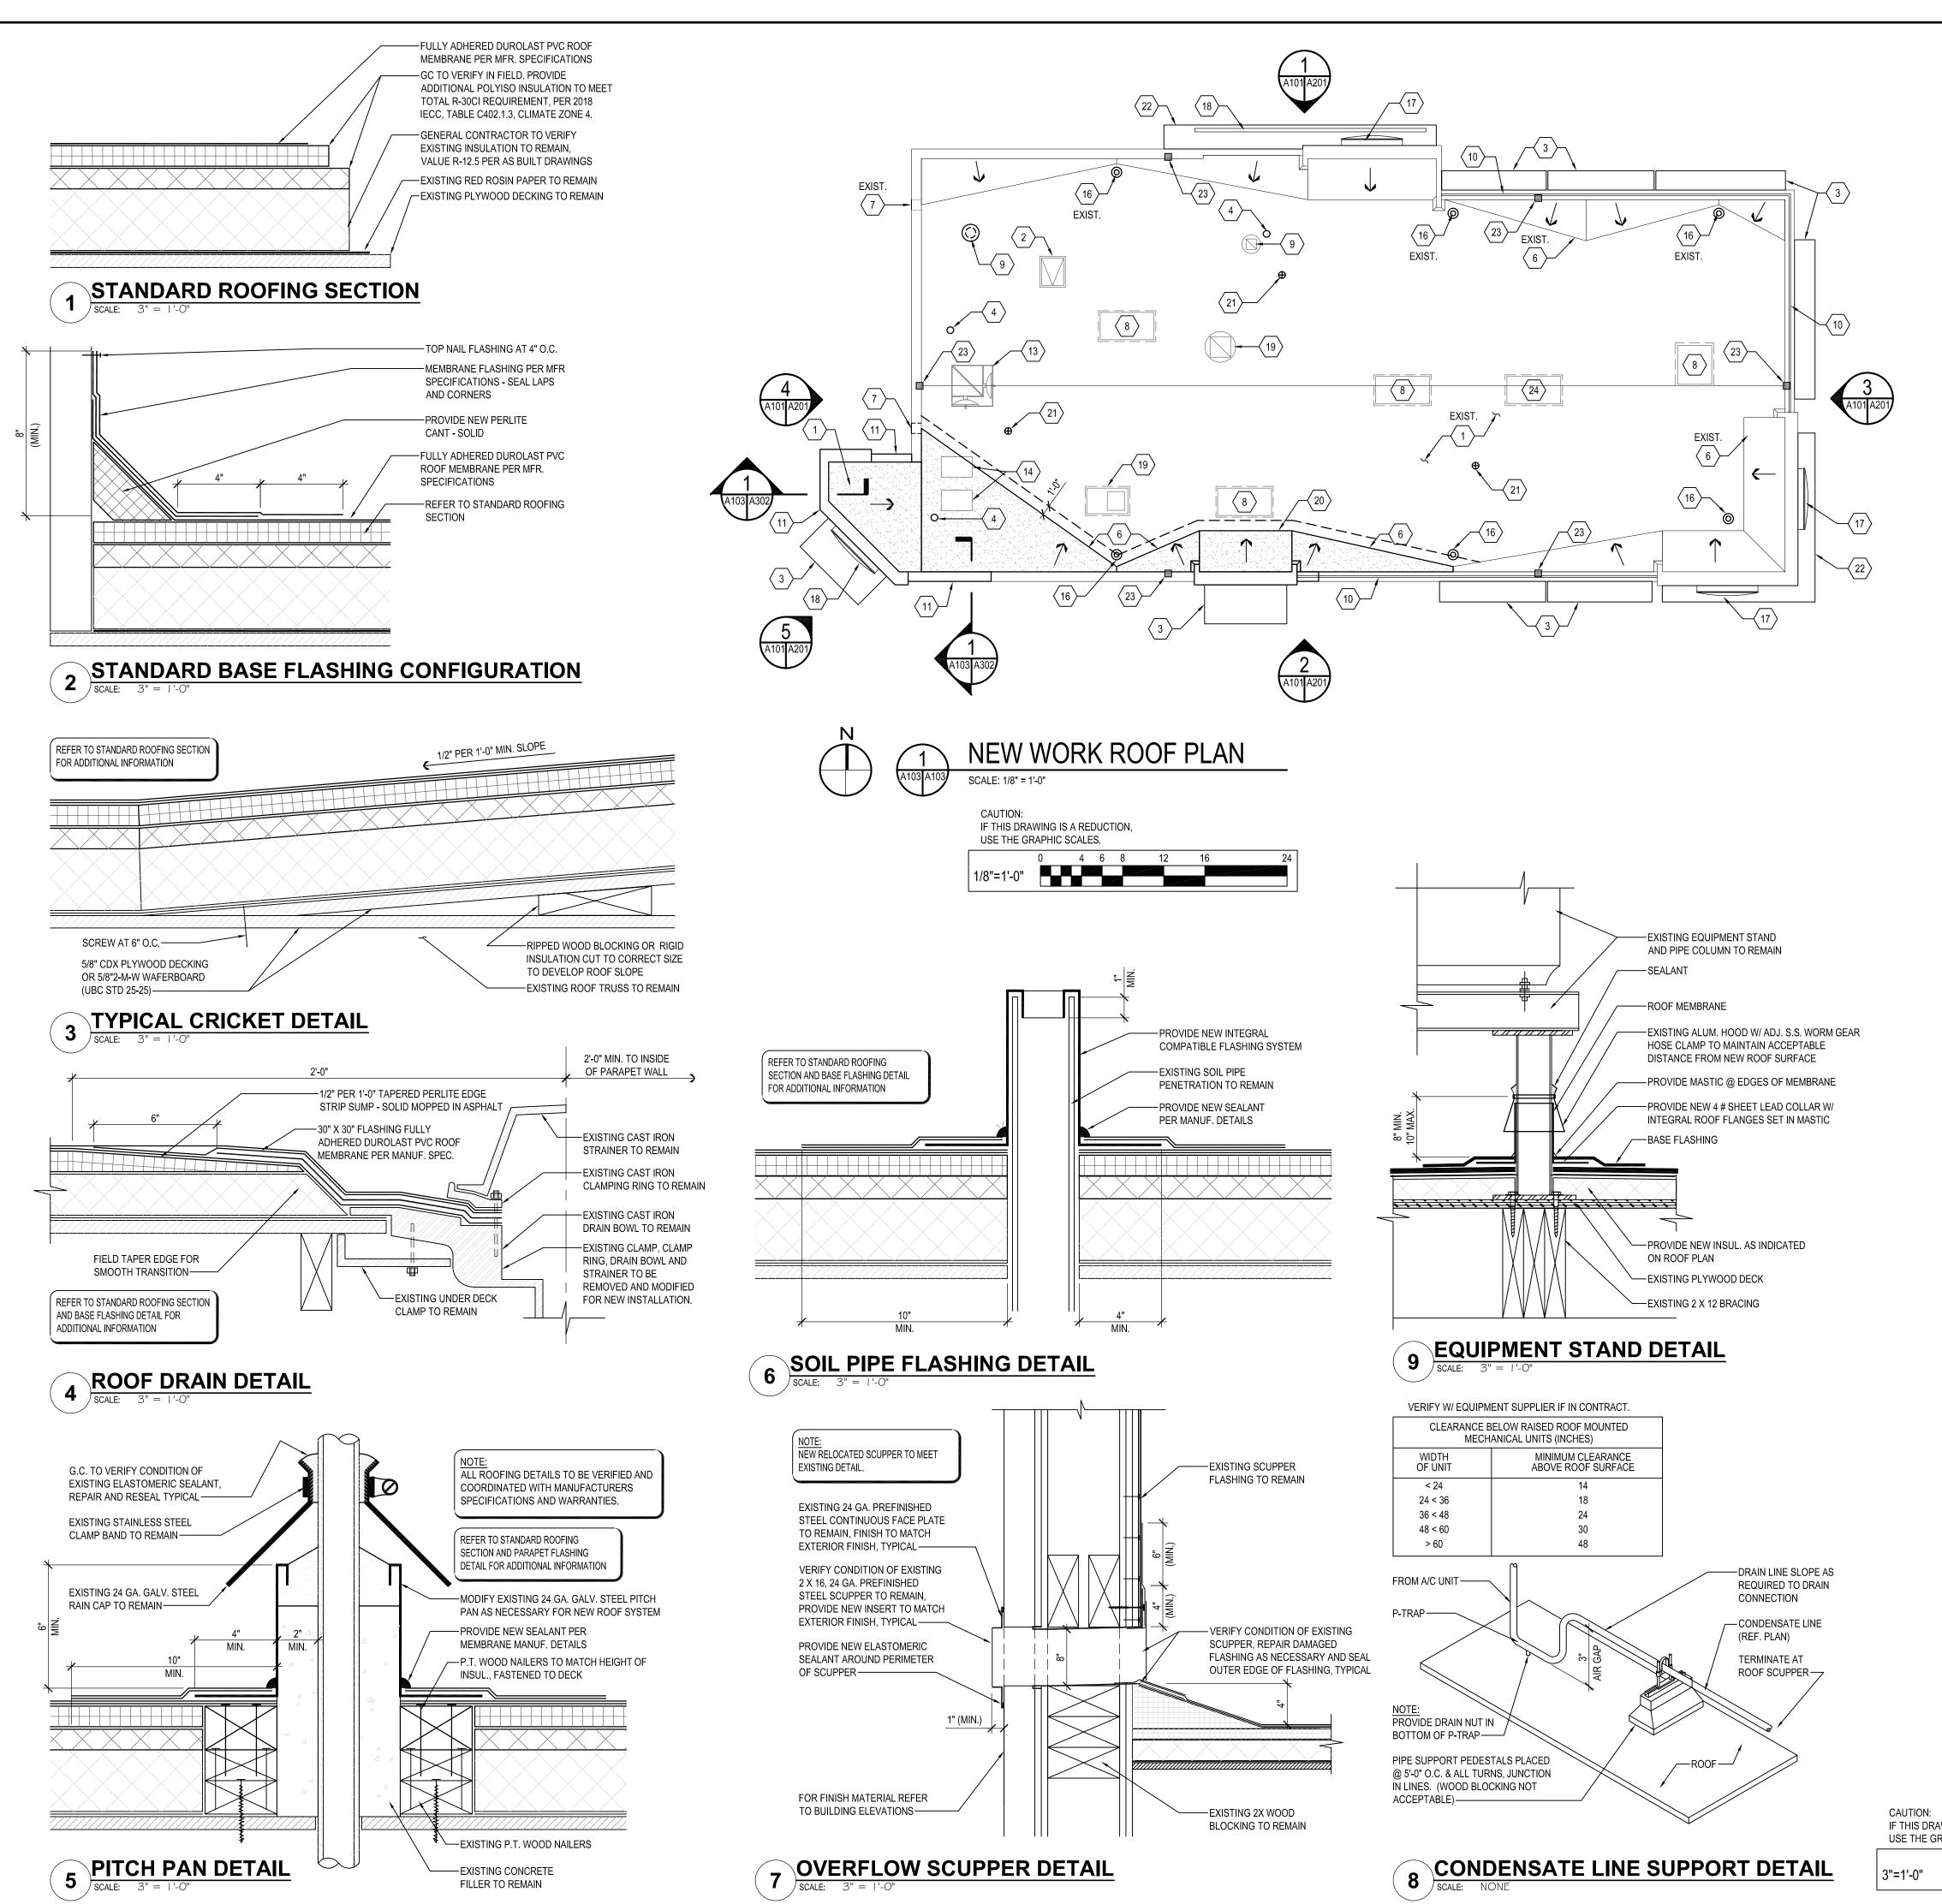
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laws of the State of Maryland.



P:\2018\18037504\Drawings\01-Arch\2018037504 - A102 - New Work Ceiling Plan.dwg



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# **GENERAL NOTES**

- A. THE EXISTING ROOF STRUCTURE SHALL NOT BE USED FOR STOCKPILING OF EQUIPMENT OR MATERIALS UNLESS APPROVED BY THE ARCHITECT, STRUCTURAL ENGINEER AND THE JOIST MANUFACTURER.
- B. THE ROOFING SYSTEM SHALL BE AS PER DRAWINGS AND PER MANUFACTURERS
- C. COORDINATE ROOF ELEVATIONS WITH EXISTING ROOF STRUCTURE AND EXISTING OPENING FOR MECHANICAL EQUIPMENT. REFER TO SPECIFICATION SHEET FOR ROOF RELATED ITEMS, INCLUDING GUARANTEES, CURBS, FLASHING, ETC.
- D. PER AS-BUILT DRAWINGS, EXISTING ROOF INSULATION, IS 1 1/2" THICK. REPLACEMENT INSULATION FOR NEW ROOFING SYSTEM MAY BE 6" THICK TO PROVIDE AN R-30. MODIFY EXISTING ROOF TOP EQUIPMENT SUPPORTS, ETC. TO ACCOMMODATE THIS INCREASE IN THICKNESS.
- E. MINIMUM CURB HEIGHT: 8"

SPECIFICATIONS.

# GENERAL SHEET NOTES

- 1. ROOFING SUBCONTRACTOR TO COORDINATE LOCATION OF EXISTING H.V.A.C. UNITS AND ROOF TOP ACCESSORIES WITH EXISTING OPENINGS AND EXISTING STRUCTURAL, MECHANICAL AND ELECTRICAL SYSTEMS. COORDINATE WITH STRUCTURAL, MECHANICAL AND ELECTRICAL DRAWINGS. COORDINATE PLACEMENT AND TAPERED RIGID INSULATION BOARD LAY-OUT AND SUBSEQUENT INSTALLATION IN ORDER TO AVOID PONDING WATER CONDITIONS ATTRIBUTABLE TO BOARD LAY-OUT ISSUES.
- ROOF SYSTEMS SPECIFIED SHALL BE APPLIED ONLY BY MANUFACTURER APPROVED APPLICATOR IN ORDER TO MEET GUARANTEE REQUIREMENTS.
- 3. HVAC CONDENSATE LINES TO TERMINATE AT ROOF DRAIN OR AS REQUIRED BY LOCAL CODE.
- 4. REFER TO MEP DRAWINGS FOR ADDITIONAL INFORMATION.
- 5. ALL CURBS AND PIPE PENETRATIONS SHALL HAVE A MINIMUM OF 16" CLEAR FROM EACH OTHER FOR ROOF FLASHING PURPOSES. ALL EQUIPMENT SHALL HAVE A MINIMUM OF 16" CLEAR FROM ALL ADJACENT PARAPETS. ALL HVAC MOUNTED EQUIPMENT (DISCONNECT BOXES, GFCI, PIPE SUPPORTS) SHALL NOT BE CLOSER THAN 16" FROM EACH OTHER OR CURB. NO UNISTRUT PIPE SUPPORTS SHALL BE USED AS VERTICAL MEMBERS FOR MOUNTING EQUIPMENT TO ROOF SURFACE.
- 6. PONDING WATER IS DEFINED AS WATER THAT DOES NOT DRAIN OR DISSIPATE FROM THE ROOF WITHIN 48 HOURS AFTER PRECIPITATION.
- 7. ALL FLASHING CEMENTS, DURO-LAST MEMBRANE, PRODUCTS AND ACCESSORIES SHALL BE APPROVED BY ROOFING MANUFACTURER WITH THE MANUFACTURES'S BRAND. ALL ROOFING PRODUCTS SHALL BE AMERICAN MANUFACTURED PRODUCTS.

# ○ SHEET KEYNOTES

- 1. FULLY ADHERED DURO-LAST PVC ROOF MEMBRANE. NEW MEMBRANE TO LAP OVER EXISTING, PER MANUFACTURE REQUIREMENTS.
- 2. ROOF ACCESS SCUTTLE TO BE REMOVED, RAISE AND REINSTALLED WITH INSTALLATION OF NEW INSULATION AND ROOF SYSTEM. GENERAL CONTRACTOR TO VERIFY CONDITION OF EXISTING SCUTTLE AND REPAIR FINISH AS NECESSARY.
- 3. PREFABRICATED METAL CANOPY. REFERENCE SHEETS A304.
- 4. EXISTING VENT THROUGH ROOF, PROVIDE PREFABRICATED DURO-LAST VENT FLASHING FOR ALL VENTS AND PIPE PENETRATIONS. REFERENCE DETAIL #6, THIS SHEET.
- 5. INSTALL DURO-LAST PVC ROOF MEMBRANE SACRIFICE SHEET AS SPECIFIED KITCHEN EXHAUST.
- 6. ROOF CRICKET WITH SLOPE TO MATCH ROOF, REFER TO DETAIL #3, THIS SHEET.
- 7. OVERFLOW ROOF SCUPPERS REFER TO DETAIL #7 THIS SHEET.
- 8. ROOFTOP AIR CONDITIONING UNIT REFER TO MECHANICAL PLANS.
- 9. EXHAUST FAN REFER TO MECHANICAL PLANS.
- 10. ILLUMINATED PARAPET LIGHT BAND MP-1.
- 11. RAISED PARAPET WALL WITH NEW PRE FINISHED METAL COPING.
- 12. PVC CONDENSATE DRAIN (SIZE AS SHOWN) WITH PIPE SUPPORTS EVERY 5'-0". TERMINATE CONDENSATE DRAIN AT PRIMARY SCUPPER. REFER TO DETAIL #8, THIS SHEET FOR ADDITIONAL INFORMATION.
- 13. PROVIDE NEW PITCH PAN WITH CONDUIT OVER OFFICE FOR EXISTING SATELLITE DISH/ANTENNA TO BE REMOVED AND REINSTALLED.
- 14. EQUIPMENT STAND FOR WALK-IN BOX COOLER/FREEZER CONDENSERS AND ICE MACHINE CONDENSER. REFER TO EQUIPMENT STAND DETAIL, THIS SHEET.
- 15. NOT USED.
- 16. EXISTING ROOF DRAINS. MODIFY AND EXTEND RAIN WATER LEADER, AS REQUIRED FOR NEW ROOFING SYSTEM AND THICKER INSULATION REFER TO DETAIL #4 THIS SHEET.
- 17. REINSTALL EXISTING SIGNAGE. SIGNAGE TO BE REINSTALLED DURING CONSTRUCTION PHASE.
- 18. NEW SIGNAGE TO BE INSTALLED
- 19. EXISTING EXHAUST FAN ON MODIFY EXISTING CURBS AND OPENING. COORDINATE WITH LOCATION OF FRYER AND BROILER BELOW. CONNECT EXISTING FRYER AND BROILER HOOD WITH ASSOCIATED DUCTWORK.
- 20. CRIPPLE ONTO OTHER SHEATHING AND RAFTERS/KICKERS.
- 21. EXISTING SEALED ROOF VENT TO REMAIN.
- 22. REINSTALL SALVAGED CANOPY. CANOPY TO BE REINSTALLED DURING CONSTRUCTION PHASE.
- 23. WALL MOUNTED METAL VENT REMOVED, PROVIDE BLOCKING AND PLYWOOD SUBSTRATE FLUSH WITH ADJACENT PARAPET WALL. PATCH AND REPAIR WITH ADJACENT ROOF WITH COMPATIBLE DURO-LAST ROOF MEMBRANE
- 24. EXISTING ABANDONED ROOF TOP EQUIPMENT TO REMAIN

CAUTION:

IF THIS DRAWING IS A REDUCTION,

USE THE GRAPHIC SCALES.

0 3" 6" 12"

3"=1'-0"

SCALE: AS NOTED

DATE: 05/25/2021

PROJECT: 2018.0375.04.0

DRAWING:

JMM

SCB

hereby certify that these documents were

prepared or approved by me, and that I am a

icense # 6140 Expiration Date: 08/21/202

BURGER

NEW

DESIGNED:

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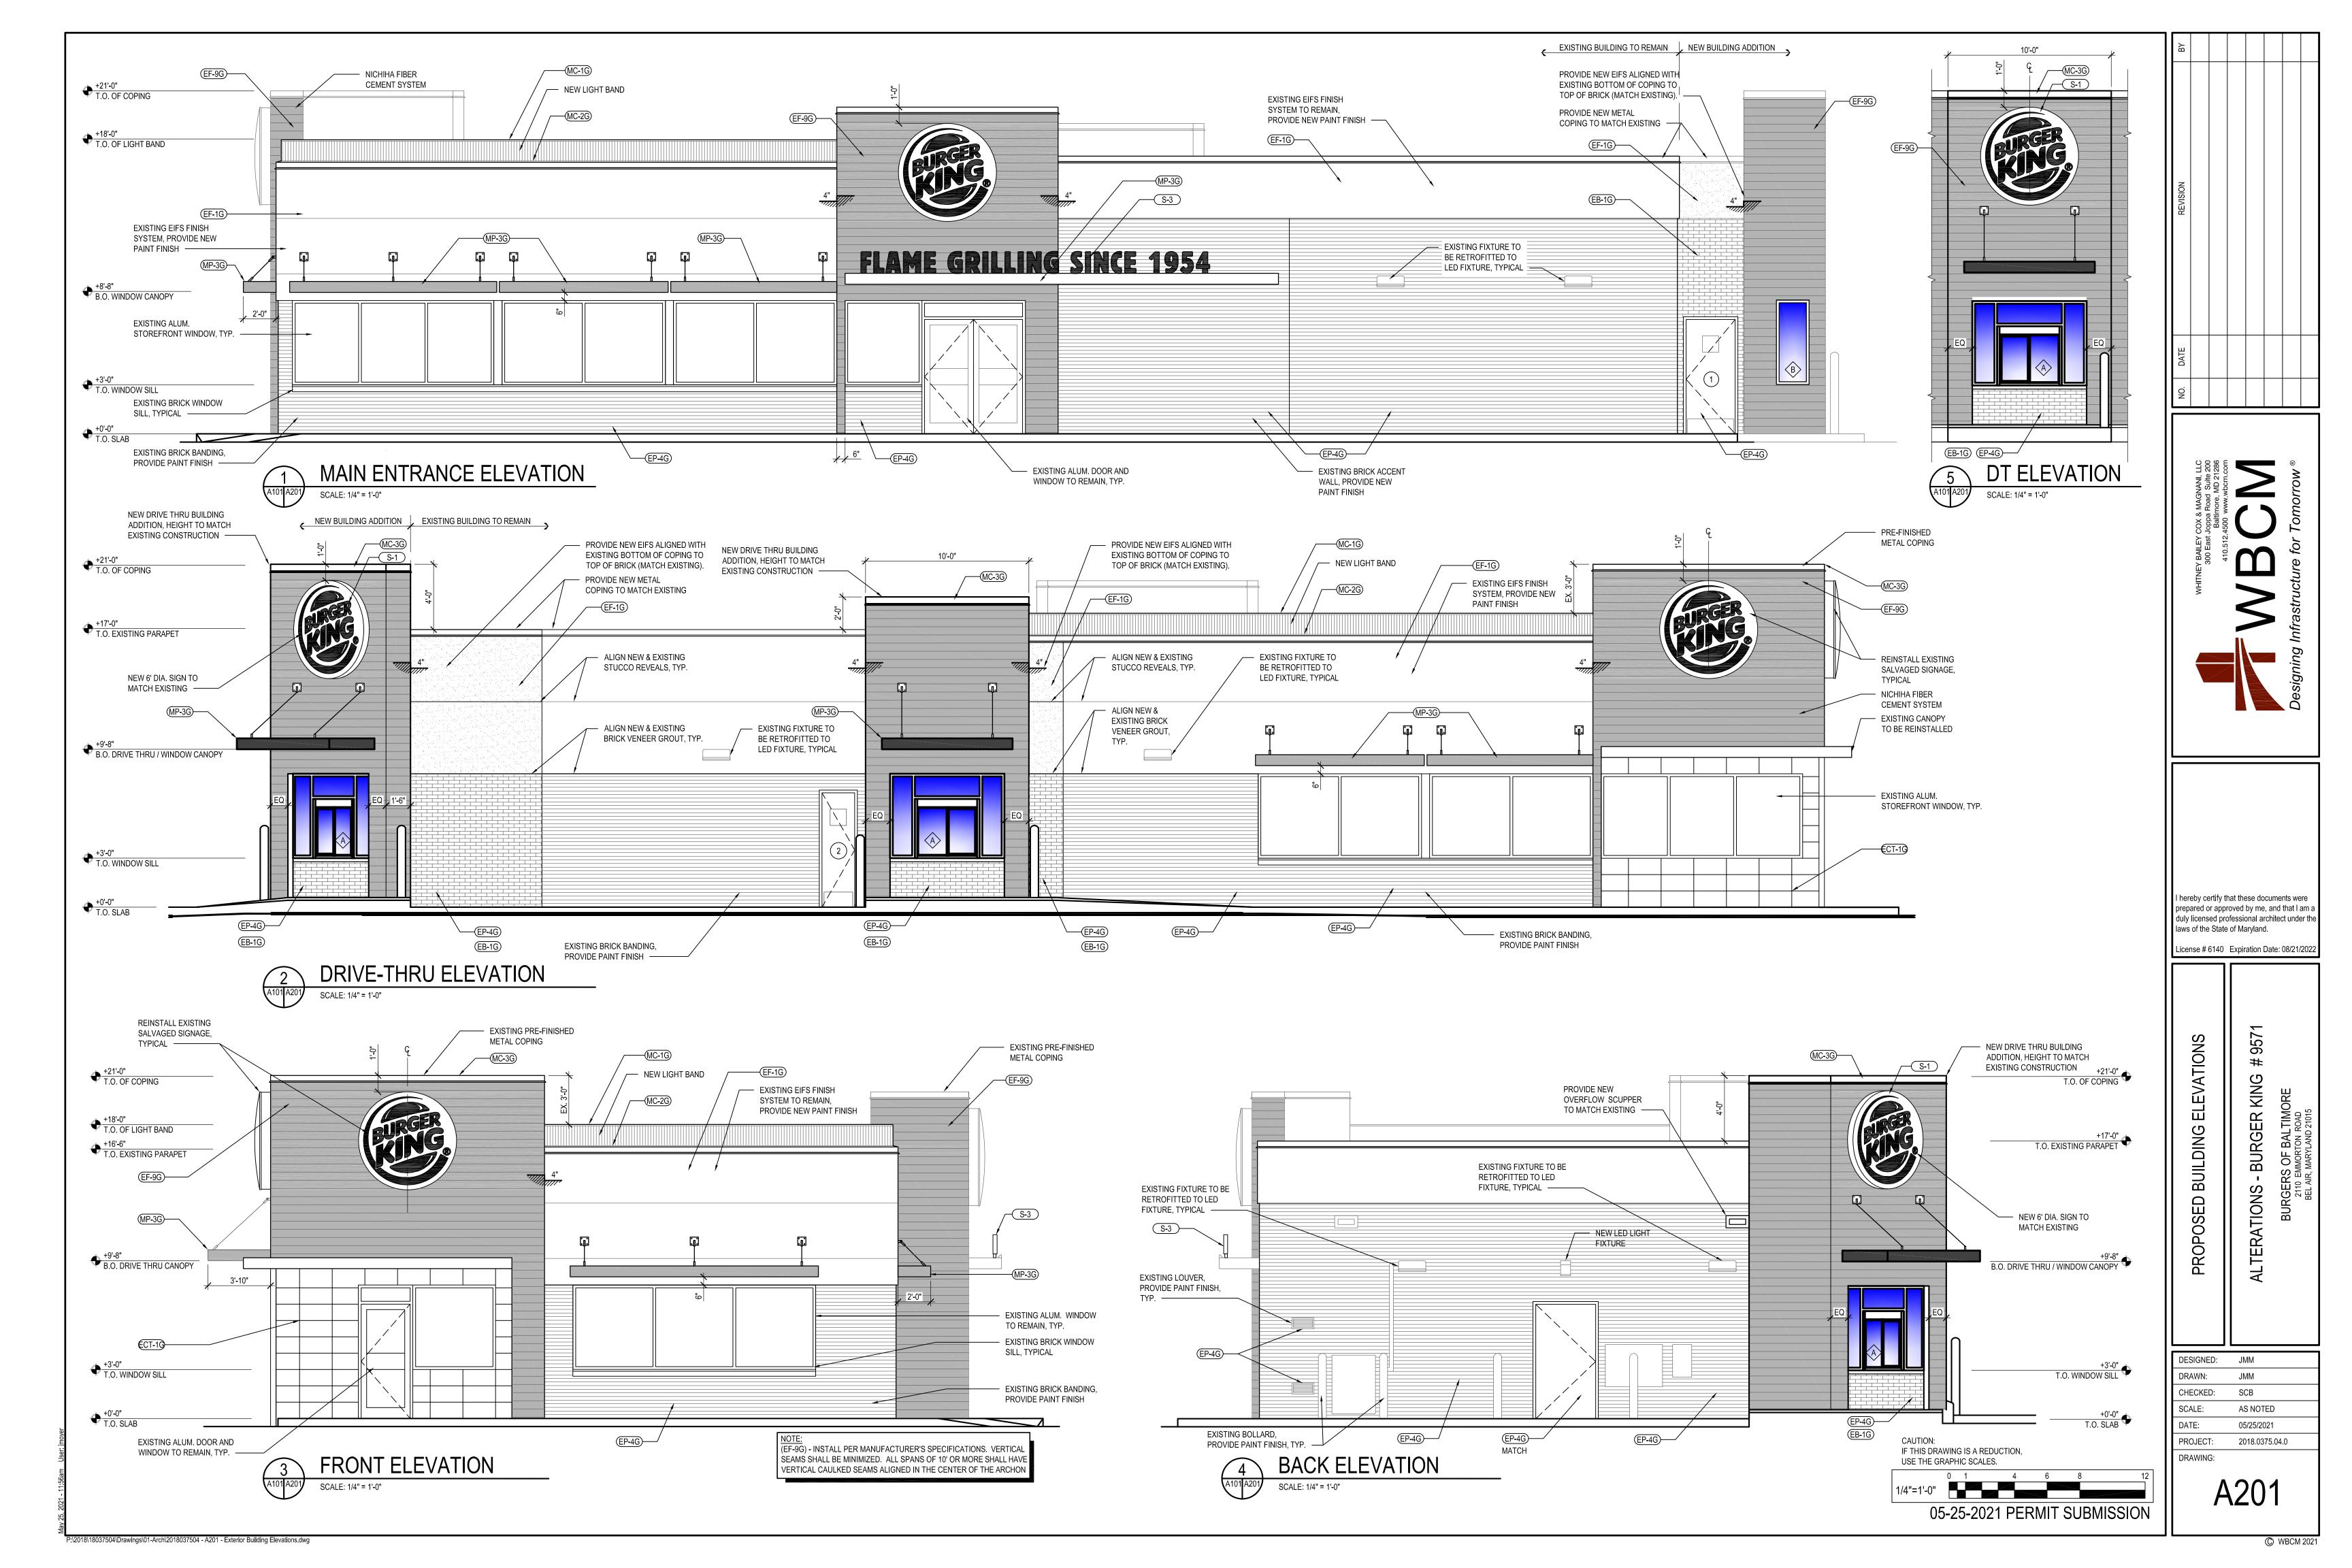
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laws of the State of Maryland.

duly licensed professional architect under the


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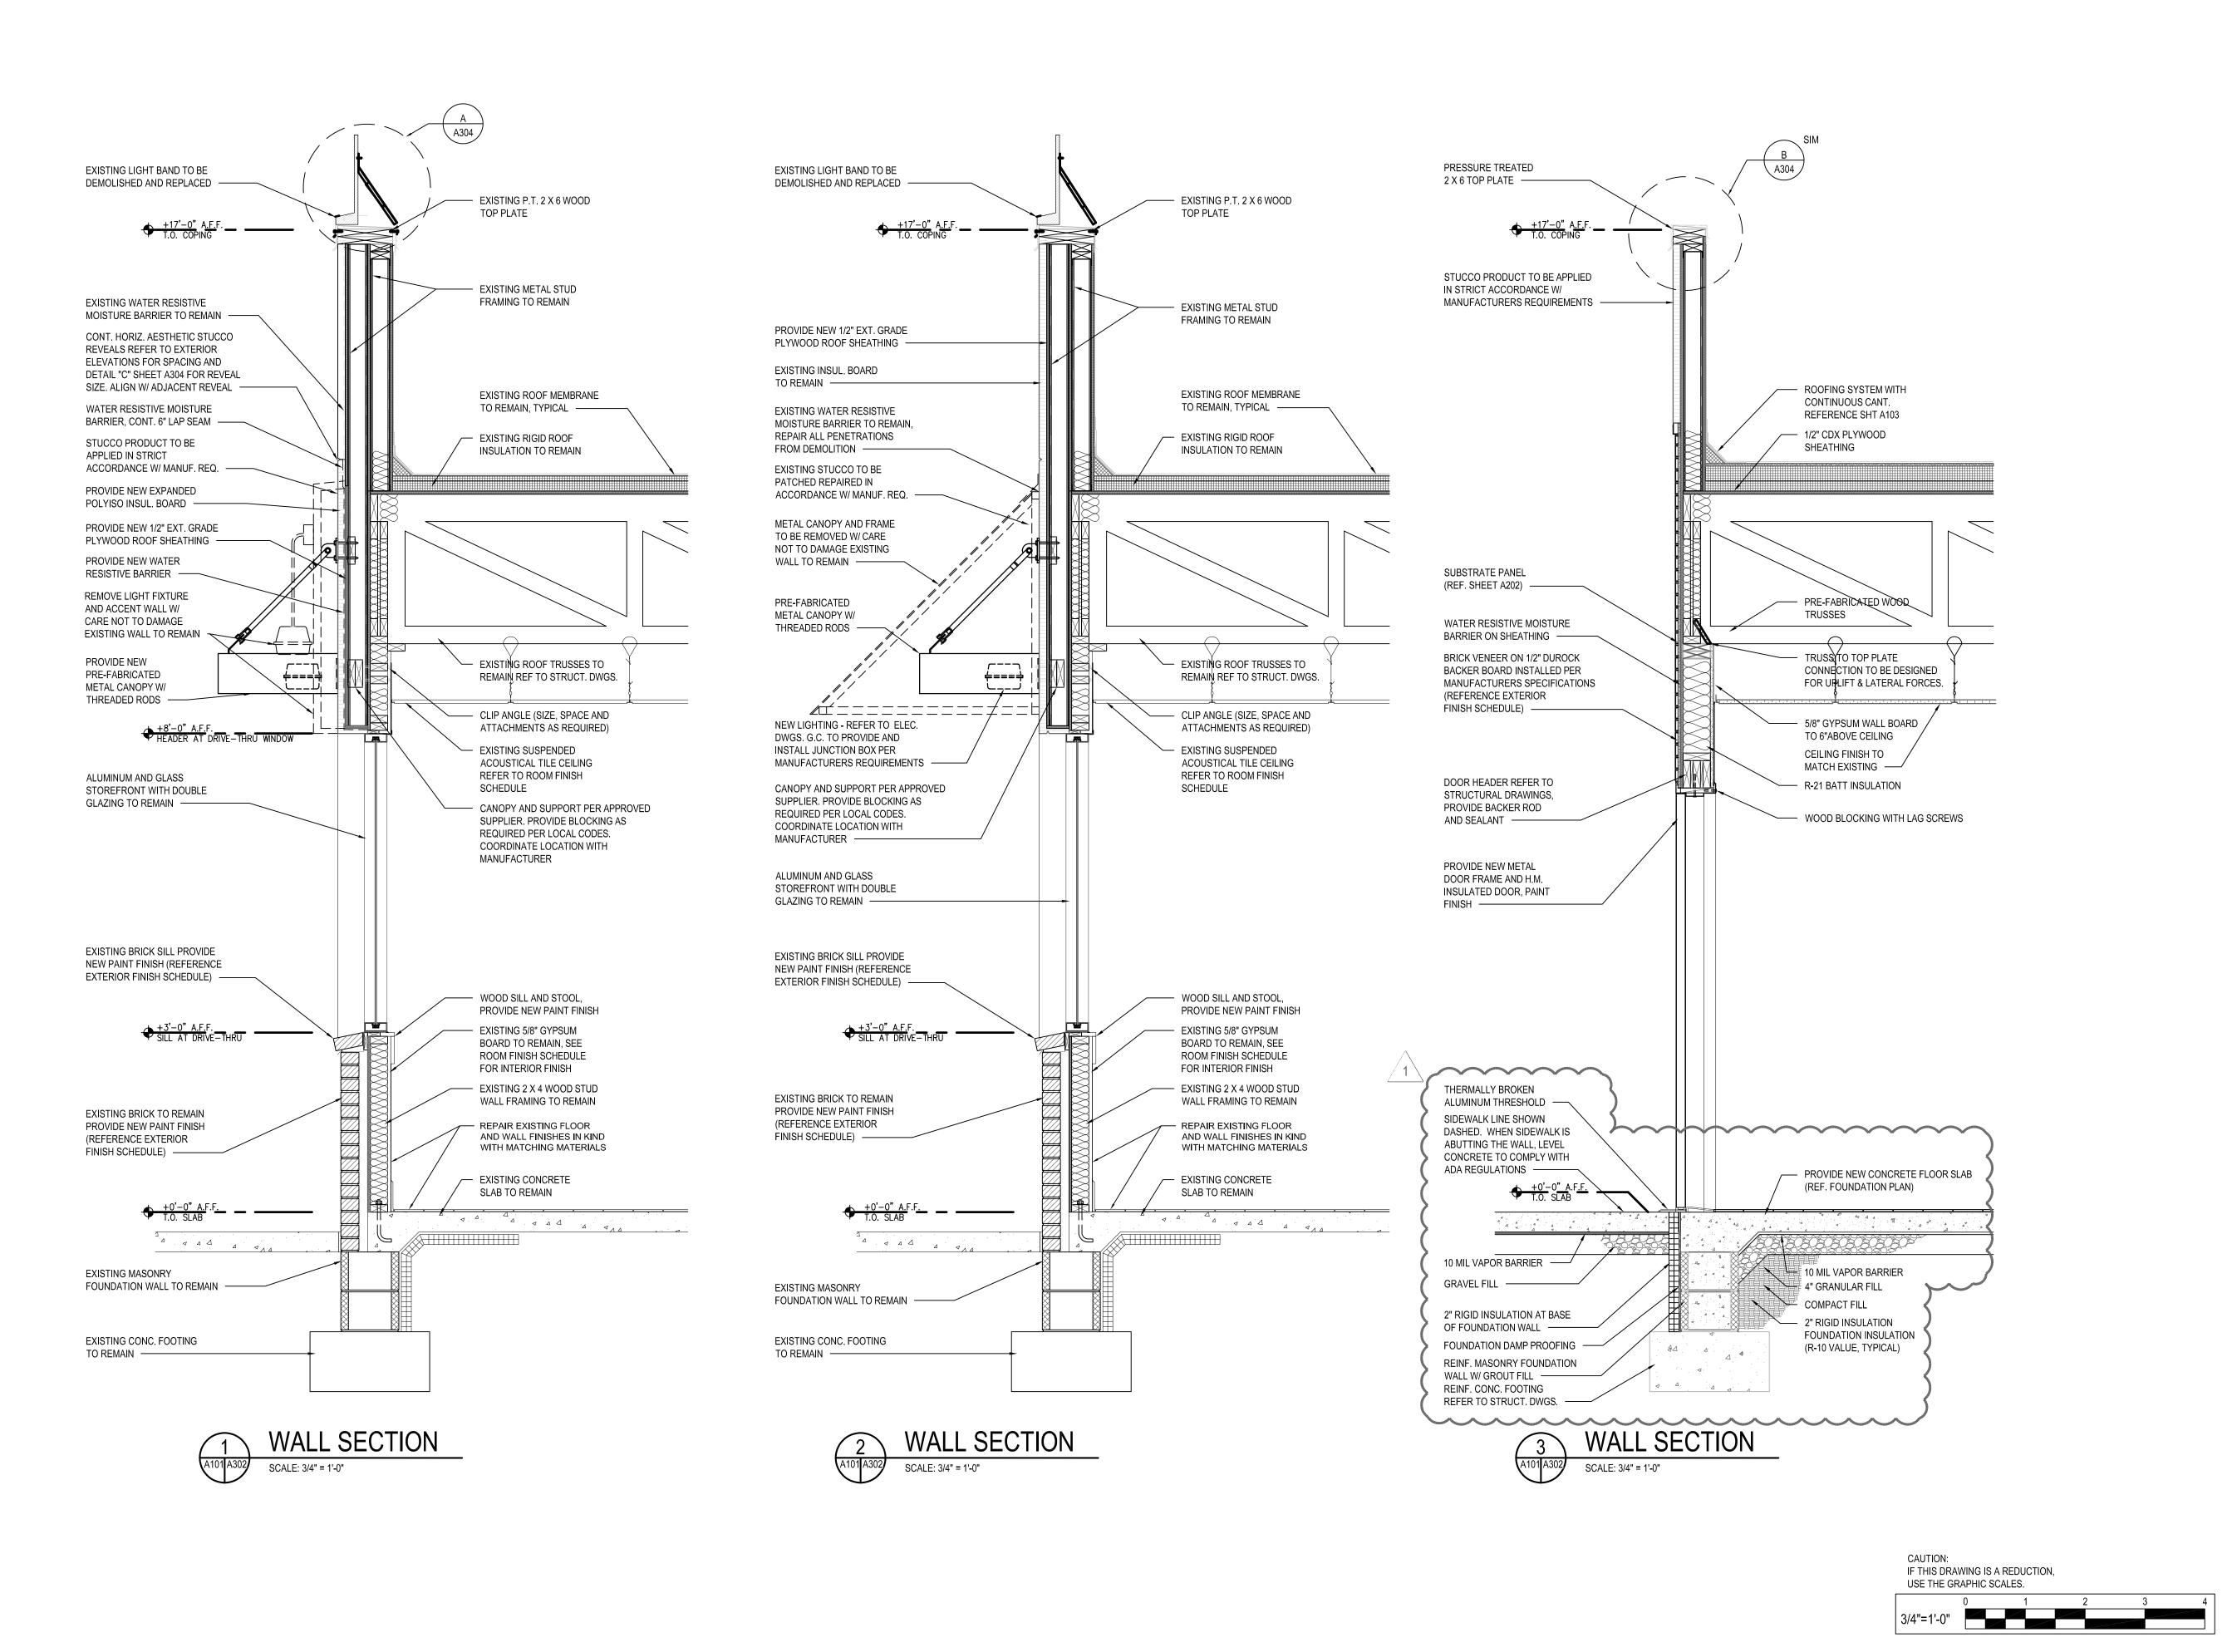
**2** 14/2014



				BURGER KING - 20/20 GAF	RDEN GRILL EXTERIOR		
8/07/19				EXTERIOR MATERIALS & FINISH SCHEDULE	(not all specs are used on every project)		
CODE	MATERIAL	LOCATION	MANUFACTURER		DESCRIPTION		ADDITIONAL INFORMATION
				PRODUCT	COLOR	DIMENSION	CONTACT: GABE POWERS (502) 558-4612
			EVOLUTION BRICK	MOD / QS TUMBLED (FULL BRICK)  (THIN BRICK)	OLDE HILLSBORO SIERRA TUMBLED		NOTE: USE WITH EGR-3G
EB-1G	EXTERIOR BRICK	GENERAL	PINE HALL BRICK	FACE BRICK	OLD IRVINGTON O/S		CONTACT: THERESA BEANE (800) 334-8689 - tbeane@pinehallbrick.com
			FINE HALL BRICK		OLD INVINGTON 0/3		NOTE: USE WITH EGR-3G  CONTACT: ERIN LYNCH (916) 206-7831
			H.C. MUDDOX BRICK	THIN BRICK	BK WEST COAST BLEND		NOTE: USE WITH EGR-3G
					"RED NATURAL"		CONTACT: JOY DETER AT EUROWEST (714) 309-9551  OR JOY KLEIN (813) 334-3302
ECT-1G	EXTERIOR CERAMIC TILE	ACCENT AT BUILDING FRONT	GRANITI GIANDRE / EUROWEST	SENSIBLE STONE ED5052	STACKED BOND PATTERN	12" X 24"	jklein@transamerica.com
				STO POWERWALL STUCCO SYSTEM	COLOR TO MATCH EP-2G		NOTE: USE WITH EGR-4G  CONTACT: TIM SALERNO AT STO CORP (407) 466-5371
			STO OR APPROVED EQUAL	TEXTURE: FINE SAND	PPG "DESERT DUNE"		
EF-1G	EXTERIOR FINISH - STUCCO, STO, FIBER CEMENT SIDING	GENERAL		OR STO THERM CI EIFS SYSTEM			CONTACT NICHIHA CUSTOMER SERVICE (770) 805-9466
	PANELS		NICHIHA FIBER CEMENT	NICHIHA TUFFBLOCK	PREPAINTED TO MATCH EP-2G - PPG "DESERT DUNE" STACKED BOND PATTERN	18" X 6'	BK@NICHIHA.COM  INSTALL PER MANUFACTURER'S SPECIFICATIONS
					STAGRED BOTTO TATLERIA		VERTICAL APPLICATIONS ONLY (NOT FOR USE ON SOFFITS)
EF-4G	EXTERIOR FINISH STUCCO	GENERAL	STO OR APPROVED EQUAL	STO POWERWALL STUCCO SYSTEM	COLOR TO MATCH EP-4G		CONTACT: TIM SALERNO AT STO CORP (407) 466-5371
					PPG "GRANITE"		CONTACT NICHIHA CUSTOMER SERVICE (770) 805-9466
EF-9G	EXTERIOR FINISH FIBER CEMENT						BK@NICHIHA.COM
							INSTALL PER MANUFACTURER'S SPECIFICATIONS. VERTICAL SEAMS SHALL BE MINIMIZED. ALL SPANS OF 10' OR MORE SHALL
			NICHIHA FIBER CEMENT	VINTAGE WOOD EF762	"CEDAR"	18" X 10'	HAVE VERTICAL SEAMS ALIGNED IN THE CENTER OF THE ARCHON.
TR-1G	ALUMINUM TRIMS	EXTERIOR SIGN ARCHONS					SEAMS TO BE CAULKED WITH EC-1G OR USE "H-MOLD"  FACTORY TRIMS. ALL TRIMS SHALL BE FACTORY PAINTED
							TO MATCH PANELS.  VERTICAL APPLICATIONS ONLY (NOT FOR USE ON SOFFITS)
							CONTACT: MATT KLINGE AT ADFAST (314) 753-0964
EC-1G	EXTERIOR CAULK		ADSEAL PRODUCTS	ADSEAL 458-63	"VINTAGE WOOD CEDAR"		matt.klinge@adfastcorp.com
	EVTERIOR RAINT	EVITEDIOD CENTERAL		PRIMER: 17-921	"DESERT DUNE" 1023-4, former "TANNERS TAUPE"		NOTE: USE WITH EF-9G  CONTACT: KEVIN LASTACY @ PPG
EP-2G	EXTERIOR PAINT	EXTERIOR GENERAL		PAINT: 6-2045XI	PPG1023-4		Corporate National Accounts Manager
EP-4G	EXTERIOR PAINT	EXTERIOR WAINSCOT	_	PRIMER: 17-921 PAINT: 6-2045XI	"GRANITE" 1022-6 , former "MONTERREY CLIFFS"  10YY 14/080		(616) 335-3259 klastacy@ppg.com
ED CC	EVTERIOR DAINT	LOGO SIGN CABINETS & BURGER	_	PRIMER: 6-212	"STEPPING STONE" 1010-4 , former "BURGER KING SILVER"		NOTE: FOR REMODELS ONLY
EP-6G	EXTERIOR PAINT	KING CHANNEL LETTER CABINETS	_	PAINT: 6-230	Custom Formula		NOT FOR USE ON ROOFS.  SEE EP-6AG & EP-6BG
EP-6AG	EXTERIOR PAINT	EXISTING MANSARD ROOFS, SHINGLES & BARREL TILE	DDG .	PRIMER: 17-921	"DOVER GRAY" 1001-1 , former "GRYMMYS GREY"		NOTE: BY EXCEPTION FOR REMODELS ONLY
	EVERTOR PATRIC	EXISTING STANDING SEAM	PPG	PAINT: 90-1110 PRIMER: 90-712	00NN 20/000  "GRAY STONE" 1009-4 , former "MARCH WIND"		NOTE: BY EXCEPTION FOR REMODELS ONLY
EP-6BG	EXTERIOR PAINT	METAL ROOF		PAINT: 90-1110	Custom Formula		
EP-8BG	EXTERIOR PAINT	METAL COPING AT ARCHON TOWERS	-	PRIMER: 17-921 PAINT: 6-2045XI	"CARAVEL BROWN" 1079-6 , former "CEDAR"  Custom Formula		
EXT-1G	EXTERIOR PAINT	POLES & POLE SIGN		PRIMER: 90-712	"BLACK"		
FVT 20	EVTERIOR RAINT	GIONO	_	PAINT: 90-353 PRIMER: 90-712	Tint to match		
EXT-2G	EXTERIOR PAINT	SIGNS		PAINT: 90-375	PPG 1006-6 "DECONSTRUCTION"		Courte sty CLENN DEMLED ADCUST COURT ACCOUNT EVECUTIVE
			_	PRIMER:  Loxon Concrete & Masonry A24W300	"TAUPE TONE"  SW 7633		Contact: GLENN REMLER, ARCHITECTURAL ACCOUNT EXECUTIVE
EP-2G	EXTERIOR PAINT	EXTERIOR GENERAL		PAINT:			phone: (954) 547-1217
			_	Superpaint Ext Satin A89 Series Satin			email: Glenn.J.Remler@Sherwin.com
				PRIMER: Loxon Concrete & Masonry A24W300	"HOMESTEAD BROWN"		
EP-4G	EXTERIOR PAINT	EXTERIOR WAINSCOT		PAINT:	SW 7515		
				Superpaint Ext Satin A89 Series Satin			
				PRIMER:	FACTORY FINISH SILVER		NOTE: FOR REMODELS ONLY
EP-6G	EXTERIOR PAINT	LOGO SIGN CABINETS & BURGER KING CHANNEL LETTER CABINETS		Kem Bond HS B50A28  PAINT:			NOT FOR USE ON ROOFS.
				Silver Brite B59S11			NOT TOK USE ON ROOTS!
			SHERWIN-WILLIAMS	PRIMER: Pro Industrial Pro-Cryl Primer B66-310	"CEDAR"  Custom Formula		
EP-8G	EXTERIOR PAINT	METAL COPING AT ARCHON TOWERS		PAINT:	Custom Formula		
			_	Pro Industrial High Performance Acrylic B66-650 Semi-Gloss			
				PRIMER:	FACTORY FINISH BLACK		
EXT-1G	EXTERIOR PAINT	POLES & POLE SIGN	_	Pro Industrial Pro-Cryl Primer B66-310  PAINT:			
באו וט	EXTERIOR FAINT	TOLES & TOLE STOW		Pro Industrial High Performance Acrylic B66-600			
			_	Gloss PRIMER:	FACTORY FINISH TO MATCH		
				Pro Industrial Pro-Cryl Primer B66-310	SW 6075 "GARRET GRAY"		
EXT-2G	EXTERIOR PAINT	SIGNS	_	PAINT: Pro Industrial High Performance Acrylic B66-600			
				Gloss			NOTE: HOE WITH ED 40
EGR-3G	GROUT	BRICK	MAPEI		#5 "CHAMOIS"		NOTE: USE WITH EB-1G
							NOTE: USE WITH ECT-1G
EGR-4G	GROUT	CERAMIC TILE	CUSTOM BUILDING PRODUCTS	POLYBLEND SANDED	#335 "WINTER GRAY"		*** FOR SETTING MATERIALS USE COMPLETE CONTACT RAPID SET  *** SEAL GROUT WITH AQUAMIX SEALERS CHOICE GOLD
							CONTACT, W. D. LITCKMAN, COMPANY, (020) CTC, 1700, MINNW, MIDLL COM
MC-1G	METAL COPING	TOP OF LIGHT BAND		PERMA SNAP PLUS	A-30 "SILVERSMITH"		CONTACT: W.P. HICKMAN COMPANY (828)676-1700 - WWW.WPH.COM
		WALL CAP					
MC-2G	METAL COPING	BELOW LIGHT BAND	W.P. HICKMAN SYSTEMS, INC.	PERMA SNAP PLUS	FACTORY FINISH TO MATCH EP-2G  PPG "TANNERS TAUPE"		
	-	-					
MC-3G	METAL COPING	TOP OF ARCHON		PERMA SNAP PLUS	TO BE PAINTED TO MATCH EP-8G  PPG "CEDAR"		
							PRODUCT WIFECOM - TO COMPANY -
			LEKTRON	. <b></b>			PRODUCT INFORMATION: KEVIN RUBOTTOM AT LEKTRON (800) 634-4059 OR (918) 622-4978
		PARAPET LIGHT BAND	*SEE APPROVED SIGN SUPPLIERS	LED LIGHT BAND		*SEE PLANS	Email: KRubottom@lektroninc.com
MP-1G			SEE AFFROVED SIGN SOFFEIERS				Email: Kikabaccamalektromine.com
MP-1G		ABOVE DOORS	*SEE APPROVED				Email: Kikabaccamateka amire.com


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EXTERIOR FINISH SCHEDULE  EXTERIOR FINISH SCHEDULE  WHTTNEY BALLEY COX & MAGNANI, LLC 300 East Joppa Road Suite 200 Baltimore, MD 21286 410.512.4500 www.wben.com LTERATIONS - BURGERS OF BALTIMORE 2110 EMMORTON ROAD BELARK, MARYLAND 21015  Designing Infrastructure for Tomorrow®  BELARK, MARYLAND 21015	EXTERIOR FINISH SCHEDULE    No.   State   Stat
EXTERIOR FINISH SCHEDULE  LTERATIONS - BURGERS OF BALTIMORE  BURGERS OF BALTIMORE  2110 EMMORTON ROAD BEL AIR, MARYLAND 21015	EXTERIOR FINISH SCHEDULE  I hereby certify that these documents were prepared or approved by me, and that I am a duly licensed professional architect under the laws of the State of Maryland.  License # 6140 Expiration Date: 08/21/2022  BURGERS OF BALTIMORE  2110 EMMORTON ROAD  SCHOOL SCHOOL BELLING # 9571  Designing Infrastructure  Designing Infrastructure  Designing Infrastructure
EXTERIOR FINISH SCHEDULE  LICENSE # 6140 Expiration Date: 08/21/2022  BURGERS OF BALTIMORE  2110 EMMORTON ROAD BELAIR, MARYLAND 21015 BELAIR, MARYLAND 21015	Prepared or approved by me, and that I am a duly licensed professional architect under the laws of the State of Maryland.  License # 6140 Expiration Date: 08/21/2022   PESIGNED: JMM  DRAWN: JMM  CHECKED: SCB  SCALE: AS NOTED  DATE: 05/25/2021
EXTERIOR FINISH SCHEDU LTERATIONS - BURGER KING 2110 EMMORTON ROAD BEL AIR, MARYLAND 21015	EXTERIOR FINISH SCHEDU WART INDER SCHEDU WART INDER SCHED WART INDER SCHEDU SCH
	DRAWN: JMM  CHECKED: SCB  SCALE: AS NOTED  DATE: 05/25/2021



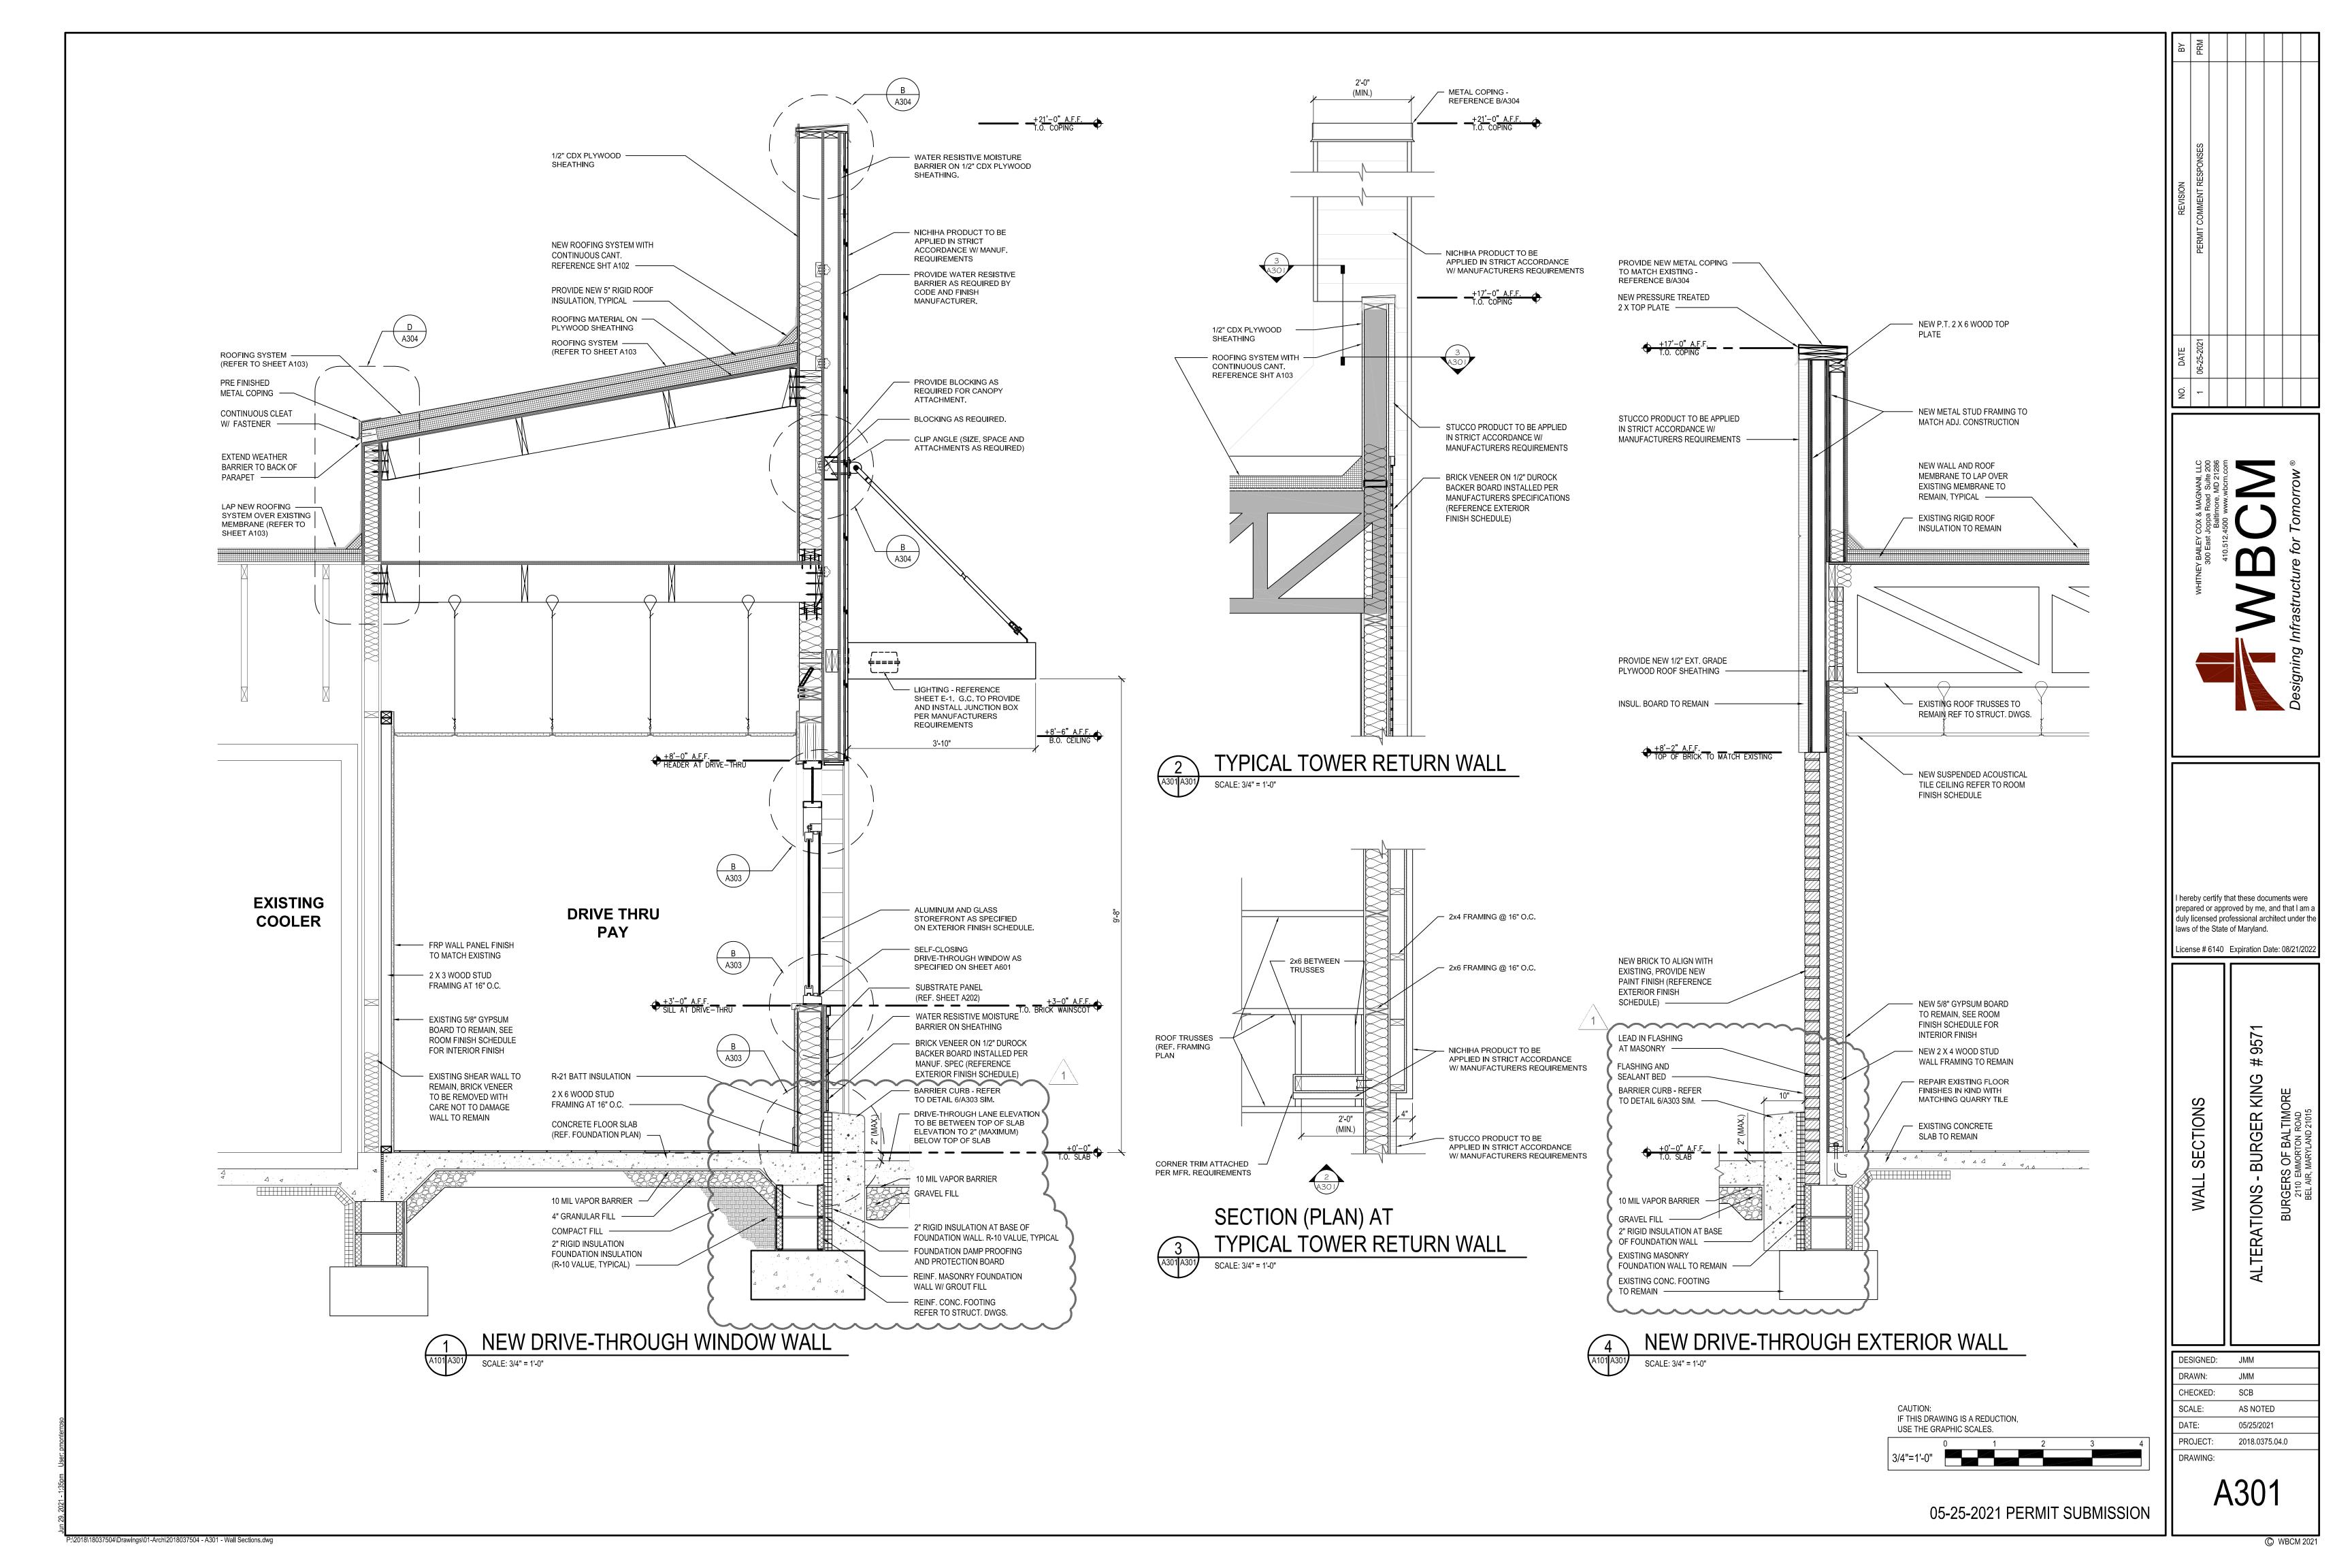

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I hereby certify that these documents were prepared or approved by me, and that I am a duly licensed professional architect under the laws of the State of Maryland. License # 6140 Expiration Date: 08/21/2022 BURGER RATIONS DESIGNED: JMM DRAWN: JMM CHECKED: SCB SCALE: AS NOTED 05/25/2021 PROJECT: 2018.0375.04.0 DRAWING: A302

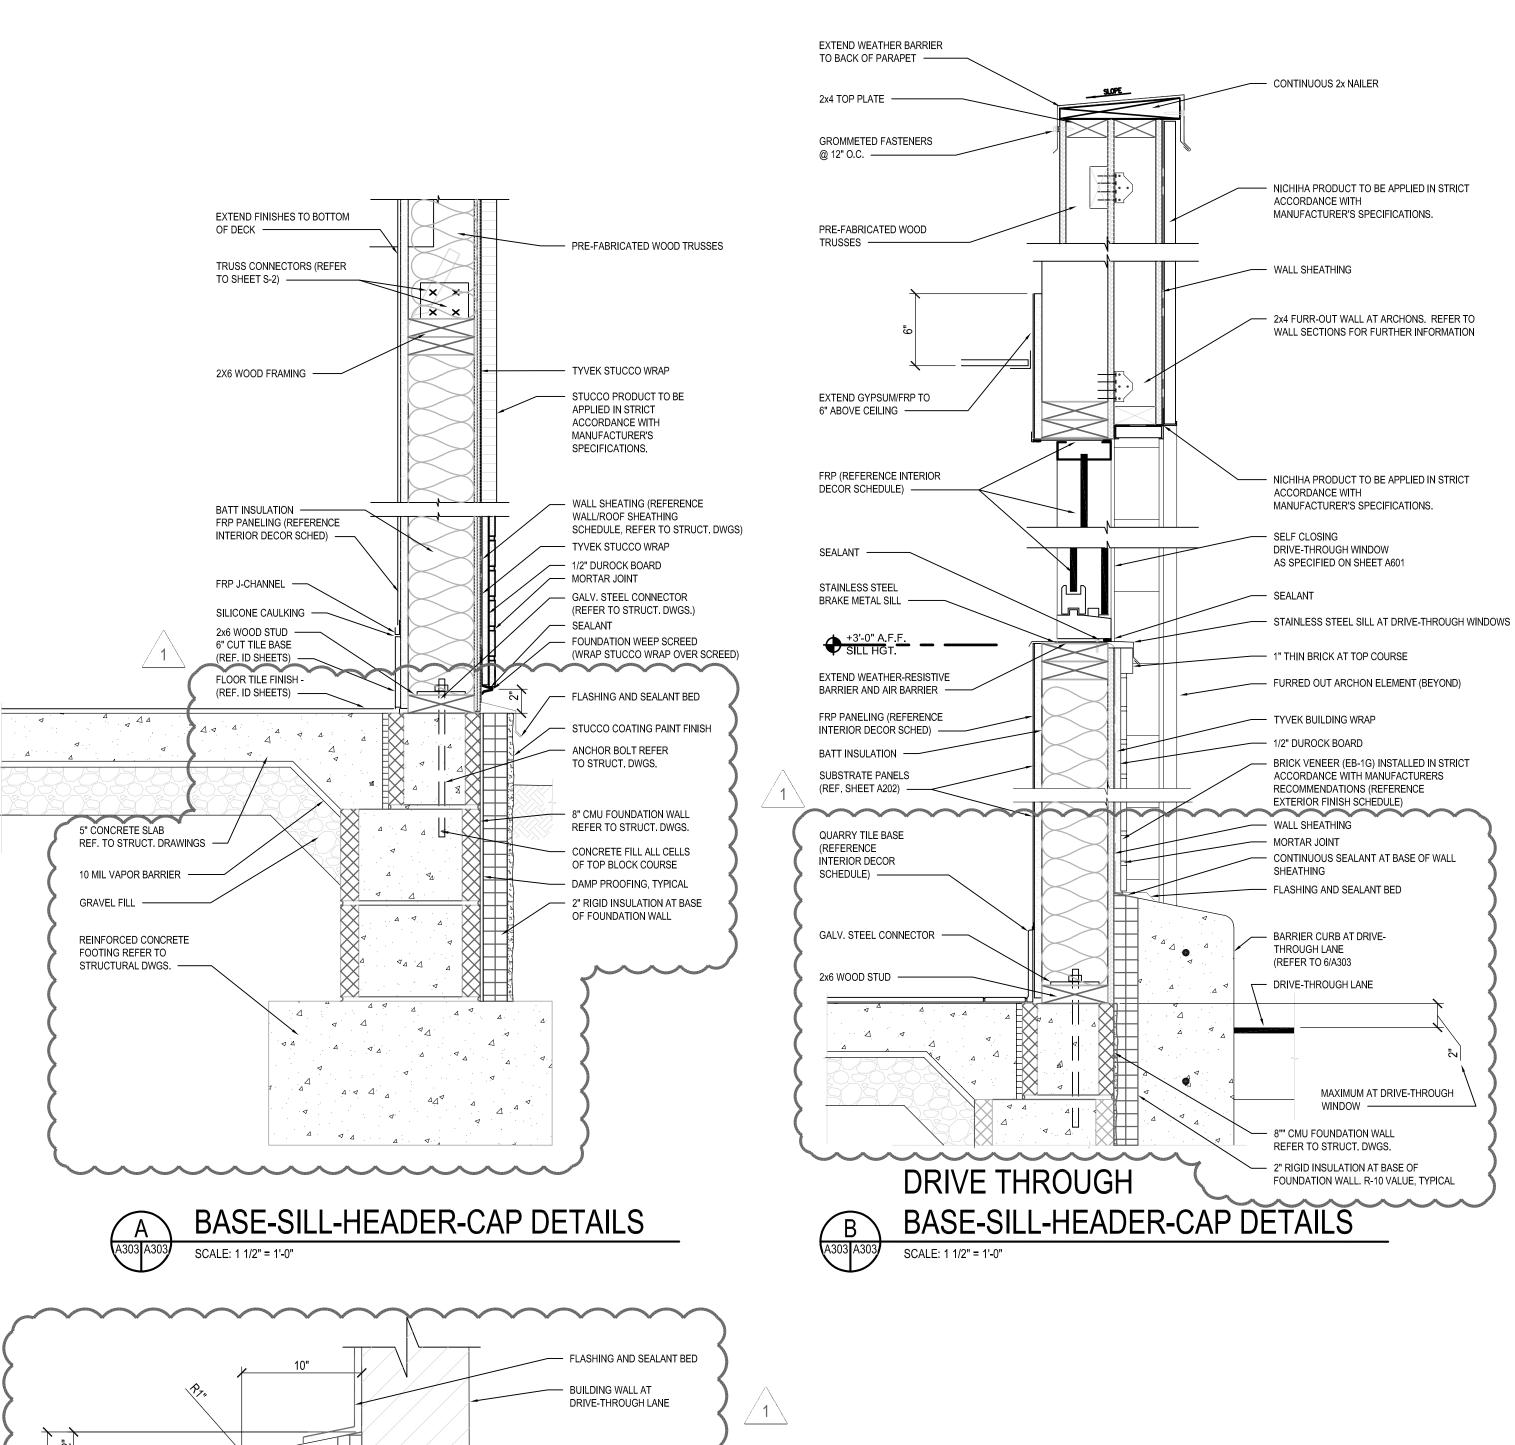



2 - #4's CONTINUOUS

2" RIGID INSULATION AT BASE OF FOUNDATION WALL


6" THICK CONCRETE SLAB @ DRIVE-THROUGH

— FINISH FLOOR

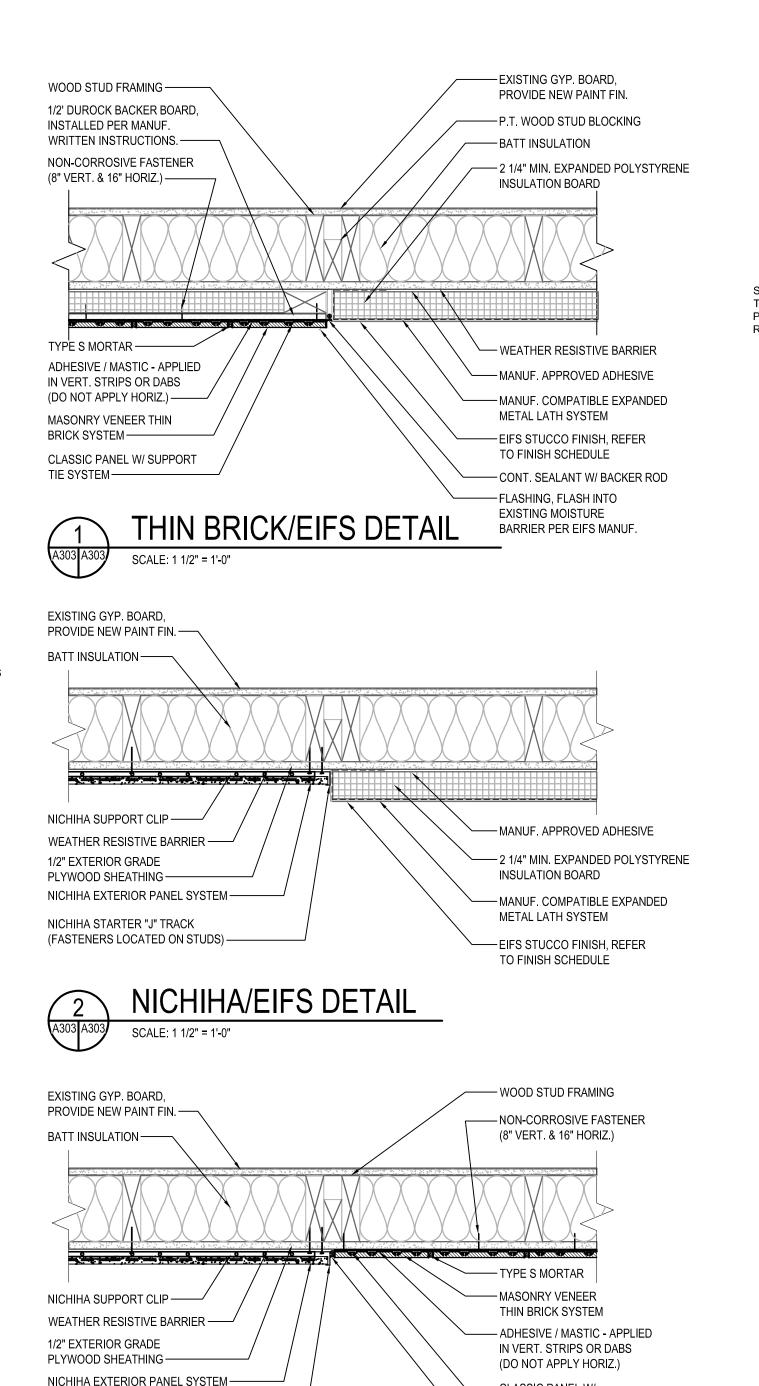


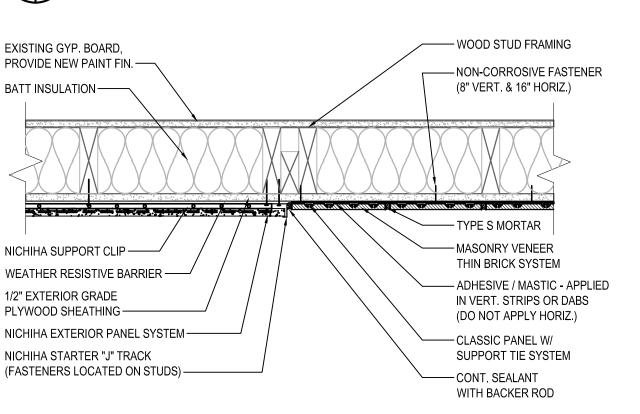




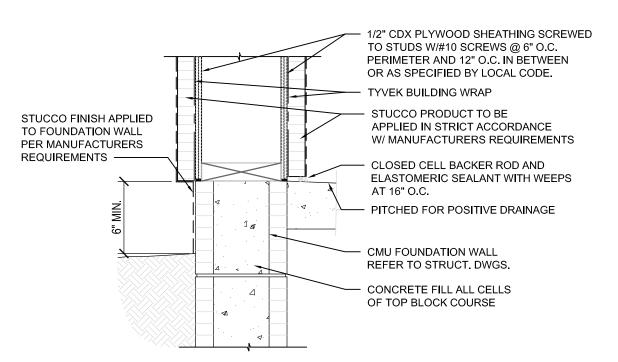



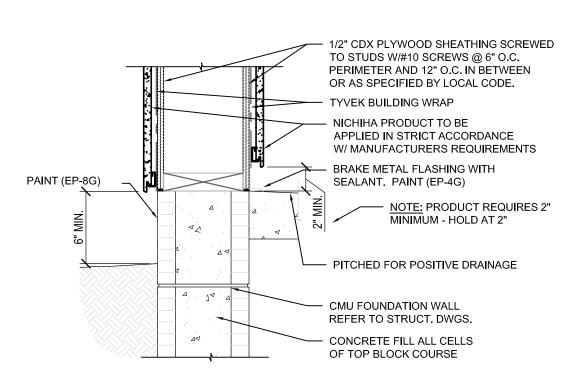



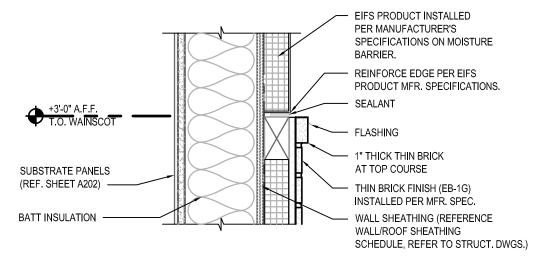



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05-25-2021 PERMIT SUBMISSION

DESIGNED: DRAWN: JMM CHECKED: SCB SCALE: AS NOTED 05/25/2021 PROJECT: 2018.0375.04.0 DRAWING: A303

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prepared or approved by me, and that I am

laws of the State of Maryland.

SECTIONS

WALL

duly licensed professional architect under the

License # 6140 Expiration Date: 08/21/2023

- BURGER

TERATIONS


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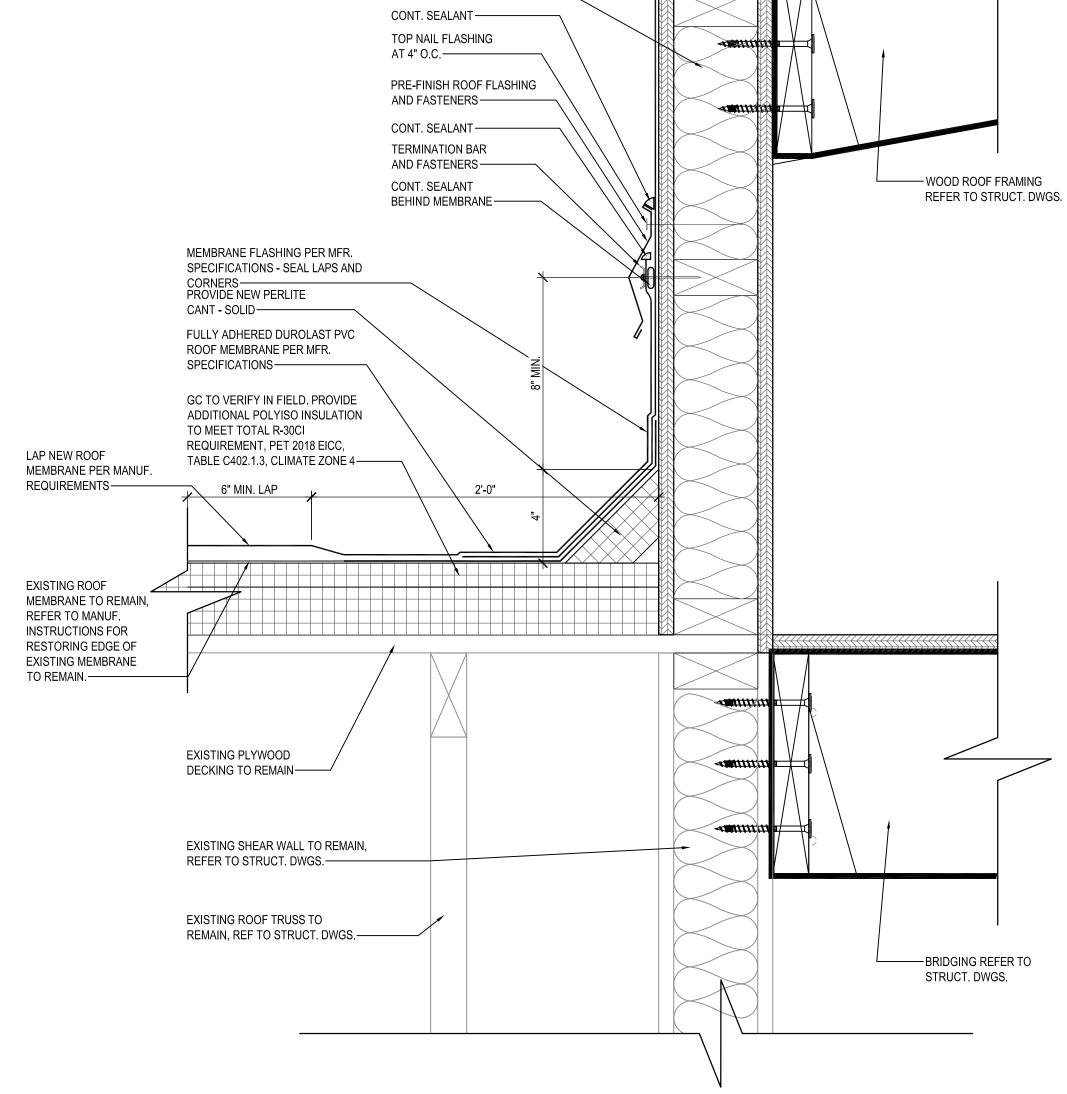
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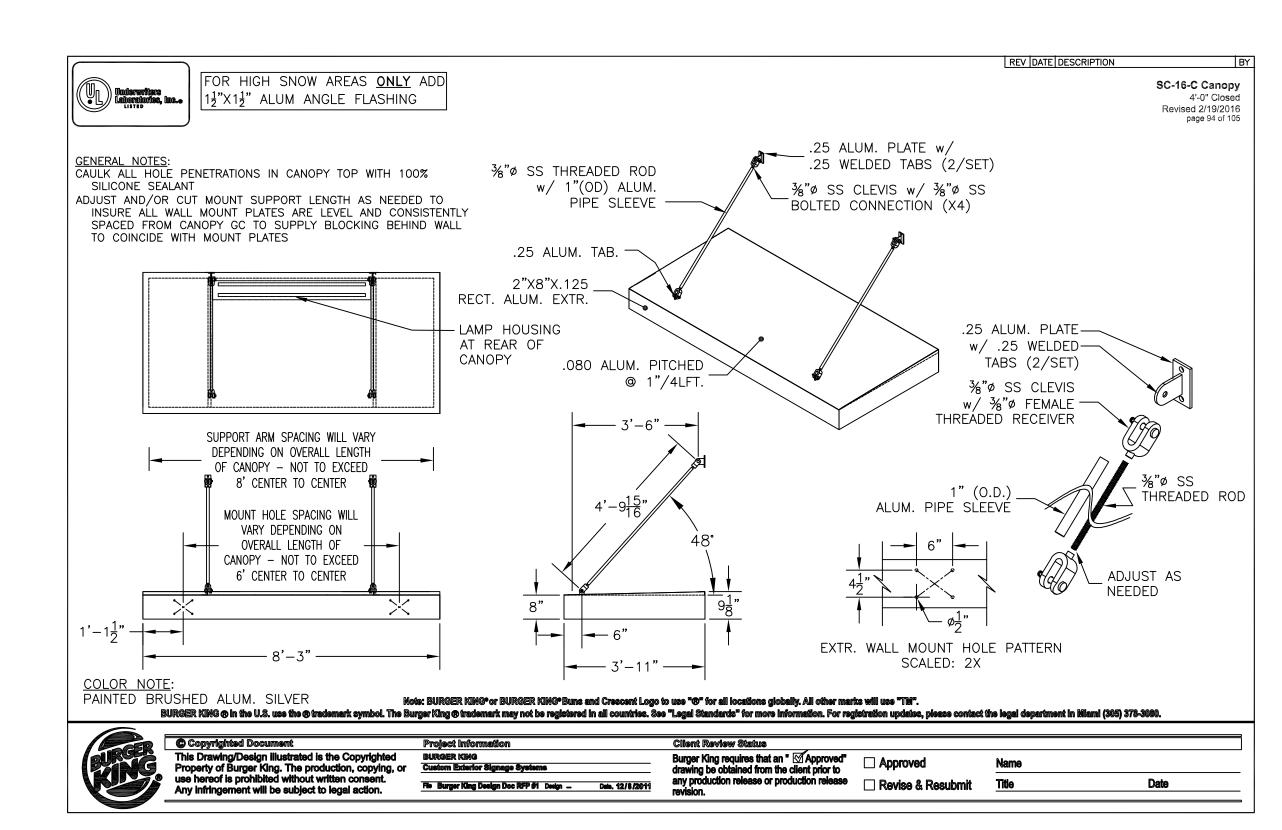
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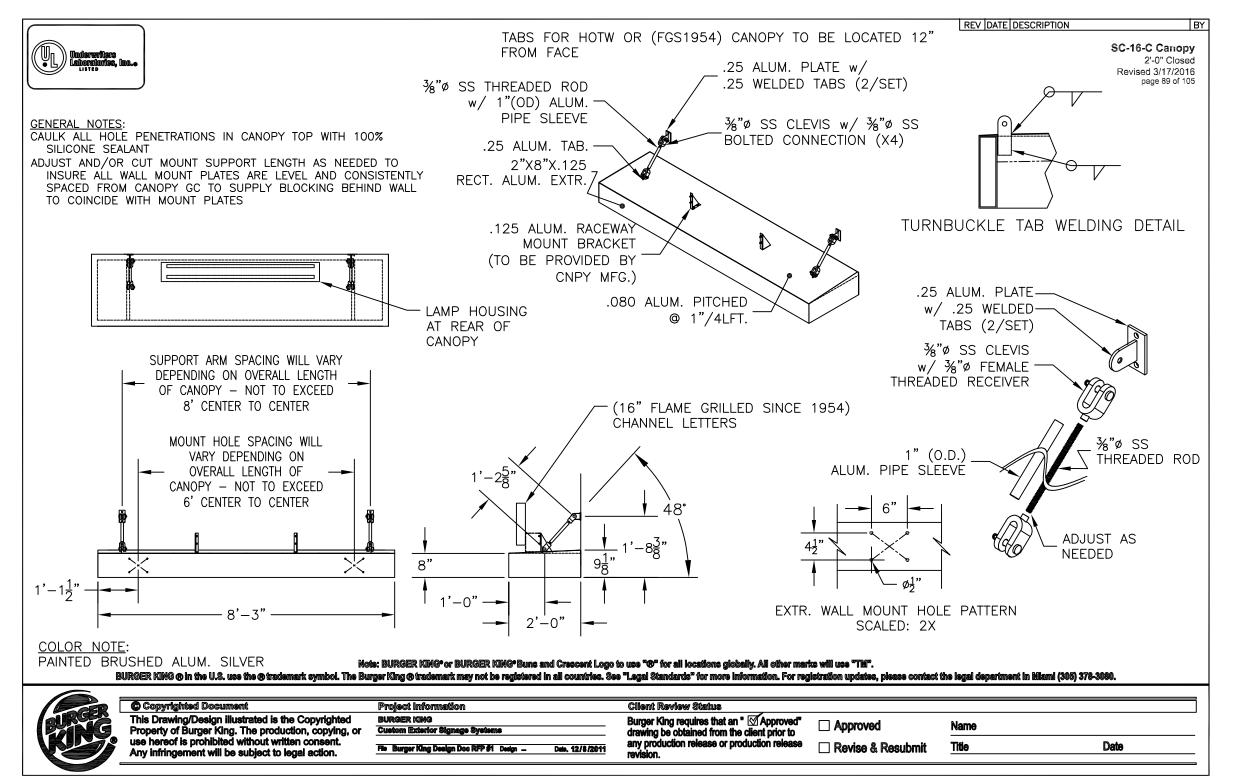
MAXIMUM AT

DRIVE-THROUGH WINDOW (0" PREFERRED) -







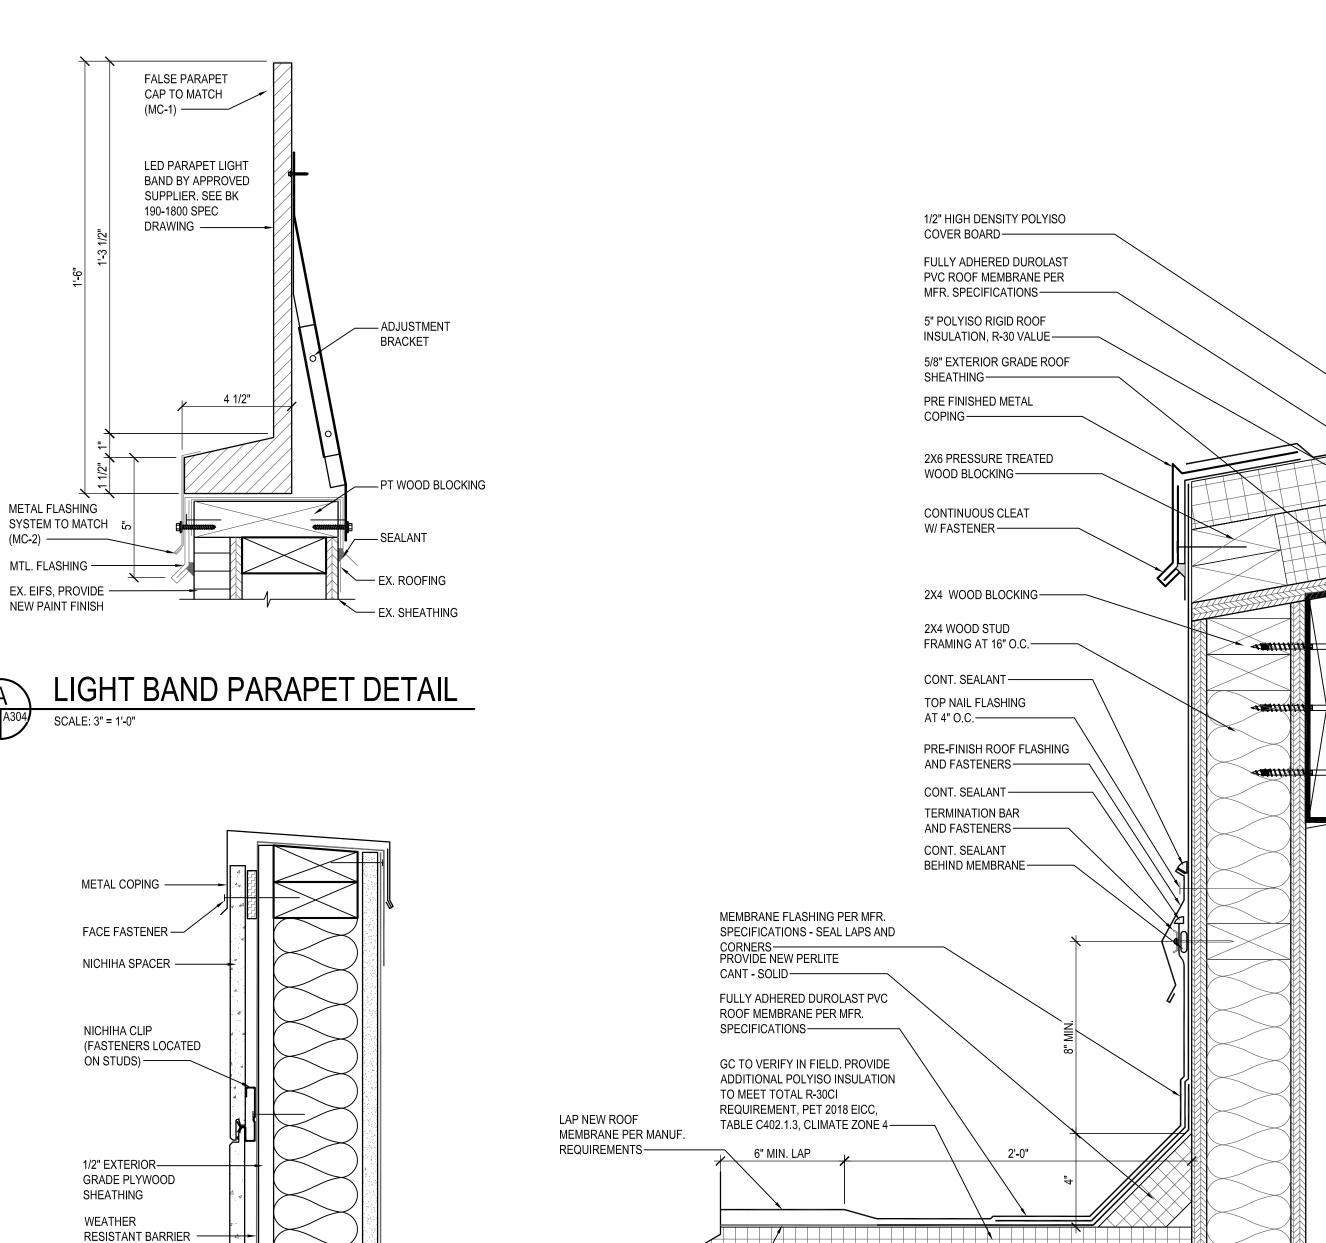

GENERAL NOTE: GENERAL CONTRACTOR TO VERIFY SIGNAGE,
DINING ROOM WINDOW CANOPY & DRIVE THRU CANOPY WITH
OWNER AND BURGER KING, BEFORE ORDER AND INSTALLATION.

BUILDING HORIZONTAL
REVEALS - EIFS DETAIL
SCALE: 3" = 1'-0"

TOWER PARAPET DETAIL

- E.I.F. SYSTEM AS SPECIFIED ON EXTERIOR FINISH SCHEDULE

VERTICAL SPACING.

REFER TO EXTERIOR ELEVATIONS FOR

2. REVEAL TO BE FORMED WITH AESTHETIC GROOVE KIT KV-5050 (OR EQUAL). HOT

KNIFE AND GROOVE BY "WIND-LOCK".

SCALE: 3" = 1'-0"

P:\2018\18037504\Drawings\01-Arch\2018037504 - A304 - Wall Sections.dwg

D ROOF DETAIL

SCALE: 3" = 1'-0"

CAUTION:
IF THIS DRAWING IS A REDUCTION,
USE THE GRAPHIC SCALES.

0 3" 6" 12"
3"=1'-0"

05-25-2021 PERMIT SUBMISSION

DESIGNED: JMM

DRAWN: JMM

CHECKED: SCB

SCALE: AS NOTED

DATE: 05/25/2021

PROJECT: 2018.0375.04.0

DRAWING:

A304

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SECTIONS


WALL

duly licensed professional architect under the

License # 6140 Expiration Date: 08/21/202

- BURGER


TERATIONS

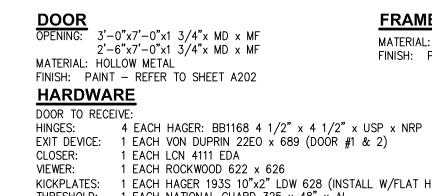



MATERIAL: HOLLOW METAL FINISH: PAINT - REFER TO SHEET A202


1 EACH ROCKWOOD 622 x 626 KICKPLATES: 1 EACH HAGER 193S 10"x2" LDW 628 (INSTALL W/FLAT HEAD PHILLIPS HEAD SCREWS)
THRESHOLD: 1 EACH NATIONAL GUARD 325 x 48" x AL
DOOR SWEEP: 1 EACH NATIONAL GUARD 200NA x 48"


WEATHERSTRIP: 1 SET NATIONAL GUARD 160SA 1@48", 2@84"

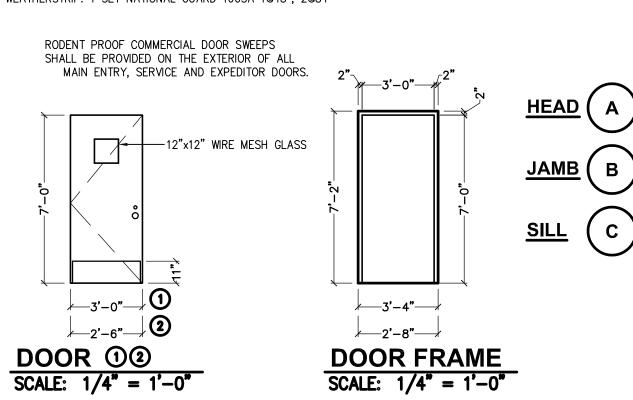


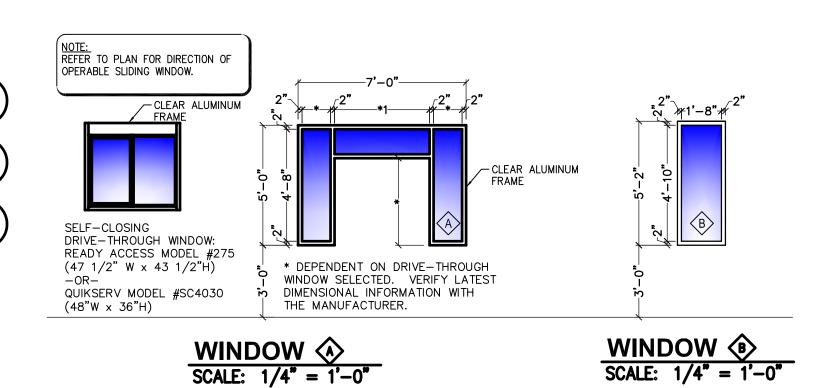


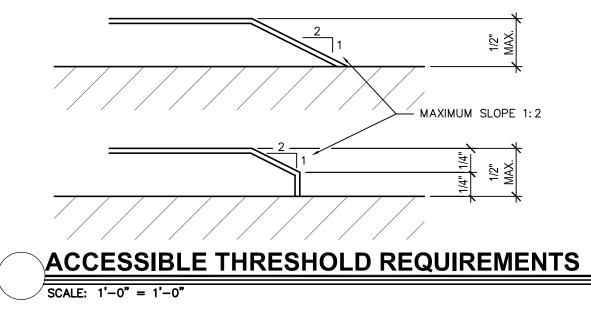

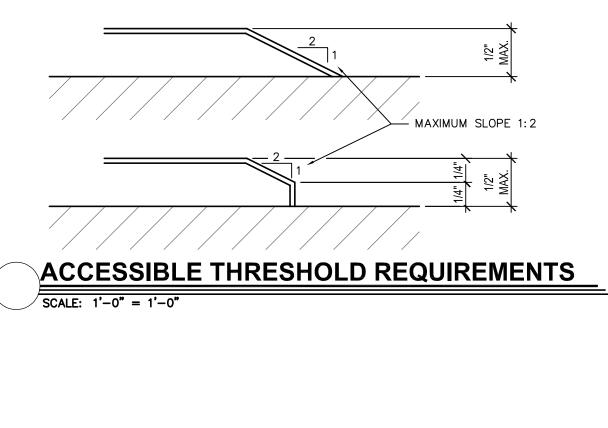

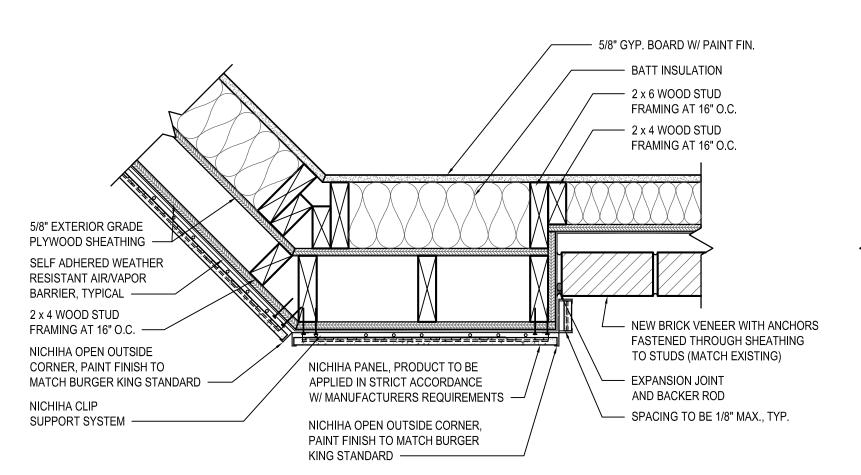

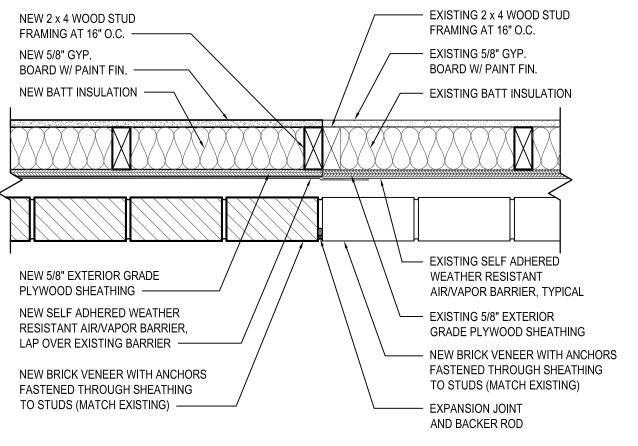

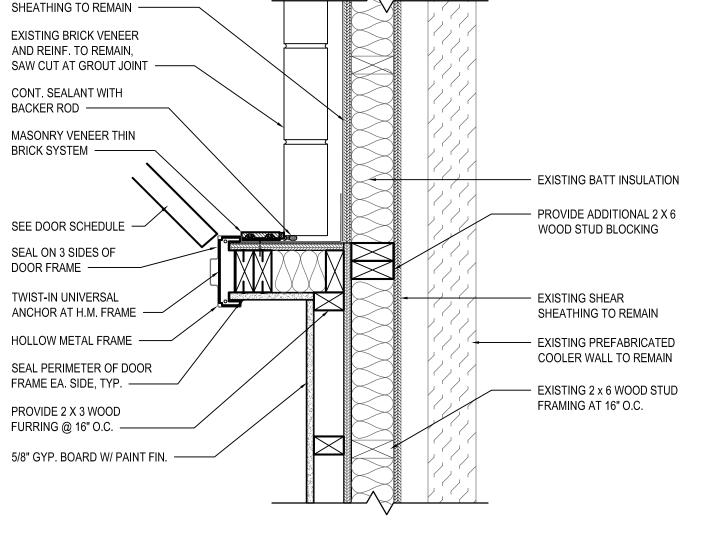










EXISTING SHEAR

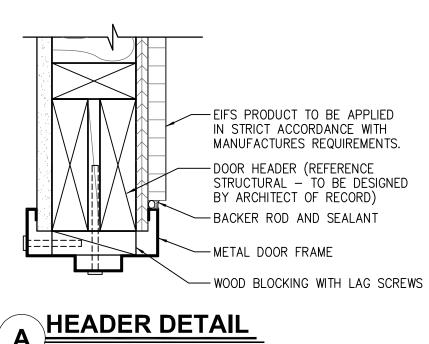

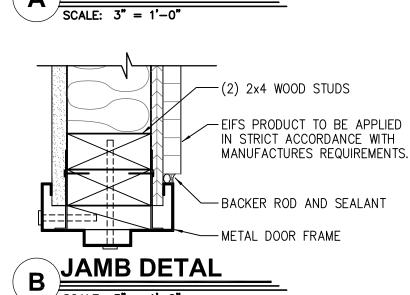

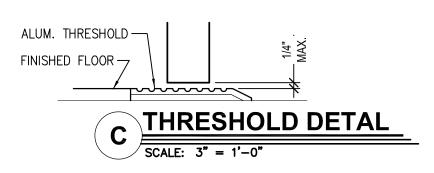


XCLUDER RODENT CONTROL DOOR SWEEP

SCALE: 3'' = 1' - 0

Hinaes -	•					Approved	own in hardw	are sets.
HAGER		BB1279		-,	BB116		253	
MCKINNEY		TA2714			T4A378	36		
BOMMER		BB5000			BB500	4		
Locks - P	rovide feat	ures, fur	nctions	and fi	nish a	as shown in	hardware se	ts.
FALCON - DEAD	LOCK	D871			<u> </u>		NO SUBSTIT	JTIONS
SCHLAGE		AL53PD			AL405			
YALE		AU5307LN			AU530	2LN		
FALCON		B511D			B301D			
VON DUPRIN YALE SARGENT Closers - Provide LCN YALE		22 EO 2100 EO 3828 EO <b>e features, function</b> 1461 3301 8616		ctions	41151		own in hardw	are sets.
Push/Pul hardware	•		Provide	featur		Inctins, size	e and finish a	
	K1050 B3E	BF106	X 70C	70C		441CU	409	622
ROCKWOOD			3x2 🚽 PROJ.	1001-3		1211	1270WV	976U

LOW PROFILE 36" - 162500 AND 48" - 162520

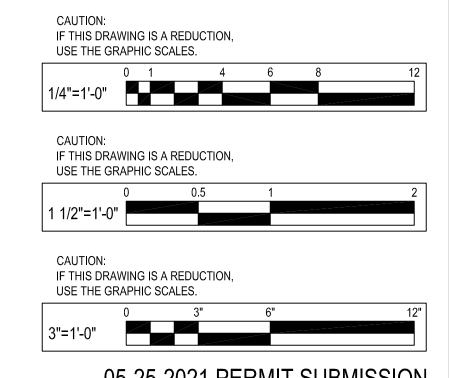

05/25/2021 PROJECT: 2018.0375.04.0 DRAWING: A601

AS NOTED

JMM SCB

DESIGNED: JMM

DRAWN:

CHECKED: SCALE:

I hereby certify that these documents were

prepared or approved by me, and that I am a

duly licensed professional architect under the

License # 6140 Expiration Date: 08/21/2022

TERATIONS - BURGER KING

laws of the State of Maryland.

DOOR SCHEDULE AND DETAILS

05-25-2021 PERMIT SUBMISSION

P:\2018\18037504\Drawings\01-Arch\2018037504 - A601 - Door Schedule.dwg

	This	s list is intended to assist the contractor in sourcing building mate		DRY OF MANUFACTURERS AND aterials and products may be purchased directly from these sour		ved manufacturers, see plans and specifications. and visit RSI's eR	edbook.	
JPDATE: 2-20-2018			у		,	T		
DIVISION 4 - MASONRY	EVOLUTION PRICK	DIVISION 9 - FINISHES		DIVISION 15 - MECHANICAL	EVEDDUDE INC	SIGNS, EQUIPMENT, PLAYGROUNDS AND DÉCOR	LINTEGRATED CONTROL CORD	L CHARTER HOUSE INC
PINE HALL BRICK CO. FACE BRICK) 2701 SHOREFAIR DRIVE, NW WINSTON-SALEM, NC 27105 THERESA BEANE: (800) 334-8689 TBEANE@PINEHALLBRICK.COM	EVOLUTION BRICK (FACE BRICK) 126 OLD HIGHWAY 60 EAST HARDINSBURG, KY 40143 GABE POWERS: (502) 558-4612	FOR FINISH MATERIALS, AND CONTACTS, REFER TO FIN SECTION OF THE WWW.DE.	ISH SCHEDULES FOUND IN THE "COMMON DOCUMENTS" SIGNWITHBK.COM WEBSITE.	RINNAI (INSTANT WATER HEATERS) RINNAI NATIONAL ACCOUNT PRICING THROUGH HAINES, JONES, & CADBURY. CONTACT THE BURGER KING CSR AT HJC 800-459-7099 FOR RINNAI TANKLESS WATER HEATER PRICING (MISCELLANEOUS)	EVERPURE, INC (WATER FILTERS) 1040 MUIRFIELD DRIVE HANOVER PARK, IL. 60133 JEANNINE GAINE: 630-240-1298 jeannine.gaine@pentair.com	L.S.I. (MENU BOARDS) 10000 ALLIANCE ROAD CINCINNATI, OH 45242 BRITTANY KOESTER: 513-372-3391 OR 513-315-3725	INTEGRATED CONTROL CORP. (KITCHEN MINDER) 748 PARK AVENUE HUNTINGTON, NY 11743 JOHN PATTI: 631-673-5100 EXT 325	CHARTER HOUSE INC. (DECOR) 4660 136 AVENUE HOLLAND, MI. 49424 BARB ZILM: 800-314-7659 OR 317-774-8880 barbara.zilm@charter-house.com www.gotochi.com
HC MUDDOX BRICK CO. (FACE BRICK) 4875 BRADSHAW ROAD SACRAMENTO, CA 95827 916-859-6320		SUMMITVILLE TILE CO (REPLACEMENT STRATA TILE) 330-223-1511		RHEEM (WATER HEATERS) 101 BELL ROAD MONTGOMERY, AL. 36117 800-621-5622 OR CONTACT HAINES, JONES, & CADBURY (MISCELLANEOUS)	SELECTO SCIENTIFIC, INC (WATER FILTERS) 3980 LAKEFIELD COURT SUWANEE, GA. 30024 EHUD LEVY: 678-475-1445 edlevy@selectoinc.com	FEDERAL HEATH SIGN CO (AWNINGS, CANOPIES AND SIGNS) 12704 DUPONT CIRCLE TAMPA, FL. 33626 FIONA PAUL: 800-284-3284 EXT. 19 fpaul@federalheath.com	DUKE MANUFACTURING (PRODUCT HOLDING UNITS) 2305 NORTH BROADWAY ST. LOUIS MO. 63102 SUE SCIUTO: 800-735-3853 EXT 1260 ssciuto@dukemfg.com	SEATING CONCEPTS (DECOR) 125 CONNELL STREET ROCKDALE, IL. 60436 ZACH DEPYSSLER: 815-483-2244 zdepyssler@seating-concepts.com
DIVISION 5 - METALS ADDISON STEEL STRUCTURAL STEEL) ADDISON, IL 256-747-1554		DIVISION 10 - SPECIALTIES  BOBRICK PRODUCTS (RESTROOM ACCESSORIES, TOILET PARTITIONS* AND HARDWARE) CONTACT: HAINES, JONES, & CADBURY (MISCELLANEOUS) *GREEN PRODUCT	KOALA KARE PRODUCTS (BABY CHANGING STATIONS) CONTACT: HAINES, JONES, & CADBURY (MISCELLANEOUS)	A.O. SMITH (WATER HEATERS) 600 E. JOHN CARPENTER FREEWAY, SUITE 200 IRVING, TX. 75062 800-447-1953 972-719-5900	N.C.A. NATIONAL HVAC PRODUCTS, LLC. (AIR CONDITIONING - FULL SERVICE) 4585 140 AVENUE NORTH CLEARWATER, FL. 33762 877-530-0078	CUMMINGS SIGNS, INC (AWNINGS, CANOPIES AND SIGNS) 105 DALTON PLACE WAY KNOXVILLE, TN 37912 AMANDA HICKMAN: 865-862-4416 amanda.hickman@cummingssigns.com	FRYMASTER CORPORATION (FRYERS) 8700 LINE AVE SHREVEPORT, LA 71106 LAURA DODD: 318-865-1711 eqorders@frymaster.com	FCC COMMERCIAL FURNITURE (DECOR) 8452 OLD HWY. 99 NORTH ROSEBURG, OR. 97470 PRESTON O'HARA: 541-464-5284 OR 800-322-7328 EXT 284 preston.ohara@fccfurn.com
		AMERICAN STANDARD (RESTROOM ACCESSORIES) 1 CENTENNIAL AVENUE PISCATAWAY, NJ. 08854 CONTACT HAINES, JONES, & CADBURY (MISCELLANEOUS)	COLUMBIA VORTEX (HAND DRYERS) 825 GARLAND STREET 866-337-7286 EXT. 1136	CARRIER CORPORATION (AIR CONDITIONING) 6304 CARRIER PARKWAY SYRACUSE, NY. 13221 DEBORAH ROY-JONES: 315-432-7941 800-690-1086	LOREN COOK CO (EXHAUST FANS) 2015 E. DALE SPRINGFIELD, MO 65803-4637 KEN DICKSON: 813-966-9200 ken.dickson@tampabay.rr.com	ENTERA SIGNS (AWNINGS, CANOPIES AND SIGNS) 1200 ENTERA DRIVE PANAMA CITY, FL. 32401 850-797-1779	GAYLORD INDUSTRIES (HOODS) 10900 SOUTH AVERY STREET TUALATIN, OR. 97062 JOHN ANDERSON: 971-223-1238 john.anderson@gaylordusa.com	CASABLANCA DESIGN GROUP (DECOR) 811 PICKENS INDUSTRIAL DRIVE MARIETTA, GA 30026 JOHN HARRISON: 770-423-9575 John.Harrison@cdg.com
DIVISION 7 - THERMAL MOISTURE PROTECTION DURO-LAST ROOFING (FLAT ROOFING) 525 MORLEY DRIVE 6AGINAW, MI 48601 LINDY BEUTHIN: 800-432-9331 6AMANTHA PICKELMAN 989-758-1048 OR 989-930-9826	G.A.F. (FLAT ROOF) 1361 ALPS ROAD WAYNE, NJ. 07470 (201) 628-3000 800-766-3411	ZURN INDUSTRIES (PLUMBING FIXTURES) CONTACT: HAINES, JONES, AND CADBURY (MISCELLANEOUS)	WORLD DRYER, CO (HAND DRYERS) CONTACT: HAINES, JONES, AND CADBURY (MISCELLANEOUS)	TRANE (AIR CONDITIONING UNITS, RTU's/SPLIT SYSTEMS CONTROLS) 2884 CORPORATE WAY MIRAMAR, FL. 33025 AL MARTINEZ: 954-499-2289 OR 800-440-9554 bkhvac@trane.com	AMEREX CORPORATION (FIRE PROTECTION SYSTEMS) 7595 GADSDEN HIGHWAY TRUSSVILLE, AL 35173-0081 LISA JONES: 205-655-5760 Ijones@amerex-fire.com www.amerex-fire.com	SIGN RESOURCE (AWNINGS, CANOPIES AND SIGNS) 6135 DISTRICT BLVD. MAYWOOD, CA. 90270 RAMON ORTIZ: 323-326-6463 rortiz@signresource.com	LANCER (DRINK DISPENSERS) 6655 LANCER BLVD SAN ANTONIO, TX. 78219 MIKE KRAWETZKE: 817-692-5094 michael.krawetzke@lancercorp.com	FACILITY CONCEPTS, INC (FCI) (DECOR) 7676 ZIONSVILLE ROAD INDIANAPOLIS, IN 46268 KEN WEAVER: 800-915-8890 EXT. 103 kweaver@fcius.com CALVIN DURR: 800-915-8890 EXT 303 cdurr@fcius.com
BERRIDGE ROOFING METAL ROOF) TYLER HALL SAN ANTONIO, TX. 210-650-7047	TAMKO ROOFING PRODUCTS (FLAT ROOFING) P.O. BOX 1404 JOPLIN, MO. 64802 800-641-4691	SAN JAMAR (RESTROOM ACCESSORIES & SUPPLIES) 555 KOOPMAN LANE ELKHORN, WI. 262-723-6133 www.sanjamar.com OR CONTACT HAINES, JONES, & CADBURY (MISCELLANEOUS)		AMERICAN STANDARD (TOILET, URINAL, FAUCETS) 1 CENTENNIAL AVE. PISCATAWAY, NJ. 08855 800-442-1902 OR CONTACT: HAINES, JONES, & CADBURY (MISCELLANEOUS)		ALLEN INDUSTRIES, INC (AWNINGS, CANOPIES AND SIGNS) 11351 49TH STREET NORTH CLEARWATER, FL 33762 THERESA TRIMMER: 800-677-3075 EXT. 3422 theresa.trimmer@allenindustries.com	NIECO CORPORATION (BROILERS) 7950 CAMERON DRIVE WINDSOR, CA 95492 CHRISTINA NEAT: 707-284-7100 sales@nieco.com	INTERIOR SYSTEMS, INC (DECOR) 241 NORTH BROADWAY, SUITE 600 MILWAUKEE, WI 53202 JIM ZIELINSKI: 414-232-3502 JZielinski@isiamerica.com JASON FREDRICKSON: 414-224-0972 jfredrickson@isiamerica.com
IRESTONE METAL PRODUCTS METAL ROOF) 50 WEST 96TH STREET NDIANAPOLIS, IN 46260 USUKE KOREEDA: 615-345-9991 oreedayusuke@firestonebp.com	BASF CORPORATION (POLYURETHANE ROOFING SYSTEMS) 1703 CROSS POINT AVE HOUSTON, TX 77054 MOSES M CLARK, JR: 315-263-4665	UNIVERSAL MANUFACTURING (RESTROOM ACCESSORIES) 5366 CRESTVIEW DR. MEMPHIS, TN. 38134 901-458-5881 800-821-1414				LEKTRON, INC (PARAPET LIGHT BANDS) 7450 E. 46th PLACE TULSA, OK. 74145 KEVIN RUBOTTOM 800-634-4059 OR 918-622-4978 EXT 309 krubottom@lektroninc.com	PITCO (FRYERS) 10 FERRY STREET CONCORD, NH. 03301 BONNIE BOLSTER: 603-230-5529 bbolster@pitco.com	COMMERCIAL INTERIOR MANUFACTURERS, INC (LIMITED DÉCOR ITEMS) 158 HOLLY STREET JASPER, GA. 30143 706-253-4761 STEVE BOUDREAU steve@cimgbiz.com AUSTIN HOLAN austin@cimgbiz.com
VISION 8 - DOORS AND WINDOWS				DIVISION 16 - ELECTRICAL		FRANKE	TAYLOR ULTIMATE SERVICES, INC	NAUTICAL FURNISHINGS, LLC
QUIKSERV DRIVE-THRU WINDOWS) .1441 BRITTMOORE PARK DRIVE HOUSTON, TX. 77041 800-388-8307 STEVEN BERT bert@quikserv.com	MARLITE (DOOR, ALUMINUM FRAMES) 202 HARGER STREET DOVER, NH 44622 800-377-1221 KURT HORSTMANN khorstmann@marlite.com			LSI INDUSTRIES INC. (INTERIOR AND EXTERIOR LIGHTING, SURVEYS AND PHOTOMETRICS) 10000 ALLIANCE ROAD CINCINNATI, OH. 45242 BRITTANY KOESTER: 513-372-3391 OR 513-315-3725	SECURITY LIGHTING SYSTEMS (EXTERIOR SITE AND BUILDING LIGHTING, SURVEYS AND PHOTOMETRICS) 2100 GOLF ROAD, SUITE 460 ROLLING MEADOWS, IL. 60008 ERIC HILLESLAND: 630-636-8493 ehillesland@security lighting.com	(KITCHEN EQUIPMENT, SMALLWARES, HOODS) 800 AVIATION PARKWAY SMYRNA, TN. 37086 CUSTOMER SERVICE: 800-877-5178 fs-bkparts.us@franke.com	(SHAKE MACHINE, FROZEN BEVERAGE MACHINE) 1780 NORTH COMMERCE PKWY WESTON, FL. 33326 TINA SMART: 954-217-9100 tina@taylorus.com	(LIMITED DÉCOR ITEMS) 60 NW 60TH STREET FT. LAUDERDALE, FL 33309 MICHAEL HOGLUND: 954-771-1100 mhoglund@nauticalfurnishings.com
EADY ACCESS DRIVE THRU WINDOWS & AIR CURTAINS) B15 ARTHUR DRIVE WEST HICAGO, IL. 60185 ELLY MCGOLDRICK: 800-621-5045 EXT 113 elly@ready-access.com	UNIVERSAL MANUFACTURING CO (HOLLOW METAL FRAMES & DOORS, WOOD DOORS, HARDWARE (HINGES, LOCKS, ETC) 5366 CRESTVIEW RD. MEMPHIS, TN. 38134 901-458-5881 OR 800-821-1414			3M SOUND PRODUCTS (DRIVE-THRU SOUND SYSTEM & SATELITE ANTENNA) 3M CENTER BLDG. 223-2N-20 ST. PAUL, MN. 55144-1000 JOE CIAMPI: 704-771-2449 jjciampi@mmm.com	CREE / HERMITAGE LIGHTING NATIONAL ACCOUNTS (INTERIOR AND EXTERIOR LIGHTING, SURVEYS AND PHOTOMETRICS) 3640 TROUSDALE DRIVE NASHVILLE, TN. 37204 STEVE FRIEDMAN: 847-830-1444 OR WYATT CULVER: 615-843-3379 800-264-3383	QUALSERV SOLUTION (KITCHEN EQUIPMENT, SMALLWARES) 7400 SOUTH 28th STREET FORT SMITH, AR. 72908 BECKY DUBOSE: 479-221-1467 bdubose@qualservsolutions.com	PLAY SYSTEMS (DIV. OF SUPERIOR INT. INDUSTRIES, INC) (PLAYGROUND MANUFACTURER) 1050 COLUMBIA DR. CARROLLTON, GA 30717 JUAN CUELLAR: 770-832-6660 EXT. 1517 jcuellar@siibrands.com	ARMSTRONG STRATEGIC ACCOUNTS (CEILING TILE) 2500 COLUMBIA AVENUE LANCASTER, PA. 17604 LOUIS JOHN: 407-697-6768 800-442-4212 lijohn@armstrongceilings.com OR ARMSTRONG STRATEGIC ACCOUNTS (800) 442-4212
	3M COMMERCIAL CORE DIVISION (WINDOW FILM) 3M CENTER ST. PAUL, MN 704-771-2449 OR 800-328-0033			SECURITY PRODUCTS, INC (REAR DOOR ALARM) 30950 COREAL DRIVE, SUITE B COARSEGOLD, CA. 93614 BOB BARR OR EMILY BEACH: 800-452-5276 orders@security productsinc.com	HM ELECTRONICS, INC (HME) (DRIVE-THRU SOUND SYSTEM) 14110 STOWE DRIVE POWAY, CA. 92064 PAUL KOOSER: 800-848-4468 paulk@hme.com	H & K INTERNATIONAL (KITCHEN EQUIPMENT, SMALLWARES, HOODS) 2200 SKYLINE DR DALLAS, TX 75223 HEATHER VALVERDE: 214-818-3521 heather.valverde@hki.com	SPI INDUSTRIES (PLAYGROUND MANUFACTURER) BOX 100, R.R. #2, JOINT ST. SHALLOW LAKE, ON, NOH 2KO CANADA CYNTHIA MASTERS: 519-935-2174 OR 519-378-4356 cmasters@spiplastics.com www.spiplastics.com	USG INTERIORS (CEILING TILE) CHRIS BENJAMIN: 312-436-5458 cbenjamin@usg.com
				N.C.A. NATIONAL HVAC PRODUCTS, LLC. (MASTER CONTROL SYSTEM) 4585 140 AVENUE NORTH CLEARWATER, FL. 33762 877-530-0078	SUNCOAST ENVIRONMENTAL CONTROLS, INC. (ELECTRICAL SWITCH GEAR) 8655 115th AVENUE NORTH LARGO, FL. 34643 877-544-6679	INTERNATIONAL COLD STORAGE (ICS) (WALK-IN COOLERS / FREEZERS, DRY STORAGE COMPARTMENTS) 215 EAST 13th STREET ANDOVER, KS. 67002 LISA MOORE: 800-835-0001 EXT 4177 lisa.moore@icsco.com	SOFT PLAY, LLC (PLAYGROUND MANUFACTURER, SAFETY SURFACING, NON-CONTAINED PLAY EQUIPMENT) 13620 EAST REESE BLVD. SUITE 300 HUNTERSVILLE, NC. 28078 JIM SWINTEK: 704-948-3448 jim.swintek@softplay.com	MITYLITE (2020 LIGHT CHAIRS AND BARSTOOLS) 1301 WEST NORTH OREM, UT KAREN EDWARDS: 561-213-2810
				HILL PHOENIX POWER SYSTEMS DIVISION (FACTORY INTEGRATED SWITCH GEAR) 8166 INDUSTRIAL BLVD COVINGTON, GA. 30014 PAUL BROWN: 678-699-0129 paul.brown@hillphoenix.com	TRANE CO. (ENERGY MANAGEMENT PANEL) 2884 CORPORATE WAY MIRAMAR, FL. 33025 AL MARTINEZ: 954-499-2289 ammartinez@trane.com	3M FOOD SERVICE BUSINESS (DRIVETHRU COMMUNCATION PRODUCTS, MAINTENANCE PRODUCTS, MATTING AND TRACTION PRODUCTS, MONITOR STRIPS, TAPES AND DISPENSERS, LAMINATING SYSTEMS) 3M CENTER BLDG. 223-2N-20 ST. PAUL, MN. 55144-1000 JOE CIAMPI: 704-771-2449 jjciampi@mmm.com	MOSS RETAIL AND ENVIRONMENTS (GRAPHICS) 2643 WEST CHICAGO AVE CHICAGO, IL 60622 DJ SCANDIFF: 773-435-7600 EXT 617 ROB LORTS: 773-435-7600 EXT 655 rlorts@mossinc.com	TWENTY FOUR 7 GLOBAL SOLUTIONS, INC. (2020 LIGHT AND GARDEN GRILL CHAIRS AND BARSTOOLS) 898 NORTH SEPULVEDA BLVD, SUITE 465 EL SEGUNDO, CA 90245 BARRY WOON: 323-319-2722
						HM ELECTRONICS, INC (HME) (DRIVE-THRU WIRELESS INTERCOMS, DRIVE-THRU SPEED OF SERVICE TIMERS, DIGITAL SURVEILLANCE SYSTEMS) 14110 STOWE DRIVE POWAY, CA. 92064 PAUL KOOSER: 800-848-4468 paulk@hme.com	VGS, INC (GRAPHICS) 1696 MABRY MILL DRIVE, SW NORTH CANTON, OH 44709 GREG MOROZ: 201-528-9680 ORDER EMAIL: BURGERKING@VGS-INC.COM	WAUSAU TILE, INC (EXTERIOR DÉCOR) P.O. BOX 1520 WAUSAU, WI 54402-1520 STEVE THUT: 800-388-8728 EXT 320 sthut@wausautile.com
								MISCELLANEOUS  HAINES, JONES, AND CADBURY (PACKAGE PRICING ON MULTIPLE ITEMS PLUMBING, TILE, RESTROOM ACCESSORIES, ETC) 310 SW 24TH STREET BENTONVILLE, AR 72712 BARRY BRYANT:479-899-3555 barry.bryant@hjcinc.com

MANUFACTURERS AND SUPPLIERS  MARIANUFACTURERS AND SUPPLIERS  MARIANULLI WHITNEY BALLEY COX & MAGNANU, LLC 300 East Joppa Road Suite 200 300 East Joppa Road
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DRAWN: JMM

CHECKED: SCB

SCALE: AS NOTED

DATE: 05/25/2021

PROJECT: 2018.0375.04.0

DRAWING:

A701

DESIGNED: JMM

#### STRUCTURAL GENERAL NOTES

#### CODE

A. ALL CONSTRUCTION SHALL CONFORM TO 2018 INTERNATIONAL BUILDING CODE, AND HARFORD COUNTY LOCAL AMENDMENTS.

#### DESIGN LOADING

A. THE DESIGN DEAD LOAD FOR THE FRAMING IS AS FOLLOWS:

EXISTING ROOF DL = 13 PSF (ROOF, FRAMING AND CEILING) SOURCE: EXISTING STRUCTURAL DRAWINGS DATED 10/12/95

#### NEW ROOF DL = 25 PSF

B. THE FOLLOWING LIVE LOADS WERE USED IN DESIGN:

IBC 1603.1.2 - ROOF LIVE LOAD ROOF LIVE LOAD = 30 PSF

## IBC 1603.1.3 - ROOF SNOW LOAD

GROUND SNOW LOAD  $(P_G) = 30 PSF$ FLAT SNOW LOAD  $(P_F) = 21 PSF$ SNOW EXPOSURE FACTOR  $(C_F) = 1.0$ SNOW LOAD IMPORTANCE FACTOR (I) = 1.0 THERMAL FACTOR  $(C_T) = 1.0$ 

IBC 1603.1.4 - WIND LOAD ULTIMATE DESIGN WIND SPEED  $(V_{IIIT}) = 115 \text{ MPH}$ NOMINAL DESIGN WIND SPEED  $(V_{ASD}) = 89 \text{ MPH}$ RISK CATEGORY = II WIND EXPOSURE = C INTERNAL PRESSURE COEFFICIENT = ±0.18

#### GENERAL

- A. THE CONTRACTOR SHALL FIELD CHECK AND VERIFY ALL DIMENSIONS AND ELEVATIONS OF EXISTING WORK PRIOR TO FABRICATION OF ANY NEW MATERIALS.
- B. THE CONTRACTOR IS ADVISED THAT ALL PLANS, DIMENSIONS, AND DETAILS DEPICT FIELD CONDITION AS SHOWN. MINOR VARIATIONS ARE TO BE EXPECTED AND ANY DEVIATIONS FROM THE CONTRACT DOCUMENTS SHALL BE APPROVED BY THE ARCHITECT IN WRITING PRIOR TO PROCEEDING.
- C. IT SHALL BE THE CONTRACTOR'S RESPONSIBILITY TO EXAMINE THE EXISTING BUILDING DURING THE COURSE OF CONSTRUCTION AND IMMEDIATELY ADVISE THE ARCHITECT OF ANY AREAS WHERE THE STRUCTURE EXHIBITS DISTRESS OR FAILURE.
- D. IT IS THE CONTRACTOR'S RESPONSIBILITY TO SATISFY HIMSELF AS TO THE LOCATION OF ANY UTILITIES IN THE IMMEDIATE VICINITY OF CONSTRUCTION SO AS TO PREVENT DAMAGE TO THEM. SHOULD ANY DAMAGE TO SUCH UTILITIES OCCUR THE CONTRACTOR SHALL BE REQUIRED TO REPAIR SUCH DAMAGE AT HIS OWN EXPENSE AND TO THE SATISFACTION OF THE OWNER.
- E. THE CONTRACTOR SHALL PROVIDE ALL SHORING, NEEDLING AND BRACING AS REQUIRED TO SUPPORT THE EXISTING STRUCTURE. THE CONTRACTOR SHALL EXAMINE THE EXISTING STRUCTURE TO DETERMINE THE EXTENT OF NECESSARY SHORING, NEEDLING AND UNDERPINNING. THE CAPACITY AND METHOD USED FOR SHORING AND NEEDLING SHALL BE THE RESPONSIBILITY OF THE CONTRACTOR.
- F. ALL WORK SPECIFIED HEREIN SHALL BE INSPECTED IN ACCORDANCE WITH THE BUILDING CODE AND ALL LOCAL ORDINANCES. THE OWNER OR CONTRACTOR SHALL HIRE AN EXPERIENCED, QUALIFIED INSPECTOR TO PERFORM ALL THE REQUIRED INSPECTION WORK. THE ENGINEER WILL NOT PERFORM THE REQUIRED INSPECTION AS A PART OF THEIR DESIGN SERVICES. THE ENGINEER MAY VISIT THE SITE TO ASCERTAIN GENERAL CONFORMANCE WITH THE CONTRACT DOCUMENTS. SUCH SITE VISITS ARE NOT TO BE CONSTRUED AS MEETING ANY INSPECTION REQUIREMENTS UNLESS THE ENGINEER SPECIFICALLY SO STATES IN WRITING.
- G. ANY REVIEW OF STRUCTURAL ITEM SHOP DRAWINGS BY (THE STRUCTURAL ENGINEER) IS FOR GENERAL CONFORMANCE WITH THE DESIGN CONCEPT AS PRESENTED BY THE CONTRACT DOCUMENTS. NO DETAILED CHECK OF QUANTITIES OR DIMENSIONS WILL BE MADE, SEE WBCM SHOP DRAWING STAMP FOR RESPONSIBILITIES OF EACH PARTY.
- H. SHOP DRAWINGS FOR ALL STRUCTURAL ELEMENTS SHOWN ON THE CONTRACT DOCUMENTS MUST BE SUBMITTED BY THE GENERAL CONTRACTOR. IF A CONTRACTOR OR OWNER FAILS TO SUBMIT THE SHOP DRAWINGS. THE ENGINEER WILL NOT BE RESPONSIBLE FOR THE STRUCTURAL CERTIFICATION OR FOR THE DESIGN OF THE PROJECT.
- FOOTINGS ARE DESIGNED FOR AN ASSUMED BEARING CAPACITY OF 2000 PSF. CONTRACTOR SHALL VERIFY SOIL PRESSURE IN THE FIELD. IF FOUND TO BE LESS THAN THIS VALUE, THE FOOTINGS WILL HAVE TO BE REDESIGNED.

# 4. CAST-IN-PLACE CONCRETE

# 4A. GENERAL CONSTRUCTION

ASTM C94

A. ALL CONCRETE WORK SHALL CONFORM TO THE LATEST APPROVED (BY LOCAL GOVERNMENT) EDITIONS OF THE FOLLOWING A.C.I. AND A.S.T.M. DOCUMENTS:

SPECIFICATIONS FOR STRUCTURAL CONCRETE FOR BUILDINGS ACI-301 ACI-302,1R FLOOR AND SLAB CONSTRUCTION ACI-318 BUILDING CODE REQUIREMENTS FOR REINFORCED CONCRETE ACI-214 COMPRESSION TESTS ACI-306 COLD WEATHER ACI-315 DETAILING ACI-347 FORMWORK ACI-305 HOT WEATHER ACI-211 PROPORTIONS OF CONCRETE ACI-304 PLACING CONCRETE ACI-ASCE/423 UNBONDED TENDONS

B. ALL FIELD AND LAB TESTING OF CONCRETE SHALL CONFORM TO THE LATEST APPROVED (BY LOCAL GOVERNMENT) EDITIONS OF ASTM:

ASTM C31 FIELD CYLINDER SPECIMENS ASTM C143 SLUMP TEST ASTM C231 AIR CONTENT (WHEN REQUIRED) ASTM C39 LAB TESTING CYLINDERS C172 ASTM SAMPLING FRESH CONCRETE ASTM C42 HARDENED CORES (WHEN REQUIRED)

READY-MIX CONCRETE

C. ALL CONCRETE, UNLESS NOTED OTHERWISE, SHALL BE STONE AGGREGATE CONCRETE HAVING A MINIMUM COMPRESSIVE STRENGTH OF 4000 PSI AT 28 DAYS. ALL CONCRETE EXPOSED TO WEATHER SHALL HAVE AN AIR ENTRAINMENT OF 5%±1%. NO ADMIXTURES CONTAINING CALCIUM CHLORIDE SHALL BE PERMITTED MAXIMUM AGGREGATE SIZE FOR CONCRETE SHALL BE 1", AND MAXIMUM SLUMP SHALL BE 4", AND 3" FOR SLABS ON GRADE. ALL CONCRETE, EXCEPT FOOTINGS, SHALL CONTAIN A WATER REDUCING ADMIXTURE.

- D. ALL CONCRETE MIX DESIGNS AND ADMIXTURES SHALL BE APPROVED BY THE ARCHITECT 30 DAYS PRIOR TO INITIATION OF FIRST POUR.
- E. ALL REINFORCING BARS SHALL CONFORM TO ASTM A-615 GRADE 60. WELDED WIRE FABRIC SHALL CONFORM TO ASTM A-185.
- F. CONCRETE EXPOSED TO PUBLIC VIEW SHALL MEET THE REQUIREMENTS FOR ARCHITECTURAL CONCRETE OF ACI 301.
- G. ALL FORMWORK SHALL BE IN ACCORDANCE WITH THE AMERICAN CONCRETE INSTITUTE "FORMWORK FOR CONCRETE", SPECIAL PUBLICATION NO. 4 AND ACI'S "STANDARD RECOMMENDED PRACTICE FOR CONCRETE FORMWORK" (ACI-347, LATEST LOCAL APPROVED EDITION).
- H. ALL LAP SPLICES SHALL BE CLASS "B" (1'-0" MIN.) EXCEPT AS NOTED ON PLANS. BEND OUTSIDE FACE WALL HORIZONTAL REINFORCING 1'-0" AROUND ALL CORNERS OR PROVIDE 4'-0" LONG CORNER BARS TO MATCH HORIZONTAL REINFORCING.
- I. PROVIDE CONCRETE PROTECTION FOR REINFORCING BARS AS FOLLOWS:

# FOOTINGS

- J. WHERE CONTINUOUS BARS ARE CALLED FOR, THEY SHALL BE RUN CONTINUOUSLY AROUND CORNERS AND LAPPED AT NECESSARY SPLICES OR HOOKED AT DISCONTINUOUS ENDS. LAPS SHALL BE NOT LESS THAN THE TYPICAL SPLICE LENGTH UNLESS NOTED.
- K. REINFORCEMENT SHALL BE CONTINUOUS THROUGH ALL CONSTRUCTION JOINTS UNLESS OTHERWISE INDICATED ON THE DRAWINGS. AT VERTICAL CONSTRUCTION JOINTS.

#### WOOD FRAMING

### 5A. GENERAL WOOD FRAMING

- A. STRUCTURAL SOLID WOOD JOISTS, BEAMS, COLUMNS AND STUDS SHALL BE SOUTHERN PINE #2 SURFACED DRY AT A MAXIMUM OF 19% MOISTURE CONTENT. ALL FABRICATION, ERECTION, OTHER PROCEDURES, AND MINIMUM UNIT STRESSES SHALL CONFORM TO THE CURRENT "NATIONAL DESIGN SPECIFICATION FOR WOOD CONSTRUCTION".
- B. ALL WOOD FRAMING SHALL BE FABRICATED AND ERECTED IN ACCORDANCE WITH THE AMERICAN INSTITUTE OF TIMBER CONSTRUCTION SPECIFICATION AITC 105 "RECOMMENDED PRACTICE FOR THE ERECTION OF STRUCTURAL TIMBER FRAMING, AITC 106," "CODE OF STANDARD PRACTICE", AND "THE NATIONAL DESIGN SPECIFICATION FOR WOOD CONSTRUCTION", LATEST EDITION, AS PUBLISHED BY THE NATIONAL FOREST PRODUCTS ASSOCIATION.
- C. ALL WOOD PLATES BEARING ON CONCRETE WALL SHALL BE WOLMANIZED PRESSURE TREATED LUMBER AS MANUFACTURED BY KOPPERS COMPANY OR AN APPROVED ALTERNATE.
- D. ANCHOR ALL SILL PLATES TO CONCRETE SLABS OR MASONRY WALLS WITH 5/8" DIAMETER ANCHOR BOLTS WITH 15" MIN. EMBEDMENT DEPTH AND 4" MIN. HOOK SPACED AT MAX. 32" ON CENTER. PROVIDE 2 ANCHOR BOLTS MINIMUM PER PLATE.
- ALL LAMINATED VENEER LUMBER (LVL) SHALL BE FABRICATED TO PRODUCE THE FOLLOWING MINIMUM ALLOWABLE STRESSES:

F = 2,900 PSIMODULUS OF ELASTICITY E = 2,000,000 PSI

# 5B. WOOD WALLS AND COLUMNS

- A. ALL PERIMETER STUD BEARING WALLS AND INTERIOR BEARING WALLS SHALL BE 2X6 @ 16" O/C UNLESS NOTED OTHERWISE. PROVIDE SOLID BRIDGING AT MID HEIGHT OF ALL STUD WALLS TO 9'-0" HIGH UNLESS NOTED OTHERWISE. STUD WALLS OVER 9'-0" SHALL BE PROVIDED WITH 2 ROWS OF SOLID BRIDGING LOCATED AT THE THIRD POINT OF THE STUD HEIGHT UNLESS NOTED OTHERWISE.
- B. PROVIDE DOUBLE STUDS AT ALL CORNERS, SIDES OF ALL OPENINGS, WINDOWS AND DOORS, AND BENEATH ALL WOOD BEAMS AND LINTELS UNLESS NOTED OTHERWISE ON PLANS. DOUBLE STUDS BENEATH WOOD BEAMS AND LINTELS SHALL BE CARRIED THROUGH ANY INTERMEDIATE FLOOR FRAMING TO THE TOP OF FOOTINGS OR MASONRY FOUNDATION WALLS.

# 5C. PLYWOOD

- ALL PLYWOOD SHALL MEET THE REQUIREMENTS OF THE PLYWOOD DESIGN SPECIFICATIONS AS PUBLISHED BY THE AMERICAN PLYWOOD ASSOCIATION.
- B. ENTIRE ROOF DECK SHALL BE 5/8"-24/0 PLYWOOD. PROVIDE PLY CLIPS AT CENTERLINE OF PLYWOOD SPAN AT ALL EDGES PARALLEL TO SPAN.
- C. PLYWOOD SHEATHING SHALL BE CONTINUOUS OVER A MINIMUM OF 2 SPANS.

D. PLYWOOD SHALL BE SECURELY FASTENED 3/8" FROM THE EDGE.

- E. PLYWOOD 1/2" IN THICKNESS AND LESS SHALL BE PROVIDED WITH PLY-CLIPS ALONG EDGES AT MIDSPAN. PLYWOOD 5/8" AND THICKER SHALL EITHER HAVE TONGUE AND GROOVE EDGES OR PLY-CLIPS AT MIDSPAN. FOR 48" SPANS PROVIDE 2 PLY CLIPS AT THIRD JOINTS OR TONGUE AND GROOVE PLYWOOD.
- MINIMUM NAIL SIZE NO. 11 GAGE, 1-3/4" LONG, 7/16" HEAD, DIAMOND POINT, GALVANIZED. ALTERNATE NAILS MAY BE USED IF THEIR DIMENSIONS ARE NOT LESS THAN THE SPECIFIED VALUES.
- G. END JOINTS OF ADJACENT COURSES OF GYPSUM BOARD SHEATHING SHALL NOT OCCUR OVER THE SAME STUD.
- H. WHERE BLOCKING IS REQUIRED BLOCKING SHALL BE THE SAME SIZE AS TYPICAL STUDS AND SHALL BE PROVIDED AT ALL JOINTS THAT ARE PERPENDICULAR TO STUDS.
- NAILS SHALL BE SPACED NOT LESS THAN 3/8" FROM EDGES AND ENDS OF GYP BOARD SHEATHING.
- NAIL SPACING SPECIFIED APPLIES TO ALL STUDS, TOP AND BOTTOM PLATES, AND BLOCKING.

#### 6. STRUCTURAL AND MISCELLANEOUS STEEL

#### A. GENERAL AND NEW CONSTRUCTION

- 1) ALL STRUCTURAL AND MISCELLANEOUS STEEL SHALL CONFORM TO THE FOURTEENTH EDITION OF THE AISC "SPECIFICATION FOR STRUCTURAL STEEL BUILDINGS" AND ALL ITS SUPPLEMENTS, AND TO THE AISC "CODE OF STANDARD PRACTICE FOR STEEL BUILDINGS AND BRIDGES."
- 2) ALL STRUCTURAL STEEL SHALL BE AS FOLLOWS:

ASTM A992, FY = 50,000 PSI W-SHAPES MISCELLANEOUS STEEL ASTM A572 GRADE 50, FY = 50,000 PSI RECTANGULAR/SQUARE HSS ASTM A500 GRADE C, FY = 50,000 PSI

- 3) NO OPENINGS IN BEAMS SHALL BE PERMITTED WITHOUT THE WRITTEN PERMISSION OF THE ENGINEER.
- 4) THE USE OF A GAS-CUTTING TORCH IN THE FIELD FOR CUTTING HOLES OR FOR CORRECTIONS FABRICATION ERRORS WILL NOT BE PERMITTED ON NEW STRUCTURAL FRAMING MEMBERS EXCEPT WITH THE WRITTEN APPROVAL OF THE ARCHITECT FOR EACH SPECIFIC CONDITION.
- 5) FIELD STRUCTURAL STEEL TO BE INSPECTED BY QUALIFIED INSPECTORS APPROVED BY THE STRUCTURAL ENGINEER AND RETAINED BY THE CONTRACTOR. FIELD INSPECTION REPORTS TO BE FILED WITH THE STRUCTURAL ENGINEER WITHIN 5 DAYS OF TIME OF ACTUAL INSPECTION. INSPECTORS MUST BE NOTIFIED OF ALL PHASES OF CONSTRUCTION AND WELDING BY GENERAL CONTRACTOR.
- 6) ALL WELDED CONNECTIONS SHALL BE DONE WITH E70XX ELECTRODES. SHOP AND FIELD WELDS SHALL BE MADE BY APPROVED CERTIFIED WELDERS AND SHALL CONFORM TO THE AMERICAN WELDING SOCIETY CODE FOR BUILDINGS AWS D1.1. WELDS SHALL DEVELOP THE FULL STRENGTH OF MATERIALS BEING WELDED UNLESS OTHERWISE NOTED.
- 7) ALL BUTT WELDS SHALL BE FULL PENETRATION BUTT WELDS IN ACCORDANCE WITH THE STRUCTURAL WELDING CODE (ANSI/AWS D1.1). THESE WELDS SHALL BE MADE ONLY BY OPERATORS QUALIFIED BY PRESCRIBED TESTS IN THE STRUCTURAL WELDING CODE IN BUILDING CONSTRUCTION OF THE AMERICAN WELDING SOCIETY. ACCEPTANCE TO BE SUBJECT TO THE INSPECTION AND REVIEW OF AN INDEPENDENT INSPECTION
- 8) WELDING SEQUENCE AND TECHNIQUE SHALL BE SUCH THAT DISTORTION OF STEEL MEMBERS IS MINIMIZED AND UNDUE DISTORTION IS AVOIDED.

# 7. POST-INSTALLED ANCHORS

#### A. ANCHORS IN CONCRETE AND MASONRY

- 1) POST INSTALLED ANCHORS SHALL BE USED ONLY WHERE SPECIFIED ON STRUCTURAL CONTRACT DRAWINGS
- 2) THE INSTALLATION OF POST INSTALLED ANCHORS FOR MISSING OR MISPLACED CAST IN-PLACE ANCHORS SHALL BE APPROVED BY THE ENGINEER OF RECORD
- 3) EXISTING EMBEDDED ITEMS IN THE CONCRETE STRUCTURE (I.E., EINFORCING BARS, CONDUIT, ETC.) SHALL NOT BE CUT UNLESS APPROVED BY THE STRUCTURAL ENGINEER OF RECORD.
- 4) SUBMITTAL OF ALL PROPOSED PRODUCTS, WITH TECHNICAL DATA AND CURRENT ICC-ESR REPORTS IS REQUIRED FOR REVIEW AND APPROVAL BY ENGINEER OF RECORD. ADDITIONAL APPLICATION CALCULATIONS MAY BE REQUIRED BY THE ENGINEER OF RECORD.
- 5) ALL ANCHORS SHALL BE INSTALLED IN STRICT ACCORDANCE WITH MANUFACTURER'S PRINTED INSTALLATION INSTRUCTIONS (MPII) IN CONJUNCTION WITH EDGE DISTANCE, SPACING AND EMBEDMENT DEPTH AS INDICATED ON THE CONTRACT DRAWINGS.
- 6) THE CONTRACTOR SHALL ARRANGE FOR A MANUFACTURER'S FIELD REPRESENTATIVE TO PROVIDE INSTALLATION TRAINING FOR ALL PRODUCTS TO BE USED. PRIOR TO COMMENCEMENT OF WORK, ONLY TRAINED INSTALLERS SHALL PERFORM POST INSTALLED ANCHOR INSTALLATION. A RECORD OF TRAINING SHALL BE KEPT ON SITE AND BE MADE AVAILABLE TO THE ENGINEER OF RECORD AS REQUESTED.
- ADHESIVE ANCHORS INSTALLED IN HORIZONTAL TO VERTICALLY OVERHEAD ORIENTATION TO SUPPORT SUSTAINED TENSION LOADS SHALL BE DONE BY A CERTIFIED ADHESIVE ANCHOR INSTALLER (AAI) AS CERTIFIED THROUGH ACI/CRSI (ACI 318-14 17.8). PROOF OF CURRENT CERTIFICATION SHALL BE SUBMITTED TO THE ENGINEER FOR APPROVAL PRIOR TO COMMENCEMENT OF INSTALLATION.
- ADHESIVE ANCHORS MUST BE INSTALLED IN CONCRETE AGED A MINIMUM OF 21 DAYS (ACI 318-14 17.1.2).
- 9) PROVIDE SPECIAL INSPECTION FOR ALL MECHANICAL AND ADHESIVE ANCHORS PER THE APPLICABLE BUILDING CODE AND PER THE CURRENT ICC-ES REPORT (IBC 2015 TABLE 1705.3 NOTE B).
- 10) SUBSTITUTION REQUESTS, FOR PRODUCTS OTHER THAN THOSE SPECIFIED BELOW, SHALL BE SUBMITTED BY THE CONTRACTOR TO THE ENGINEER OF RECORD ALONG WITH CALCULATIONS THAT ARE PREPARED & SEALED BY A REGISTERED PROFESSIONAL ENGINEER. THE CALCULATIONS SHALL DEMONSTRATE THAT THE SUBSTITUTED PRODUCT IS CAPABLE OF ACHIEVING EQUIVALENT PERFORMANCE VALUES (MINIMUM) OF THE SPECIFIED PRODUCT USING THE APPROPRIATE DESIGN PROCEDURE AND/OR STANDARDS(S) AS REQUIRED BY ACI 318-14 CHAPTER 17.
- 11) THE FOLLOWING MANUFACTURER'S HAVE BEEN PRE-APPROVED FOR
- a. POWERS FASTENERS b. HILTI INC
- c. SIMPSON

#### B. CONCRETE ANCHORS

- 1) MECHANICAL ANCHORS SHALL HAVE BEEN TESTED AND QUALIFIED FOR USE IN ACCORDANCE WITH ACI 355.2 AND ICC-ES AC193 FOR CRACKED, UNCRACKED AND SEISMIC CONCRETE RECOGNITION.
- 2) ADHESIVE ANCHORS SHALL HAVE BEEN TESTED AND QUALIFIED FOR USE IN ACCORDANCE WITH ACI 355.4 AND ICC-ES AC308 FOR CRACKED, UNCRACKED AND SEISMIC CONCRETE RECOGNITION.
- 3) CAST-IN-PLACE INSERTS SHALL HAVE BEEN TESTED AND QUALIFIED FOR USE IN ACCORDANCE WITH ICC-ES AC446 FOR CRACKED, UNCRACKED AND SEISMIC CONCRETE RECOGNITION.

#### C. MASONRY ANCHORS

- 1) MECHANICAL ANCHORS SHALL HAVE BEEN TESTED AND QUALIFIED FOR USE IN ACCORDANCE WITH ICC-ES AC01 OR AC106.
- 2) ADHESIVE ANCHORS SHALL HAVE BEEN TESTED AND QUALIFIED FOR USE IN ACCORDANCE WITH ICC-ES AC58.

#### 8. MASONRY

- A. ALL MASONRY CONSTRUCTION AND MATERIALS USED THEREIN (CONCRETE MASONRY, CLAY MASONRY, MORTAR, GROUT AND STEEL REINFORCEMENT) SHALL CONFORM TO "BUILDING CODE REQUIREMENTS FOR MASONRY STRUCTURES" (ACI 530/ASCE 5/TMS 402) AND "SPECIFICATIONS FOR MASONRY STRUCTURES" (ACI 530.1/ASCE 6/TMS 602) IN ALL RESPECTS. WHERE ANCHORS (INCLUDING ANCHOR BOLTS) ARE INDICATED TO BE GROUTED IN CELLS OF HOLLOW CMU, THE CELL CONTAINING THE ANCHOR (OR ANCHOR BOLT) SHALL BE FULLY GROUTED AND IN ADDITION TO THIS CELL THE CELLS ABOVE, BELOW, TO EACH SIDE, AND THE FOUR CELLS ON EACH 45 DEGREE DIAGONAL ADJACENT TO THE CELL CONTAINING THE ANCHOR/ANCHOR BOLT SHALL BE FULLY GROUTED AND THE EIGHT SURROUNDING CELLS SHALL BE FULLY GROUTED.
- B. UNLESS OTHERWISE NOTED CONCRETE MASONRY UNITS SHALL HAVE A MINIMUM NET AREA COMPRESSIVE STRENGTH OF 2,000 PSI. TYPE "S" PORTLAND CEMENT/LIME MORTAR SHALL BE USED FOR ALL MASONRY.
- C. MASONRY BEARING WALLS SHALL CONSIST OF STANDARD HOLLOW UNITS CONFORMING TO ASTM C 90 UNLESS OTHERWISE NOTED. WHERE SOLID UNITS ARE REQUIRED, PROVIDE UNITS CONFORMING TO ASTM C 145. CONCRETE MASONRY SHALL BE SAMPLED AND TESTED BY THE MASONRY SUPPLIER ACCORDING TO THE REQUIREMENTS OF "BUILDING CODE REQUIREMENTS FOR MASONRY STRUCTURES" (ACI 530/ASCE 5/TMS 402) AND "SPECIFICATIONS FOR MASONRY STRUCTURES" (ACI 530.1/ASCE 6/TMS 602) AND RESULTS SUBMITTED TO THE ENGINEER FOR APPROVAL. USE FULL HEAD JOINTS, FILL COLLAR JOINTS 100% SOLID, BOND PIERS INTO WALLS BY TOOTHING, AND BOND WALLS TO CROSS-WALLS BY TOOTHING.
- D. ALL MORTAR SHALL CONFORM TO THE REQUIREMENTS FOR PROPORTIONS, MIXING. STRENGTH. SAMPLING. TESTING. AND APPLICATION FOR PORTLAND CEMENT/LIME TYPE "S" MORTAR AS DESCRIBED IN ACI 530.
- E. MASONRY CONSTRUCTION IS TO BE INSPECTED BY AN EXPERIENCED, QUALIFIED INSPECTOR APPROVED BY THE STRUCTURAL ENGINEER. INSPECTION IS TO BE PROVIDED IN ACCORDANCE WITH THE ACI/ASCE/TMS CODE AND SPECIFICATION.
- F. ALL SOLID CMU IS TO BE 100% SOLID CMU OR HOLLOW CMU WITH ALL CELLS FILLED 100% WITH GROUT CONFORMING TO ASTM C 476.
- G. LOOSE LINTELS FOR MASONRY WALLS SHALL BE FOR EACH 4" WIDTH OF MASONRY ONE STEEL ANGLE AS FOLLOWS:

0'-0" TO 3'-0" \( \alpha \) 1/2" x 3 1/2" x 5/16" 3'-1" TO 5'-0" ∠4" x 3 1/2" x 5/16"

5'-1" TO 6'-6" ∠5" x 3 1/2" x 3/8"

6'-7" TO 8'-0" ∠6" x 3 1/2" x 3/8"


H. ALL ANGLES SHALL HAVE THEIR SHORT LEG OUTSTANDING AND 6" MINIMUM BEARING LINTELS OVER OPENINGS IN INTERIOR NON-BEARING MASONRY PARTITIONS NOT OTHERWISE SPECIFIED SHALL BE PRECAST LIGHTWEIGHT CONCRETE LINTELS WITH 1 NO. 5 BAR TOP AND BOTTOM FOR EACH 4" WIDTH. ALL MULTIPLE ANGLE LINTELS SHALL BE TACK WELDED TOGETHER AT ENDS AND AT

THIRD POINTS. SHORE LINTELS TO PREVENT ROTATION DURING CONSTRUCTION.

- I. LAP ALL VERTICAL REINFORCING 48 BAR DIAMETERS MINIMUM.
- J. ALL EXTERIOR WALLS AND ALL WALLS SUPPORTING LOADS OTHER THAN THEIR OWN WEIGHT SHALL BE CONSTRUCTED OF LOAD BEARING UNITS.
- K. ALL MASONRY WALLS SHALL BE REINFORCED WITH NO. 9 GAGE TRUSS-TYPE HOT DIPPED GALVANIZED JOINT REINFORCEMENT SPACED VERTICALLY AT 16" O/C U.N.O. PROVIDE CORNER AND TEE PIECES AT ALL INTERSECTIONS. LAP ALL JOINT REINFORCEMENT 6" MINIMUM.
- PROVIDE 16" MINIMUM DEPTH OF 100% SOLID MASONRY OR HOLLOW BLOCK FILLED SOLID WITH GROUT BELOW ALL LINTELS.
- M. BRACE AND SHORE ALL NEW MASONRY WALLS AS REQUIRED UNTIL ROOF DECKS HAVE BEEN COMPLETELY INSTALLED.
- N. PROVIDE SOLID BLOCK OR FILL WALL SOLID WITH GROUT DIRECTLY BELOW ALL CHANGES IN WALL THICKNESS OR CONSTRUCTION AS REQUIRED TO PROVIDE CONTINUOUS BEARING FOR ALL FACE SHELLS OF BLOCK.
- O. PROVIDE 8" DEEP SOLID BEARING BELOW ALL WOOD JOISTS AND STUDS BEARING ON MASONRY WALLS. SOLID BEARING SHALL BE SOLID BLOCK OR BRICK OR HOLLOW BLOCK FILLED SOLID WITH GROUT.

SOX & MAGNANI, LLC	Baltimore, MD 21286 500 www.wbcm.com	*	<b>&gt;</b>	Tomorrow ®	



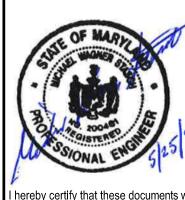


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prepared or approved by me, and that I am

duly licensed professional engineer under the

NOTE BURGER GENE TIONS

DESIGNED:	FC
DRAWN:	CG
CHECKED:	MWS
SCALE:	AS NOTED
DATE:	05/25/2021
PROJECT:	2018.0375.04.0
DRAWING:	



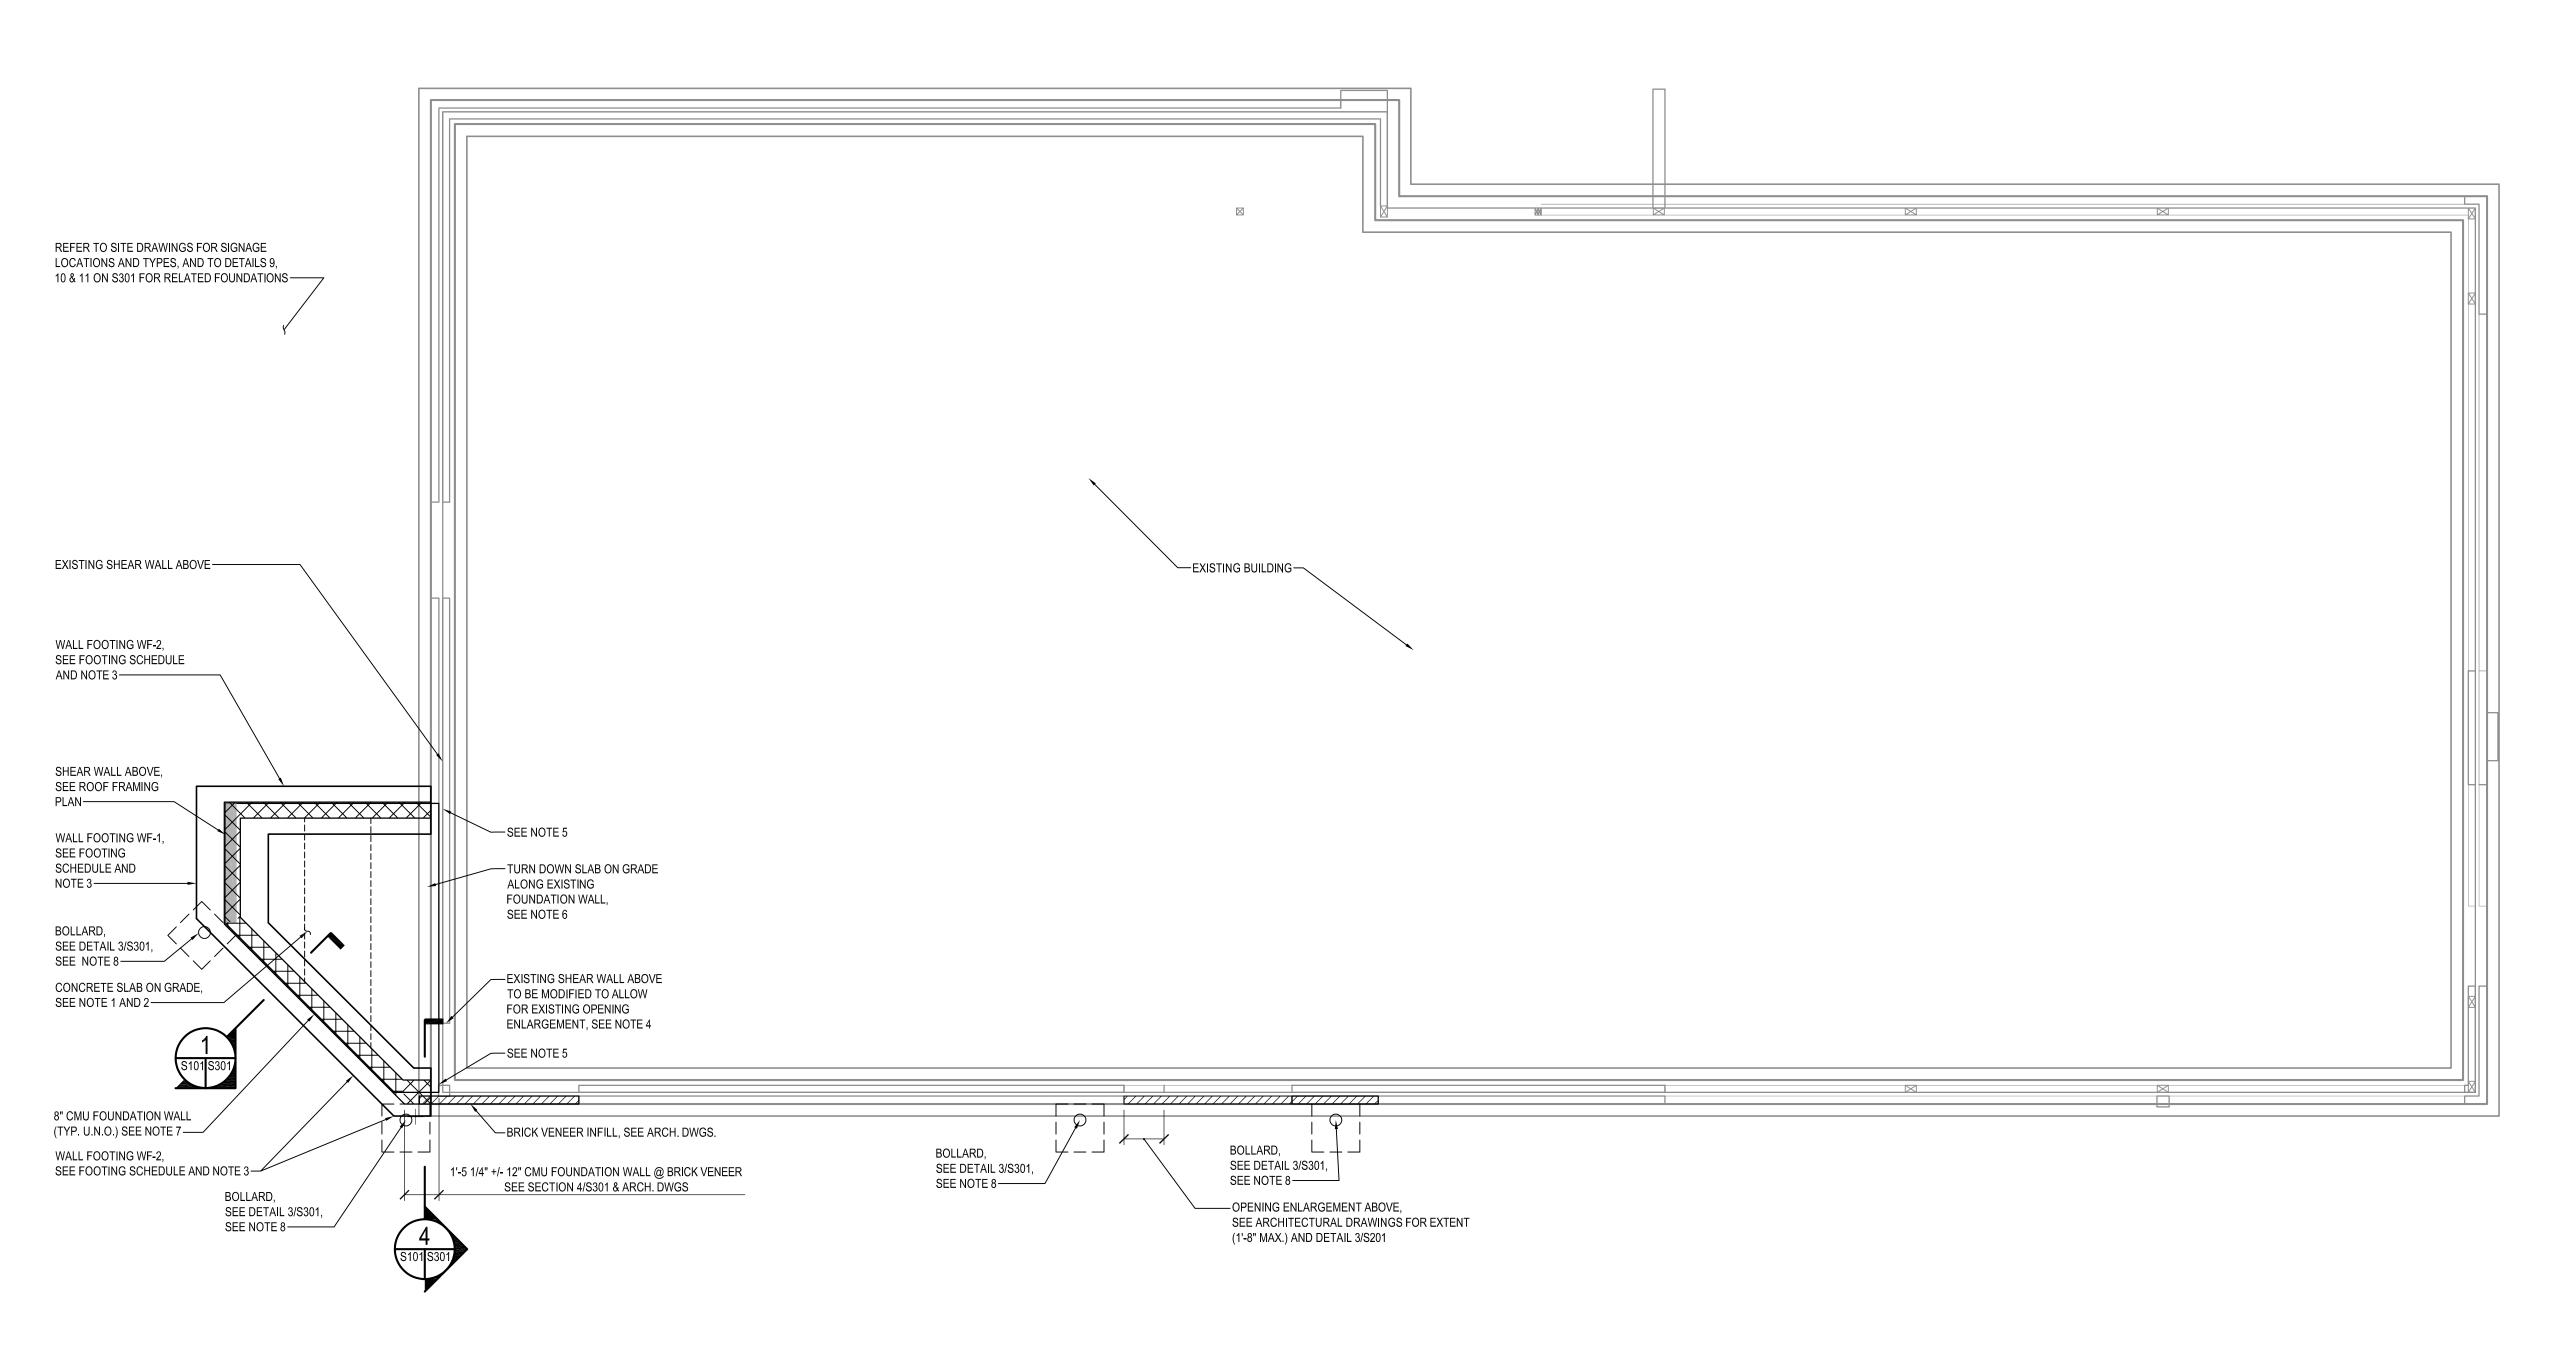



FOUNDATION PLAN NOTES:

- 1. FINISH FLOOR ELEVATION TO MATCH EXISTING, SEE ARCH. DWGS.
- 2. CONCRETE SLAB ON GRADE SHALL BE 5" CONCRETE SLAB REINFORCED W/ 6x6-W2.9xW2.9 WWF PLACED OVER 4" THICK LAYER OF #57 STONE & 10 MIL VAPOR BARRIER.
- 3. BOTTOM OF FOOTING TO MATCH BOTTOM OF EXISTING ADJACENT FOOTINGS OR TO BE 2'-6" MIN. BELOW GRADE, WHICHEVER IS GREATER. IF BOTTOM OF EXISTING FOOTING IS FOUND TO BE LOCATED AT AN ELEVATION LESSER THAN 2'-6" BELOW GRADE, UNDERPINNING OF EXISTING FOOTING WILL BE REQUIRED.
- 4. RELOCATE EXISTING END WOOD STUDS, HOLDOWN AND ALL CONNECTED PARTS OF EXISTING SHEAR WALL TO ALLOW FOR EXISTING OPENING ENLARGMENT (SEE ARCH. DWGS FOR EXTENT (MAX. 6-1/2" WIDTH INCREASE) AND ADDITIONAL INFORMATION), USE 5/8" DIAMETER ASTM F1554 GR 36 THREADED ROD W/ HIT-RE 500 V3 ADHESIVE W/ 6" MIN. EMBEDMENT DEPTH IN EXISTING CONCRETE @ RELOCATED HOLDOWN. MODIFY EXISTING PLYWOOD SHEATHING AND RECONNECT IT TO RELOCATED END STUDS W/ 10d NAILS @ 6" O/C.
- 5. SEE DETAIL 8/S301 FOR NEW FOOTING AT EXISTING WALL, DETAIL 2/S301 FOR CONNECTION BETWEEN EXISTING AND NEW CMU WALLS AND DETAIL 7/S301 FOR TYPICAL REINFORCED MASONRY CONSTRUCTION.
- 6. TURN DOWN SLAB ON GRADE TO TOP OF EXISTING CMU LEDGE AT INTERFACE WITH EXISTING SLAB / FOUNDATION WALL. ADDITIONAL REINFORCEMENT TO BE #4 @ 24" O/C L-SHAPED BARS, 24" MIN. HORIZONTAL LENGTH, VERTICAL LENGTH TO BE COORDINATED WITH TOP ELEVATION OF EXISTING CMU LEDGE (VIF). PROVIDE 1/2" EXPANSION JOINT MATERIAL @ INTERFACE W/ EXISTING SLAB.
- 7. SEE SECTION 1/S301 FOR CMU FOUNDATION WALL INFORMATION AND DETAIL 7/S301 FOR TYPICAL REINFORCED MASONRY CONSTRUCTION.
- 8. COORDINATE LOCATION OF BOLLARDS WITH ARCHITECTURAL AND SITE DRAWINGS, EXISTING BUILDING FOUNDATIONS, WALLS, ETC. MUST NOT BE DEMOLISHED.
- 9. SEE ARCH. DRAWINGS FOR DIMENSIONS AND ELEVATIONS NOT SHOWN.

WALL FOOTING SCHEDULE						
MARK	SIZE		REINFORCEMENT			
	DEPTH	WIDTH	LONGITUDINAL	TRANSVERSAL		
WF-1	12"	3'-0"	(4) #5 CONT.	#5 @ 24" O/C		
WF-2	12"	2'-0"	(3) #5 CONT.	#5 @ 24" O/C		

REVISION						
DATE						
NO.						
	ANI, LLC	4D 21286		- >	OW ®	





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FOUNDATION PLAN - BURGER TERATIONS .


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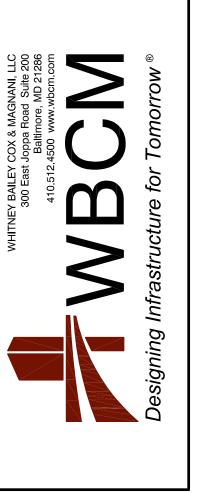
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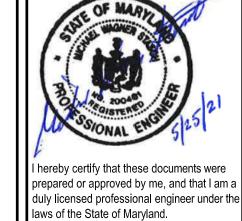
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CAUTION:



NO. DATE REVISION BY



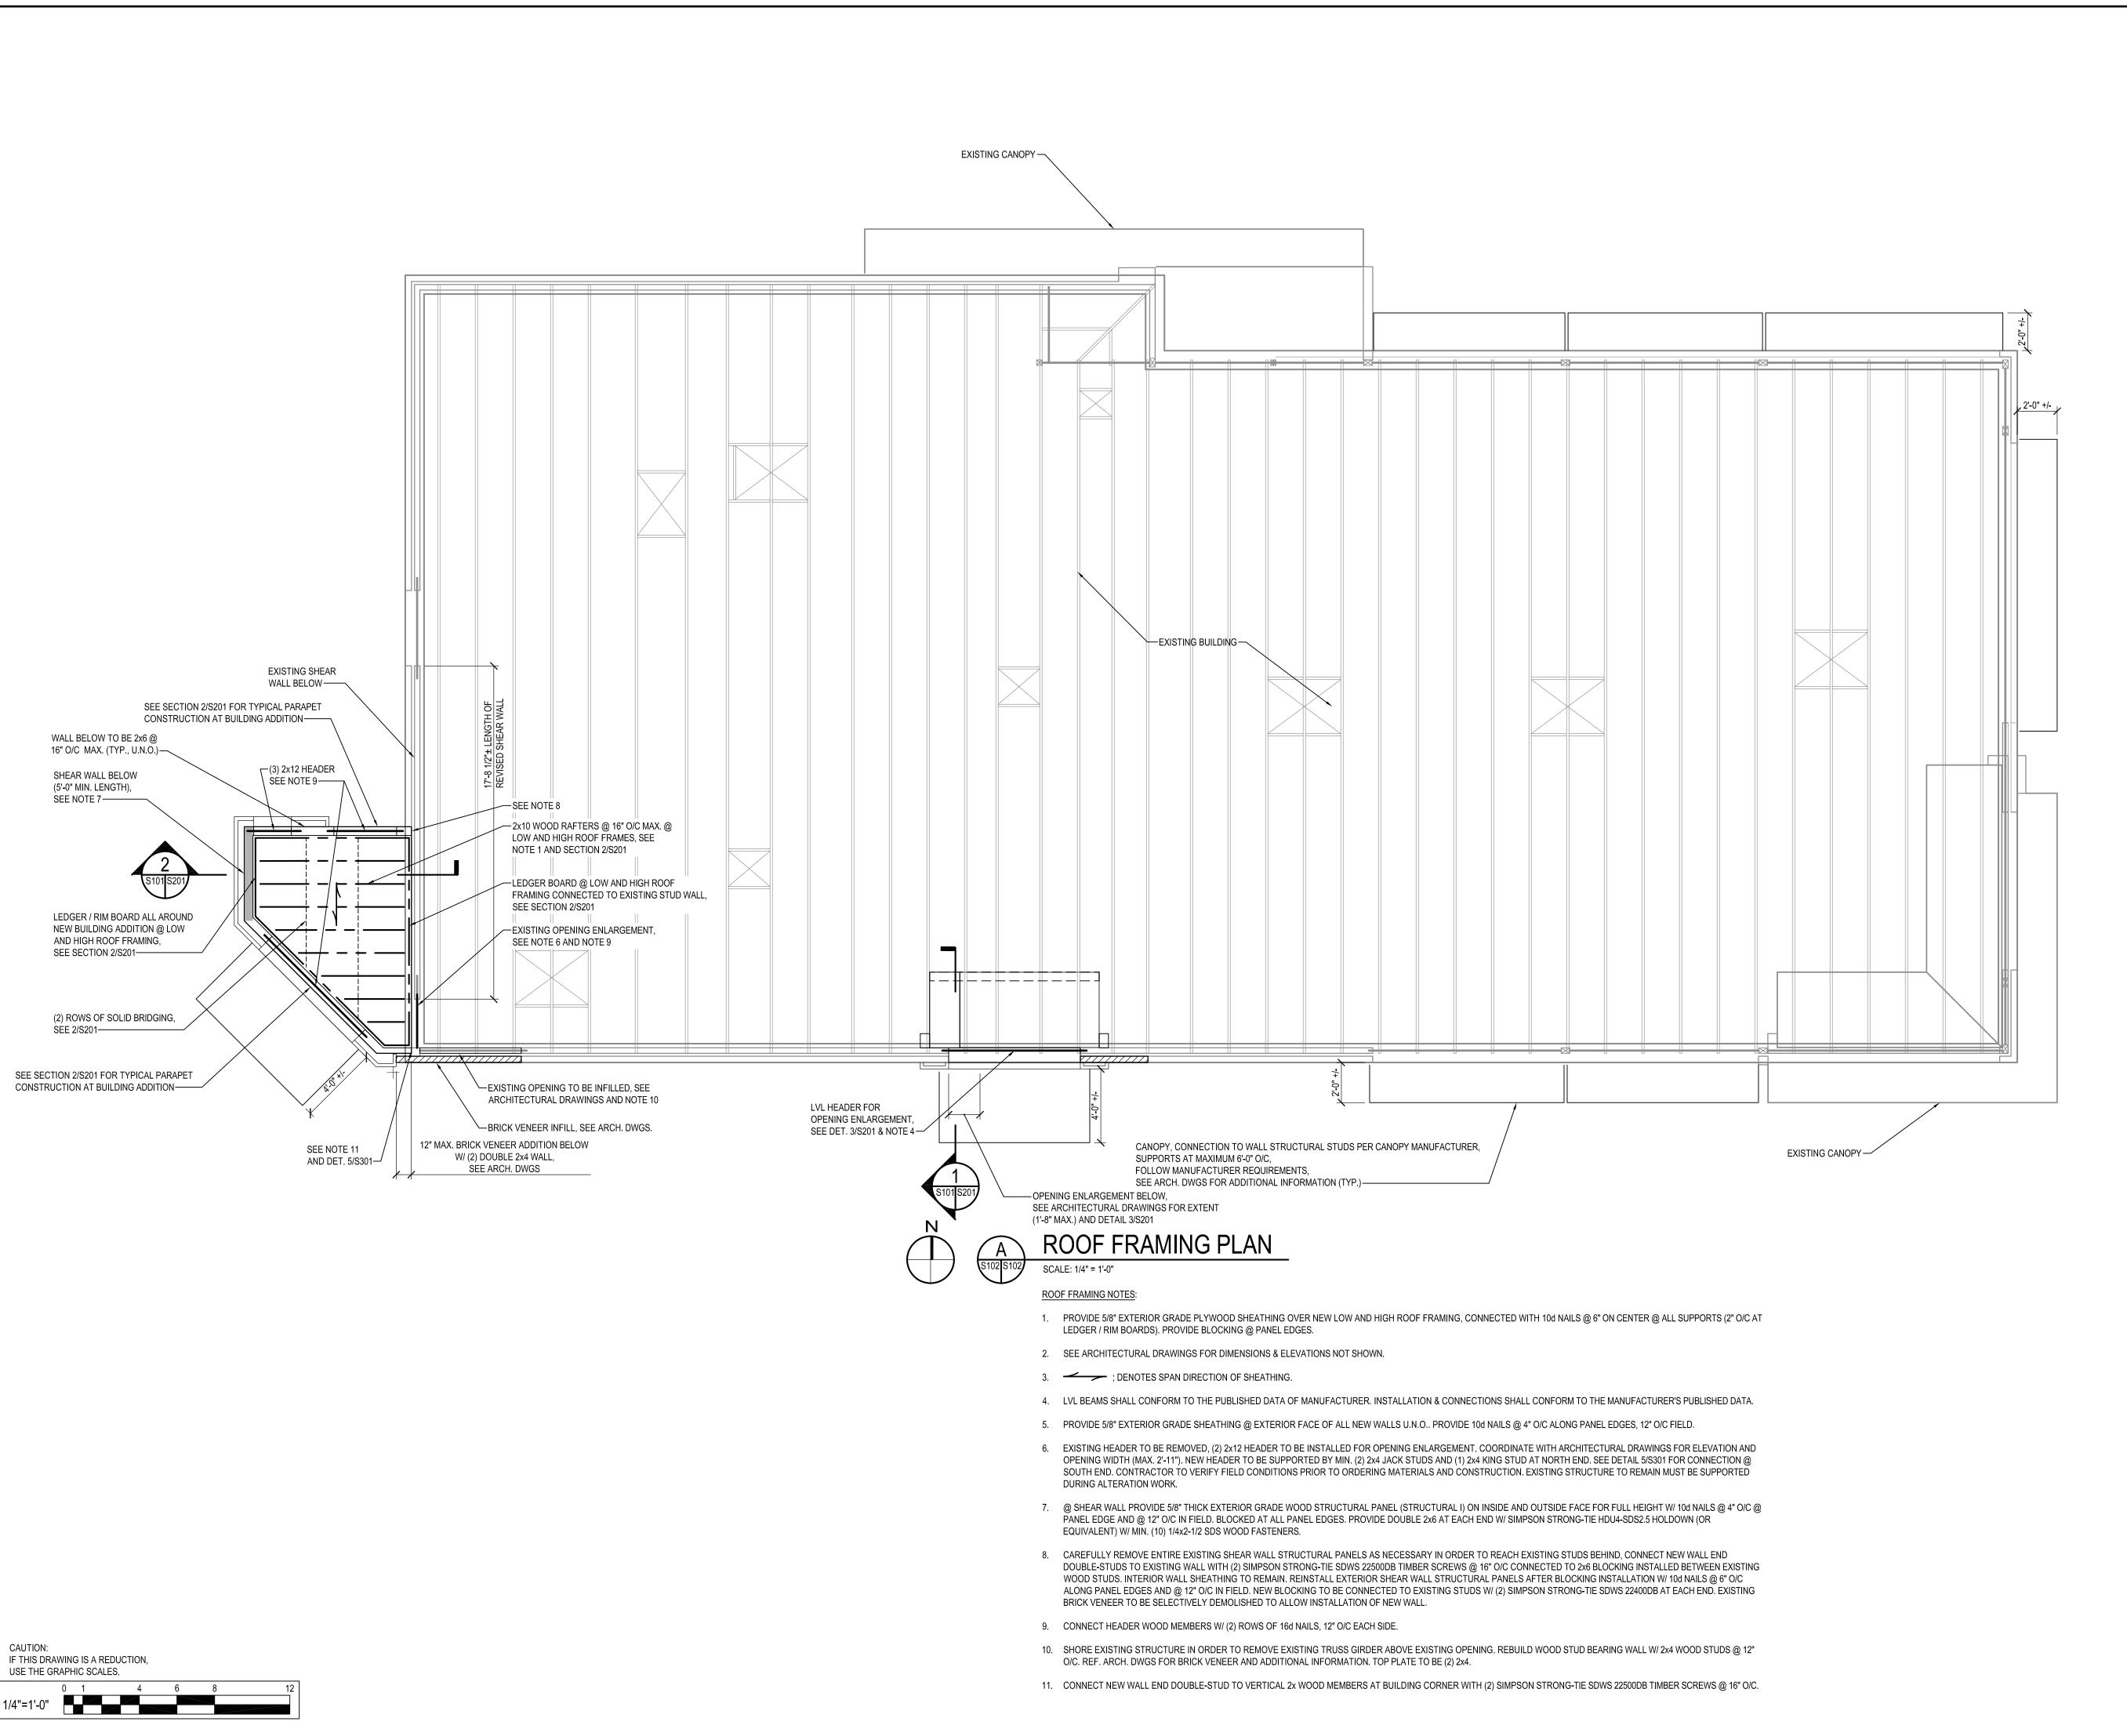


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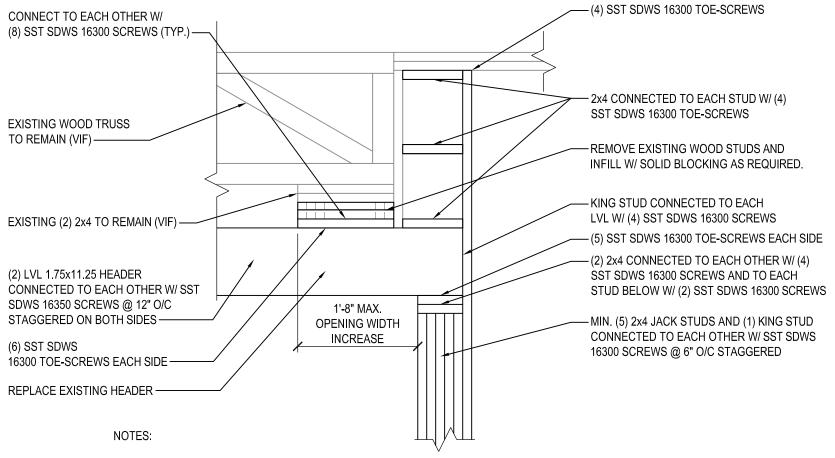
ROOF FRAMING PLAN

ERATIONS - BURGER KING # 9571

DESIGNED:	FC
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CHECKED:	MWS
SCALE:	AS NOTED
DATE:	05/25/2021
PROJECT:	2018.0375.04.0
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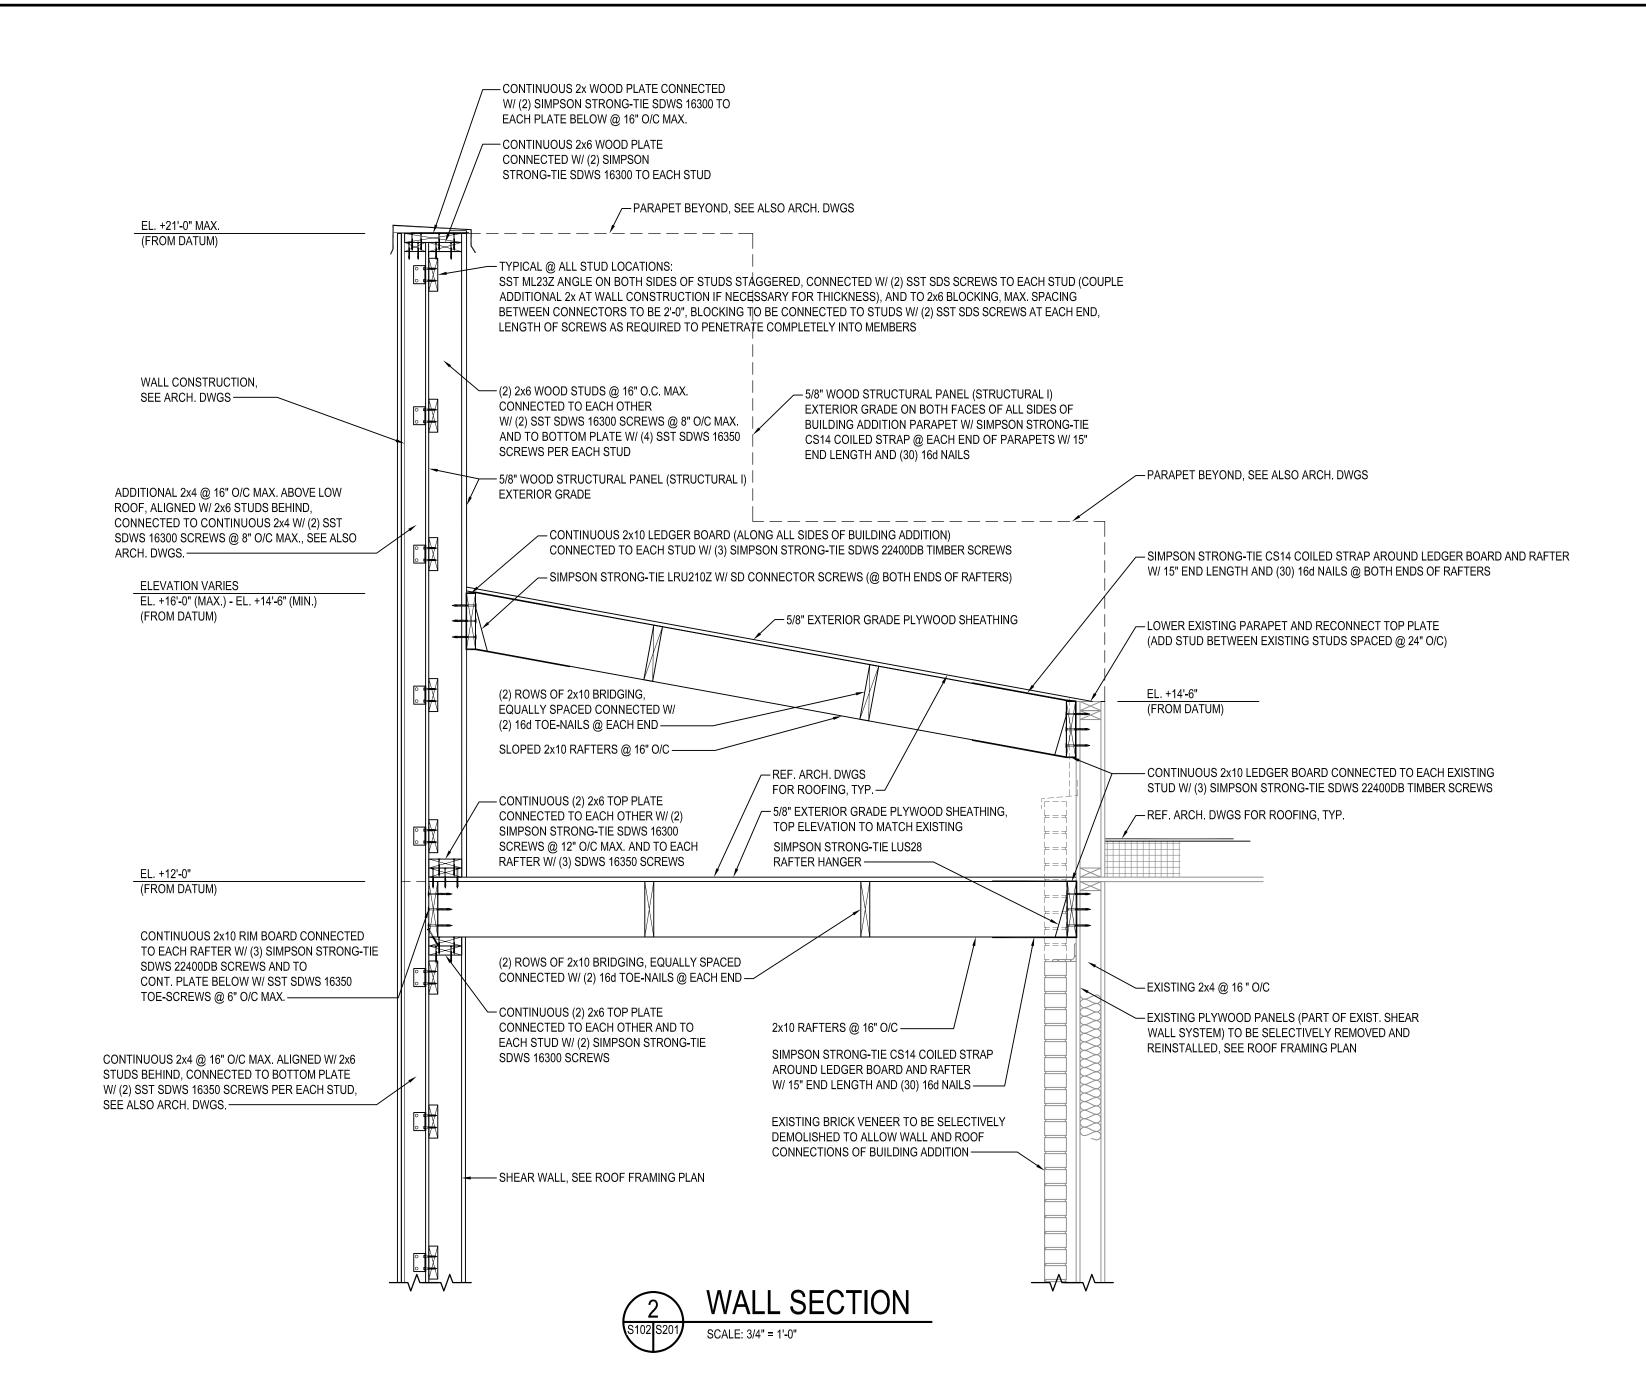
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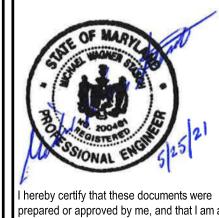




- DETAIL DESIGN IS BASED ON EXISTING STRUCTURAL DRAWINGS. FIELD CONDITIONS MAY BE DIFFER AND MUST BE VERIFIED BY CONTRACTOR PRIOR TO ORDER MATERIALS AND CONSTRUCTION.
- EXISTING STRUCTURE TO REMAIN MUST BE SUPPORTED DURING ALTERATION WORK.
- DETAIL DESIGN CONCEPT TO BE USED ALSO AT OPPOSITE END TO SUPPORT NEW LVL HEADER
- REFER TO THE ARCHITECTURAL DRAWINGS FOR REQUIRED OPENING WIDTH AND HEIGHT.

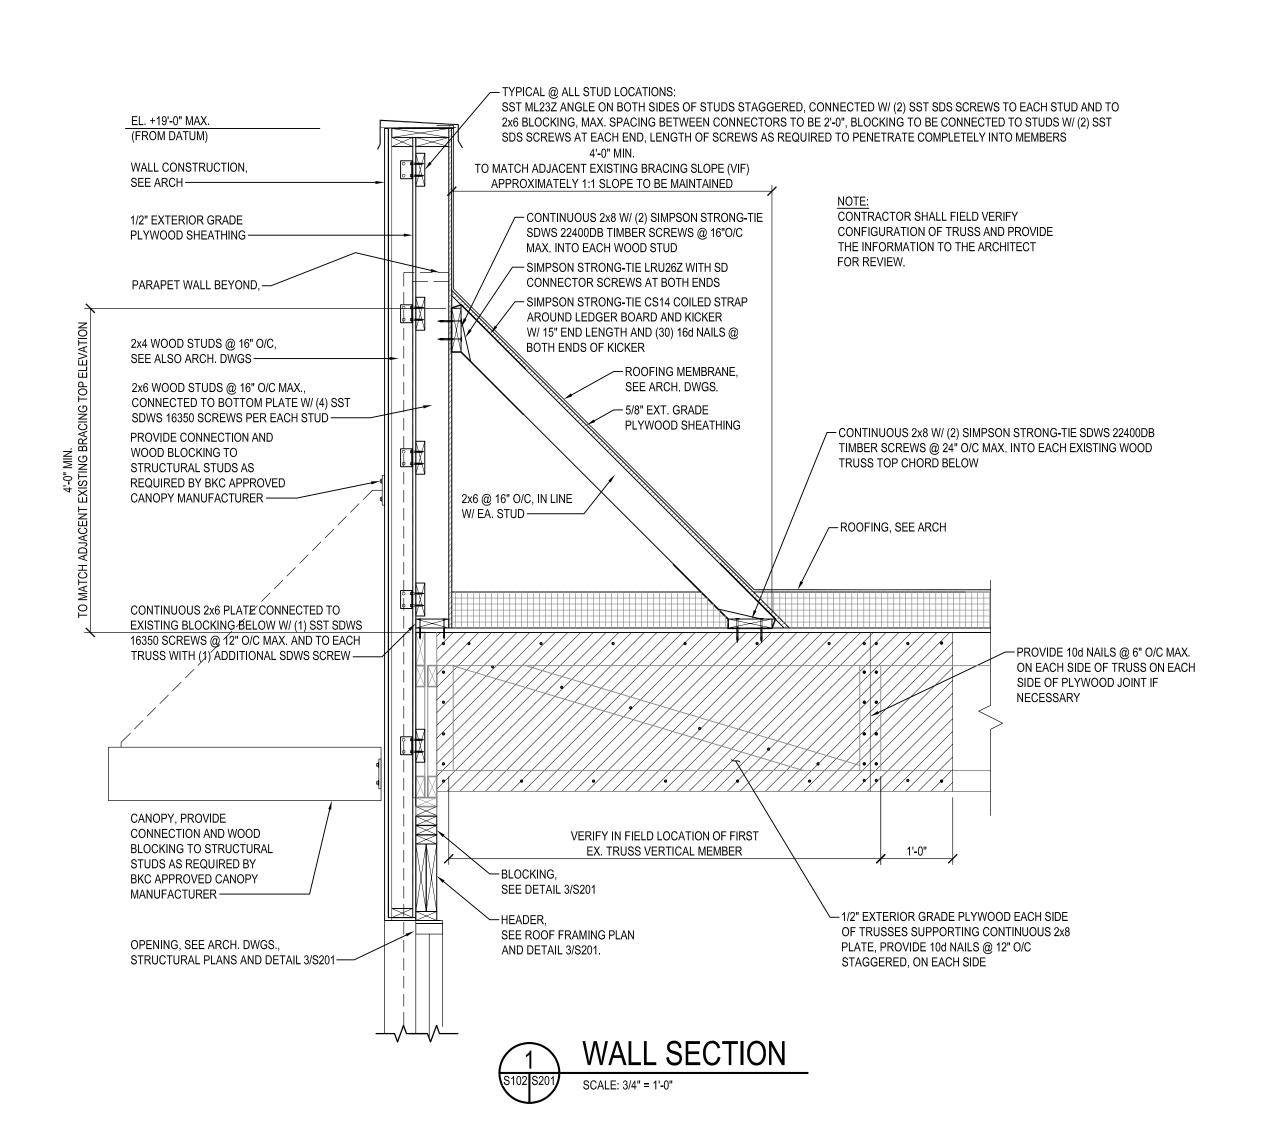





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BURGER SECTIONS RATIONS

DESIGNED: DRAWN: CG CHECKED: MWS SCALE AS NOTED 05/25/2021 PROJECT: 2018.0375.04.0


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DRAWING:

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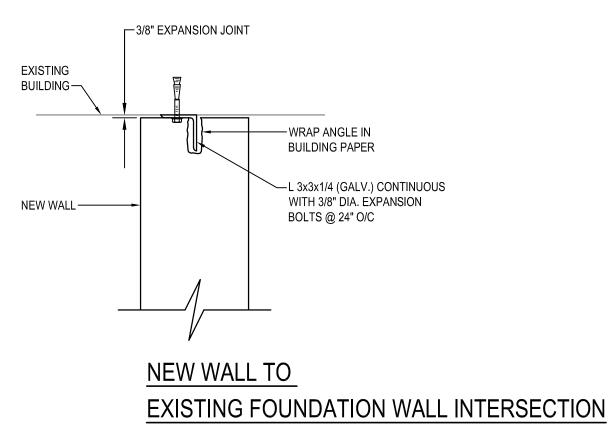
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EMBEDMENT DEPTH AND HILTI


HIT-RE 500 V3 ADHESIVE

SCALE: 3/4" = 1'-0"

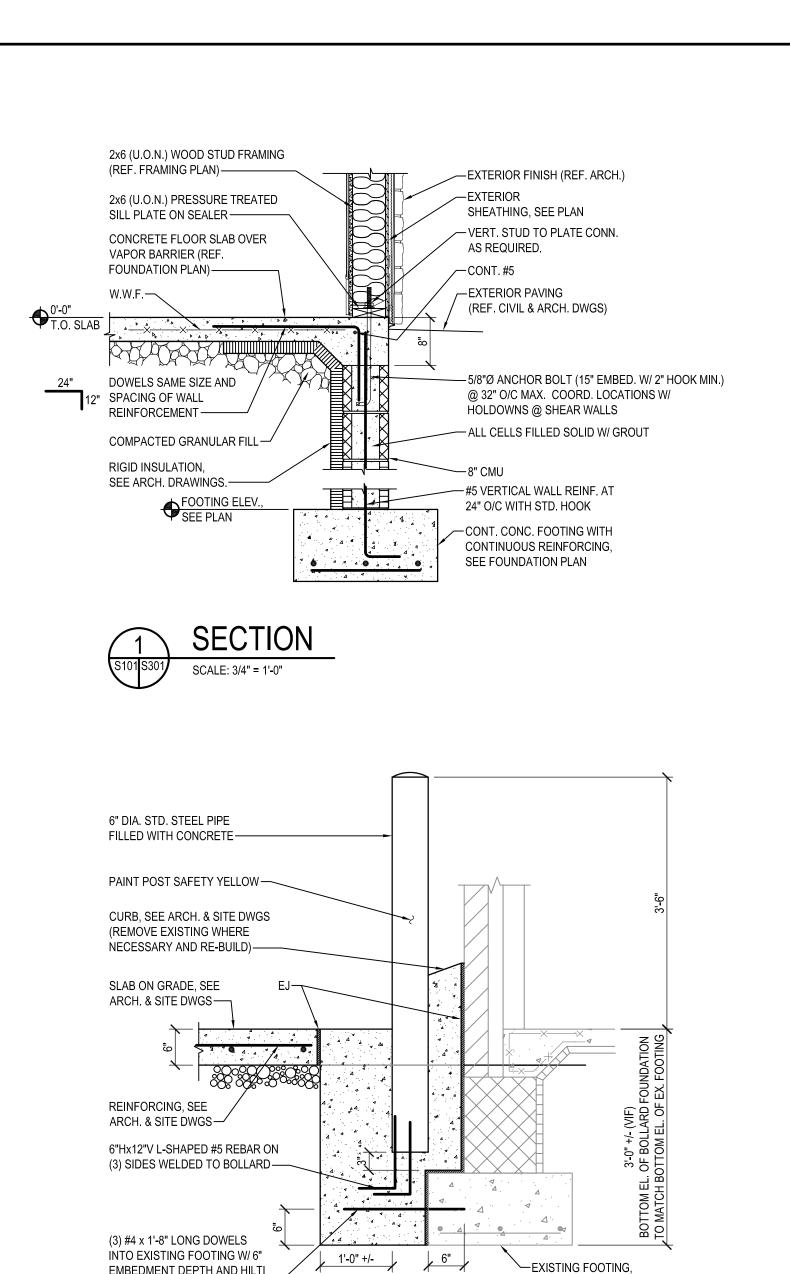

**UNIT & CANOPY FOOTING DETAIL** 

SCALE: 1" = 1'-0"

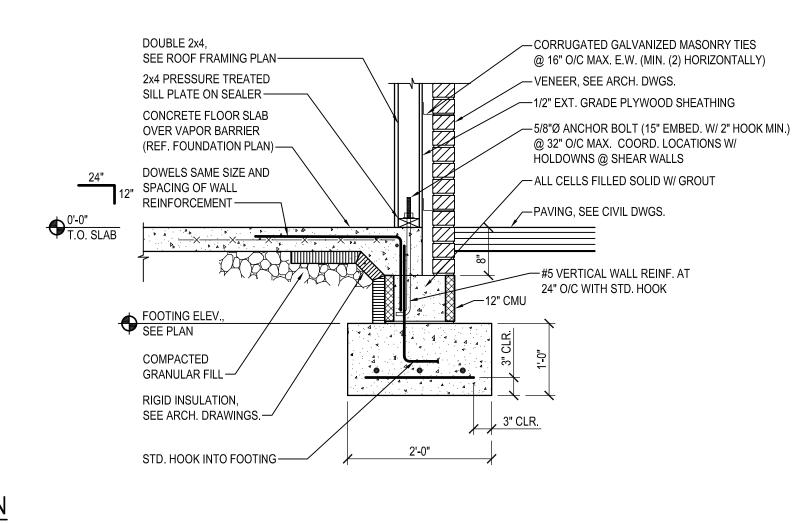

SECTION

VERTICAL STEEL-LAP MINIMUM OF 48 BAR DIAMETERS AT SPLICES. HOLD IN POSITION WITH WIRE TIES @ 5'-0" O/C. STEEL IS TO BE IN


PLACE PRIOR TO PLACING GROUT.-

 $\stackrel{\prime}{-}$  FOOTING OR TOP OF WALL @

PREVIOUS GROUT POUR.


WIRE TIE,

TYPICAL —

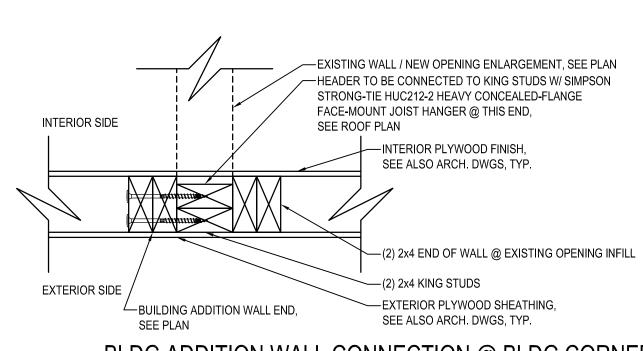


BLDG ADDITION WALL CONNECTION @ BLDG CORNER



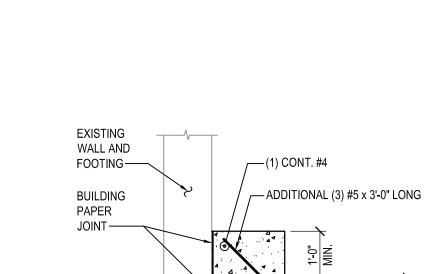

VERT. REINFORCEMENT PRIOR TO PROVIDING CLOSURE TO RESIST

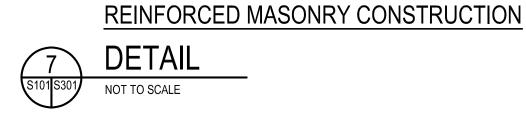

GROUT PRESSURE.

-STOP GROUT LIFT 1 1/2"

FROM TOP OF BLOCK UNIT.

-CONSOLIDATE EACH LIFT BY MECH. VIBRATION AND

CELLS CONTAINING STEEL ARE FILLED SOLIDLY WITH

CONTINUOUS CAVITY, FREE OF MORTAR DROPPINGS,

AND AT LEAST 2 1/2" x 3" IN SIZE. PLACE GROUT IN

LIFTS NOT EXCEEDING 5 FEET. MAXIMUM GROUT

POUR HEIGHT SHALL BE 12 FEET.

-WHEN GROUT POUR EXCEEDS 5' IN HEIGHT, PROVIDE CLEANOUTS IN THE BOTTOM COURSE OF MASONRY IN EACH GROUT POUR @ EACH

VERTICAL BAR. THE SIZE OF THE CLEAN OUT OPENINGS SHALL BE OF

SUFFICIENT SIZE TO PERMIT REMOVAL OF DEBRIS. THE MIN, OPENING

DIMENSION SHALL BE 3". REMOVE ALL MORTAR DROPPINGS & INSPECT

-UNLESS WALL IS FULLY GROUTED, PLACE MORTAR ON CROSS WEBS ADJACENT TO CELLS WHICH WILL BE

GROUTED TO PREVENT LEAKAGE.

WATER LOSS AND SETTLEMENT HAS OCCURED.

GROUT. VERTICAL CELLS SHOULD PROVIDE A


RECONSOLIDATE BY MECH. VIBRATION AFTER INITIAL






1/2" EXPANSION

JOINT MATERIAL -

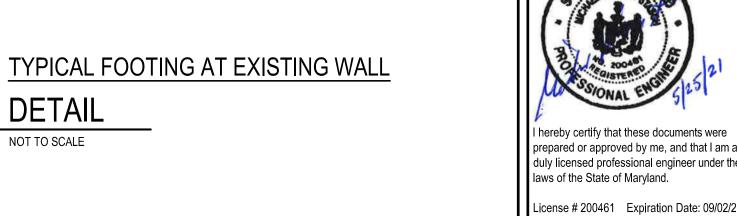


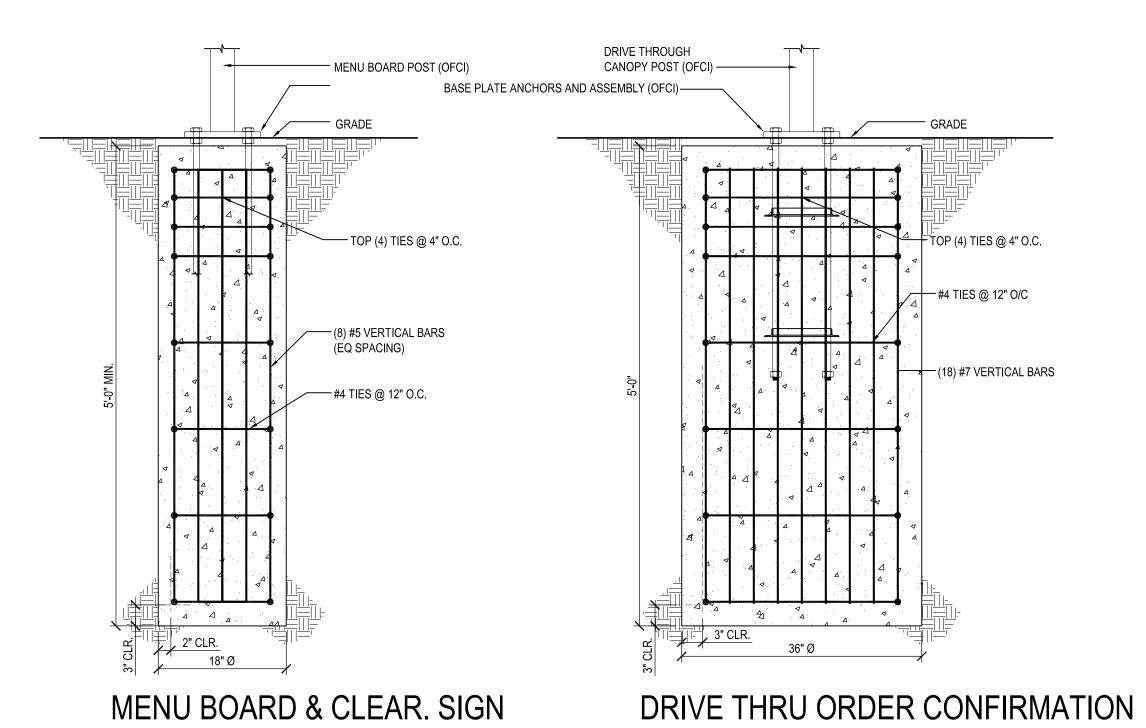

FOUNDATION WALL AND WALL

BOLLARD DETAIL AT EXISTING FOOTING

FOOTING DETAIL

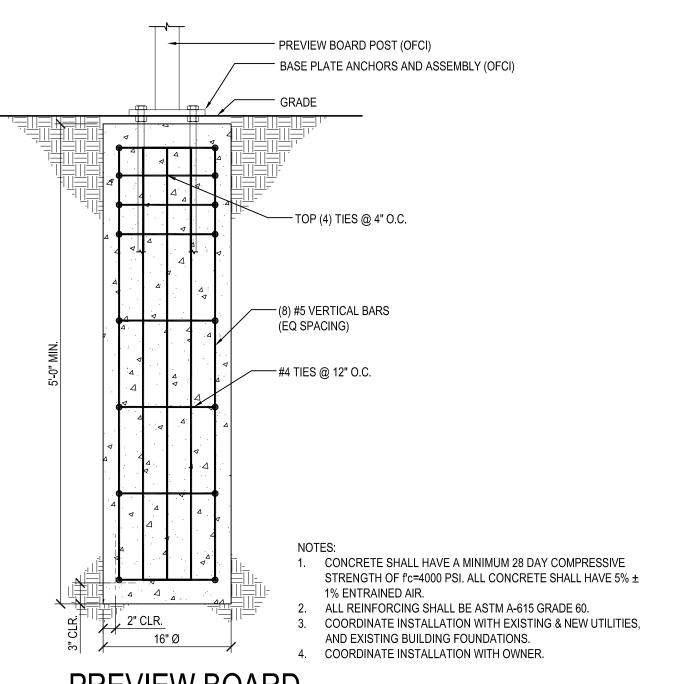

PREVIEW BOARD **FOOTING DETAIL** 

l	DESIGNED:	FC
l	DRAWN:	CG
l	CHECKED:	MWS
l	SCALE:	AS NOTED
l	DATE:	05/25/2021
l	PROJECT:	2018.0375.04.0
	DRAWING:	

- BURGER

TERATIONS

S301

05-25-2021 PERMIT SUBMISSION

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CAUTION:

IF THIS DRAWING IS A REDUCTION,

USE THE GRAPHIC SCALES.