

BURGER KING RESTAURANT # 9571

2110 EMMORTON ROAD BEL AIR, MARYLAND 21015

DISTRICT-01 ACCOUNT NUMBER - 049801 GRID- 0002D PARCEL-0220 SUBDIVISION-0000 ZONING - B3 (GENERAL BUSINESS)

DWG. NO.	SHEET	CUEST TITLE	DWG.	SHEET NO.	CUEST TITLE		
NO. ARCHITEC	NO.	SHEET TITLE	NO. ELECTRICA		SHEET TITLE		
G101	1 1	COVERSHEET, CODE ANALYSIS, ABBREVIATIONS & SYMBOLS	ED101				
AD101	2	DEMOLITION FLOOR PLAN	E101	27	LIGHTING FIXTURE SCHEDULE		
AD101 AD102	3	DEMOLITION FLOOR FLAN DEMOLITION CEILING PLAN	E101	28	LIGHTING PLAN		
AD102 AD103	4	DEMOLITION CEILING FLAN DEMOLITION ROOF PLAN	E102	29	POWER PLAN		
AD103 AD201	5	EXISTING BUILDING ELEVATIONS	E103	30	PANEL SCHEDULE		
A101	6	NEW WORK FLOOR PLAN	E104	31	ELECTRICAL SITE PLAN		
A101 A102	7	NEW WORK FLOOR PLAN	E102	31	ELECTRICAL SITE PLAN		
A102 A103	8	REFLECTED CEILING PEAN					
A103 A104	9	NEW WORK ROOF PLAN					
A104 A201	10	EXTERIOR BUILDING ELEVATIONS					
A202	11	EXTERIOR FINISH SCHEDULE					
A301	12	WALL SECTIONS					
A302	13	WALL SECTIONS					
A303	14	WALL SECTIONS					
A304	15	WALL SECTIONS					
A501	16	MISCELLANEOUS DETAILS					
A601	17	DOOR SCHEDULE AND DETAILS					
A701	18	MANUFACTURERS AND SUPPLIERS					
STRUCTUR							
S001	19	GENERAL NOTES					
S101	20	FOUNDATION PLAN					
S102	21	ROOF FRAMING PLAN					
S201	22	SECTIONS					
S301	23	SECTIONS					
MECHANIC	CAL						
MD101	24	MECHANICAL DEMOLITION					
M101	25	MECHANICAL PLAN					

EGRESS PLAN

KITCHEN

LONG, LENGTH or ANGLE

LAMINATE (D)

LAVATORY LINEAR FEET

LINEAR FEET

LIQUID SOAP DISPENSER

MATERIAL MAXIMUM

MECHANICAL **MANUFACTURER**

MINIMUM, MINUTE

MISCELLANEOUS

MOLDING

MASONRY OPENING

MODIFY, MODULAR

METAL THRESHOLD

MOUNTED

NORTH

NOT APPLICABLE

NOT IN CONTRACT

NOT TO SCALE

ON CENTER

OUTSIDE DIAMETER

OFFICE

OVERHEAD

OPENING

OPPOSITE

PERPENDICULAR

PLASTIC LAMINATE

PLATE

PLYWOOD

POWDER ACTUATED FASTENER

PRE-ENGINEERED

PRFFABRICATE

PAINT, PRESSURE TREATED

PAPER TOWEL DISPENSER

QUARRY TILE

RISER

RADIATOR or RADIUS

ROOF DRAIN

REFERENCE

REFRIGERATOR

REINFORCE (ING) (ED) REQUIRED REVISION

ROOM **ROUGH OPENING**

SANITARY NAPKIN DISPENSER

SCHEDULE

SECTION

SHEATHING

SILICONIZED MASONRY UNIT

SPECIFICATION

SQUARE

SQUARE FOOT

SQUARE YARD

STAIN (ED)

STAINLESS STEEL

STEEL

STRUCTURE (AL)

SYMBOL

SYSTEM

NUMBER

MECH

MISC

NO or #

PLYWD

PREFAB

RFINE

SECT


SPEC

SQ FT or SF

SYM


SQ YD or SY

MLDG

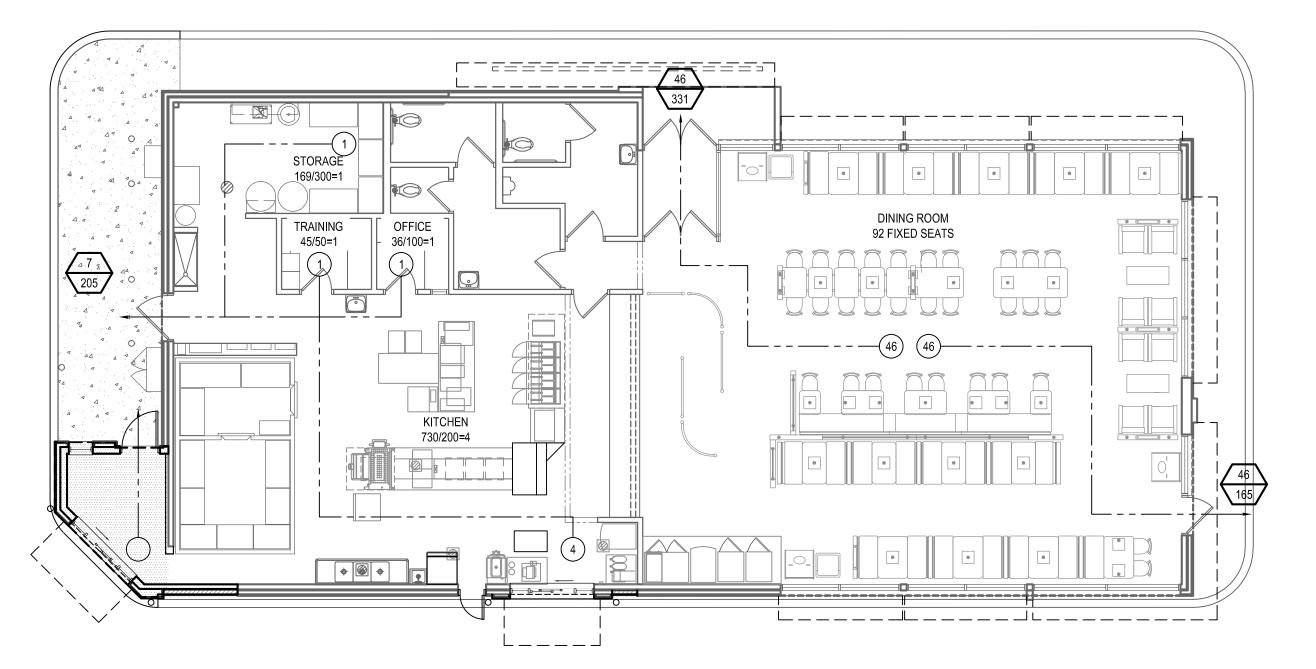

OFFICE - ROOM NAME/FUNCTION 124/100=2 TOTAL # OF OCC. -----IBC OCC AREA

EGRESS DOOR SYBMOL

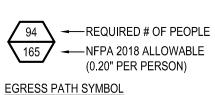


—ROOM SIZE (SF)


---PATH OF EGRESS ----# OF OCCUPANTS FROM EACH SPACE

THE EGRESS CAPACITY OF 3'-0" SINGLE DOORS HAVE BEEN CALCULATED USING 33" AS AN ACTUAL CLEAR WIDTH 33"/0.20" = 165 PERSONS

- THE EGRESS CAPACITY OF 3'-8" SINGLE DOORS HAVE BEEN CALCULATED USING 41" AS AN ACTUAL CLEAR WIDTH 41"/0.20" = 205 PERSONS
- THE EGRESS CAPACITY OF 6'-0" DOUBLE DOORS HAVE BEEN CALCULATED USING 67.25" AS AN ACTUAL CLEAR WIDTH.
- ALL OF THE ABOVE CALCULATIONS ARE BASED ON NFPA 2018

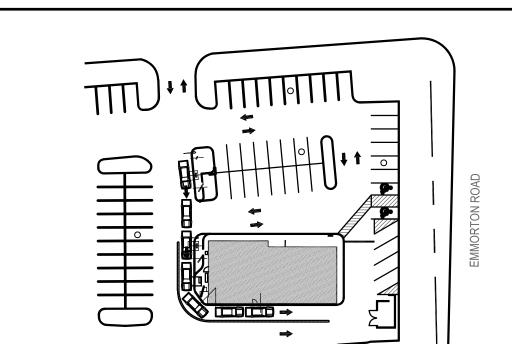

VICINITY MAP

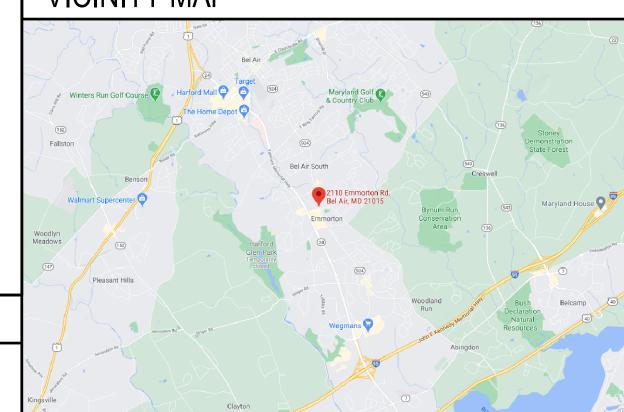

ALL WORK ASSOCIATED WITH THIS PROJECT SHALL COMPLY WITH THE FOLLOWING AS AMENDED BY

SUBCONTRACTORS & MATERIAL VENDORS SHALL COMPLY WITH CODES IDENTIFIED IN THIS CODE

2018 INTERNATIONAL BUILDING CODE

2018 INTERNATIONAL ENERGY CODE

PREVENTION CODE, COMAR 29.06.01

2018 NFPA 101, STATE OF MARYLAND FIRE

2018 INTERNATIONAL MECHANICAL CODE

2019 NFPA 72 NATIONAL FIRE ALARM CODE

2018 INTERNATIONAL PLUMBING CODE

2018 INTERNATIONAL FUEL GAS CODE

2020 NATIONAL ELECTRICAL CODE

2018 EDITION NFPA 1

2018 INTERNATIONAL EXISTING BUILDING CODE

2010 ADA STANDARDS FOR ACCESSIBILITY DESIGN

MARYLAND ACCESSIBILITY CODE, COMAR 09.12.53

HARFORD COUNTY AND THE STATE OF MARYLAND. GENERAL CONTRACTOR AND ALL

hereby certify that these documents were repared or approved by me, and that I am duly licensed professional architect under the aws of the State of Maryland.

icense # 6140 Expiration Date: 08/21/202


KING BURGER **TERATIONS**

COVERSHEET, CODE ABBREVIATIONS &

DESIGNED:	JMM
DRAWN:	JMM
CHECKED:	SCB
SCALE:	AS NOTED
DATE:	04/21/2021
PROJECT:	2018.0375.04.0
DRAWING:	

G101

MATERIAL

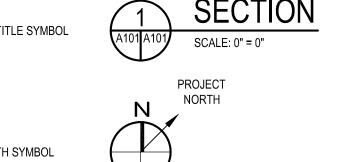

FLOOR LEVEL ELEV. 00.00 _____ ROOM NAME ROOM NAME & NUMBER

TAG SYMBOL DOOR TAG SYMBOL

EQUIPMENT & FINISH

WALL TYPE TAG SYMBOL

TAG SYMBOL

REVISION TAG &

CLOUD SYMBOL

₩#**>** WINDOW TAG SYMBOL KEYNOTE TAG SYMBOL

⟨P-##⟩— X —

CONCRETE SAND OR GROUT RIGID INSULATION

& SHIMS

& FURRING

ENGINEERED WOOD

INTERIOR ELEVATION SYMBOL WITH MULTIPLE VIEWS WALL SECTION SYMBOL BUILDING SECTION SYMBOL

ENLARGED

DETAIL SYMBOL

DETAIL SYMBOLS

-INDICATES DIRECTION OF **CUTTING PLANE** INDICATES DIRECTION OF CUTTING PLANE

SECTION

(###-#)

(#)--

✓ ✓ ✓ METAL DECKING

PLYWOOD \leftarrow

PLYWOOD (SMALL SCALE)

CRUSHED GRAVEL

COMPACT FILL EARTH

NATURAL CUT STONE

WOOD, BLOCKING

WOOD, FRAMING

GENERAL NOTE

BUILDING CODE -

ENERGY CODE -

5. LIFE SAFETY CODE -

6. ACCESSIBILITY -

MECHANICAL -

11. FIRE ALARM CODE -

PLUMBING -

9. ELECTRICAL -

EXISTING BUILDING CODE -

FIRE PROTECTION CODE -

APPLICABLE CODES

1. ALL PLAN DIMENSIONS ARE TO FACE OF GWB OR EXISTING SHELL, VERIFY IN FIELD. CONTRACTOR TO VERIFY ALL DIMENSIONS PRIOR TO COMMENCEMENT TO CONSTRUCTION, AND NOTIFY ARCHITECT OF ANY DISCREPANCIES. DO NOT SCALE DRAWINGS. USE WRITTEN DIMENSIONS ONLY.

ALL DIMENSIONS, NOTES, FINISHES AND FIXTURES SHOWN ON TYPICAL FLOOR PLANS, SECTIONS, OR DETAILS SHALL APPLY TO ALL SIMILAR, SYMMETRICAL OR OPPOSITE HAND PLANS, SECTIONS OR DETAILS.

ALL DOOR JAMBS SHALL BE LOCATED 2" FROM INTERSECTING WALL, UNLESS NOTED CONTRACTOR TO PROVIDE AND INSTALL EXIT SIGNS AND EMERGENCY LIGHTING AS REQUIRED

BY APPLICABLE CODES. COORDINATE WITH ELECTRICAL DRAWINGS. GENERAL CONTRACTOR TO VERIFY ALL EXISTING UTILITIES

12. AUTOMATIC SPRINKLER SYSTEMS CODE - 2019 NFPA 13

 A. GAS SERVICE B. DOMESTIC WATER C. SERVICE SANITARY

D. SEWER SERVICE E. ELECTRIC POWER SOURCE

8. COORDINATE WITH ALL EXISTING AND PROPOSED FLOOR WALL AND ROOF PENETRATIONS. 9. COORDINATE ALL NEW WORK WITH EXISTING CONDITIONS AND LANDLORD WORK.

04-21-2021 PERMIT SUBMISSION

TREAD FLASH FLASHING FLR FLOOR **TELEPHONE** FINISHED OPENING **TOILET TISSUE DISPENSER** THICK FOOTING FEET, FIRE TREATED, FOOT TONGUE AND GROOVE FURN FURNISH, FURNITURE TOP OF STEEL FUR TOP OF FOOTING FURRING TREATED GALVANIC, GALVANIZED GALV TRIPLE TURN DOWN SLAB GRAB BAR GLASS TYPICAL GLZ GLAZING GWB GYPSUM WALL BOARD UNDERWRITERS LABORATORIES GYP UNFIN UNFINISHED GYPSUM UNLESS NOTED OTHERWISE UNO HANDICAP VCJ VERTICAL CONTROL JOINT HORIZONTAL CONTROL JOINT HDPE HDW HIGH DENSITY POLYETHYLENE VINYL COMPOSITION TILE VERT HARDWARE VERTICAL **HOLLOW CORE** VERIFY IN FIELD HOLLOW METAL WEST, WIDE HORIZ HT HORIZONTAL HEIGHT WATER RESISTANT INSIDE DIAMETER WATERPROOF (ING) INSUL WATER CLOSET INSULATION INTER INTERMEDIATE WOOD WATER HEATER INTERIOR WELDED WIRE FABRIC **JANITOR** WEIGHT IOINT CODE INFORMATION INTERNATIONAL EXISTING BUILDING CODE **ALTERATION - LEVEL 2** 2018 EDITION, CHAPTER 8 FIRE PROTECTION THE EXISTING BUILDING IS CURRENTLY STATE OF MARYLAND FIRE NON-SPRINKLERED (NO CHANGE) PREVENTION CODE, COMAR 29.06.01 USE AND OCCUPANCY CLASSIFICATION ASSEMBLY USE - A-2' (NO CHANGE)

- ADDITIONAL INSTRUCTION -DETAIL DRAWING NUMBER DETAIL SYMBOL -SHEET NUMBER WHERE SECTION IS DRAWN -SHEET NUMBER WHERE SECTION IS TAKEN **ELEVATION SYMBOL** -INDICATES DIRECTION OF VIEWING PLANE

DRAWING TITLE SYMBOL

PLAN NORTH SYMBOL FLOOR LEVEL SYMBOL

CMU, CONCRETE

MASONRY UNIT

CAST STONE OR

PRECAST CONCRETE

TYPE 'V-B' (NO CHANGE)

1 STORY @ 40'-0" HIGH

1 STORY @ 21'-0 HIGH

1 STORY @ 21'-0 HIGH

92 ('A' USE) + 7 = 99 OCCUPANTS

6,000 SF

P:\2018\18037504\Drawings\01-Arch\2018037504 - G101 - Coversheet.dwg

(IBC 18-303.3)

(IBC 18 - TABLE 601)

(IBC 18 - TABLE 503)

OCCUPANT LOAD

(IBC 18 - TABLE 1004.1.2)

(NFPA 18 - TABLE 13.1.6)

CONSTRUCTION CLASSIFICATION

ALLOWABLE HEIGHT & BUILDING AREA

EXISTING HEIGHT AND BUILDING AREA

PROPOSED HEIGHT AND BUILDING AREA

ABBREVIATIONS

ADH

ADJ

ALUM

ARCH

BLDG

BLKG BLKHD

BOT

BOD

BUR

CHAN

CLR
CMU
COL
CONC
CONT
COORD
CPT
CT

CTR

DEMO

DWG

ELEV

EQ EQUIP

EQUIV

EXIST

EXP

FIXT

EXP BT

CU CU FT or CF

CU YD or CY

BLK

APPROX

ACCESSIBLE

ADHESIVE

ALTERNATE

ALUMINUM

ARCHITECT

BFAM

BEARING BELOW

BITUMINOUS

BUILDING

BLOCKING

BULKHEAD

BOTTOM

BOTTOM OF DECK

BOTTOM OF FOOTING

BUILT UP ROOFING

CORNER GUARD

CONTROL JOINT

CONCRETE MASONRY UNIT

CONTINUE or CONTINUOUS

DEMOLITION or DEMOLISH

DRINKING FOUNTAIN

CEILING

CLEAR

COLUMN

CONCRETE

COORDINATE

CARPET (ED)

CENTER

CUBIC FEET

CUBIC YARD

DEEP, DEPTH

DOUBLE

DIAMETER DIMENSION

DOWNSPOU^{*}

DRAWING

EACH

DISHWASHER

EXPANSION JOINT

ELECTRIC or ELECTRICAL

ELECTRIC WATER COOLER

FI FVATION

ELEVATION

ESTIMATE

EQUIPMENT

EQUIVALENT

EACH WAY

EXISTING

EXPOSED

EXPANSION BOLT

FLOOR DRAIN

FINISHED FLOOR

EXTERIOR, EXTERNAL

FIRE EXTINGUISHER

FIRE EXTINGUISHER

FIXTURE

FIRE EXTINGUISHER CABINET

DOWN

CERAMIC TILE

CENTER LINE

BLOCK

APPROXIMATE


ACOUSTICAL CEILING TILE

ABOVE FINISHED FLOOR

BABY CHANGING STATION


BELOW FINISHED FLOOP

ADJACENT, ADJOING, ADJUSTABLE

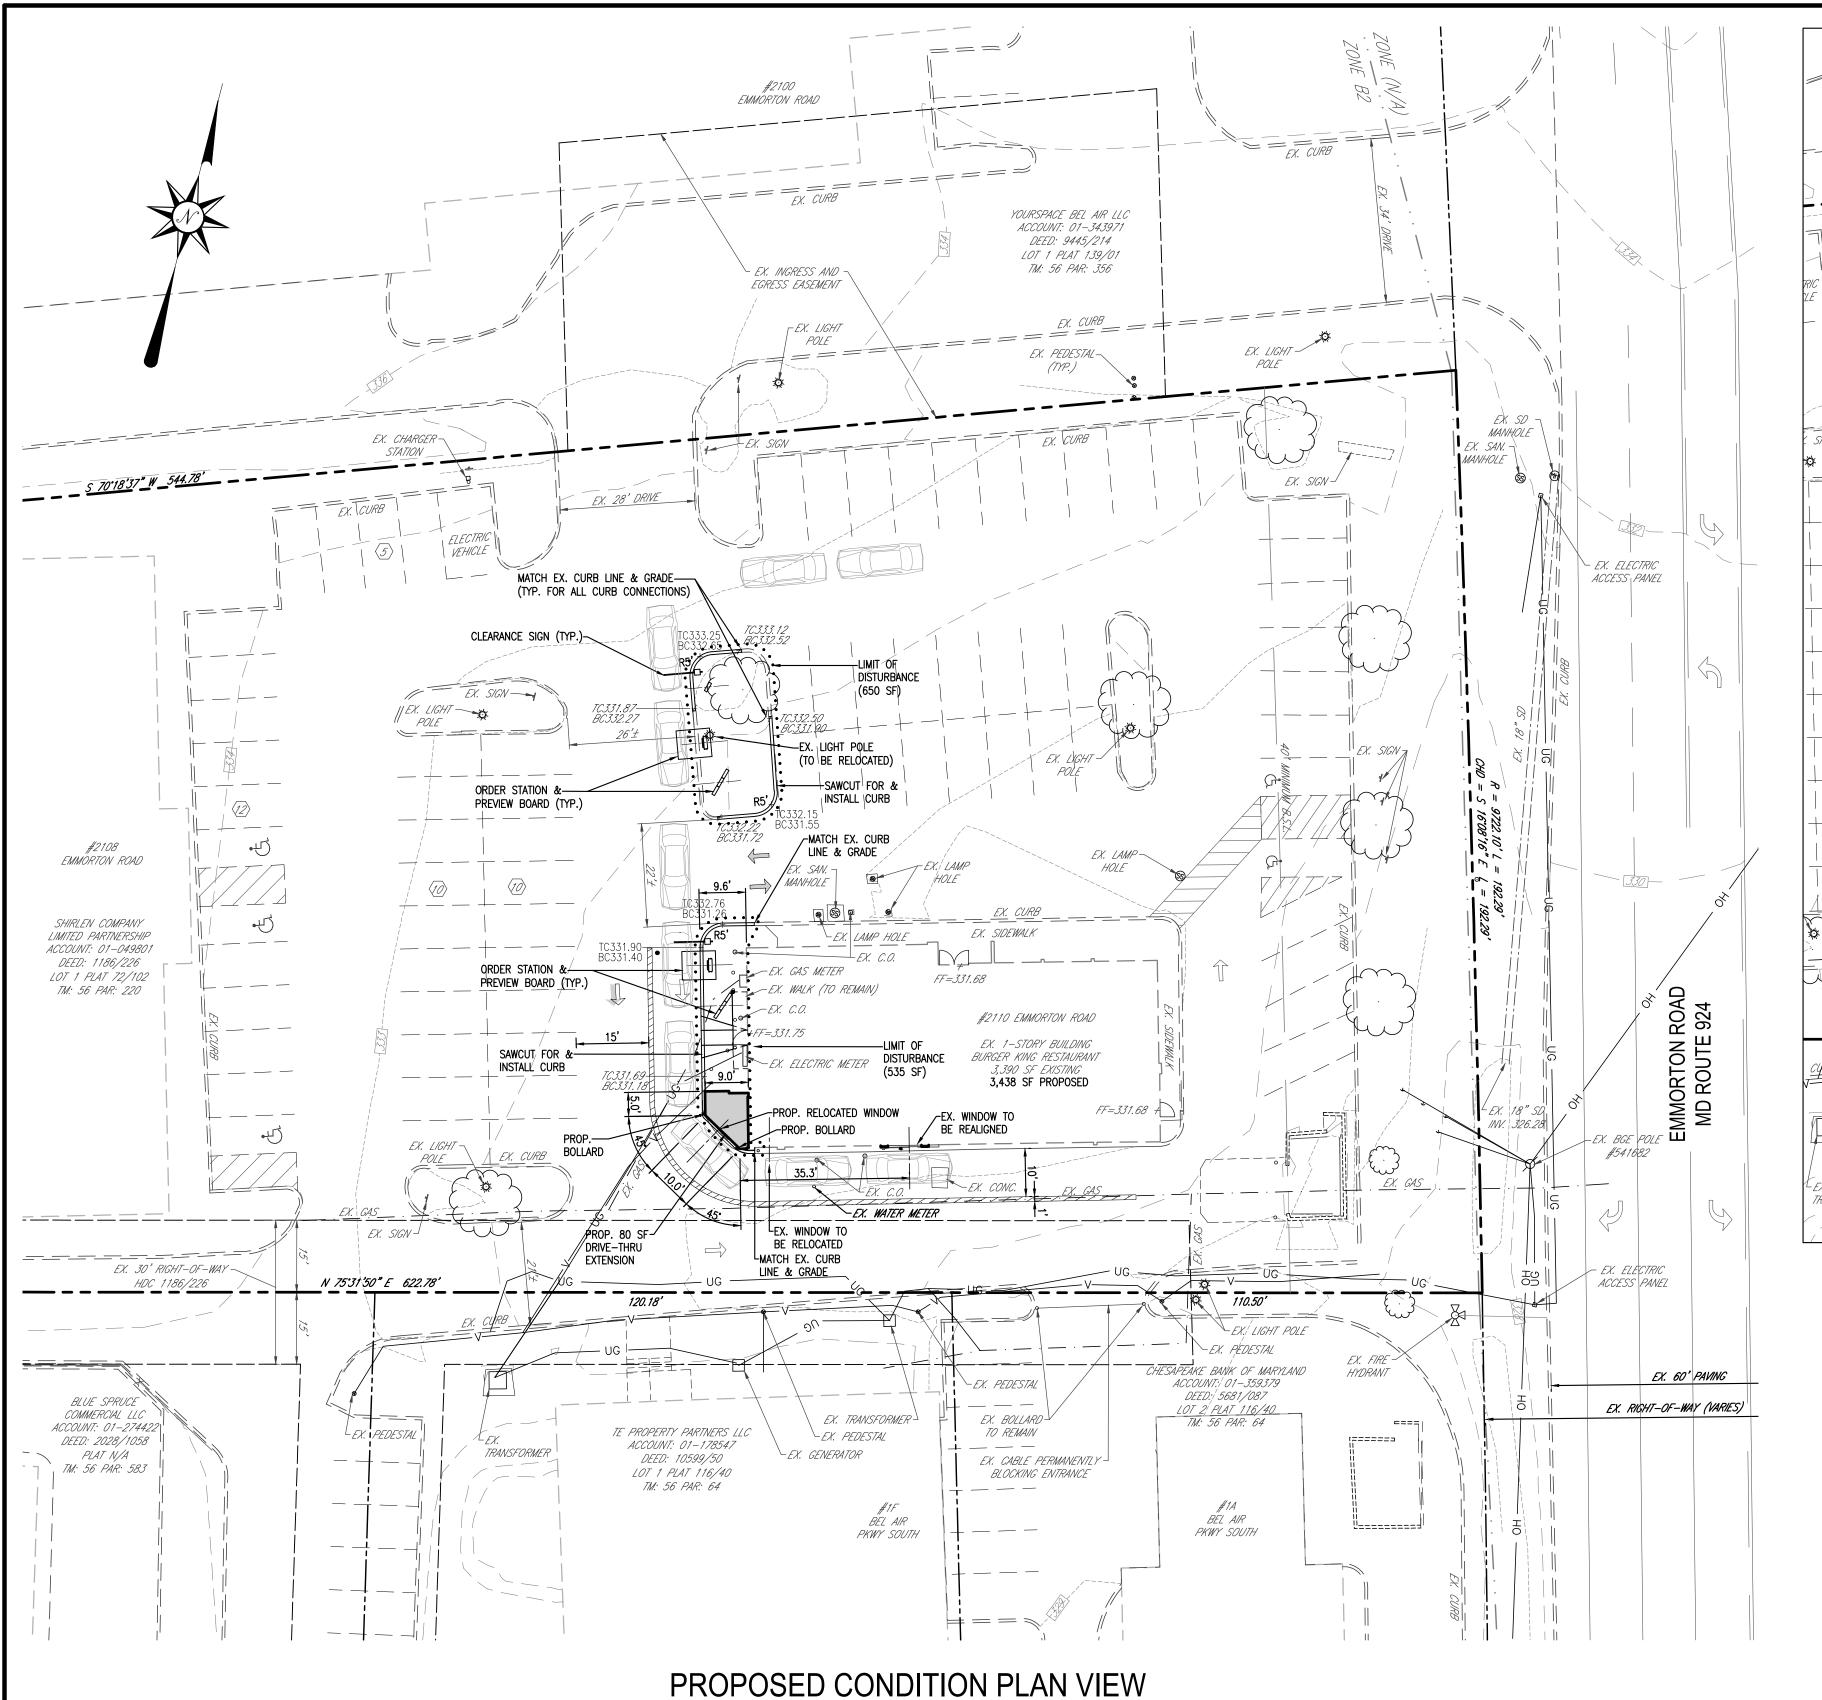

SCALE: 1" = 20'

DISTURBANCE (TO BE RELOCATED) EX. SIDEWALK EX. GAS METER FF=331.68 EX. WALK (TO REMAIN) #2110 EMMORTON ROAD ±>+FF=331.75 FX. 1-STORY BUILDING EX. ELECTRIC METER DISTURBANCE BURGER KING RESTAURANT 3,390 SF EXISTING (535 SF) (J----EX. DRIVE-THRU ORDER BOARD (TBR) FF=331.68 A EX. LIGHT POLE EX. TRANSFORMER -EX. BOLLARD Y TO REMAIN EX. PEDESTAL TRANSFORMER EX. GENERATOR EX. CABLE PERMANENTLY 🛚 BLOCKING ENTRANCE **EXISTING CONDITION PLAN VIEW** SCALE: 1" = 20'

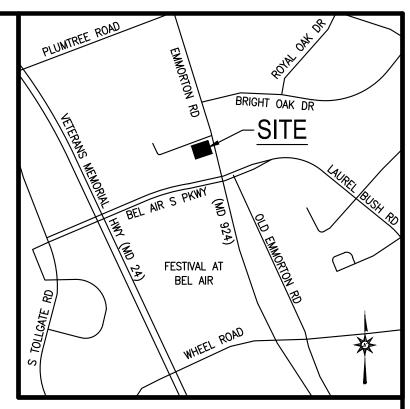

LOCATION MAP

SCALE: 1" = 1000'

GENERAL NOTES

. SITE AREA: GROSS AREA= 101,840 SQ.FT. OR 2.34 AC±

GROSS AREA= 101,840 SQ.FT. OR 2.34 AC± NET AREA= 101,840 SQ. FT. OR 2.34 AC± DEED REFERENCE: 1186/226

DEED REFERENCE: 1186/226
 TAX ACCOUNT NO. 01049801
 TAX MAP 56, GRID 2D, PARCEL 220 LOT 01

PLAT REFERENCE: 79/102
 NEIGHBORHOOD: 19000.13
 ELECTION DISTRICT: 01-21

14. COUNCILMANIC DISTRICT: B15. LAND USE: HI (HIGH INTENSITY)16. WATERSHED: BUSH RIVER

18. UTILITIES: EX. PUBLIC WATER / PUBLIC SEWER

PROP. (NO CHANGE)
9. USE: EX. RESTAURANT

PROP.(NO CHANGE)
20. BUILDING COVERAGE: 3,438 SF

PERMITTED: 35%
PROVIDED: 30% COMBINED W/ #2108 EMMORTON RD

21. IMPERVIOUS COVERAGE: 81,430 SF
PERMITTED: 85%
PROVIDED: 86% COMPINIED W/ #2108 ENMADED IN DE

PROVIDED: 80% COMBINED W/ #2108 EMMORTON RD 22. NO KNOWN PERMITS ON FILE.

23. THERE ARE NO HISTORICAL FEATURES ON SITE, NOR IS THE SITE ITSELF HISTORIC.24. ALL PROPOSED SIGNAGE SHALL CONFORM TO THE HARFORD COUNTY ZONING REGULATIONS

SECTION 267.33.

25. THIS SITE IS NOT WITHIN A FLOODPLAIN (CLASSIFIED AS FLOOD ZONE "X") PER PANEL

24025C0252E; EFF. 04/19/16.

26. BOUNDARY AND TOPOGRAPHIC INFORMATION SHOWN HEREON WAS PREPARED BY THOMPSON ASSOCIATES INC. ON APRIL 17, 2020, AND ALSO TAKEN FROM COUNTY CIS TOPO

& ASSOCIATES INC. ON APRIL 17, 2020, AND ALSO TAKEN FROM COUNTY GIS TOPO.

27. PARKING CALCULATIONS (FAST-FOOD RESTAURANT):

EXISTING

EXISTING = 40 SPACES (2 HANDICAP SPACE)
STACKING = 10 (6 BEHIND THE ORDER BOARD)
REQUIRED (1 PER 200 SF FLOOR AREA)
3,438 SF / 200 SF = 18 SPACES

STACKING = 7 (5 MUST BE BEHIND ORDER BOARD)

PROVIDED

EXISTING = 39 SPACES (2 HANDICAP SPACE)

STACKING = 10 SPACES (5 BEHIND ORDER BOARD)

28. THIS PLAN IS SUBJECT TO A BUILDING PERMIT SINCE THE LIMIT OF DISTURBANCE IS LESS THAN 5.000 SQ.FT.

29. LIMIT OF DISTURBANCE = 1,185 S.F.
28. ON AUGUST 4, 2020, HARFORD COUNTY APPROVED THIS PROJECT FOR A DAC WAIVER.

STORMWATER MANAGEMENT NOTE

THE PROPOSED COMMERCIAL REDEVELOPMENT CONSISTS OF A 48 SF BUILDING ADDITION ONTO AN EXISTING BUILDING AND REDESIGN OF THE DRIVE—THRU TO ALLOW FOR (2) ORDER STATIONS. THE TOTAL LIMIT OF DISTURBANCE (LOD) TO COMPLETE THE PROJECT IS 1,185 SF. AS A RESULT, THIS PROJECT WILL BE EXEMPT FROM STORMWATER MANAGEMENT REQUIREMENTS SINCE THE LOD IS LESS THAN 5,000 SF.

DAILY STABILIZATION NOTE

CONTRACTOR SHALL ONLY DISTURB THAT AREA WHICH CAN BE STABILIZED BY THE END OF THE WORK DAY. STABILIZATION SHALL BE AS FOLLOWS:

1) FOR PAVED AREAS, THE APPLICATION OF STONE BASE.

2) FOR VEGETATED AREAS,


a) PERMANENT SEED AND SOIL STABILIZATION MATTING OR SOD FOR ALL STEEP

SLOPES, CHANNELS OR SWALES.

b) PERMANENT SEED AND MULCH FOR ALL OTHER AREAS. ANY AREAS WHICH CANNOT BE STABILIZED BY THE END OF EACH WORKING DAY MUST HAVE SILT FENCE

INSTALLED ON THE DOWNSLOPE SIDE, OR STEEL PLATES FOR TRAFFIC AREAS.

DISTURBED AREA: 1,185 Sq.Ft. or 0.03 Ac.±

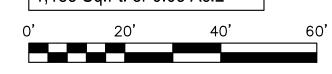



BURGERS OF BALTIMORE, LLC
811 KENSINGTON FARM COURT
FOREST HILL, MARYLAND 21050
PHONE: 410-893-1763

CONTACT


RICHARDSON ENGINEERING, LLC
30 EAST PADONIA ROAD
SUITE 500
TIMONIUM, MD 21093
ATTN: RICK RICHARDSON
PHONE: (410) 560-1502 x112

DEVELOPER /
APPLICANT

BURGERS OF BALTIMORE, LLC
811 KENSINGTON FARM COURT
FOREST HILL, MARYLAND 21050
ATTN: GARY EDWARDS
PHONE: (410) 893-1763

DESIGN AND DRAWINGS ARE BASED ON MARYLAND
COORDINATE SYSTEM (MCS).
HORIZONTAL - NAD 83/(2011)
VERTICAL - NAVD 88

PROFESSIONAL CERTIFICATION:
I HEREBY CERTIFY THAT THESE DOCUMENTS WERE PREPARED OR
APPROVED BY ME, AND THAT I AM A DULY LICENSED PROFESSIONAL
ENGINEER UNDER THE LAWS OF THE STATE OF MARYLAND, LICENSE
NUMBER 16597, EXPIRATION DATE: 08–15–2021

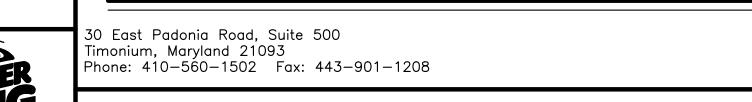

SITE PLAN
TO ACCOMPANY BUILDING PERMIT

BURGER KING

(STORE #9571)

2110 EMMORTON ROAD

BEL AIR, MD 21015

Richardson Engineering, LLC


HARFORD COUNTY
15th ELECTION DISTRICT
REVISIONS

19202

01 OF 01

06/05/20

NOTE:
THE CORRECTNESS OR COMPLETENESS OF EXISTING INFORMATION SHOWN ON THE DRAWINGS IS NOT WARRANTED OR GUARANTEED. THE CONTRACTOR SHALL VERIFY THE LOCATION OF UTILITIES AND UNDERGROUND FACILITIES, BY TEST PITS OR OTHER METHODS APPROVED BY THE OWNER'S REPRESENTATIVE, AS REQUIRED TO VERIFY EXACT LOCATIONS AND DEPTHS WITHIN THE LIMIT OF DISTURBANCE. ALL DISCREPANCIES BETWEEN INFORMATION SHOWN ON THE DRAWINGS AND THAT VERIFIED IN THE FIELD SHALL BE REPORTED TO THE OWNER'S REPRESENTATIVE PRIOR TO BEGINNING CONSTRUCTION.

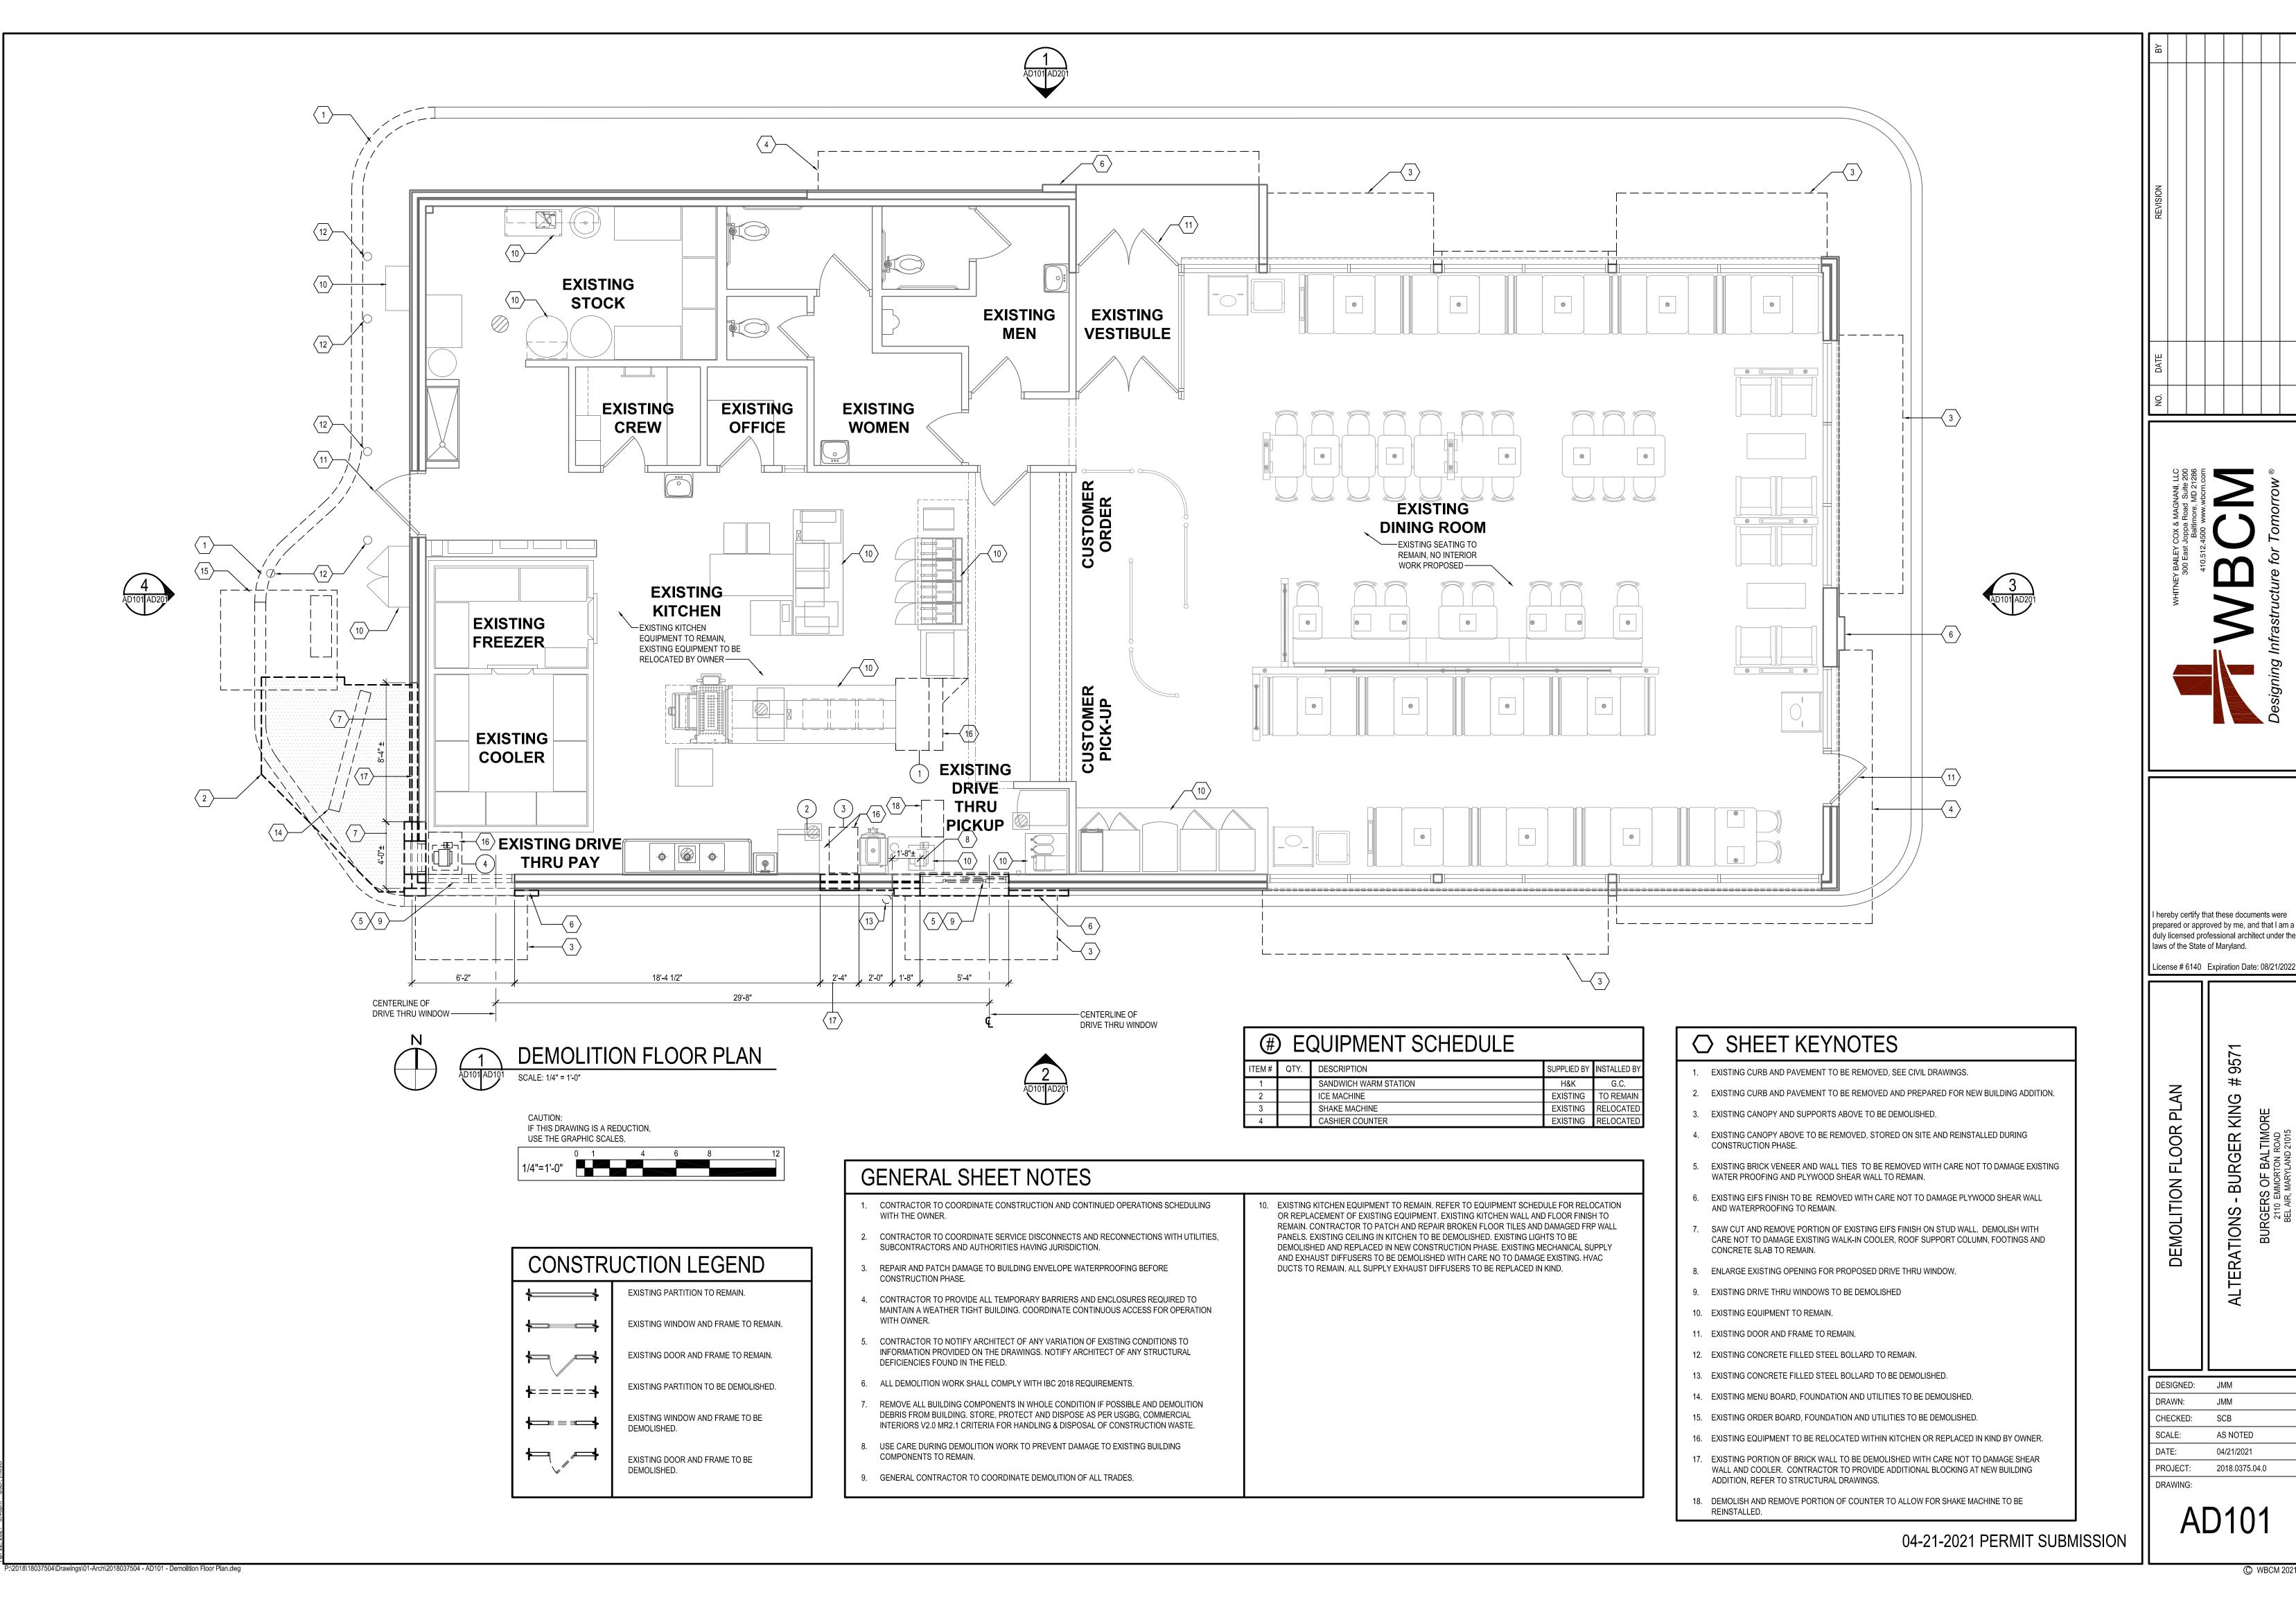

JMM

SCB

AS NOTED


04/21/2021

2018.0375.04.0

BURGER

TERATIONS .

© WBCM 2021

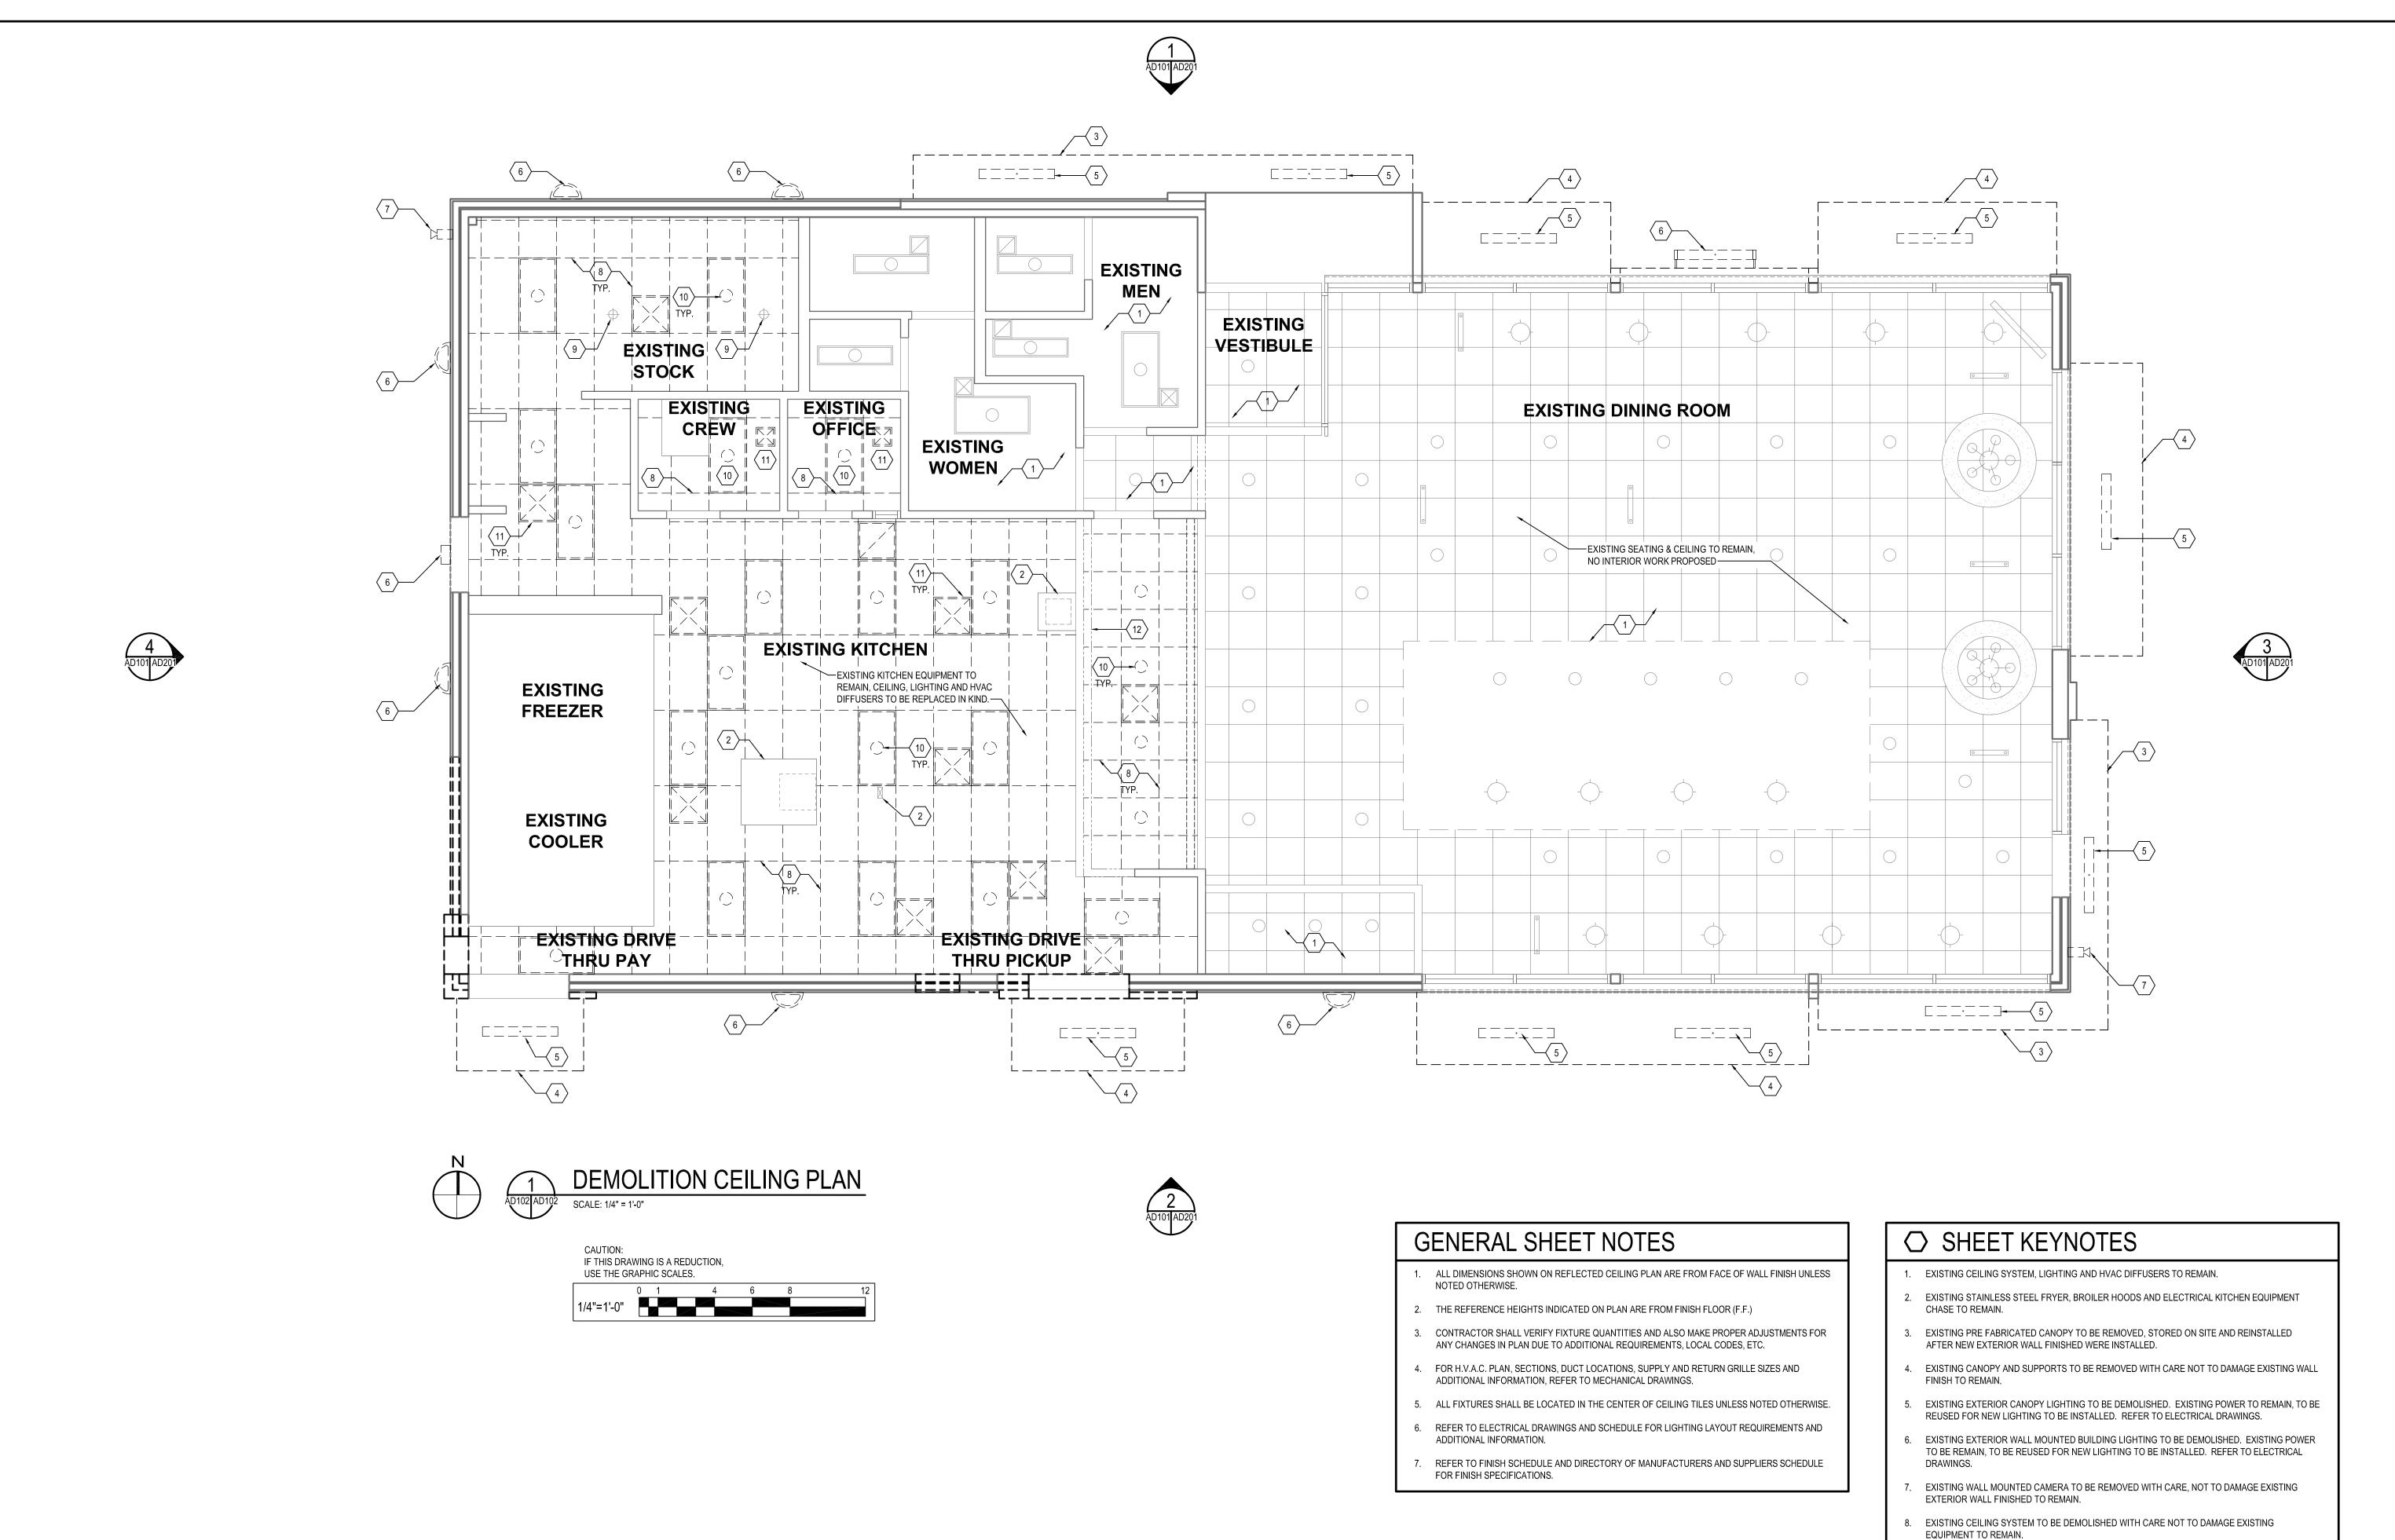

P:\2018\18037504\Drawings\01-Arch\2018037504 - AD102 - Demolition Ceiling Plan.dwg

- 9. EXISTING SPRINKLER HEADS TO REMAIN.
- 10. EXISTING INTERIOR LIGHTING TO BE DEMOLISHED. EXISTING POWER TO BE REMAIN, TO BE REUSED FOR NEW LIGHTING TO BE INSTALLED. REFER TO ELECTRICAL DRAWINGS.
- 11. EXISTING MECHANICAL SUPPLY AND EXHAUST DIFFUSERS TO BE DEMOLISHED WITH CARE NOT TO DAMAGE EXISTING HVAC DUCTS TO REMAIN. REFER TO MECHANICAL DRAWINGS.
- 12. EXISTING SURFACE MOUNTED MENU BOARD TO REMAIN.

DESIGNED: JMM

DRAWN: JMM

CHECKED: SCB

SCALE: AS NOTED

DATE: 04/21/2021

PROJECT: 2018.0375.04.0

I hereby certify that these documents were

prepared or approved by me, and that I am a duly licensed professional architect under the

License # 6140 Expiration Date: 08/21/2022

- BURGER KING


LTERATIONS -

laws of the State of Maryland.


DEMOLITION CEILING PLAN


AD102

DRAWING:

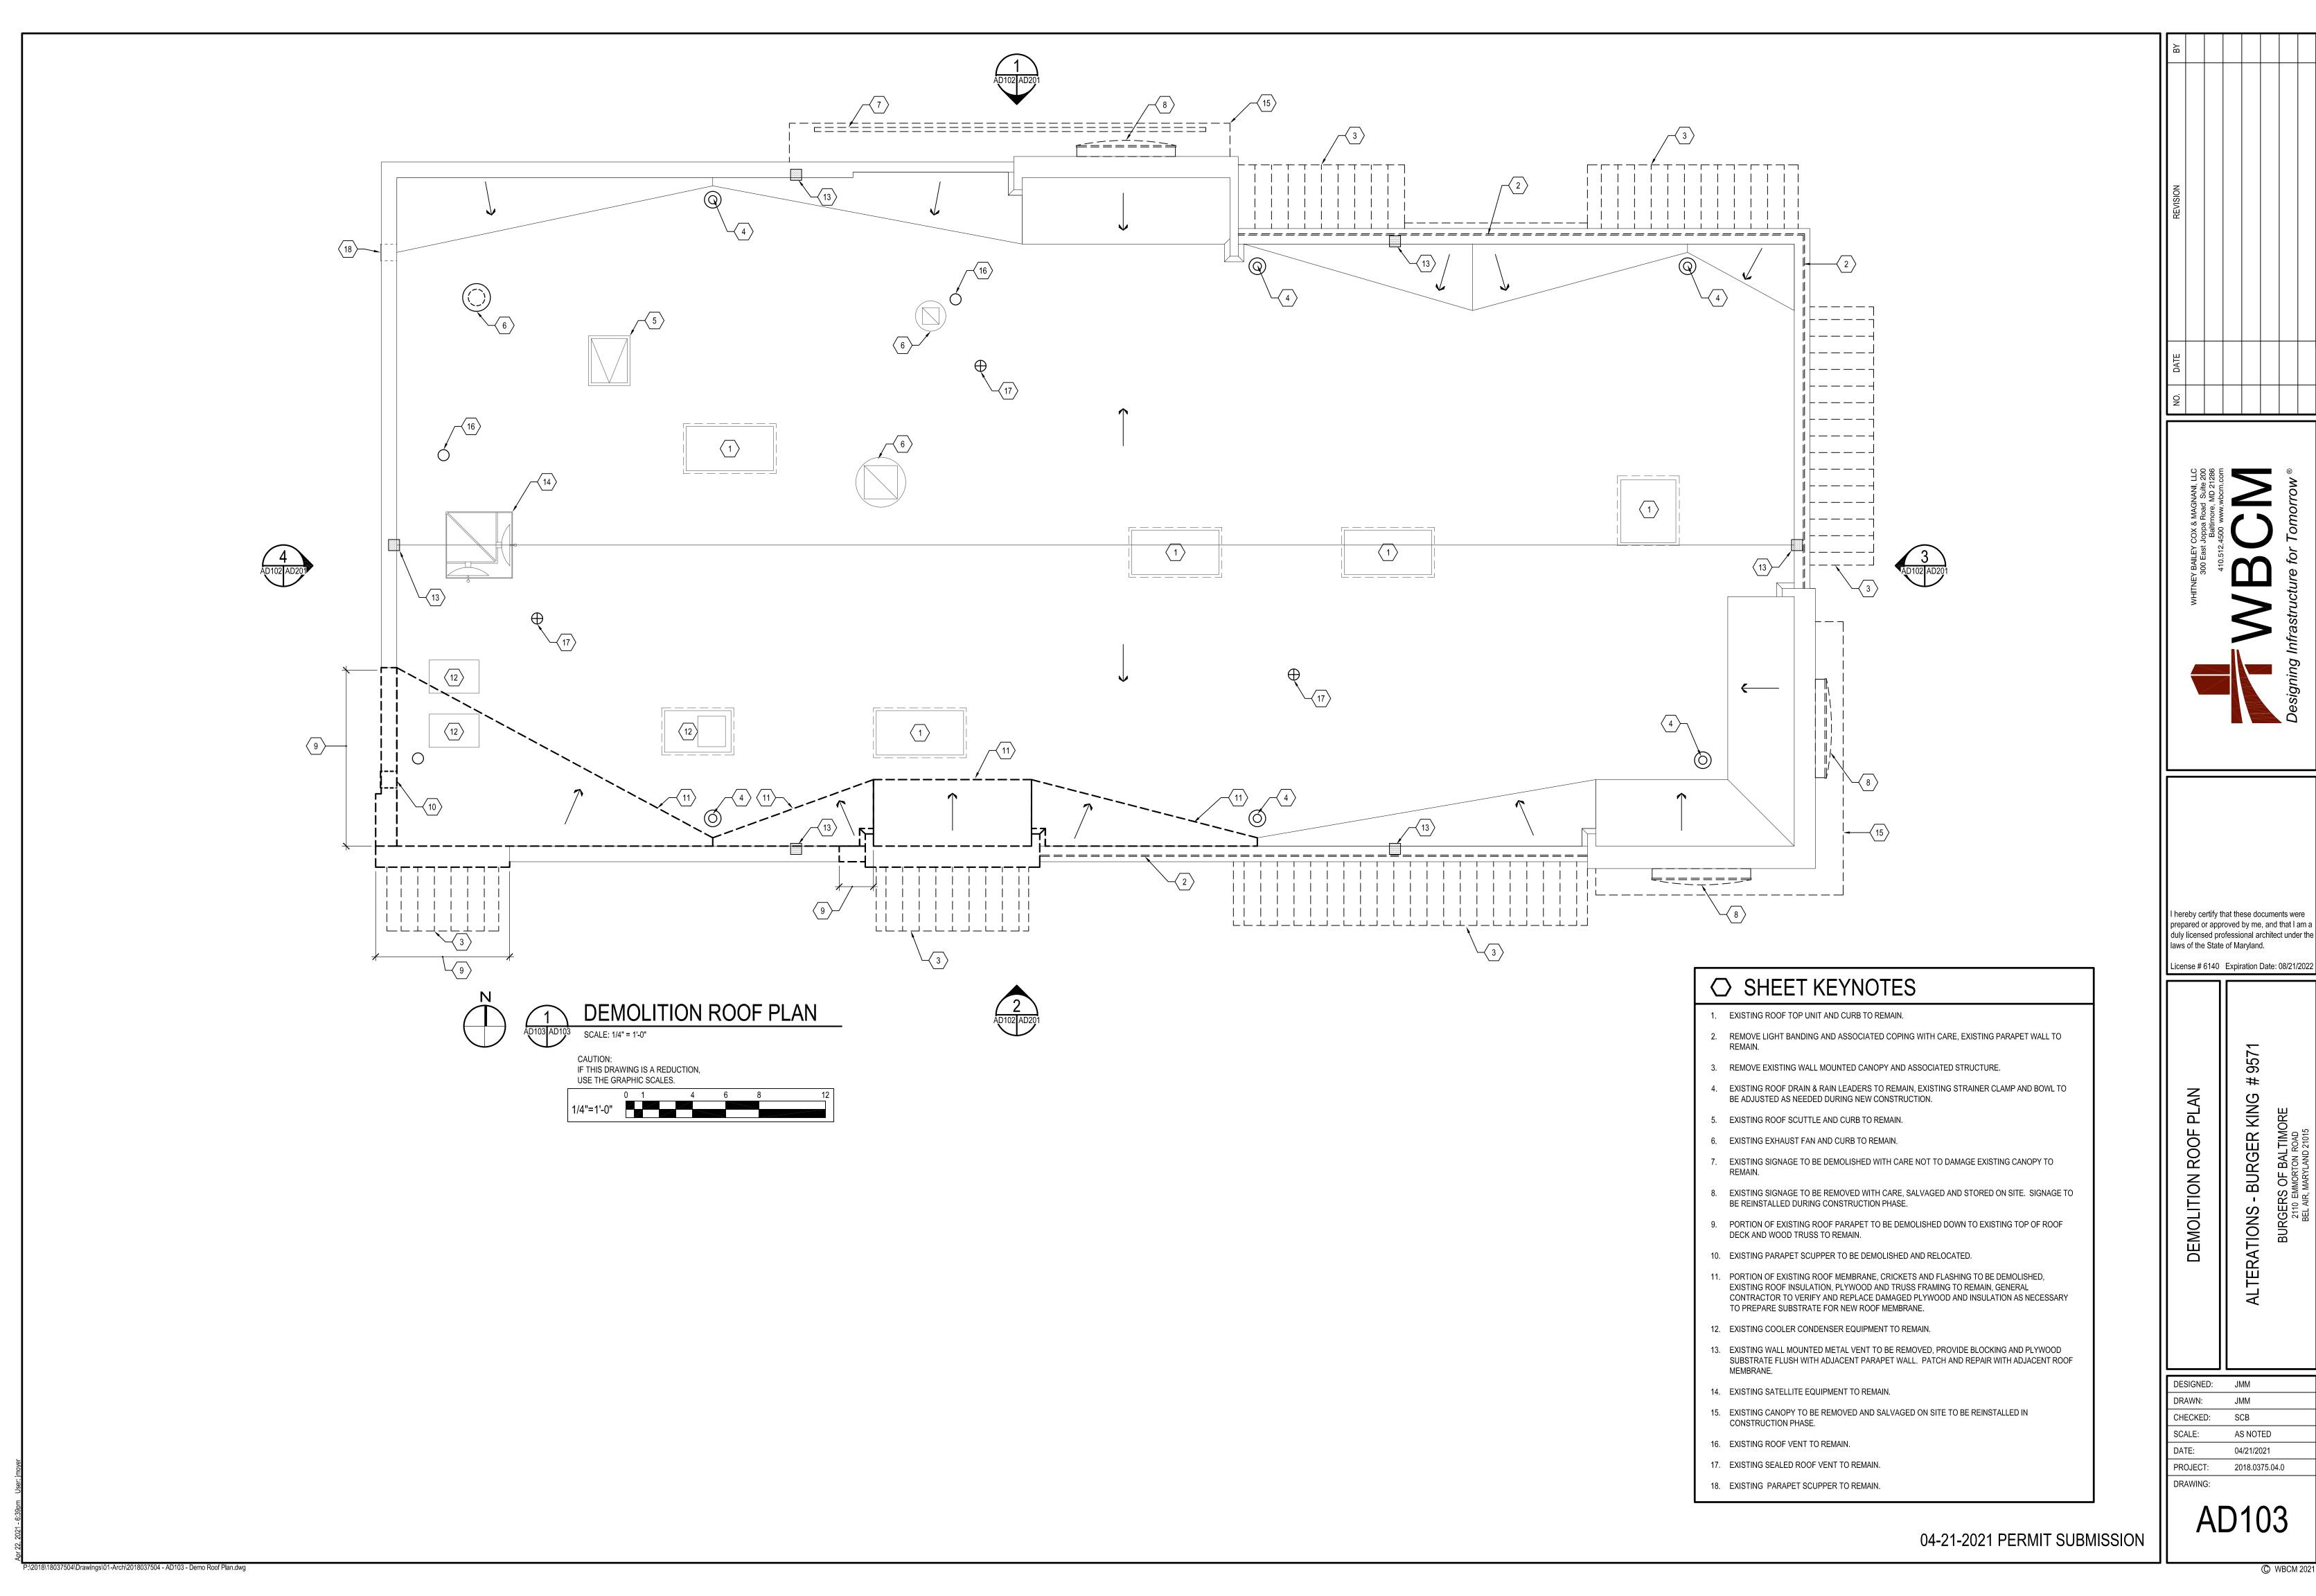

S - BURGER KING
ERS OF BALTIMORE
AIR MARYI AND 21015
AIR MARYI AND 21015 -TERATIONS -BURGER 2110 I BELAII DESIGNED: JMM JMM SCB AS NOTED 04/21/2021 PROJECT: 2018.0375.04.0

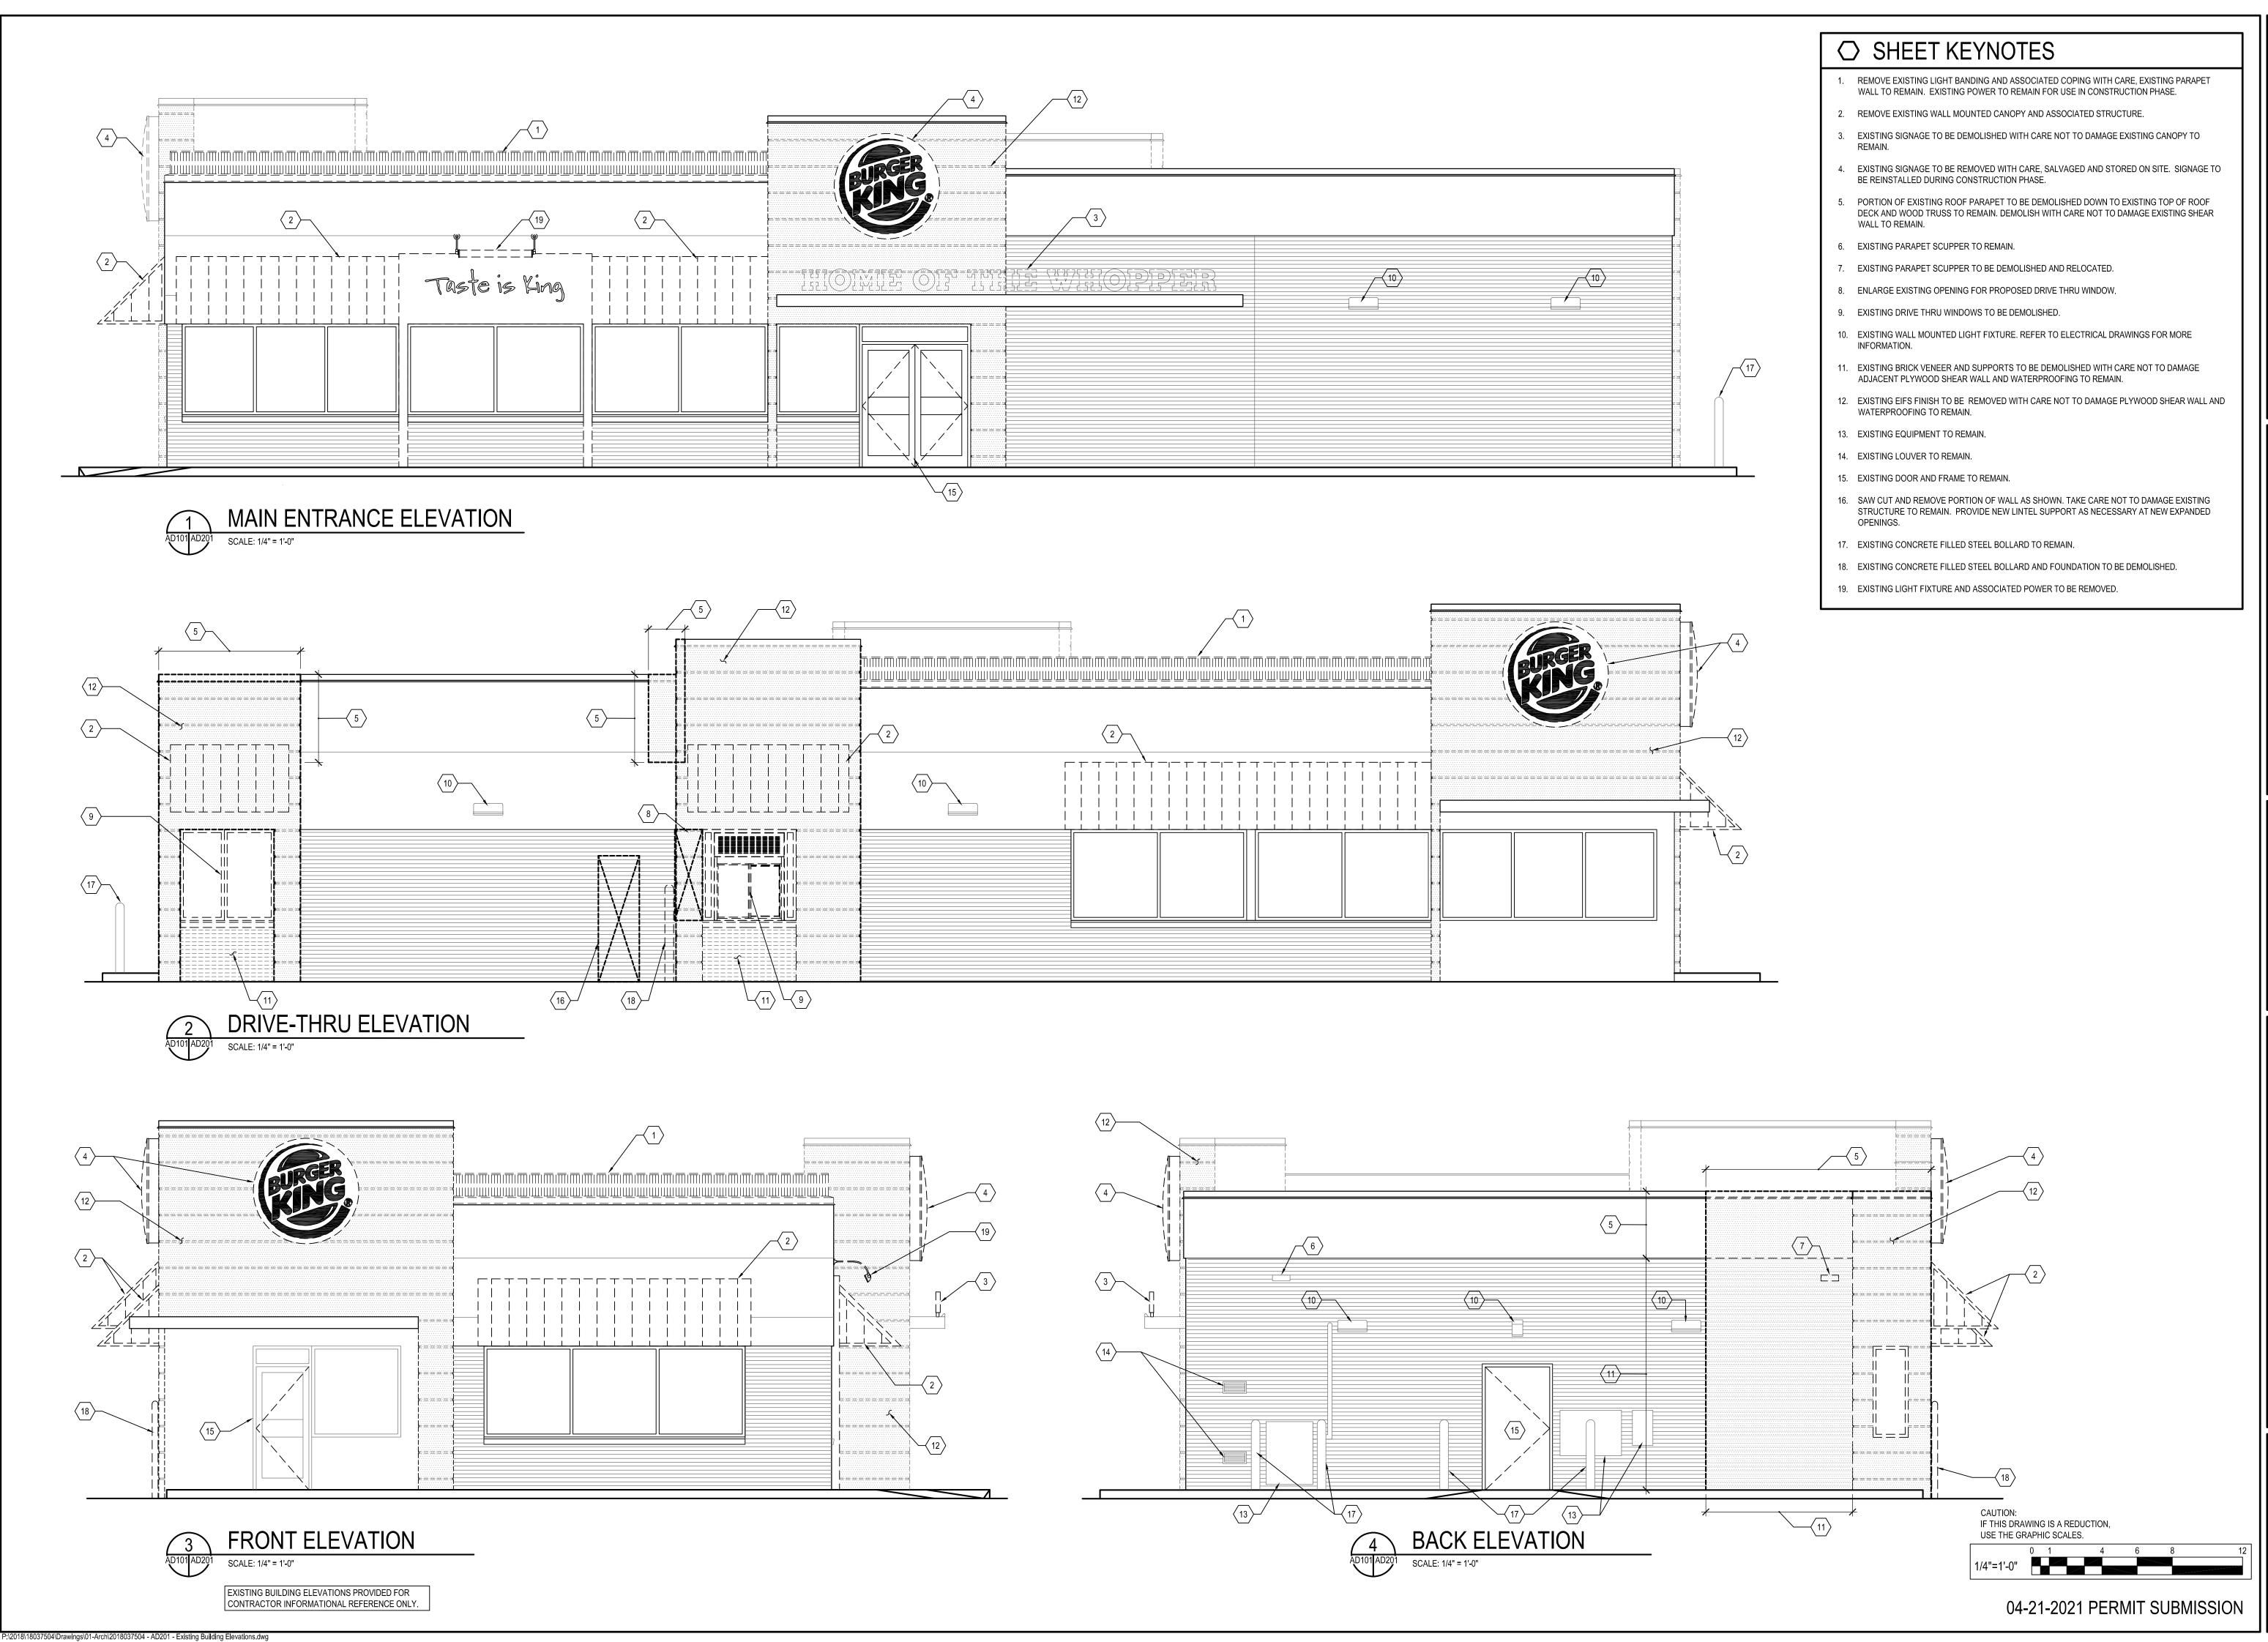

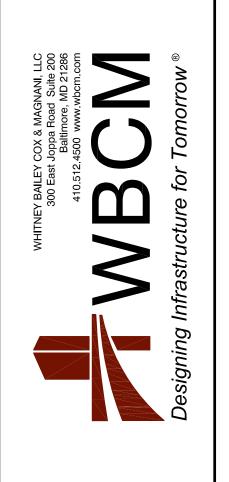

I hereby certify that these documents were prepared or approved by me, and that I am duly licensed professional architect under the laws of the State of Maryland.


License # 6140 Expiration Date: 08/21/202

EXISTING BUILDING ELEVATIONS TERATIONS - BURGER KING

DESIGNED:	JMM
DRAWN:	JMM
CHECKED:	SCB
SCALE:	AS NOTED
DATE:	04/21/2021
PROJECT:	2018.0375.04.0
DBWWING:	

AD201

© WBCM 2021

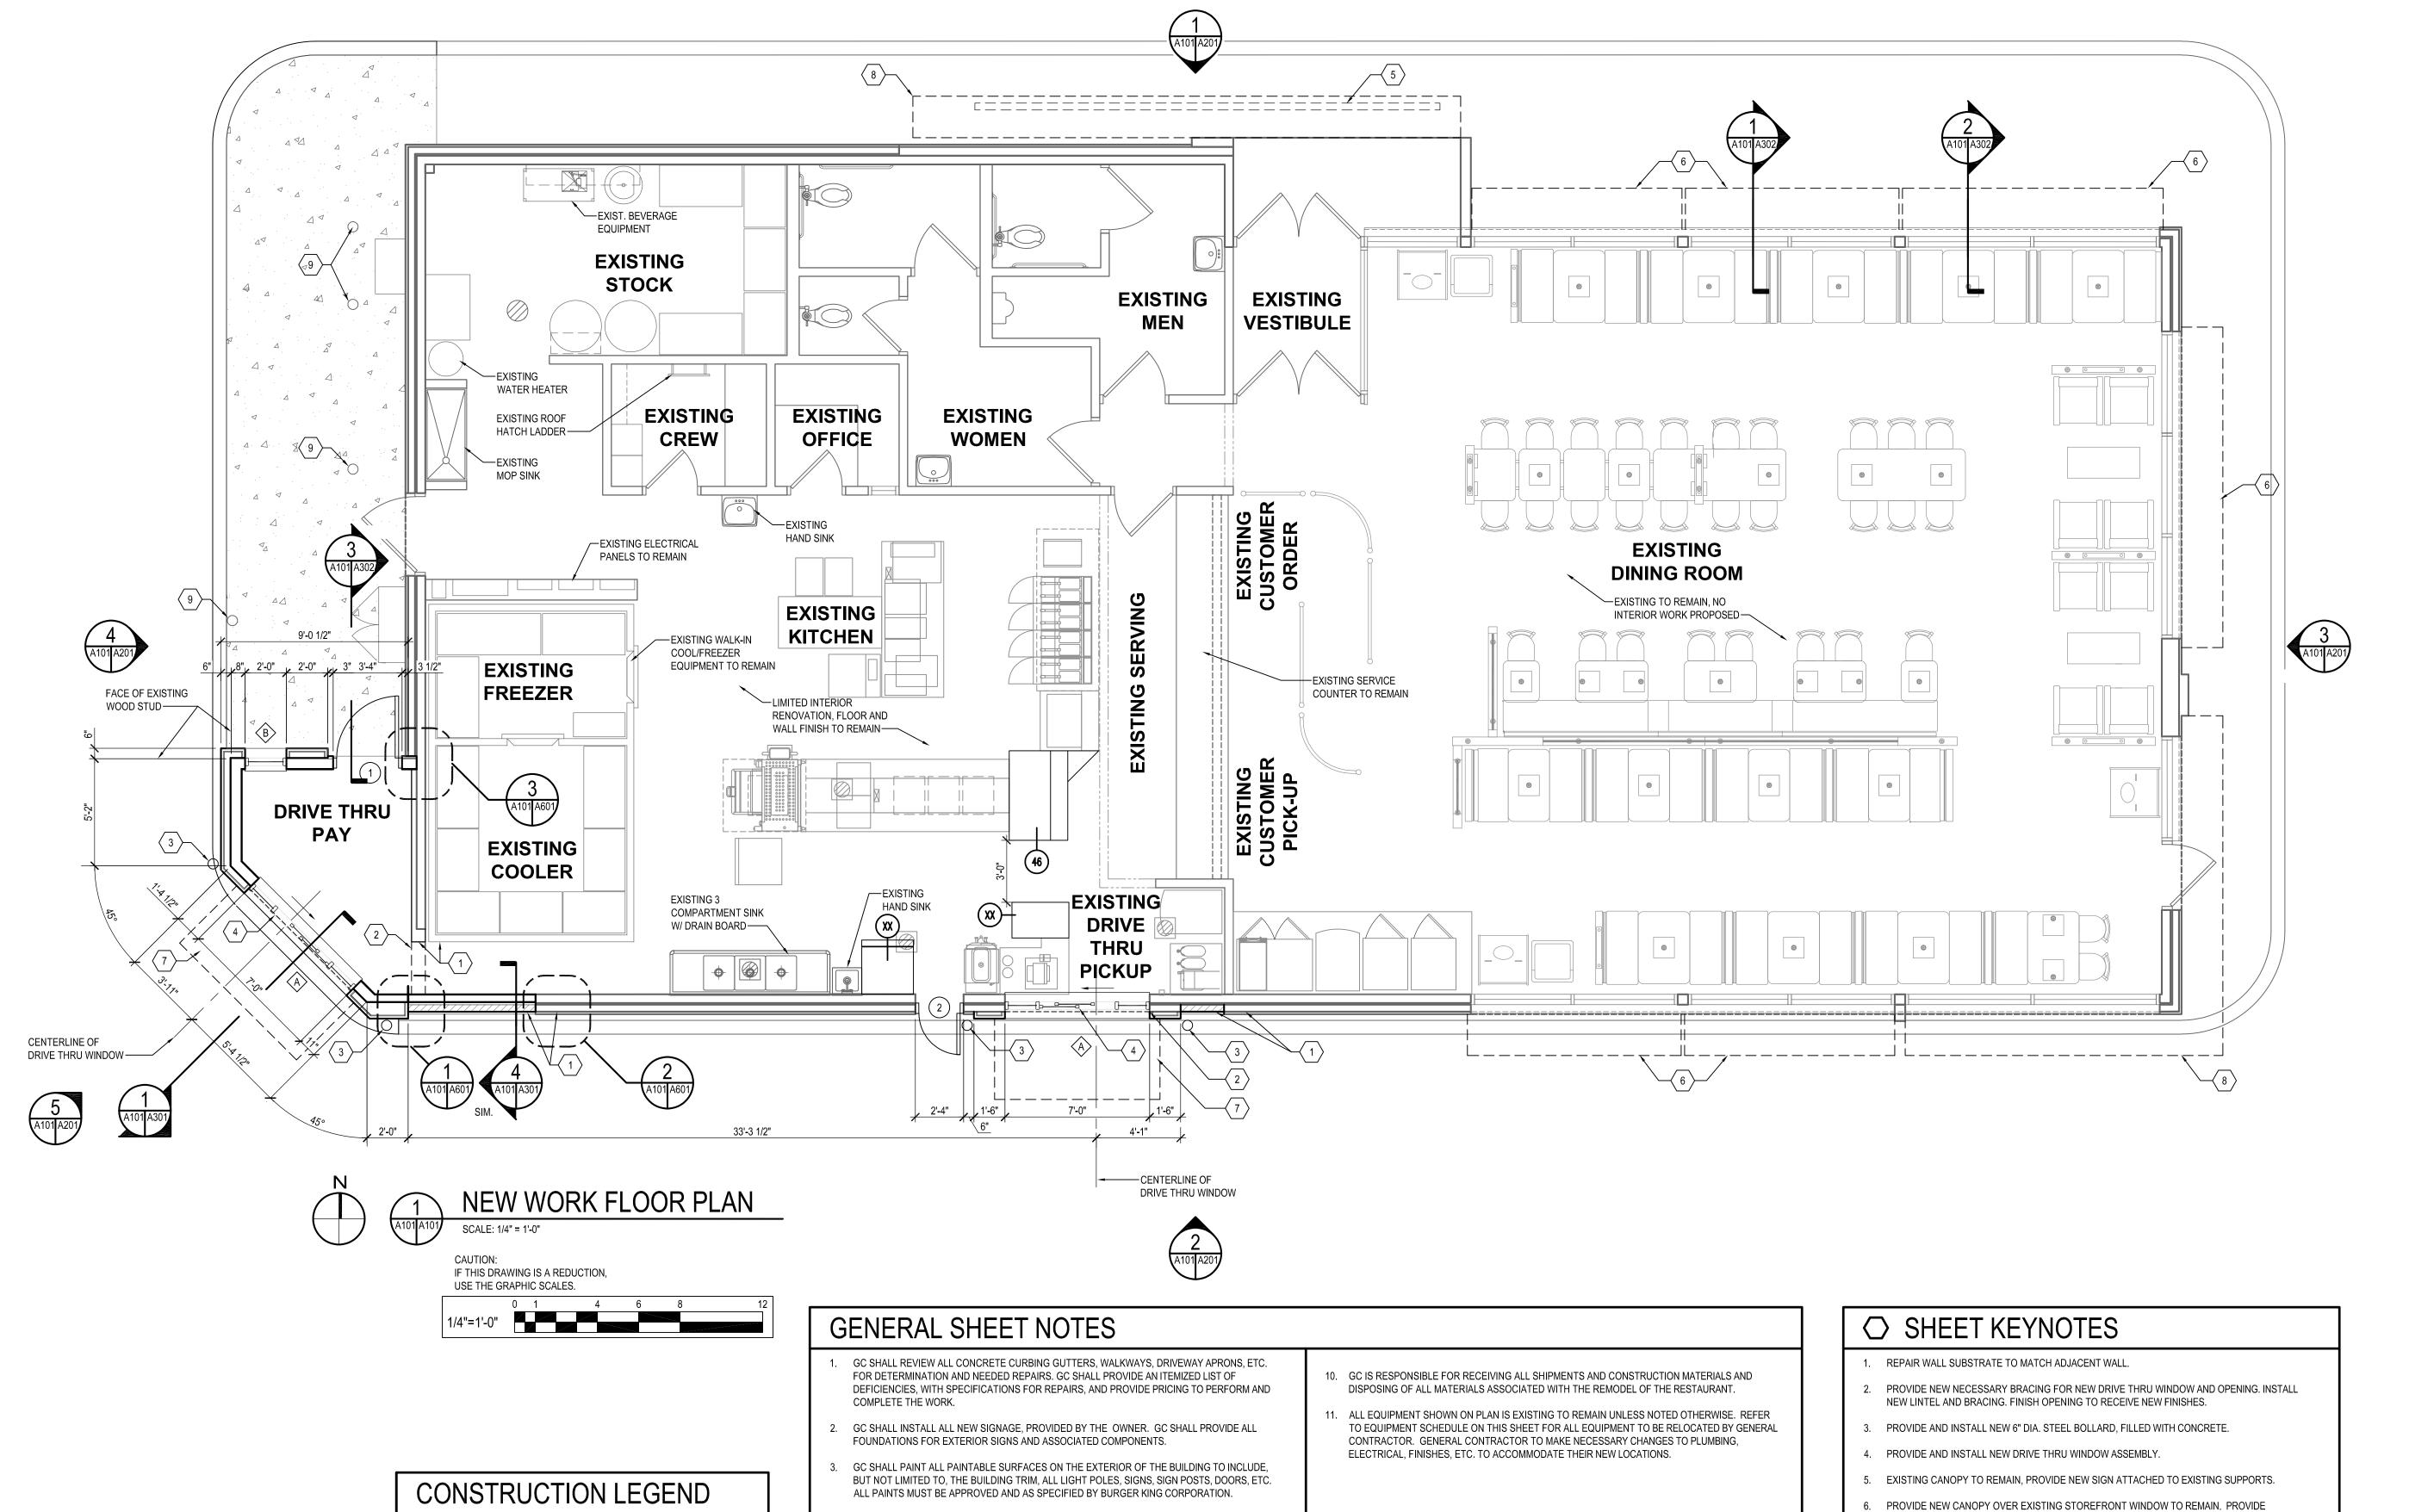

4. GC TO POWER WASH AND CLEAN ALL AREAS OF THE BUILDING NOT BEING RE-SURFACED OR

5. GC SHALL REPAIR/REPLACE FRP PANELS IN THE KITCHEN AREA AS NEEDED. INCLUDE THE WALL

6. GC SHALL CLEAN, REPAIR/REPLACE DAMAGED AND BROKEN QUARRY TILES IN THE KITCHEN

7. GC SHALL INSTALL ALL CEILING MONITORS AND OTHER MISCELLANEOUS ITEMS DISTURBED AND OR REMOVED AS PART OF THE WORK. ANY ITEMS THAT CANNOT BE CLEANED / REFURNISHED

SUPPORT FRAMING, EMBEDS, CONCEALED OR OTHERWISE FOR ALL SIGNS, CANOPIES, AND

BUILDING ATTACHMENTS. CHECK DRAWINGS AND FIELD CONDITIONS TO VERIFY PROPER

8. UNDER THE CONSTRUCTION WORK OF THIS PROJECT, GC SHALL INSTALL ALL BLOCKING,

9. ALL EXISTING AND REMAINING SIGNS SHALL BE CLEANED, RETROFITTED FOR LED AND

FINISH FRP SYMMETRIX REPLACEMENT OF UP TO 4 SHEETS OF NEW FRP PANELS. SUPPLY COST

PAINTED, AND ALL CONCRETE.

SUPPORT FOR SUCH ITEMS.

RE-LAMPED AS NEEDED.

AREA. REGROUT THE FLOOR AS REQUIRED/NEEDED.

TO LOOK AS NEW WILL BE REPLACED WITH NEW.

EXISTING PARTITION TO REMAIN.

EXISTING WINDOW AND FRAME TO REMAIN.

EXISTING DOOR AND FRAME TO REMAIN.

NEW PARTITION TO BE CONSTRUCTED.

NEW DOOR AND FRAME TO BE CONSTRUCTED.

NEW WINDOW AND FRAME TO BE

CONSTRUCTED.

- ADDITIONAL TREATED WOOD BLOCKING BEHIND WALL AS NECESSARY.
- 7. PROVIDE NEW CANOPY OVER DRIVE THRU WINDOW. PROVIDE ADDITIONAL TREATED WOOD BLOCKING BEHIND WALL AS NECESSARY.
- BEGGING BEHIND WILLE NO NEOLOGIANT.
- 8. EXISTING CANOPY TO BE REINSTALLED DURING CONSTRUCTION PHASE AFTER EXTERIOR
- FINISHES HAVE BEEN INSTALLED.

9. EXISTING BOLLARD TO REMAIN.

#) E(QUIPMENT SCHEDULE		
ITEM#	QTY.	DESCRIPTION	SUPPLIED BY	INSTALLED BY
1		SANDWICH WARM STATION	H&K	G.C.
2		SHAKE MACHINE	EXISTING	RELOCATED
3		WARMING CABINET	EXISTING	RELOCATED
4		CASHIER COUNTER	EXISTING	RELOCATED

04-21-2021 PERMIT SUBMISSION

© WBCM 2021

I hereby certify that these documents were prepared or approved by me, and that I am a duly licensed professional architect under the

License # 6140 Expiration Date: 08/21/2022

- BURGER

TERATIONS .

WORK

NEW

DESIGNED: JMM

DRAWN:

SCALE:

CHECKED:

PROJECT:

DRAWING:

JMM

SCB


AS NOTED

04/21/2021

2018.0375.04.0


laws of the State of Maryland.

P:\2018\18037504\Drawings\01-Arch\2018037504 - A101 - New Work Floor Plan.dwg

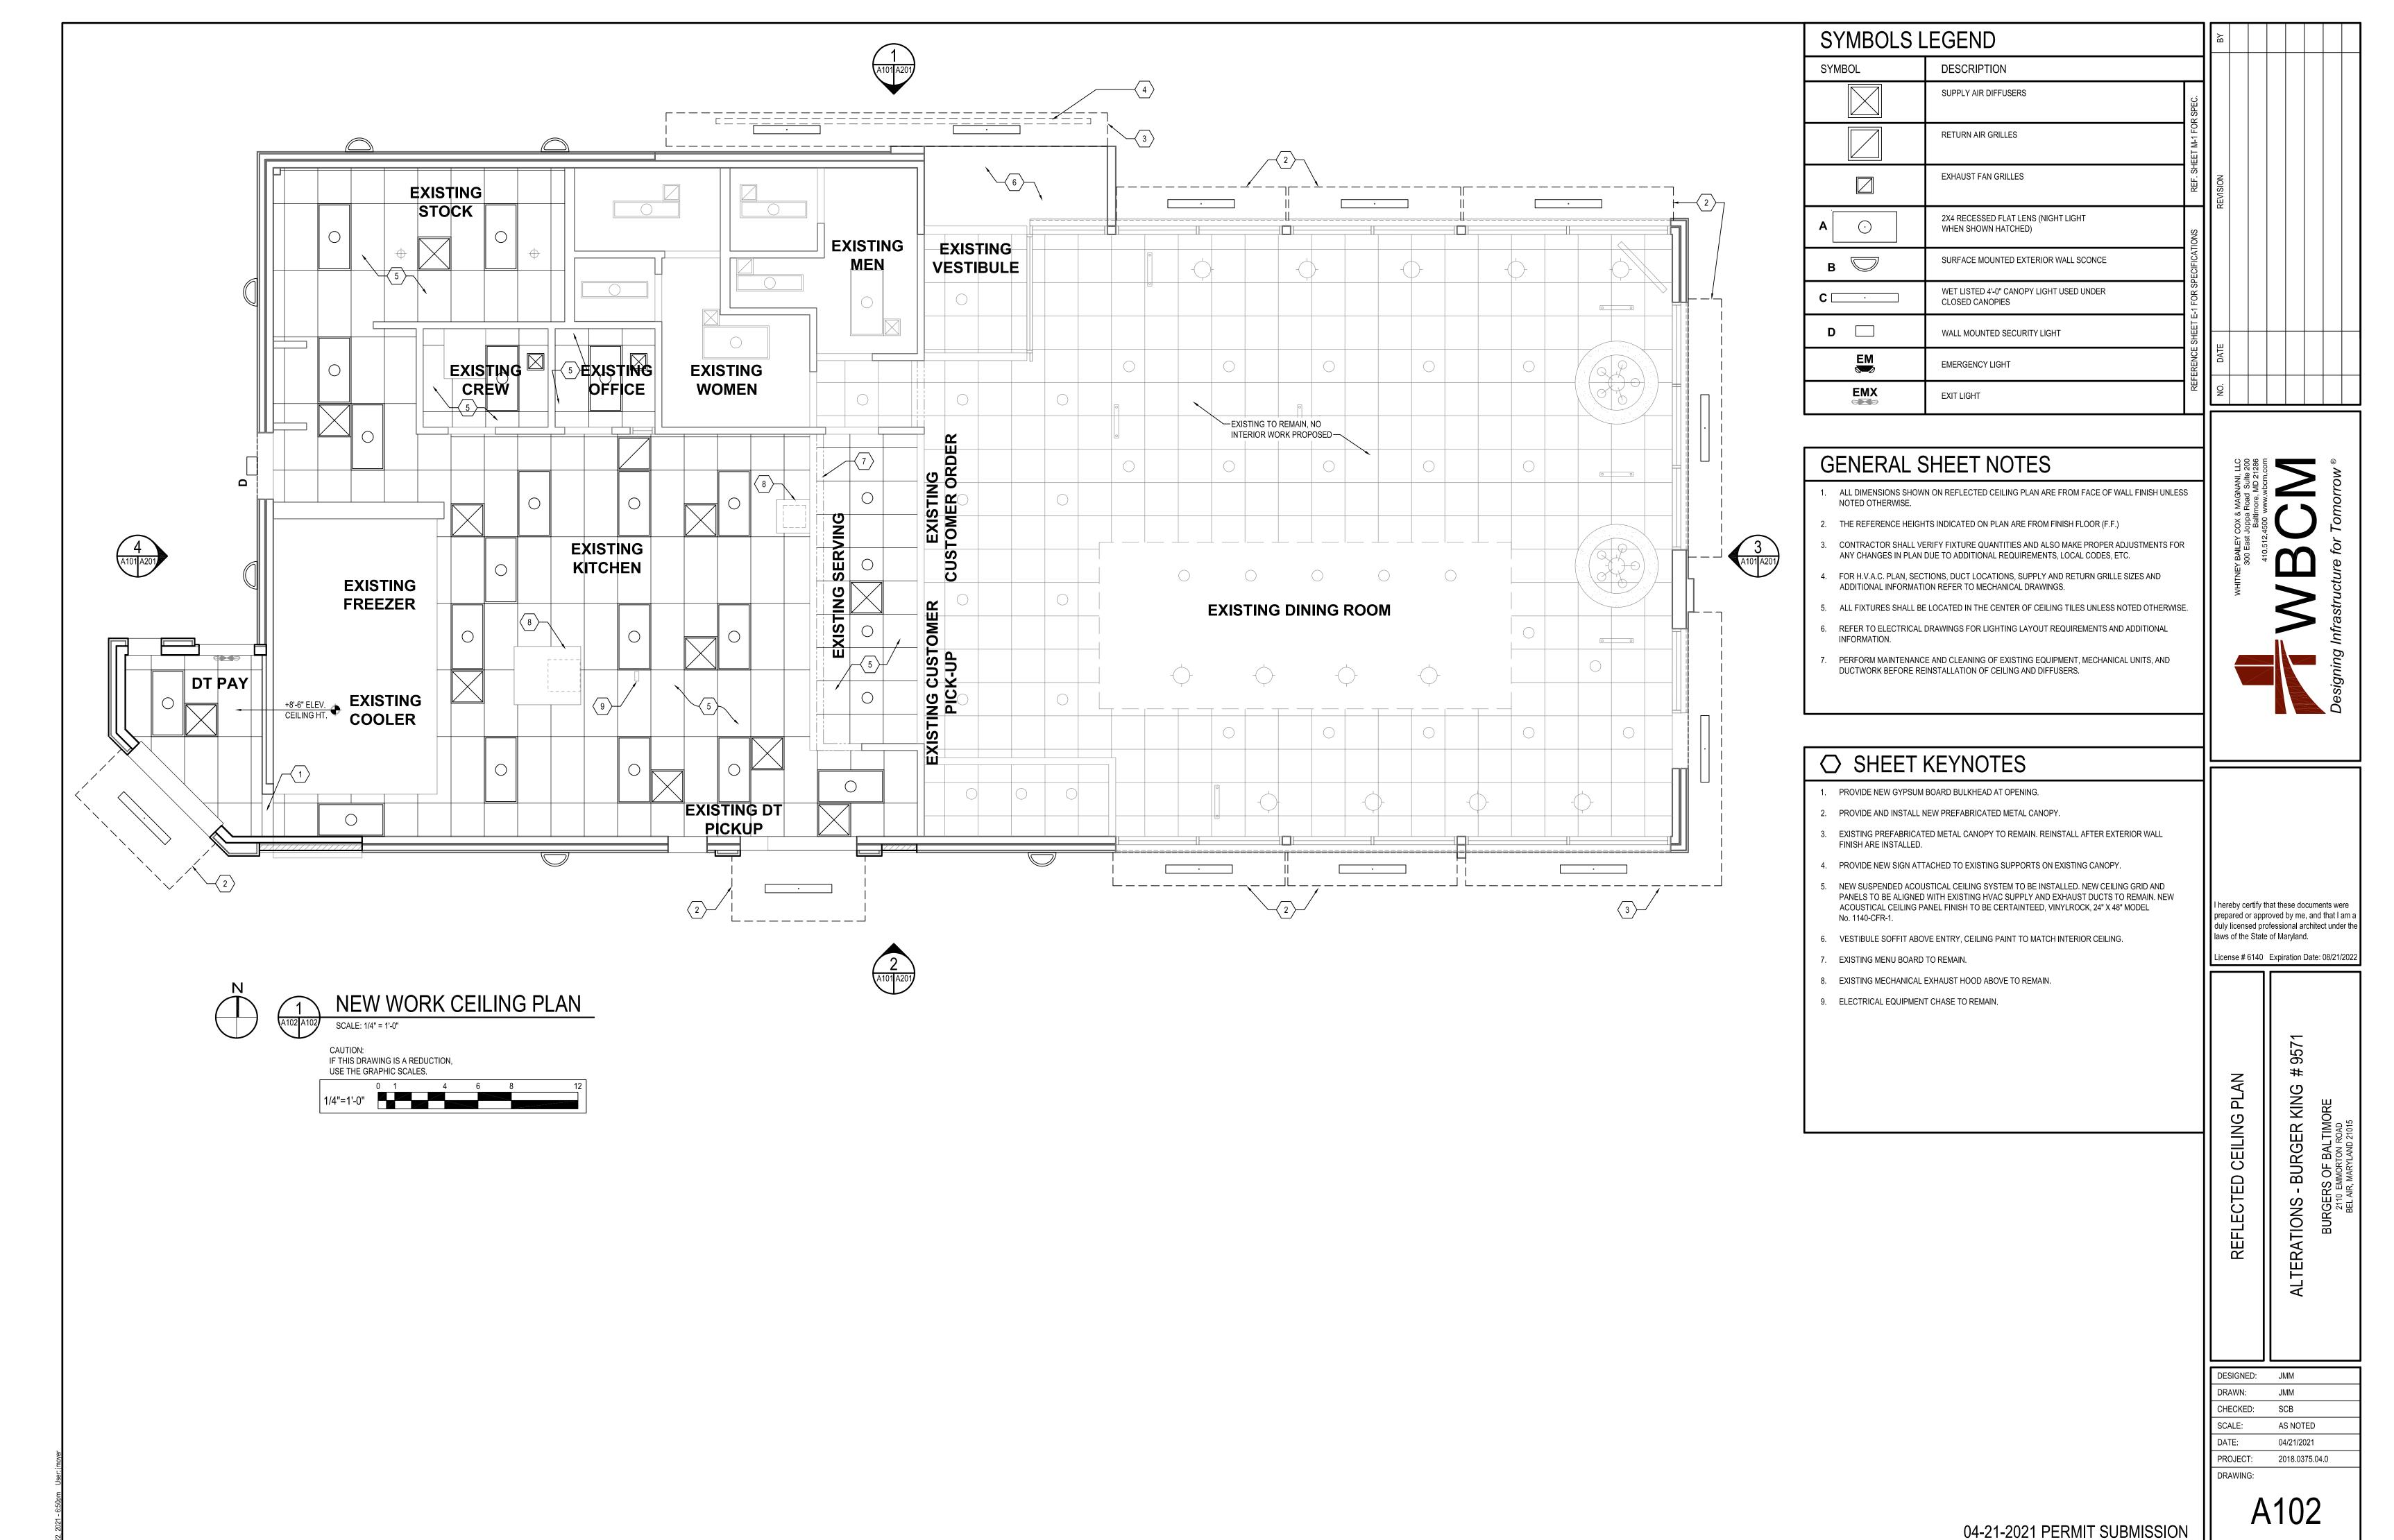

P:\2018\18037504\Drawings\01-Arch\2018037504 - A102 - New Work Ceiling Plan.dwg

© WBCM 2021

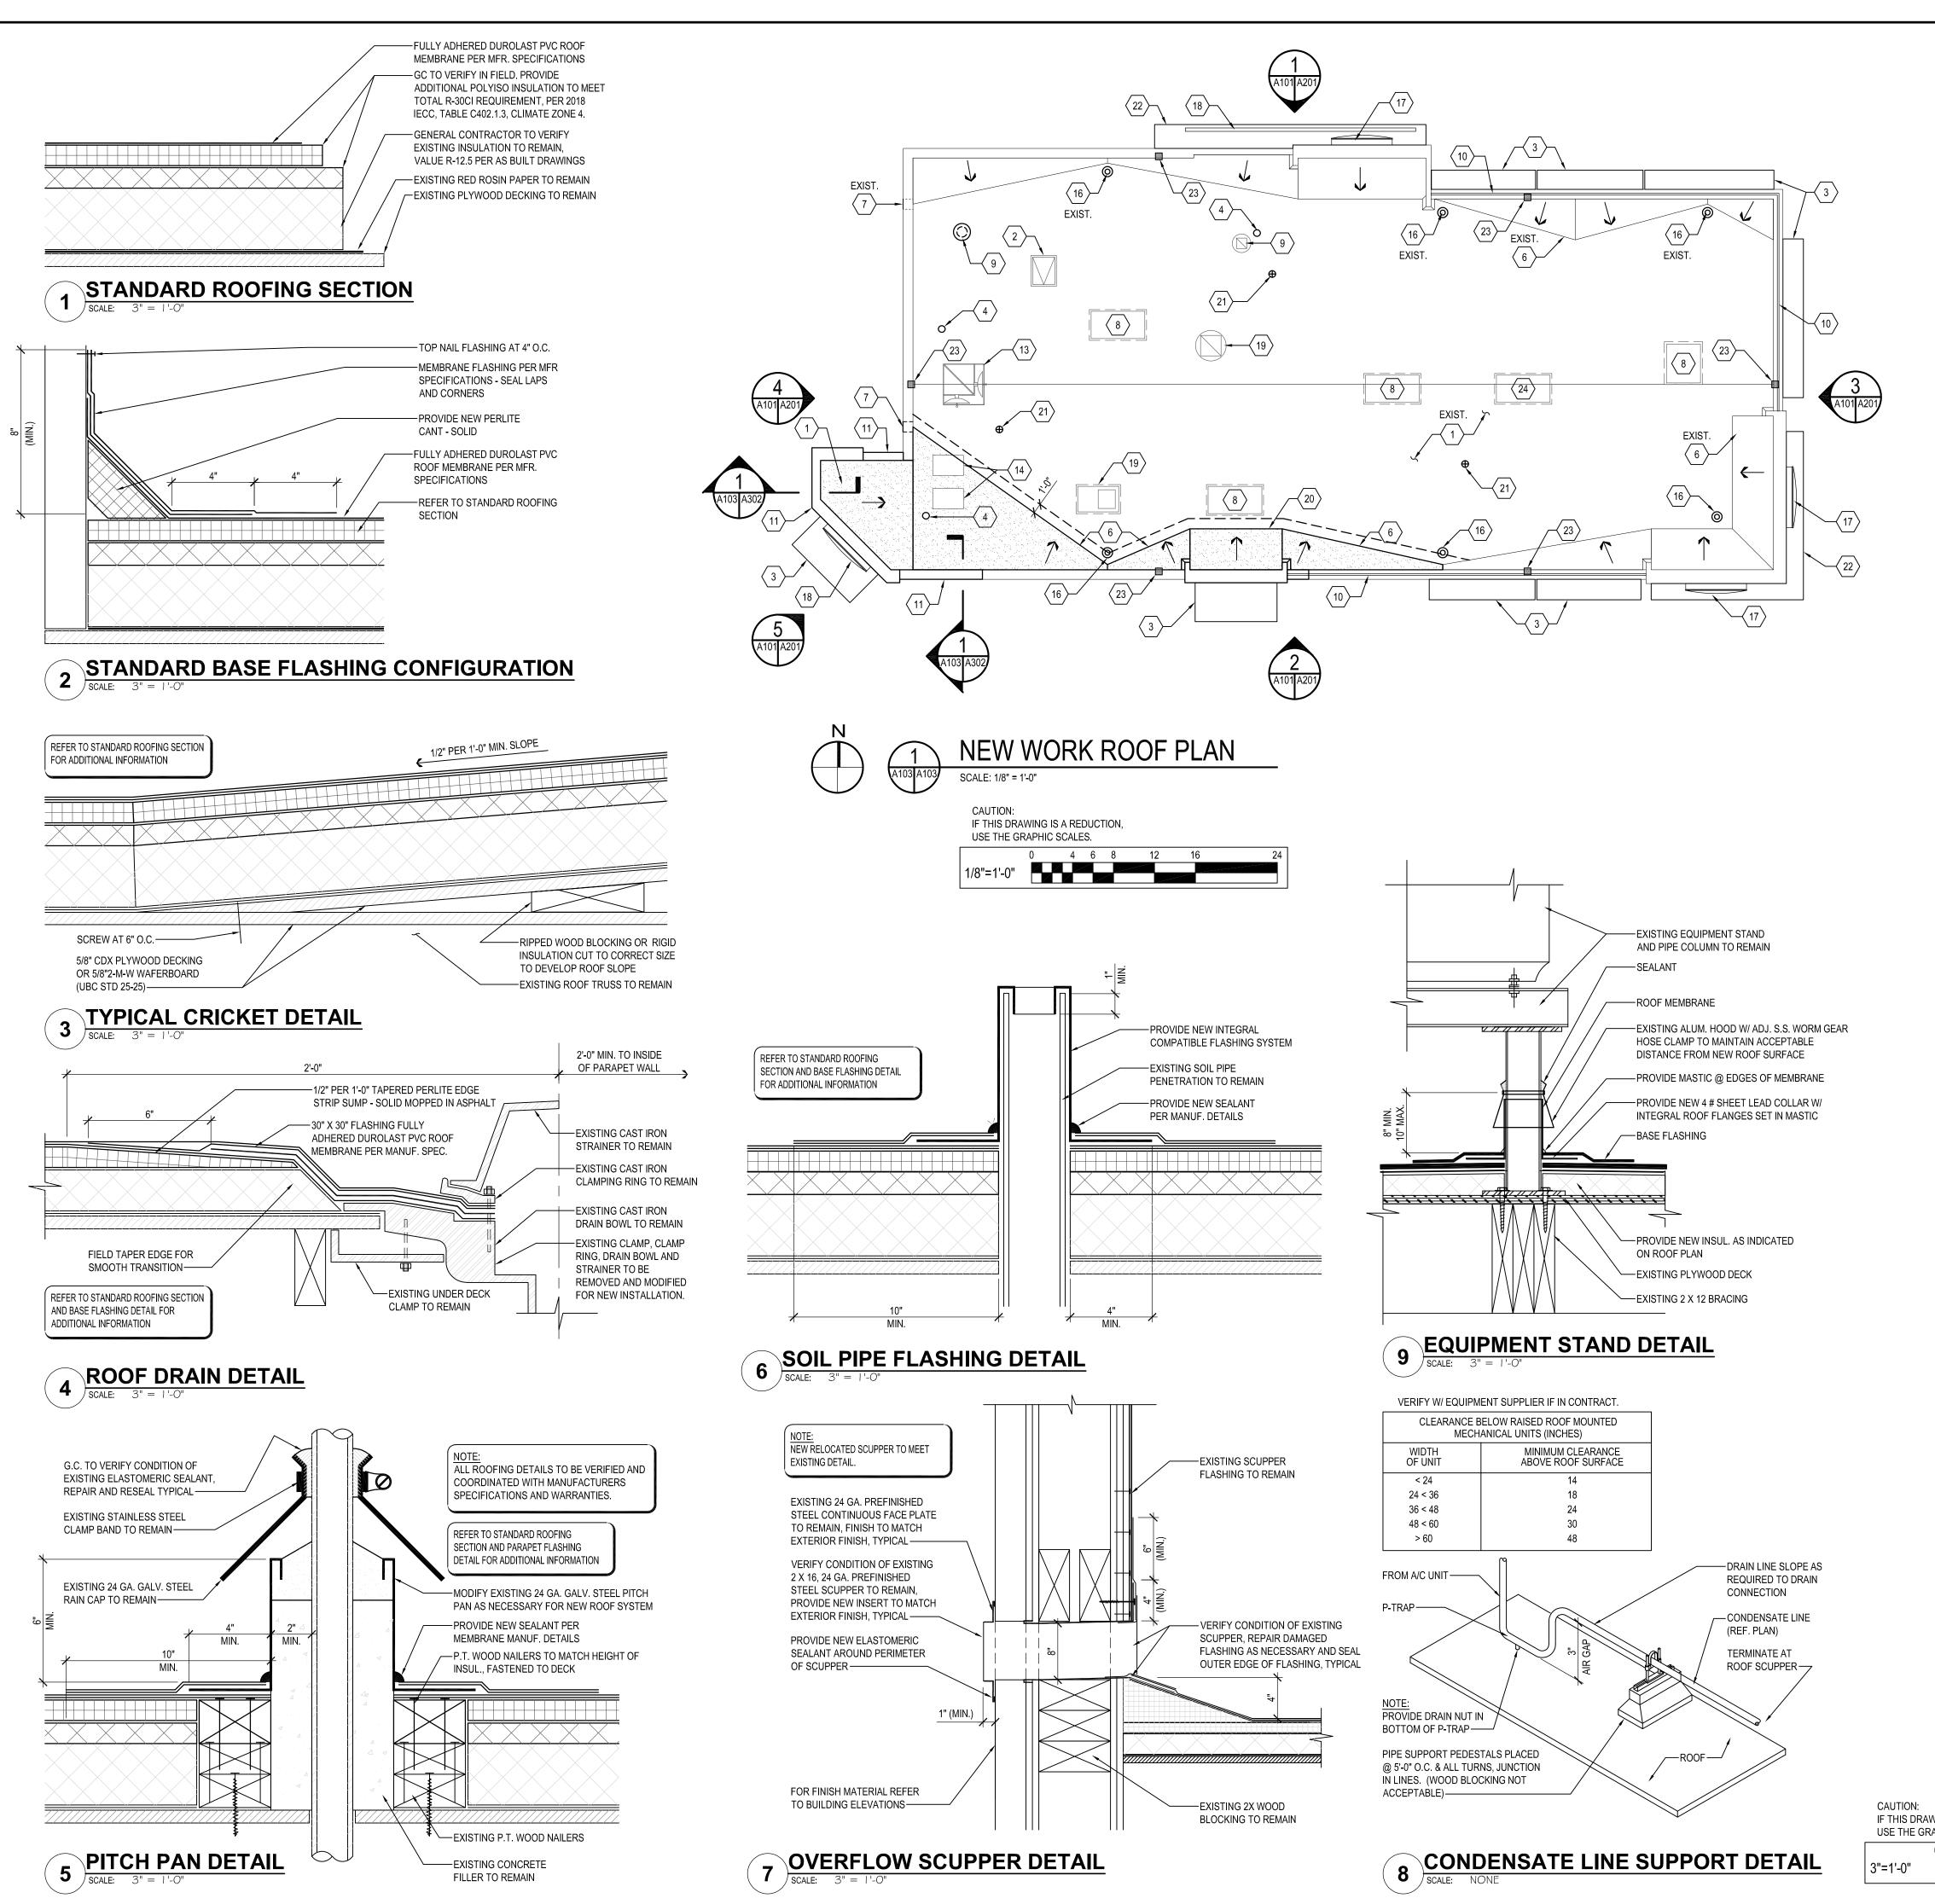

P:\2018\18037504\Drawings\01-Arch\2018037504 - A103 - New Work Roof Plan.dwg

GENERAL NOTES

- A. THE EXISTING ROOF STRUCTURE SHALL NOT BE USED FOR STOCKPILING OF EQUIPMENT OR MATERIALS UNLESS APPROVED BY THE ARCHITECT, STRUCTURAL ENGINEER AND THE JOIST MANUFACTURER.
- B. THE ROOFING SYSTEM SHALL BE AS PER DRAWINGS AND PER MANUFACTURERS
- C. COORDINATE ROOF ELEVATIONS WITH EXISTING ROOF STRUCTURE AND EXISTING OPENING FOR MECHANICAL EQUIPMENT. REFER TO SPECIFICATION SHEET FOR ROOF RELATED ITEMS, INCLUDING GUARANTEES, CURBS, FLASHING, ETC.
- D. PER AS-BUILT DRAWINGS, EXISTING ROOF INSULATION, IS 1 1/2" THICK. REPLACEMENT INSULATION FOR NEW ROOFING SYSTEM MAY BE 6" THICK TO PROVIDE AN R-30. MODIFY EXISTING ROOF TOP EQUIPMENT SUPPORTS, ETC. TO ACCOMMODATE THIS INCREASE IN THICKNESS.
- E. MINIMUM CURB HEIGHT: 8"

SPECIFICATIONS.

GENERAL SHEET NOTES

- 1. ROOFING SUBCONTRACTOR TO COORDINATE LOCATION OF EXISTING H.V.A.C. UNITS AND ROOF TOP ACCESSORIES WITH EXISTING OPENINGS AND EXISTING STRUCTURAL, MECHANICAL AND ELECTRICAL SYSTEMS. COORDINATE WITH STRUCTURAL, MECHANICAL AND ELECTRICAL DRAWINGS. COORDINATE PLACEMENT AND TAPERED RIGID INSULATION BOARD LAY-OUT AND SUBSEQUENT INSTALLATION IN ORDER TO AVOID PONDING WATER CONDITIONS ATTRIBUTABLE TO BOARD LAY-OUT ISSUES.
- 2. ROOF SYSTEMS SPECIFIED SHALL BE APPLIED ONLY BY MANUFACTURER APPROVED APPLICATOR IN ORDER TO MEET GUARANTEE REQUIREMENTS.
- 3. HVAC CONDENSATE LINES TO TERMINATE AT ROOF DRAIN OR AS REQUIRED BY LOCAL CODE.
- 4. REFER TO MEP DRAWINGS FOR ADDITIONAL INFORMATION.
- 5. ALL CURBS AND PIPE PENETRATIONS SHALL HAVE A MINIMUM OF 16" CLEAR FROM EACH OTHER FOR ROOF FLASHING PURPOSES. ALL EQUIPMENT SHALL HAVE A MINIMUM OF 16" CLEAR FROM ALL ADJACENT PARAPETS. ALL HVAC MOUNTED EQUIPMENT (DISCONNECT BOXES, GFCI, PIPE SUPPORTS) SHALL NOT BE CLOSER THAN 16" FROM EACH OTHER OR CURB. NO UNISTRUT PIPE SUPPORTS SHALL BE USED AS VERTICAL MEMBERS FOR MOUNTING EQUIPMENT TO ROOF SURFACE.
- 6. PONDING WATER IS DEFINED AS WATER THAT DOES NOT DRAIN OR DISSIPATE FROM THE ROOF WITHIN 48 HOURS AFTER PRECIPITATION.
- 7. ALL FLASHING CEMENTS, DURO-LAST MEMBRANE, PRODUCTS AND ACCESSORIES SHALL BE APPROVED BY ROOFING MANUFACTURER WITH THE MANUFACTURES'S BRAND. ALL ROOFING PRODUCTS SHALL BE AMERICAN MANUFACTURED PRODUCTS.

○ SHEET KEYNOTES

- 1. FULLY ADHERED DURO-LAST PVC ROOF MEMBRANE. NEW MEMBRANE TO LAP OVER EXISTING, PER MANUFACTURE REQUIREMENTS.
- ROOF ACCESS SCUTTLE TO BE REMOVED, RAISE AND REINSTALLED WITH INSTALLATION OF NEW INSULATION AND ROOF SYSTEM. GENERAL CONTRACTOR TO VERIFY CONDITION OF EXISTING SCUTTLE AND REPAIR FINISH AS NECESSARY.
- 3. PREFABRICATED METAL CANOPY. REFERENCE SHEETS A304.
- 4. EXISTING VENT THROUGH ROOF, PROVIDE PREFABRICATED DURO-LAST VENT FLASHING FOR ALL VENTS AND PIPE PENETRATIONS. REFERENCE DETAIL #6, THIS SHEET.
- 5. INSTALL DURO-LAST PVC ROOF MEMBRANE SACRIFICE SHEET AS SPECIFIED KITCHEN EXHAUST.
- 6. ROOF CRICKET WITH SLOPE TO MATCH ROOF, REFER TO DETAIL #3, THIS SHEET.
- 7. OVERFLOW ROOF SCUPPERS REFER TO DETAIL #7 THIS SHEET.
- 8. ROOFTOP AIR CONDITIONING UNIT REFER TO MECHANICAL PLANS.
- 9. EXHAUST FAN REFER TO MECHANICAL PLANS.
- 10. ILLUMINATED PARAPET LIGHT BAND MP-1.
- 11. RAISED PARAPET WALL WITH NEW PRE FINISHED METAL COPING.
- 12. PVC CONDENSATE DRAIN (SIZE AS SHOWN) WITH PIPE SUPPORTS EVERY 5'-0". TERMINATE CONDENSATE DRAIN AT PRIMARY SCUPPER. REFER TO DETAIL #8, THIS SHEET FOR ADDITIONAL INFORMATION.
- 13. PROVIDE NEW PITCH PAN WITH CONDUIT OVER OFFICE FOR EXISTING SATELLITE DISH/ANTENNA TO BE REMOVED AND REINSTALLED.
- 14. EQUIPMENT STAND FOR WALK-IN BOX COOLER/FREEZER CONDENSERS AND ICE MACHINE CONDENSER. REFER TO EQUIPMENT STAND DETAIL, THIS SHEET.
- 15. NOT USED.
- 16. EXISTING ROOF DRAINS. MODIFY AND EXTEND RAIN WATER LEADER, AS REQUIRED FOR NEW ROOFING SYSTEM AND THICKER INSULATION REFER TO DETAIL #4 THIS SHEET.
- 17. REINSTALL EXISTING SIGNAGE. SIGNAGE TO BE REINSTALLED DURING CONSTRUCTION PHASE.
- 18. NEW SIGNAGE TO BE INSTALLED
- 19. EXISTING EXHAUST FAN ON MODIFY EXISTING CURBS AND OPENING. COORDINATE WITH LOCATION OF FRYER AND BROILER BELOW. CONNECT EXISTING FRYER AND BROILER HOOD WITH ASSOCIATED DUCTWORK.
- 20. CRIPPLE ONTO OTHER SHEATHING AND RAFTERS/KICKERS.
- 21. EXISTING SEALED ROOF VENT TO REMAIN.
- 22. REINSTALL SALVAGED CANOPY. CANOPY TO BE REINSTALLED DURING CONSTRUCTION PHASE.
- 23. WALL MOUNTED METAL VENT REMOVED, PROVIDE BLOCKING AND PLYWOOD SUBSTRATE FLUSH WITH ADJACENT PARAPET WALL. PATCH AND REPAIR WITH ADJACENT ROOF WITH COMPATIBLE DURO-LAST ROOF MEMBRANE
- 24. EXISTING ABANDONED ROOF TOP EQUIPMENT TO REMAIN

CAUTION:
IF THIS DRAWING IS A REDUCTION,
USE THE GRAPHIC SCALES.

0 3" 6" 12"
3"=1'-0"

CHECKED: SCB

SCALE: AS NOTED

DATE: 04/21/2021

PROJECT: 2018.0375.04.0

DRAWING:

JMM

hereby certify that these documents were

prepared or approved by me, and that I am a

icense # 6140 Expiration Date: 08/21/202

BURGER

NEW


DESIGNED:

DRAWN:

laws of the State of Maryland.

duly licensed professional architect under the


04-21-2021 PERMIT SUBMISSION A 103

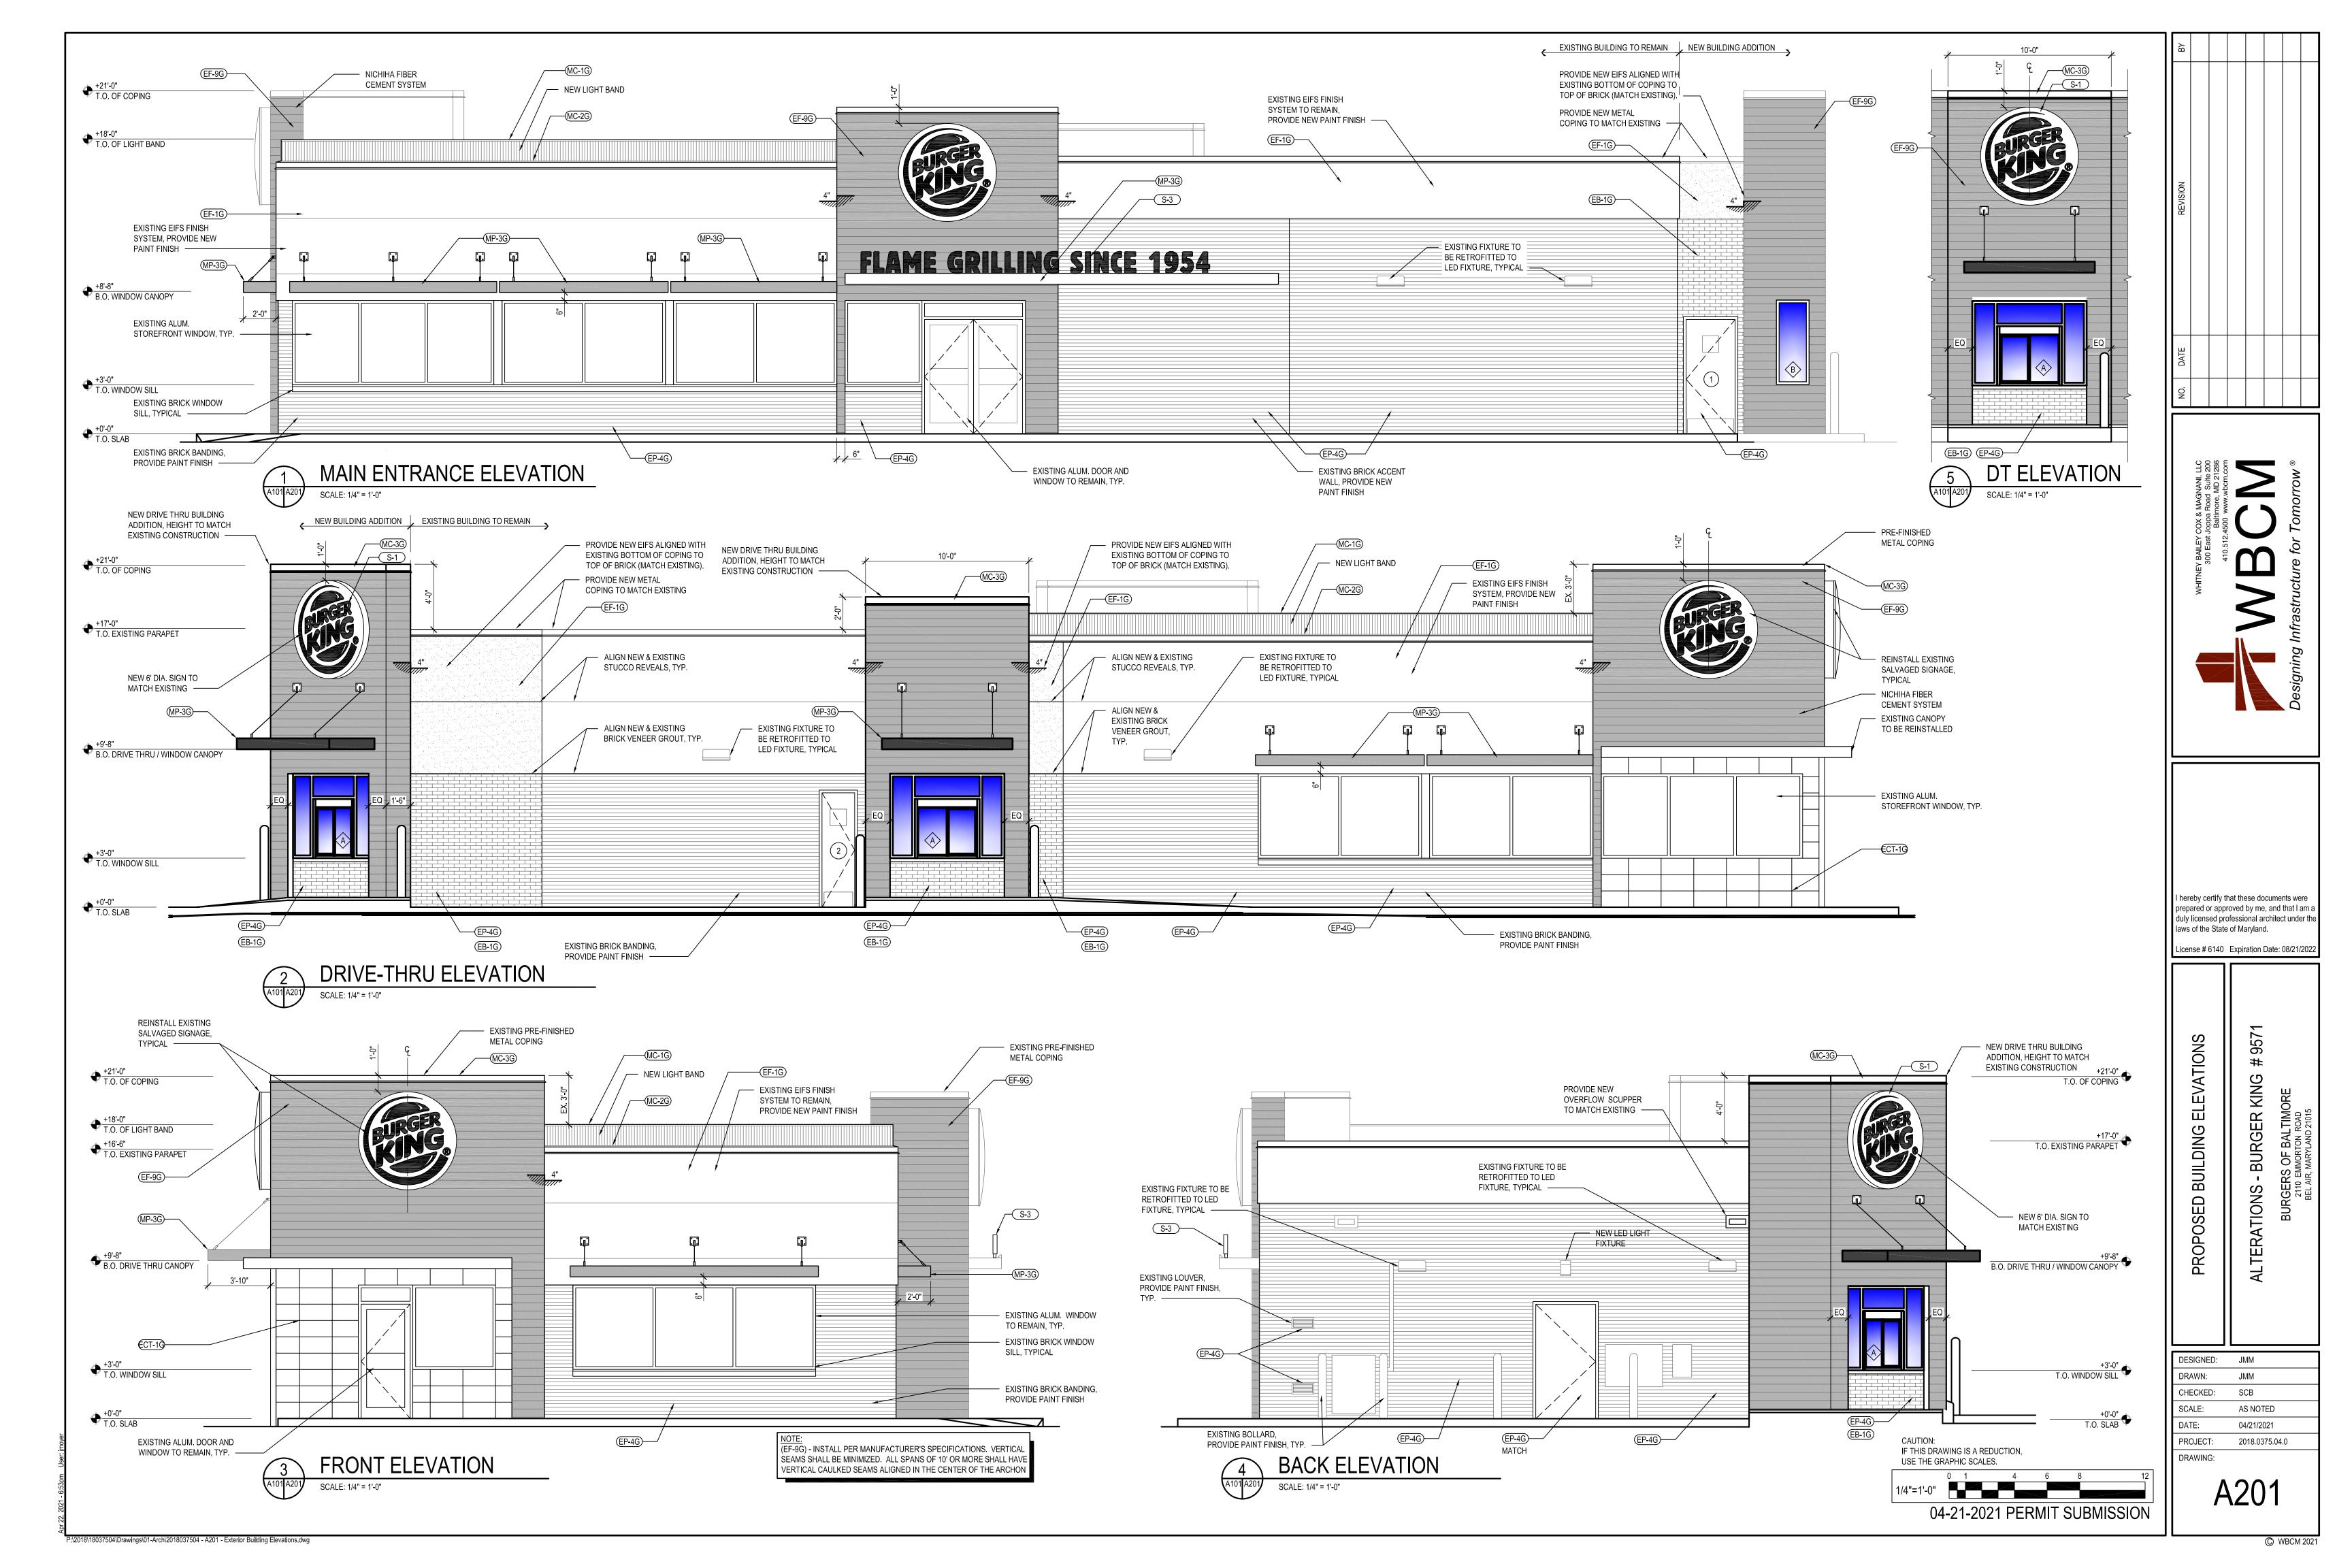


				BURGER KING - 20/20 GAR EXTERIOR MATERIALS & FINISH SCHEDULE								
08/07/19				EXTERIOR MATERIALS & FINISH SCHEDULE	(not all specs are used on every project)							
CODE	MATERIAL	LOCATION	MANUFACTURER	PRODUCT	DESCRIPTION COLOR	DIMENSION	ADDITIONAL INFORMATION					
				MOD / QS TUMBLED (FULL BRICK)	OLDE HILLSBORO	DIMENSION	CONTACT: GABE POWERS (502) 558-4612					
			EVOLUTION BRICK	(THIN BRICK)	SIERRA TUMBLED		NOTE: USE WITH EGR-3G					
EB-1G	EXTERIOR BRICK	GENERAL	PINE HALL BRICK	FACE BRICK	OLD IRVINGTON O/S		CONTACT: THERESA BEANE (800) 334-8689 - tbeane@pinehallbrick.com					
			PINE HALL BRICK	FACE DRICK	OLD INVINGTON 0/3		NOTE: USE WITH EGR-3G CONTACT: ERIN LYNCH (916) 206-7831					
			H.C. MUDDOX BRICK	THIN BRICK	BK WEST COAST BLEND		NOTE: USE WITH EGR-3G					
							CONTACT: JOY DETER AT EUROWEST (714) 309-9551					
ECT-1G	EXTERIOR CERAMIC TILE	ACCENT AT BUILDING FRONT	GRANITI GIANDRE / EUROWEST	SENSIBLE STONE ED5052	"RED NATURAL" STACKED BOND PATTERN	12" X 24"	OR JOY KLEIN (813) 334-3302 jklein@transamerica.com					
							NOTE: USE WITH EGR-4G					
			STO OR APPROVED EQUAL	STO POWERWALL STUCCO SYSTEM TEXTURE: FINE SAND	COLOR TO MATCH EP-2G PPG "DESERT DUNE"		CONTACT: TIM SALERNO AT STO CORP (407) 466-5371					
	EXTERIOR FINISH - STUCCO,		·	OR STO THERM CI EIFS SYSTEM								
EF-1G	STO, FIBER CEMENT SIDING PANELS	GENERAL			PREPAINTED TO MATCH EP-2G - PPG "DESERT DUNE"		CONTACT NICHIHA CUSTOMER SERVICE (770) 805-9466 BK@NICHIHA.COM					
			NICHIHA FIBER CEMENT	NICHIHA TUFFBLOCK	STACKED BOND PATTERN	18" X 6'	INSTALL PER MANUFACTURER'S SPECIFICATIONS					
					COLOR TO MATCH EP-4G		VERTICAL APPLICATIONS ONLY (NOT FOR USE ON SOFFITS) CONTACT: TIM SALERNO AT STO CORP (407) 466-5371					
EF-4G	EXTERIOR FINISH STUCCO	GENERAL	STO OR APPROVED EQUAL	STO POWERWALL STUCCO SYSTEM	PPG "GRANITE"		CONTACT, TIP SALERNO AT STO CORT (407) 400 5571					
	EXTERIOR FINISH						CONTACT NICHIHA CUSTOMER SERVICE (770) 805-9466					
EF-9G	FIBER CEMENT						BK@NICHIHA.COM INSTALL PER MANUFACTURER'S SPECIFICATIONS. VERTICAL					
							SEAMS SHALL BE MINIMIZED. ALL SPANS OF 10' OR MORE SHALL					
			NICHIHA FIBER CEMENT	VINTAGE WOOD EF762	"CEDAR"	18" X 10'	HAVE VERTICAL SEAMS ALIGNED IN THE CENTER OF THE ARCHON. SEAMS TO BE CAULKED WITH EC-1G OR USE "H-MOLD"					
TR-1G	ALUMINUM TRIMS	EXTERIOR SIGN ARCHONS					FACTORY TRIMS. ALL TRIMS SHALL BE FACTORY PAINTED					
							TO MATCH PANELS.					
							VERTICAL APPLICATIONS ONLY (NOT FOR USE ON SOFFITS) CONTACT: MATT KLINGE AT ADFAST (314) 753-0964					
EC-1G	EXTERIOR CAULK		ADSEAL PRODUCTS	ADSEAL 458-63	"VINTAGE WOOD CEDAR"		matt.klinge@adfastcorp.com					
				PRIMER: 17-921	"DESERT DUNE" 1023-4, former "TANNERS TAUPE"		NOTE: USE WITH EF-9G CONTACT: KEVIN LASTACY @ PPG					
EP-2G	EXTERIOR PAINT	EXTERIOR GENERAL		PAINT: 6-2045XI	PPG1023-4		Corporate National Accounts Manager					
EP-4G	EXTERIOR PAINT	EXTERIOR WAINSCOT	[PRIMER: 17-921 PAINT: 6-2045XI	"GRANITE" 1022-6 , former "MONTERREY CLIFFS" 10YY 14/080		(616) 335-3259 klastacy@ppg.com					
				PRIMER: 6-212	"STEPPING STONE" 1010-4 , former "BURGER KING SILVER"		NOTE: FOR REMODELS ONLY					
EP-6G	EXTERIOR PAINT	LOGO SIGN CABINETS & BURGER KING CHANNEL LETTER CABINETS		PAINT: 6-230	Custom Formula		NOT FOR USE ON ROOFS.					
		EXISTING MANSARD ROOFS,		PRIMER: 17-921	"DOVER GRAY" 1001-1 , former "GRYMMYS GREY"		SEE EP-6AG & EP-6BG NOTE: BY EXCEPTION FOR REMODELS ONLY					
EP-6AG	EXTERIOR PAINT	SHINGLES & BARREL TILE	PPG	PAINT: 90-1110	00NN 20/000							
EP-6BG	EXTERIOR PAINT	EXISTING STANDING SEAM METAL ROOF		PRIMER: 90-712 PAINT: 90-1110	"GRAY STONE" 1009-4 , former "MARCH WIND" Custom Formula		NOTE: BY EXCEPTION FOR REMODELS ONLY					
EP-8BG	EXTERIOR PAINT	METAL COPING AT ARCHON		PRIMER: 17-921	"CARAVEL BROWN" 1079-6 , former "CEDAR"							
LF-0DG	LATERIOR PAINT	TOWERS		PAINT: 6-2045XI PRIMER: 90-712	Custom Formula "BLACK"							
EXT-1G	EXTERIOR PAINT	POLES & POLE SIGN		PAINT: 90-353	DLACK							
EXT-2G	EXTERIOR PAINT	SIGNS		PRIMER: 90-712	Tint to match							
				PAINT: 90-375 PRIMER:	PPG 1006-6 "DECONSTRUCTION" "TAUPE TONE"		Contact: GLENN REMLER, ARCHITECTURAL ACCOUNT EXECUTIVE					
				Loxon Concrete & Masonry A24W300	SW 7633							
EP-2G	EXTERIOR PAINT	EXTERIOR GENERAL		PAINT: Superpaint Ext Satin A89 Series			phone: (954) 547-1217					
				Satin			email: Glenn.J.Remler@Sherwin.com					
				PRIMER: Loxon Concrete & Masonry A24W300	"HOMESTEAD BROWN" SW 7515							
EP-4G	EXTERIOR PAINT	EXTERIOR WAINSCOT	EXTERIOR WAINSCOT	EXTERIOR WAINSCOT	EXTERIOR WAINSCOT	EXTERIOR WAINSCOT	EXTERIOR WAINSCOT		PAINT:	3W 7515		
				Superpaint Ext Satin A89 Series								
				Satin PRIMER:	FACTORY FINISH SILVER		NOTE: FOR REMODELS ONLY					
EP-6G	EXTERIOR PAINT	LOGO SIGN CABINETS & BURGER		Kem Bond HS B50A28								
		ING CHANNEL LETTER CABINETS	ING CHANNEL LETTER CABINETS	KING CHANNEL LETTER CABINETS		PAINT: Silver Brite B59S11			NOT FOR USE ON ROOFS.			
			SHERWIN-WILLIAMS	PRIMER:	"CEDAR"							
EP-8G	EXTERIOR PAINT	METAL COPING AT ARCHON		Pro Industrial Pro-Cryl Primer B66-310 PAINT:	Custom Formula							
L1 00	EXTERIOR FAINT	TOWERS		Pro Industrial High Performance Acrylic B66-650								
				Semi-Gloss PRIMER:	FACTORY FINISH BLACK							
				Pro Industrial Pro-Cryl Primer B66-310	LACTORT LINISH DLACK							
EXT-1G	EXTERIOR PAINT	POLES & POLE SIGN		PAINT:								
				Pro Industrial High Performance Acrylic B66-600 Gloss								
				PRIMER:	FACTORY FINISH TO MATCH							
EXT-2G	EXTERIOR PAINT	SIGNS	SIGNS		Pro Industrial Pro-Cryl Primer B66-310 PAINT:	SW 6075 "GARRET GRAY"						
5				Pro Industrial High Performance Acrylic B66-600								
	-			Gloss			NOTE: USE WITH EB-1G					
EGR-3G	GROUT	BRICK	MAPEI		#5 "CHAMOIS"							
							NOTE: USE WITH ECT-1G *** FOR SETTING MATERIALS USE COMPLETE CONTACT RAPID SET					
EGR-4G	GROUT	CERAMIC TILE	CUSTOM BUILDING PRODUCTS	POLYBLEND SANDED	#335 "WINTER GRAY"		*** FOR SETTING MATERIALS USE COMPLETE CONTACT RAPID SET *** SEAL GROUT WITH AQUAMIX SEALERS CHOICE GOLD					
							CONTACT, W.D. HICKMAN COMPANY (020) CTC 4700 . WWW. WTW.					
MC-1G	METAL COPING	TOP OF LIGHT BAND		PERMA SNAP PLUS	A-30 "SILVERSMITH"		CONTACT: W.P. HICKMAN COMPANY (828)676-1700 - WWW.WPH.COM					
	2	WALL CAP										
MC-2G	METAL COPING	BELOW LIGHT BAND	W.P. HICKMAN SYSTEMS, INC.	PERMA SNAP PLUS	FACTORY FINISH TO MATCH EP-2G PPG "TANNERS TAUPE"							
I*IC-2G	METAL CUPING	DELOW LIGHT DAND	WILL LIEUNIAN STOTEMS, INC.	FERMA SIVAY PLUS	FFG TAININERS TAUPE							
					TO BE PAINTED TO MATCH EP-8G							
MC-3G	METAL COPING	TOP OF ARCHON		PERMA SNAP PLUS	PPG "CEDAR"							
							PRODUCT INFORMATION: KEVIN RUBOTTOM AT LEKTRON					
	1	PARAPET LIGHT BAND	LEKTRON *SEE APPROVED SIGN SUPPLIERS	LED LIGHT BAND		*SEE PLANS	(800) 634-4059 OR (918) 622-4978 Email: KRubottom@lektroninc.com					
MP-1G		PARAPET LIGHT BAND	SEE APPROVED SIGN SUPPLIERS I		·		Linali. Krabottomwicki omitc.com					
MP-1G		PARAPET LIGHT BAND	"SEE APPROVED SIGN SUPPLIERS				Email. Krubottom@lektromic.com					
MP-1G MP-3G	METAL CANOPY	ABOVE DOORS AND WINDOWS	*SEE APPROVED SIGN SUPPLIERS *SEE APPROVED CANOPY SUPPLIERS	CUSTOM METAL CANOPY	COLOR: CLEAR ANODIZED	*SEE PLANS	Email. Krubottom@lektromite.com					

REVISION BY	
NO. DATE	
WHITNEY BAILEY COX & MAGNANI, LLC 300 East Joppa Road Suite 200 Raltimore MD 21286	A10.512.4500 www.wbcm.com A10.512.4500 www.wbcm.com
	Designing
prepared or a duly licensed laws of the St	fy that these documents were pproved by me, and that I am a professional architect under the ate of Maryland. Expiration Date: 08/21/2022
EXTERIOR FINISH SCHEDULE	ALTERATIONS - BURGER KING #9571 BURGERS OF BALTIMORE 2110 EMMORTON ROAD BEL AIR, MARYLAND 21015
DESIGNED: DRAWN: CHECKED: SCALE: DATE: PROJECT: DRAWING:	JMM JMM SCB AS NOTED 04/21/2021 2018.0375.04.0
	4202

04-21-2021 PERMIT SUBMISSION

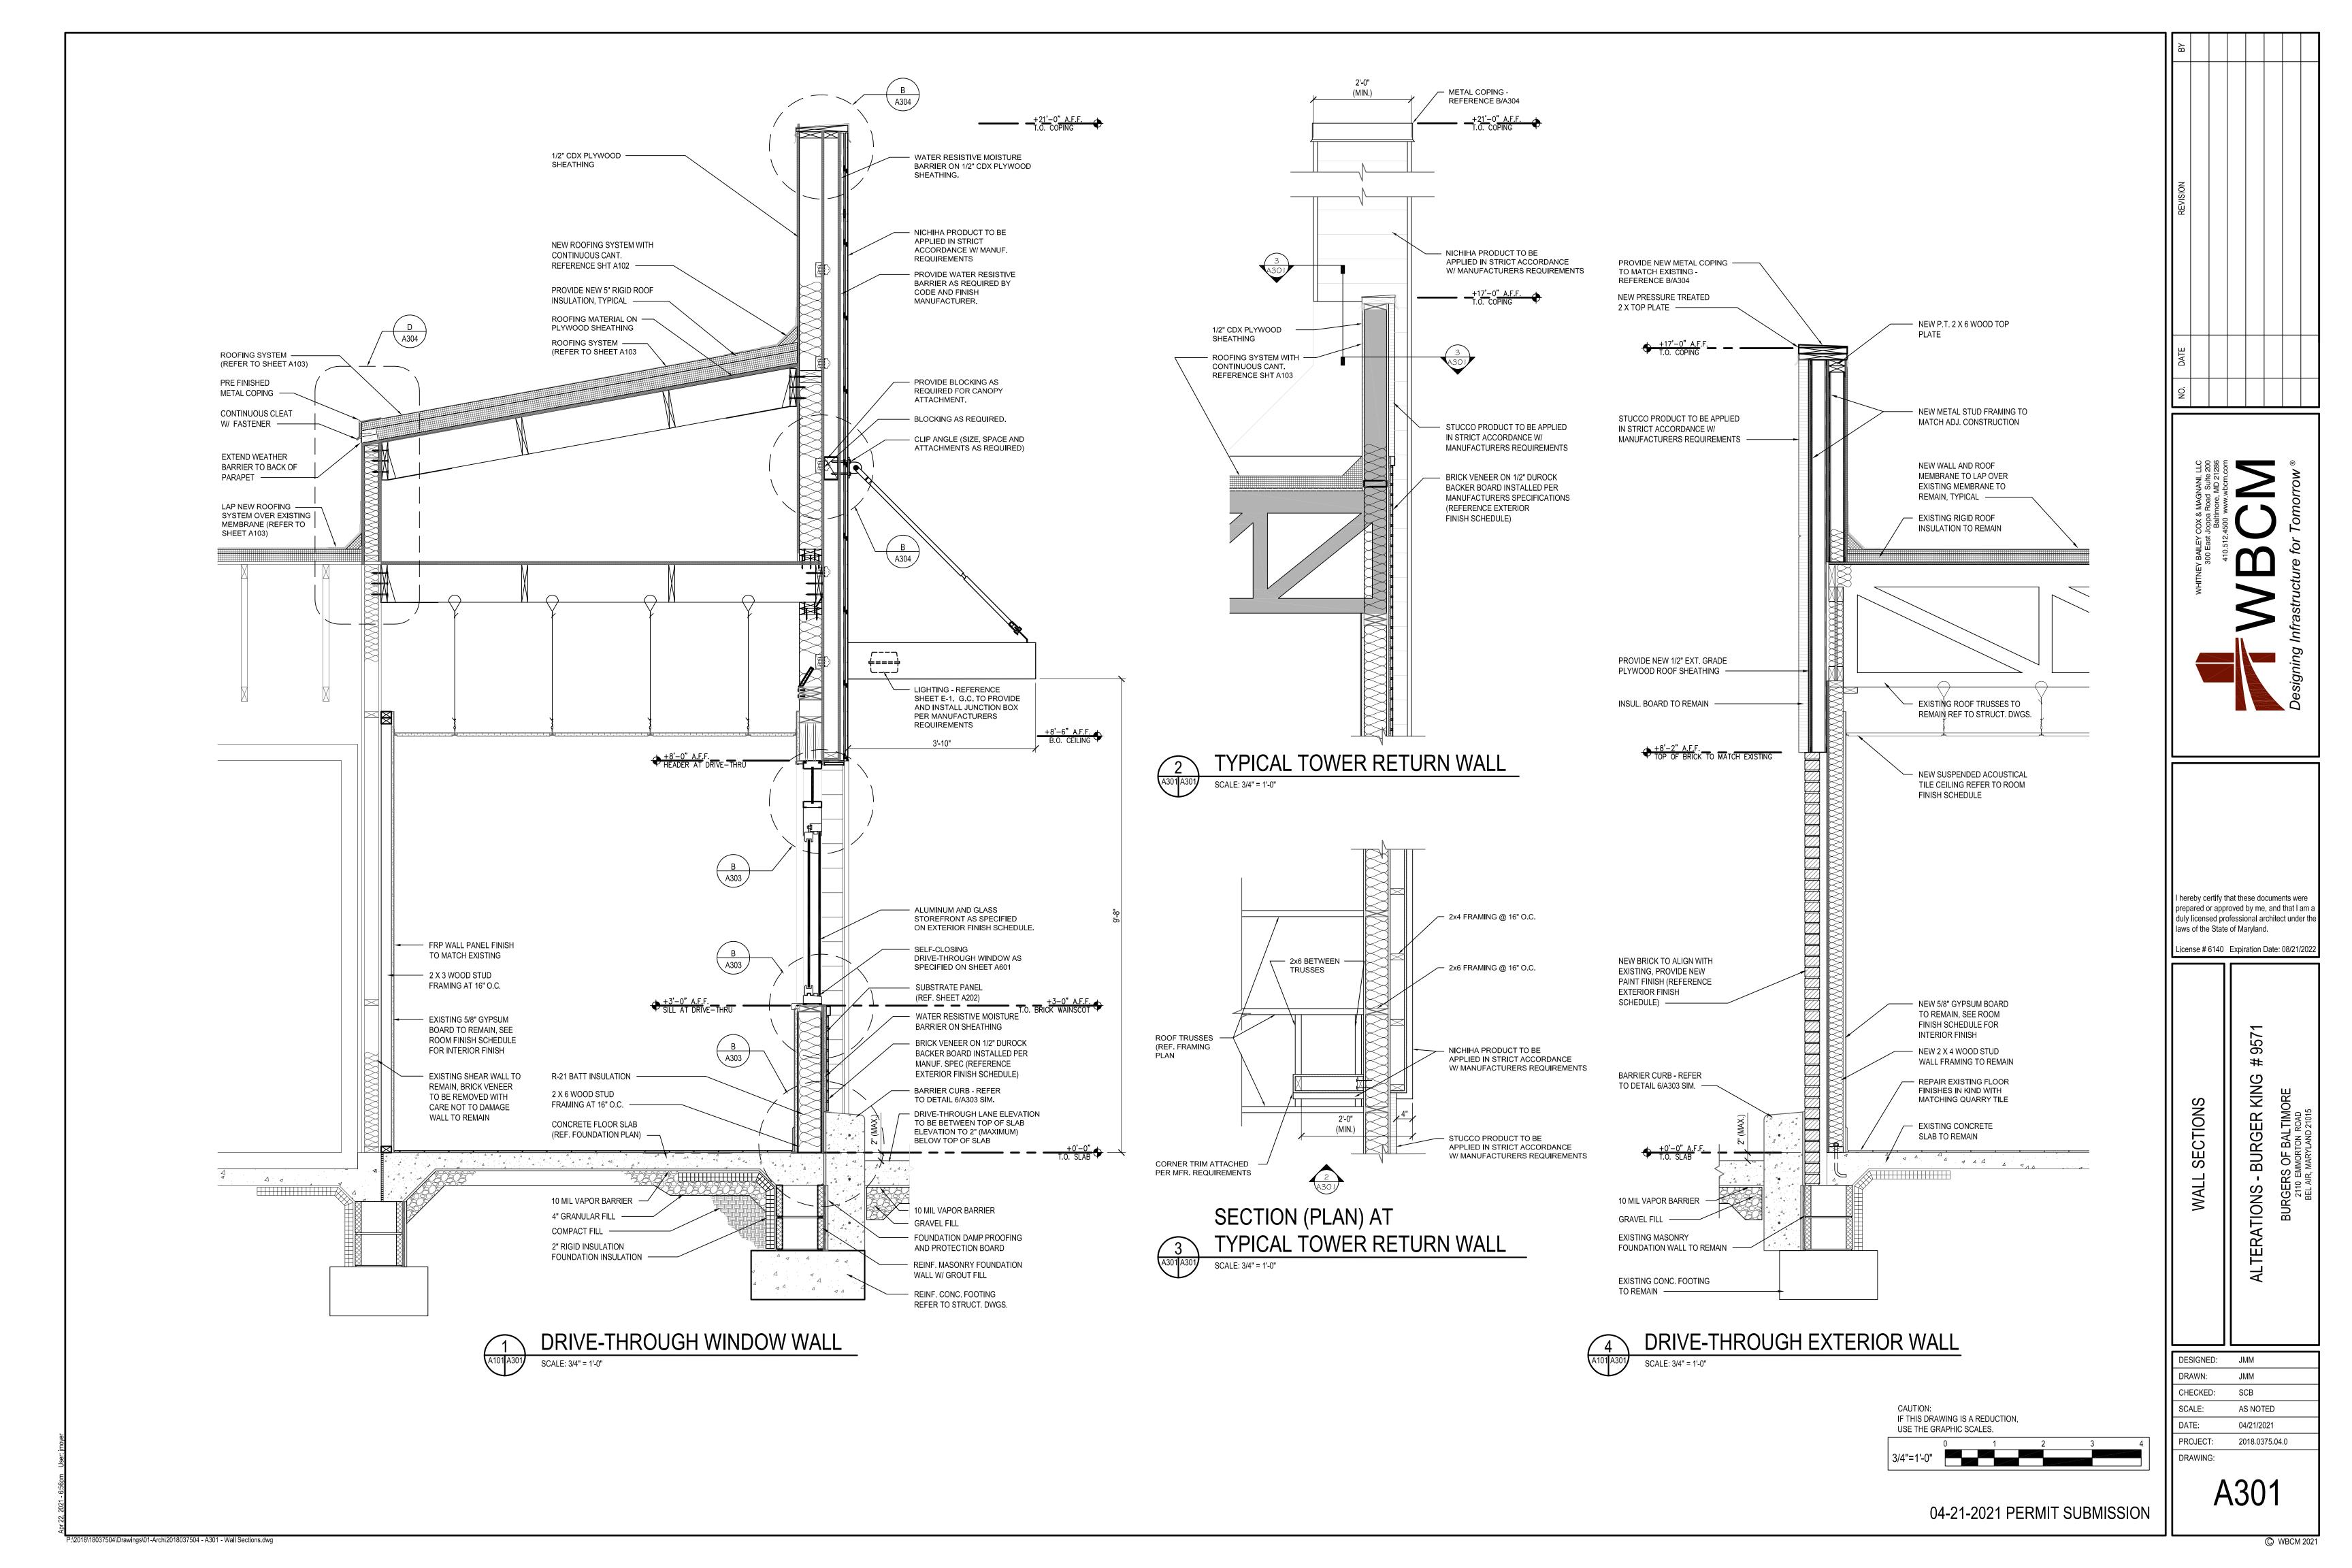

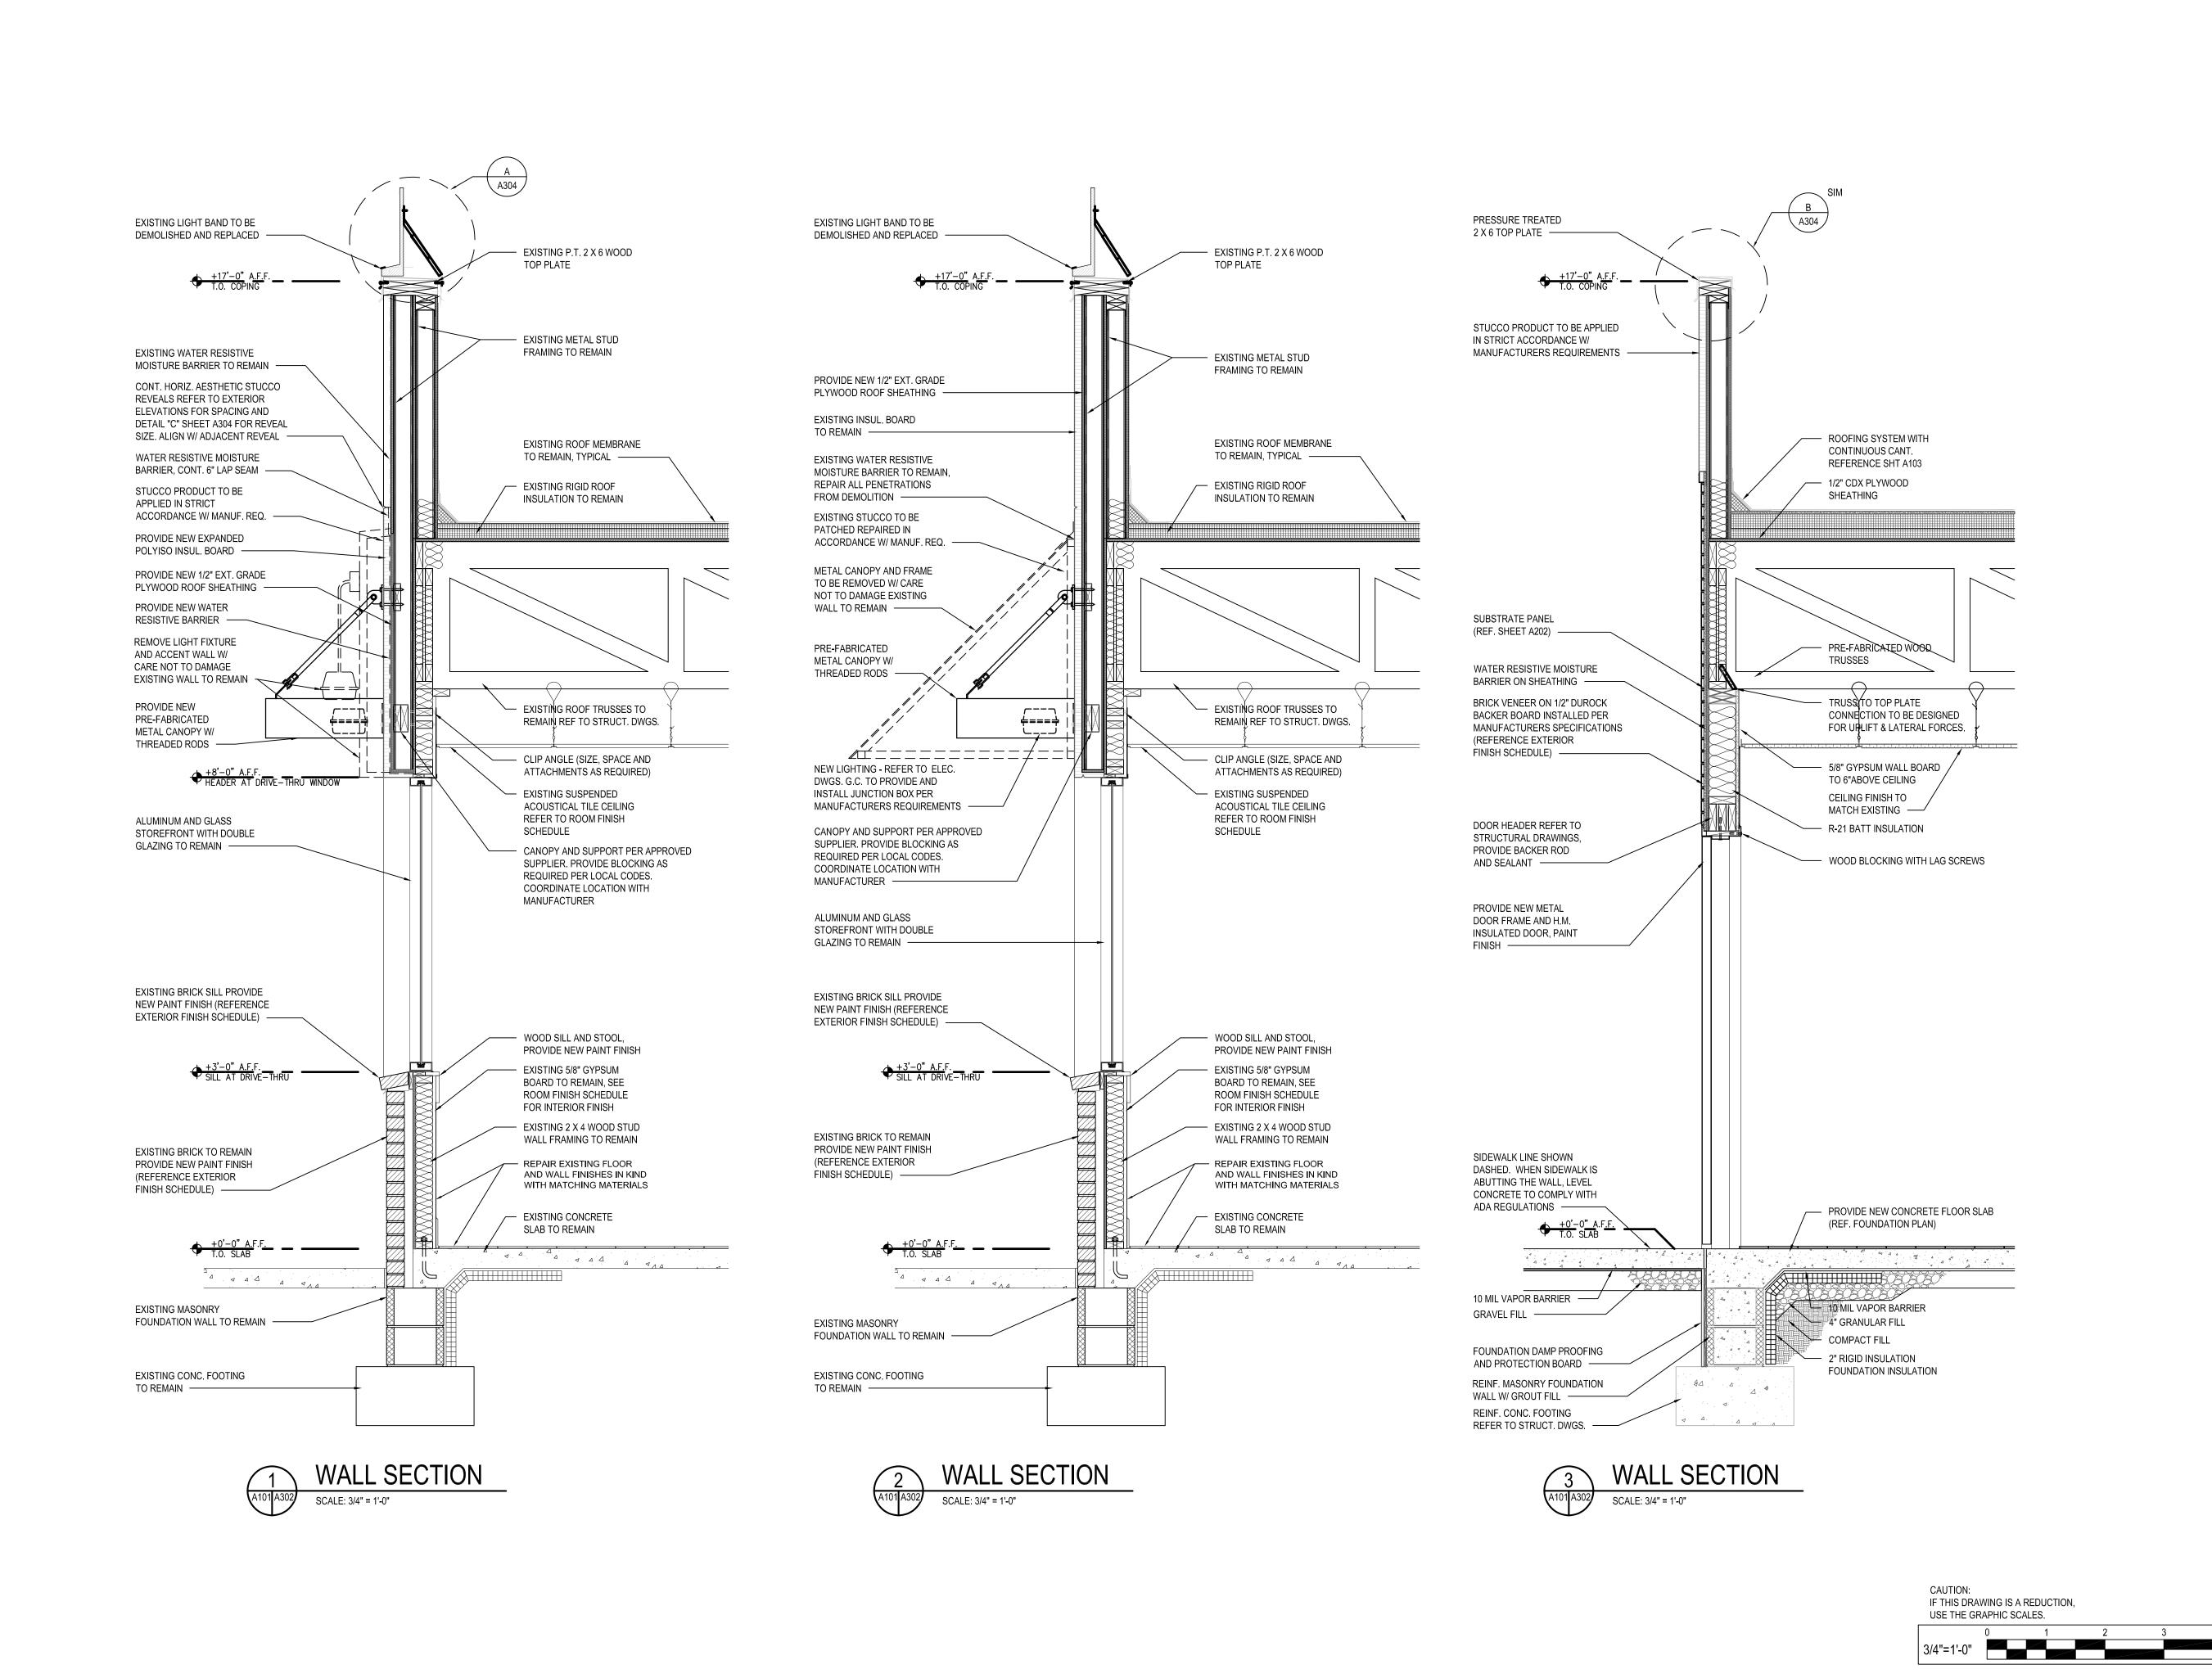

P:\2018\18037504\Drawings\01-Arch\2018037504 - A302 - Wall Sections.dwg

I hereby certify that these documents were prepared or approved by me, and that I am a duly licensed professional architect under the laws of the State of Maryland. License # 6140 Expiration Date: 08/21/2022 SECTIONS BURGER RATIONS DESIGNED: JMM

04-21-2021 PERMIT SUBMISSION

DRAWN:

CHECKED:

PROJECT:

DRAWING:

SCALE:

JMM


SCB


AS NOTED

04/21/2021


A302

2018.0375.04.0

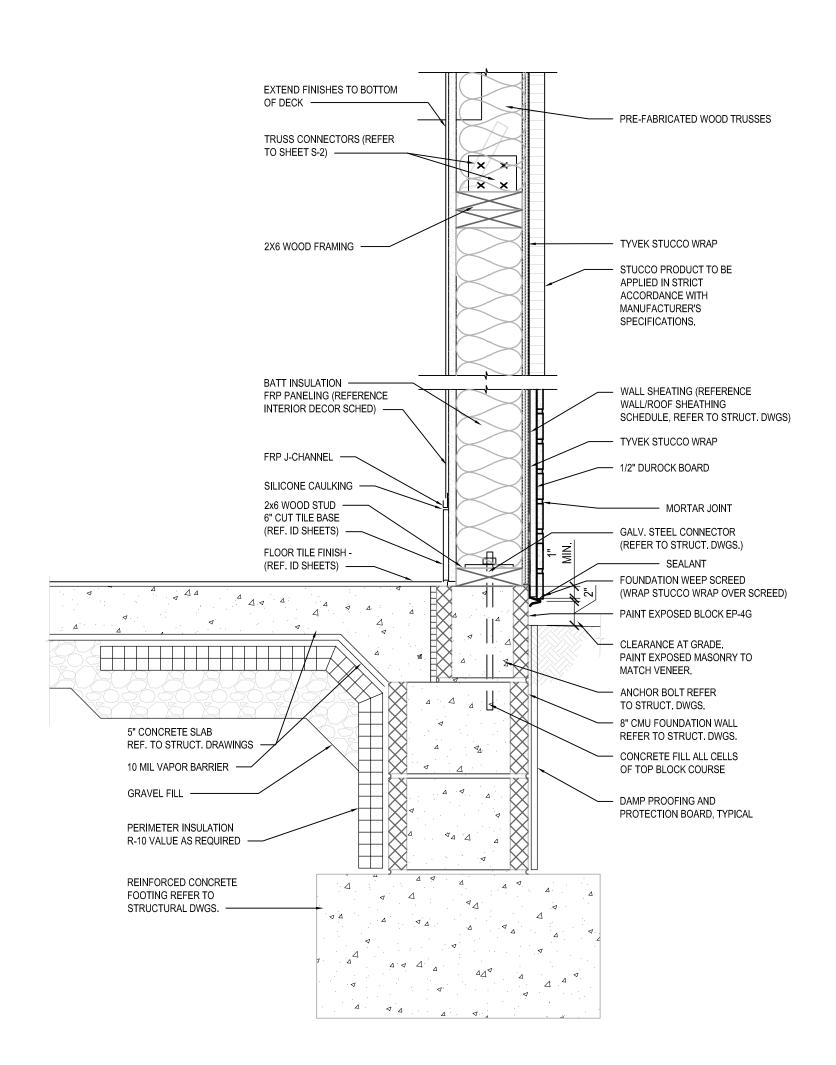


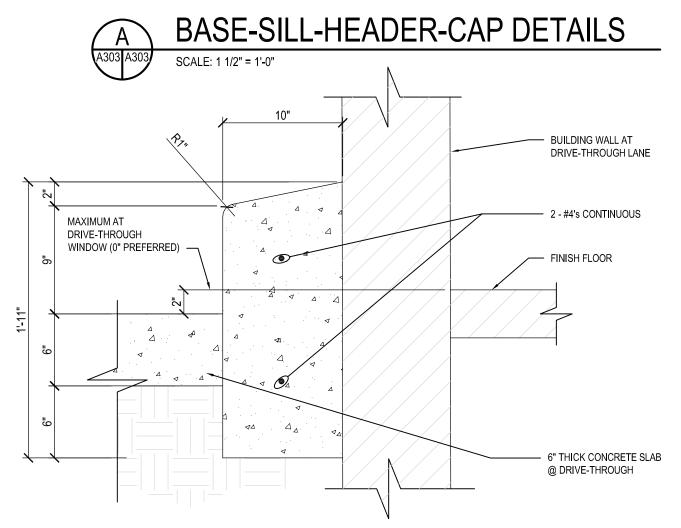




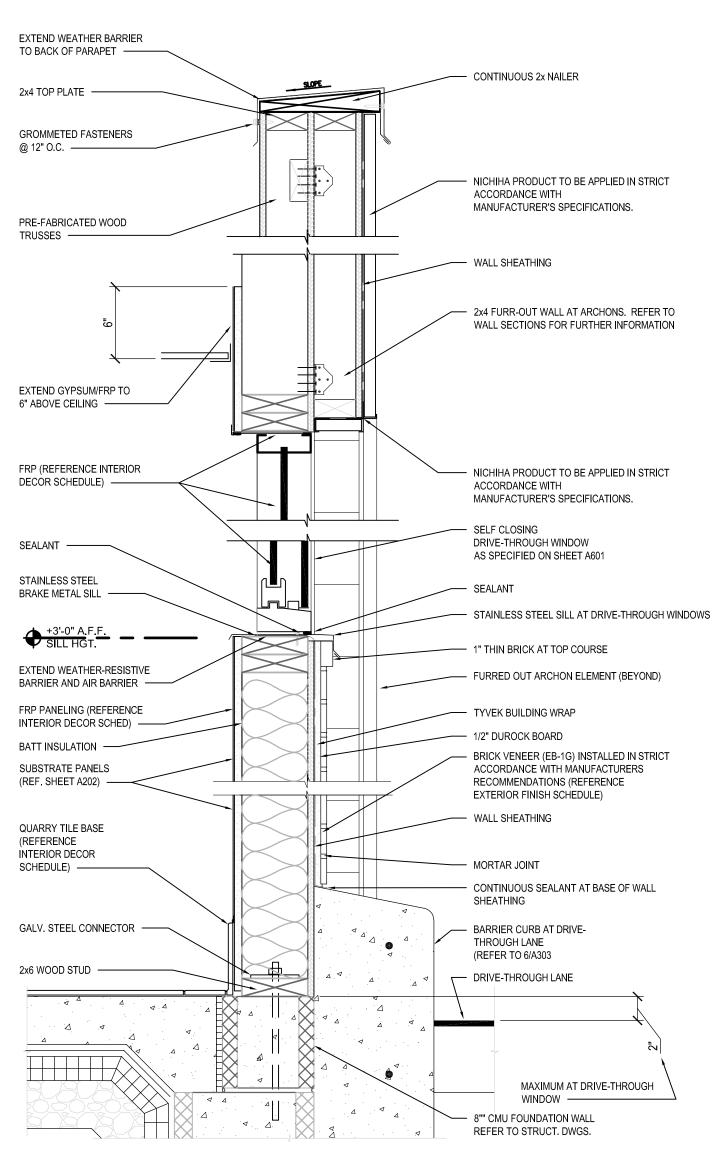


DRIVE THROUGH BASE-SILL-HEADER-CAP DETAILS SCALE: 1 1/2" = 1'-0"

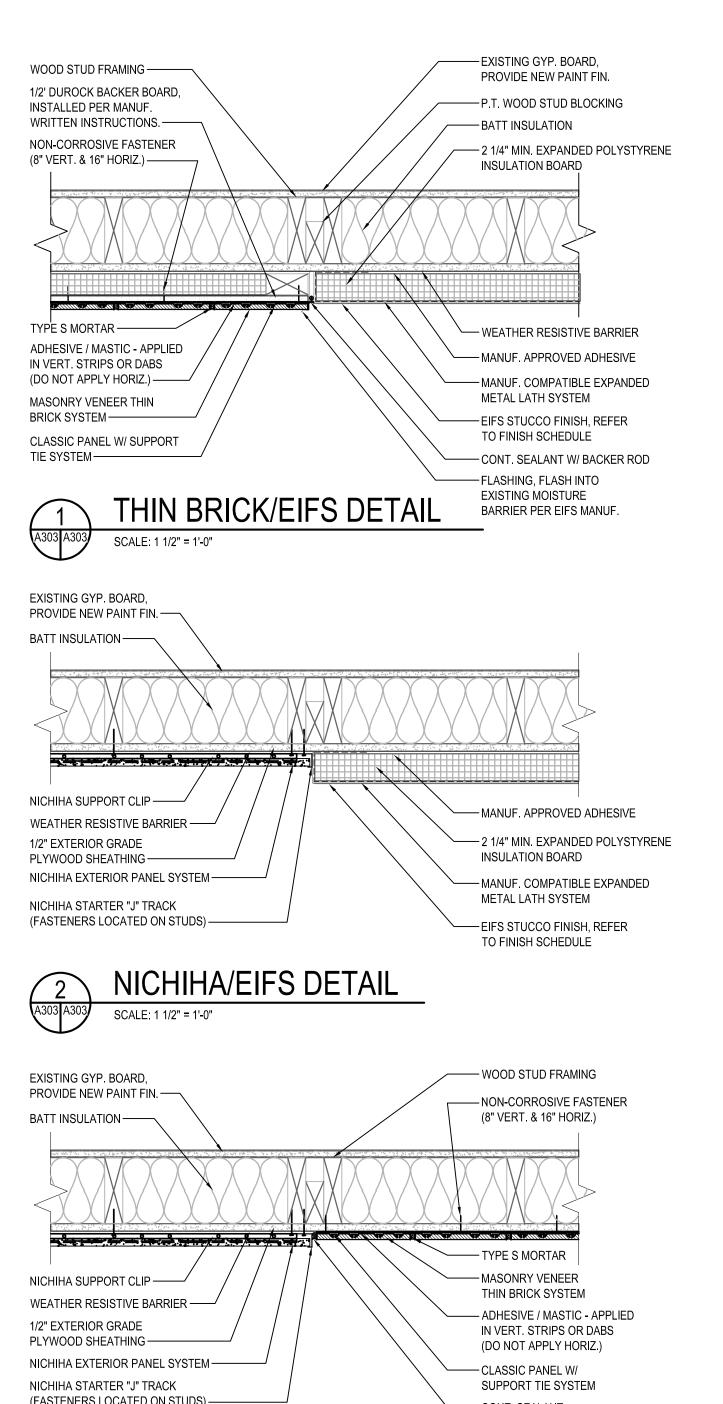


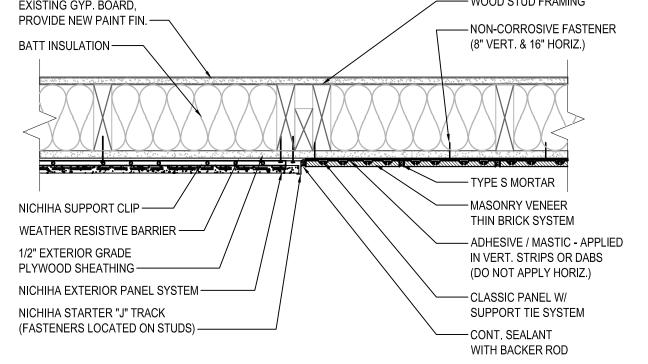




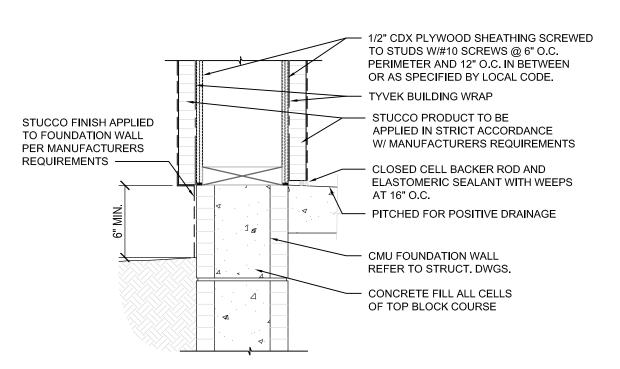




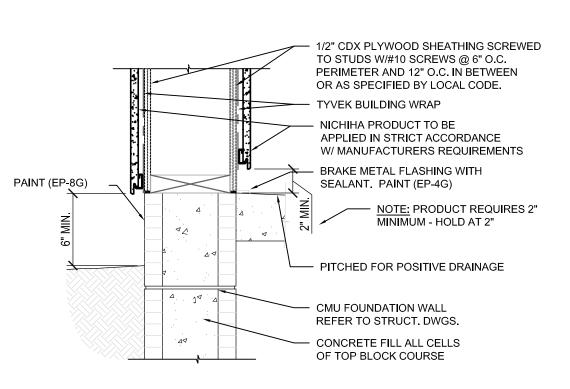



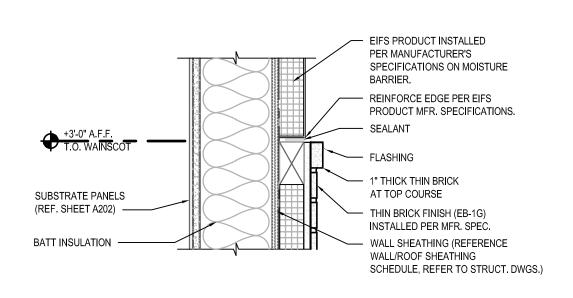

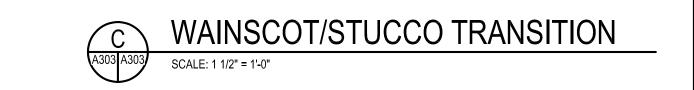

CAUTION: IF THIS DRAWING IS A REDUCTION, USE THE GRAPHIC SCALES.

04-21-2021 PERMIT SUBMISSION

DESIGNED: DRAWN: JMM SCB CHECKED: SCALE: AS NOTED 04/21/2021 PROJECT: 2018.0375.04.0 DRAWING: A303

I hereby certify that these documents were

prepared or approved by me, and that I am

laws of the State of Maryland.

SECTIONS

WALL

duly licensed professional architect under the


License # 6140 Expiration Date: 08/21/202


- BURGER


TERATIONS


© WBCM 2021

P:\2018\18037504\Drawings\01-Arch\2018037504 - A303 - Wall Sections.dwg

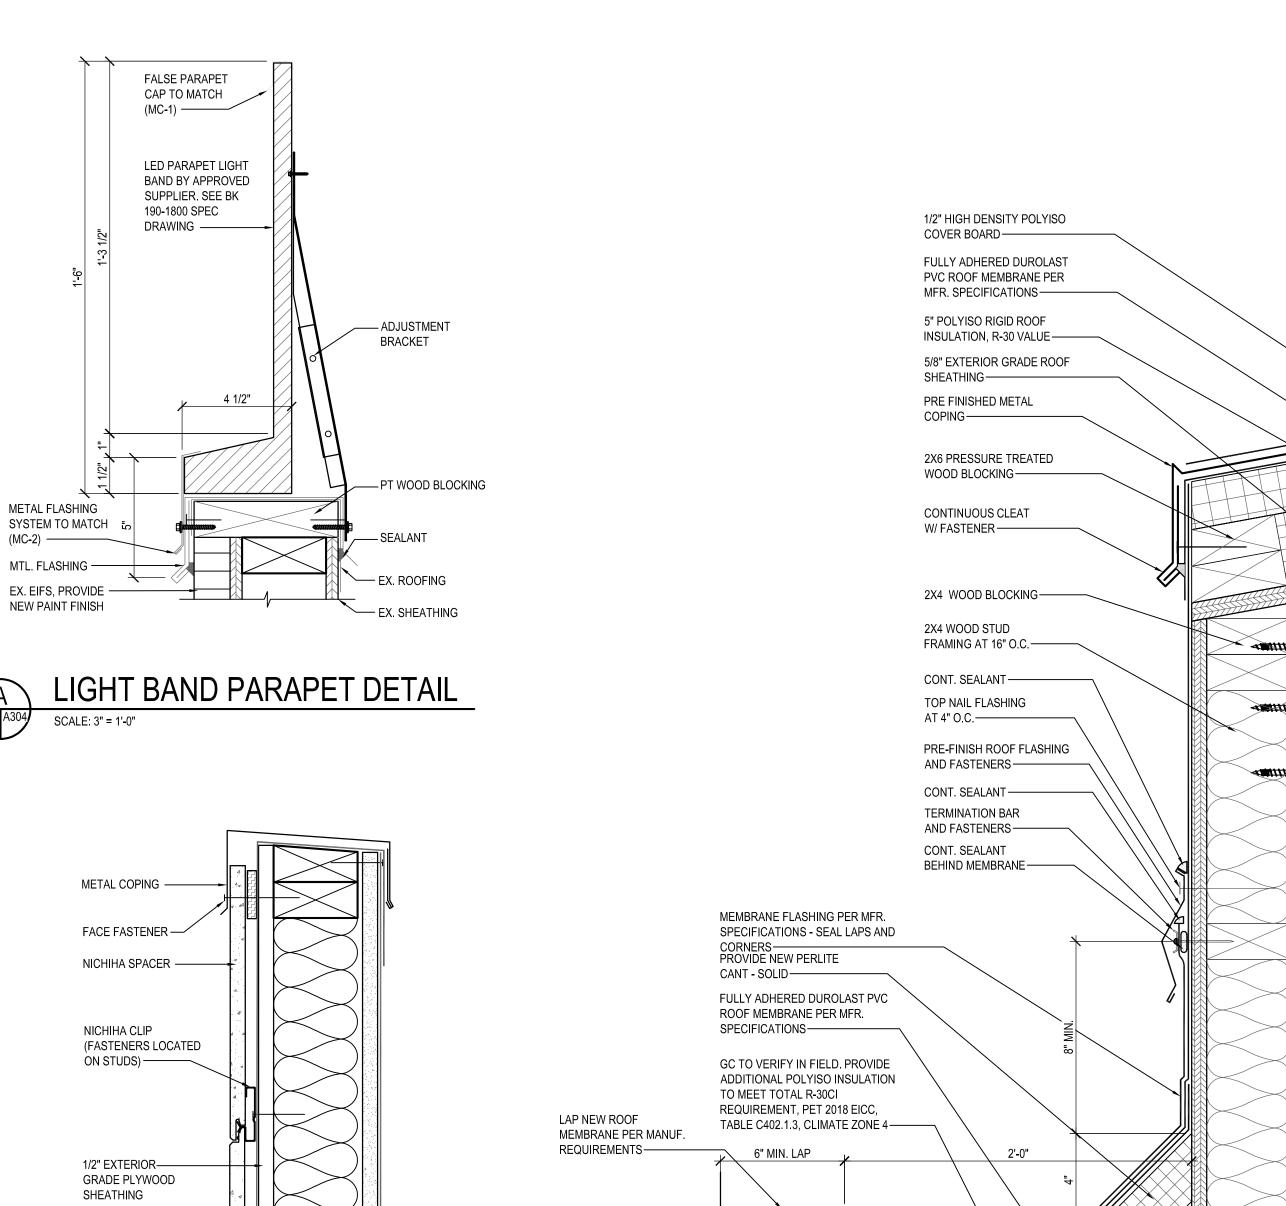

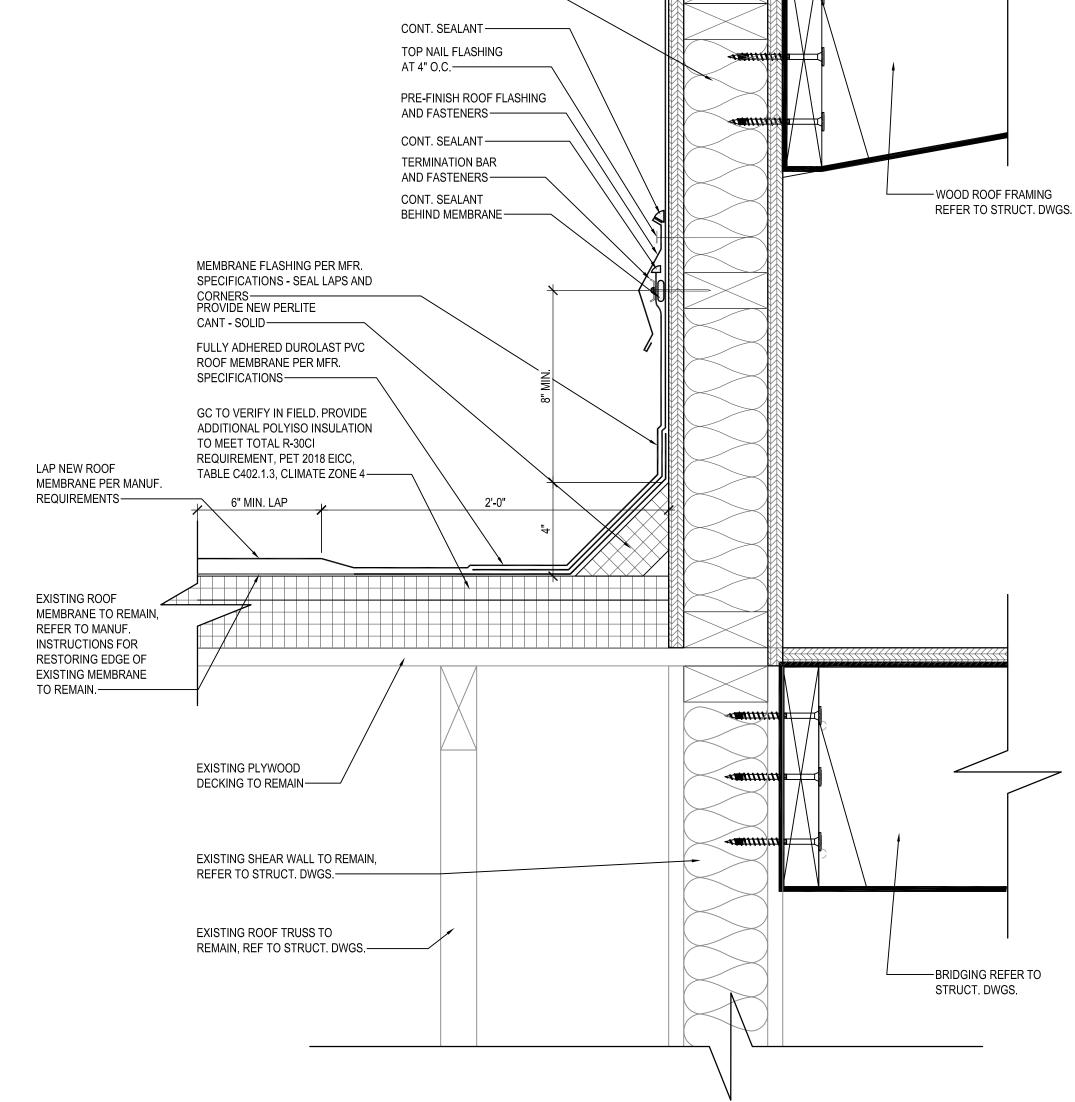

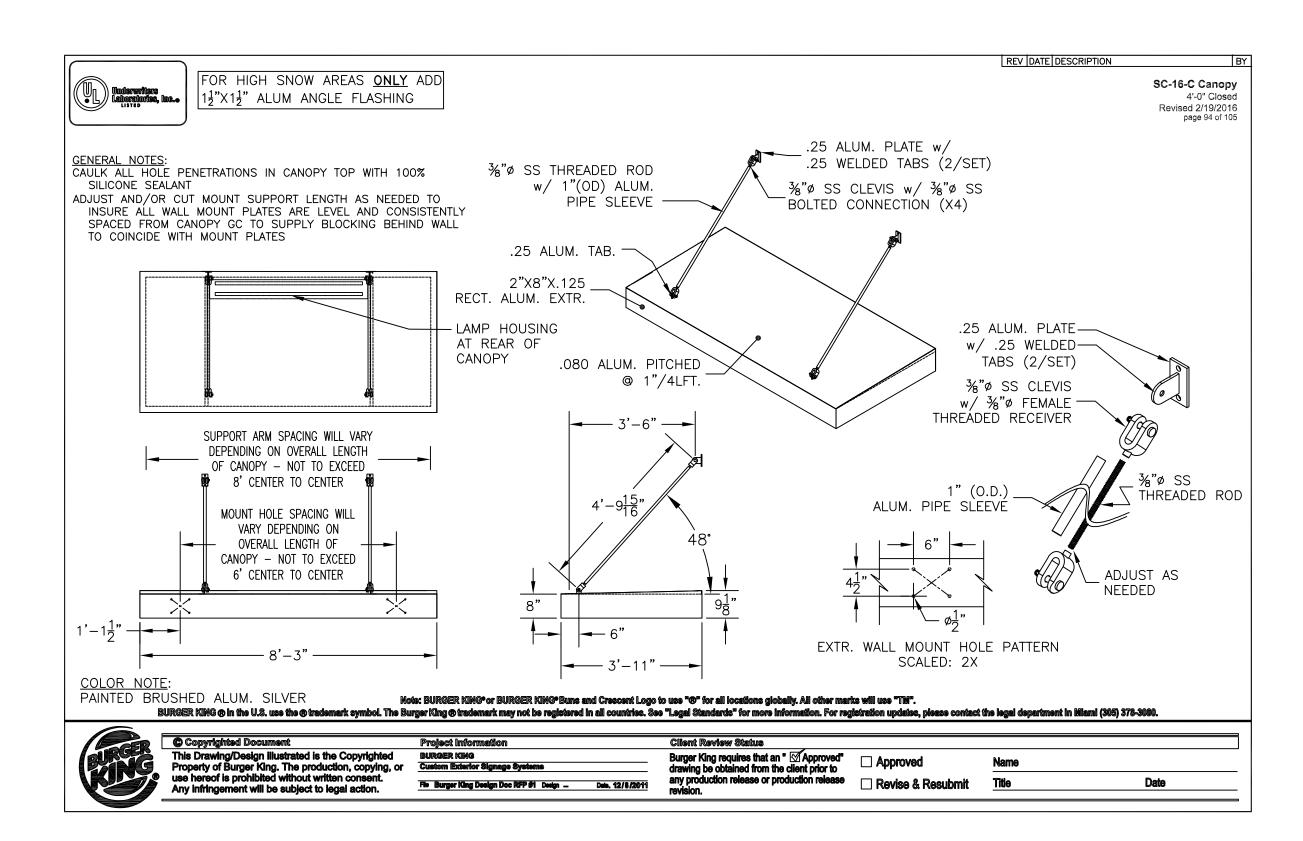

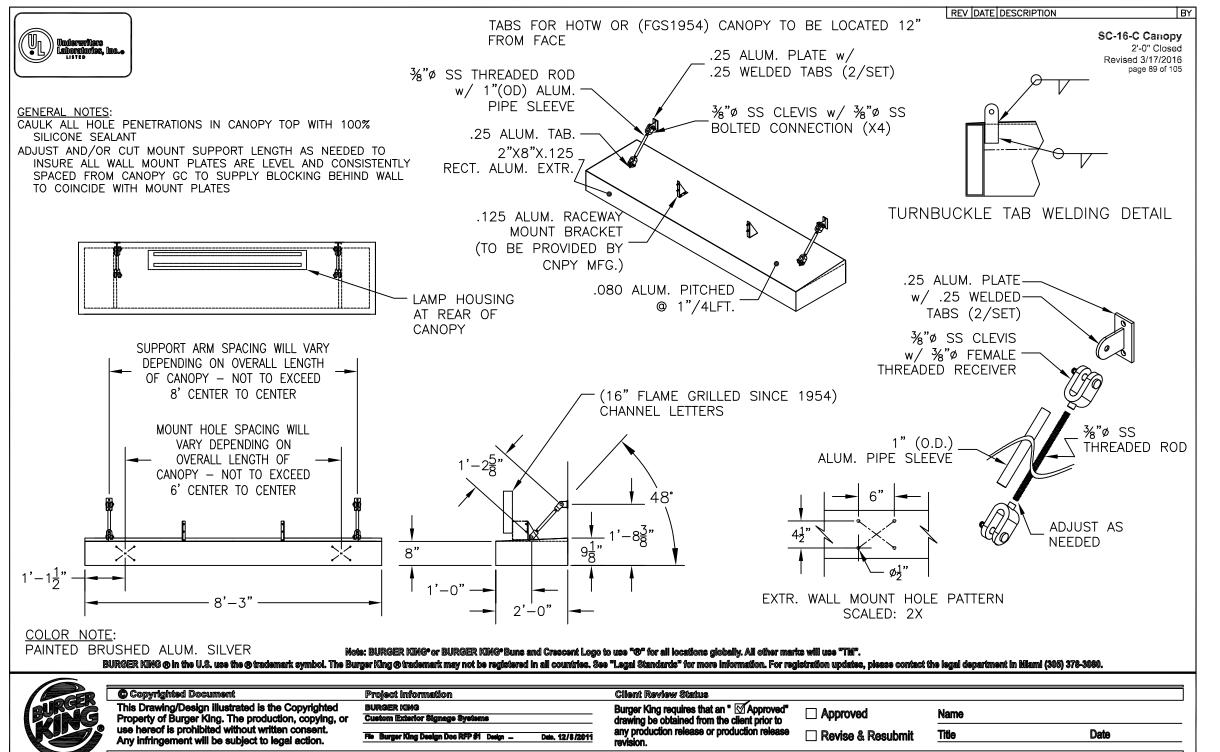

GENERAL NOTE: GENERAL CONTRACTOR TO VERIFY SIGNAGE,
DINING ROOM WINDOW CANOPY & DRIVE THRU CANOPY WITH
OWNER AND BURGER KING, BEFORE ORDER AND INSTALLATION.

ROOF DETAIL

SCALE: 3" = 1'-0"

CAUTION:
IF THIS DRAWING IS A REDUCTION,
USE THE GRAPHIC SCALES.

0 3" 6" 12"
3"=1'-0"

04-21-2021 PERMIT SUBMISSION

WHITNEY BAILEY COX & MAGNANI, LLC
300 East Joppa Road Suite 200
Baltimore, MD 21286
410.512.4500 www.wbcm.com

Designing Infrastructure for Tomorrow®

I hereby certify that these documents were prepared or approved by me, and that I am a duly licensed professional architect under the laws of the State of Maryland.

License # 6140 Expiration Date: 08/21/2022

nse # 6140 Expiration Date: 08/21/202

9571

DESIGNED: JMM

DRAWN: JMM

CHECKED: SCB

SCALE: AS NOTED

DATE: 04/21/2021

PROJECT: 2018.0375.04.0

A304

DRAWING:

SCALE: 3" = 1'-0"

WEATHER

SCALE: 3" = 1'-0"

RESISTANT BARRIER

TOWER PARAPET DETAIL

BUILDING HORIZONTAL

REVEALS - EIFS DETAIL


- E.I.F. SYSTEM AS SPECIFIED ON EXTERIOR FINISH SCHEDULE

VERTICAL SPACING.

REFER TO EXTERIOR ELEVATIONS FOR

2. REVEAL TO BE FORMED WITH AESTHETIC GROOVE KIT KV-5050 (OR EQUAL). HOT

KNIFE AND GROOVE BY "WIND-LOCK".

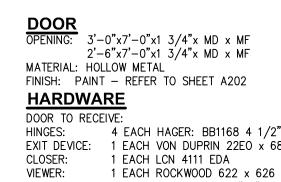



MATERIAL: HOLLOW METAL FINISH: PAINT - REFER TO SHEET A202


HINGES: 4 EACH HAGER: BB1168 4 1/2" x 4 1/2" x USP x NRP EXIT DEVICE: 1 EACH VON DUPRIN 22EO x 689 (DOOR #1 & 2)

KICKPLATES: 1 EACH HAGER 193S 10"x2" LDW 628 (INSTALL W/FLAT HEAD PHILLIPS HEAD SCREWS)
THRESHOLD: 1 EACH NATIONAL GUARD 325 x 48" x AL


DOOR SWEEP: 1 EACH NATIONAL GUARD 200NA x 48" WEATHERSTRIP: 1 SET NATIONAL GUARD 160SA 1@48", 2@84"

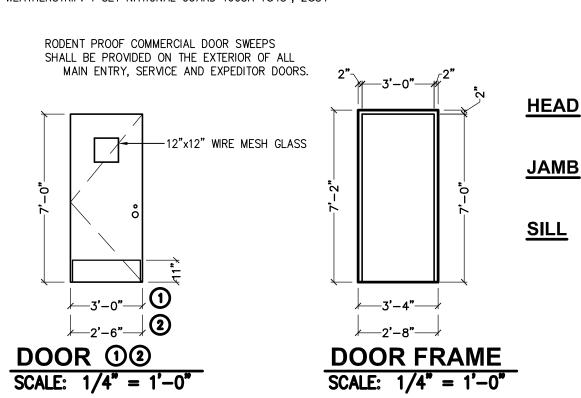


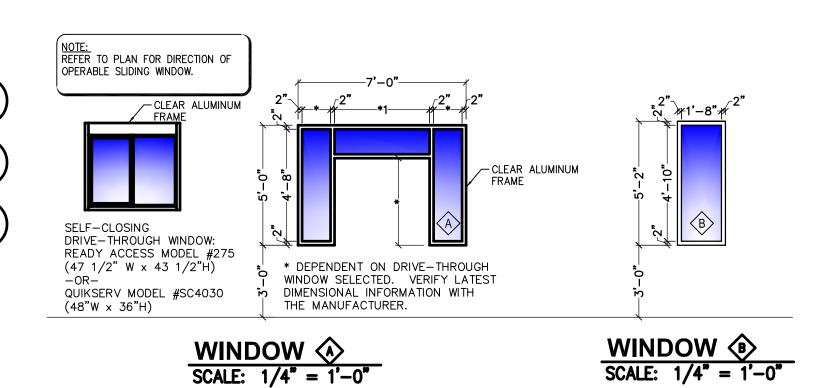

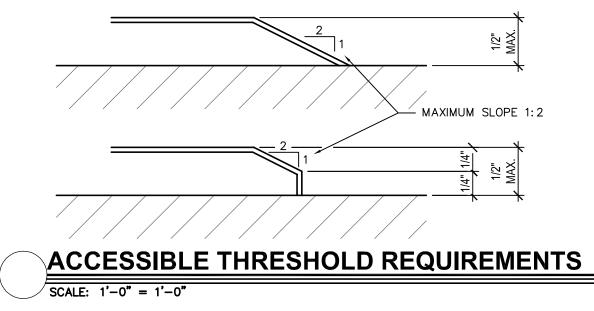

EXISTING SHEAR SHEATHING TO REMAIN -

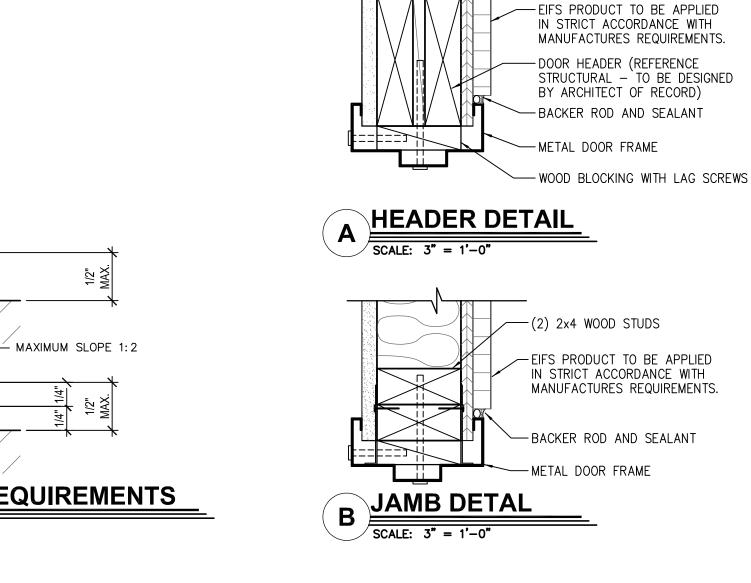

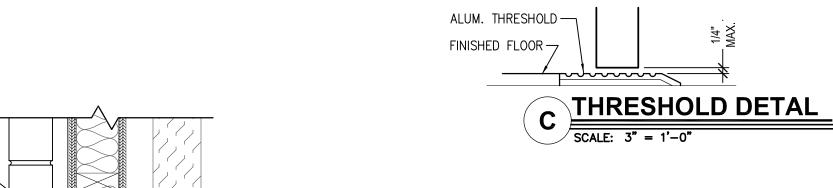

- EXISTING BATT INSULATION

PROVIDE ADDITIONAL 2 X 6

WOOD STUD BLOCKING

SHEATHING TO REMAIN


- EXISTING PREFABRICATED


COOLER WALL TO REMAIN


- EXISTING 2 x 6 WOOD STUD


FRAMING AT 16" O.C.

- EXISTING SHEAR

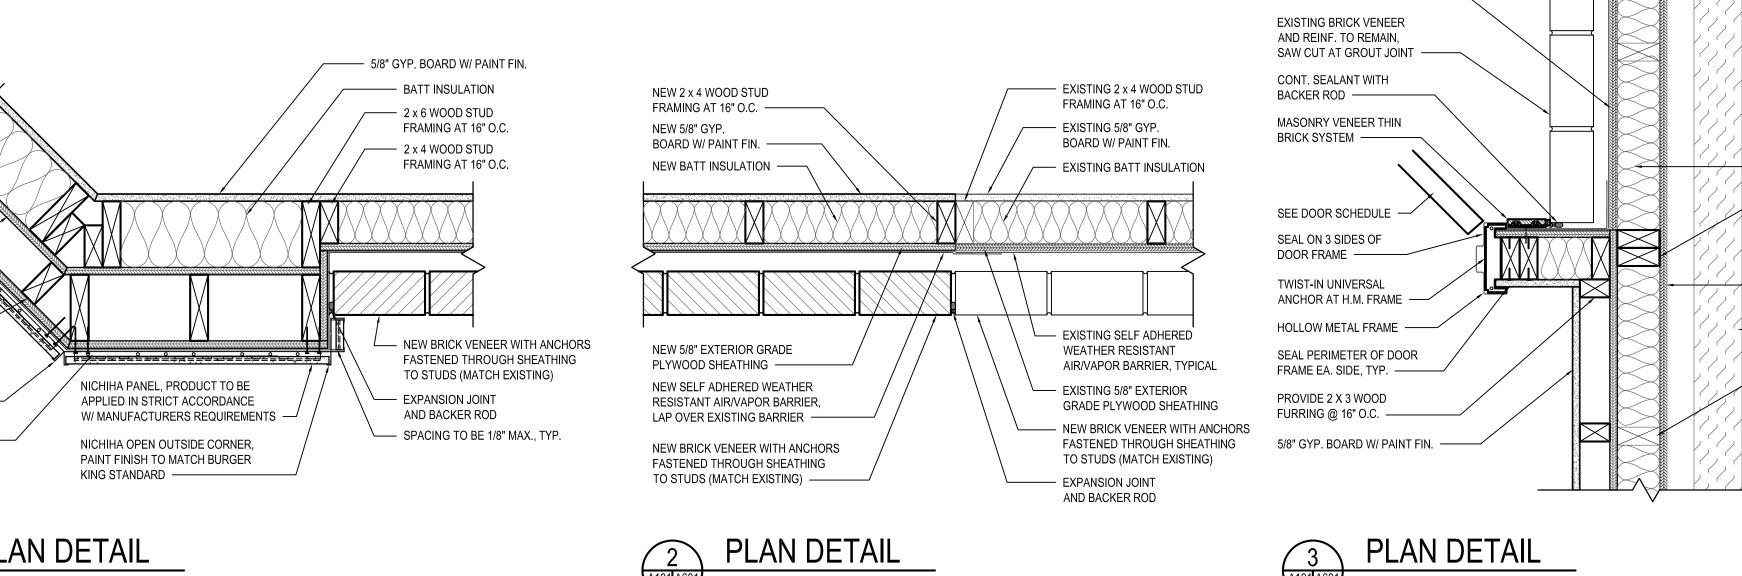

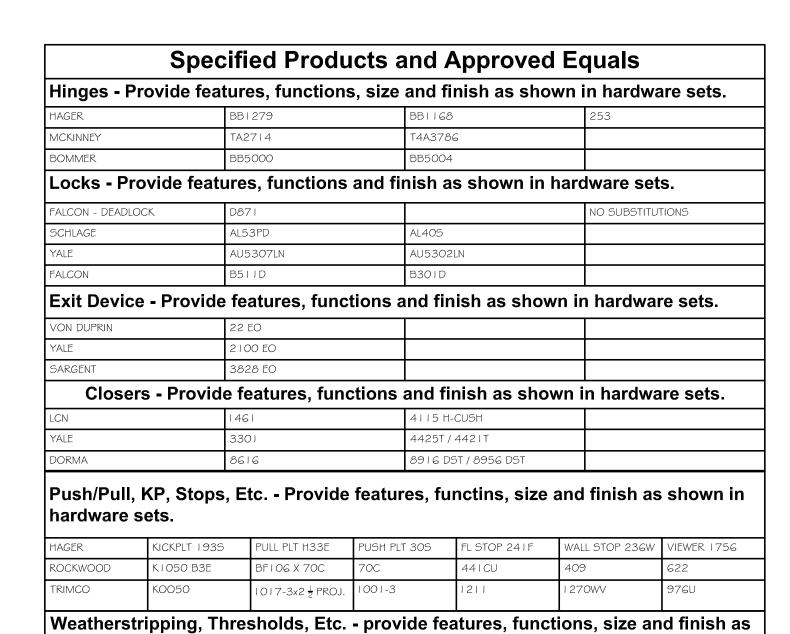

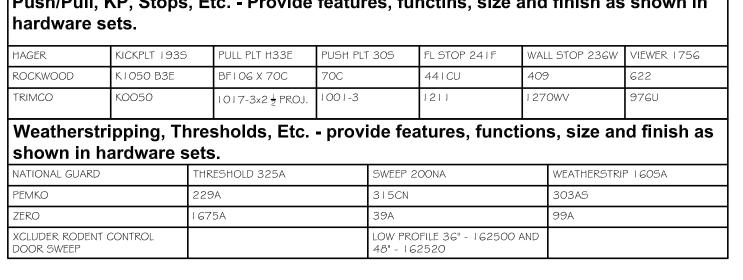

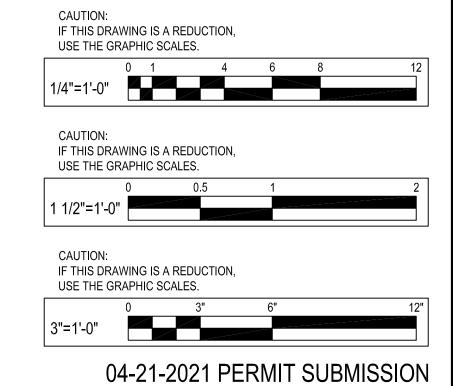

P:\2018\18037504\Drawings\01-Arch\2018037504 - A601 - Door Schedule.dwg

5/8" EXTERIOR GRADE

PLYWOOD SHEATHING -SELF ADHERED WEATHER

RESISTANT AIR/VAPOR

BARRIER, TYPICAL -

FRAMING AT 16" O.C.

NICHIHA OPEN OUTSIDE

CORNER, PAINT FINISH TO

MATCH BURGER KING STANDARD -

2 x 4 WOOD STUD

NICHIHA CLIP

SUPPORT SYSTEM

© WBCM 2021

I hereby certify that these documents were

prepared or approved by me, and that I am a

laws of the State of Maryland.

DOOR SCHEDULE AND DETAILS

DESIGNED: JMM

JMM SCB

A601

AS NOTED 04/21/2021

2018.0375.04.0

DRAWN:

CHECKED: SCALE:

PROJECT

DRAWING:

duly licensed professional architect under the

License # 6140 Expiration Date: 08/21/2022

TERATIONS - BURGER KING

	This	s list is intended to assist the contractor in sourcing building mat	erials and products. In many cases, approved Burger King m	aterials and products may be purchased directly from these sour	ces at a national accounts price. For a complete listing of approv	ed manufacturers, see plans and specifications, and visit RSI's eR	edbook.	
PDATE: 2-20-2018								
VISION 4 - MASONRY		DIVISION 9 - FINISHES		DIVISION 15 - MECHANICAL	Inventure was	SIGNS, EQUIPMENT, PLAYGROUNDS AND DÉCOR		Lauren
NE HALL BRICK CO. ACE BRICK) 701 SHOREFAIR DRIVE, NW INSTON-SALEM, NC 27105 HERESA BEANE: (800) 334-8689 BEANE@PINEHALLBRICK.COM	EVOLUTION BRICK (FACE BRICK) 126 OLD HIGHWAY 60 EAST HARDINSBURG, KY 40143 GABE POWERS: (502) 558-4612		IISH SCHEDULES FOUND IN THE "COMMON DOCUMENTS" SIGNWITHBK.COM WEBSITE.	RINNAI (INSTANT WATER HEATERS) RINNAI NATIONAL ACCOUNT PRICING THROUGH HAINES, JONES, & CADBURY. CONTACT THE BURGER KING CSR AT HJC 800-459-7099 FOR RINNAI TANKLESS WATER HEATER PRICING (MISCELLANEOUS)	EVERPURE, INC (WATER FILTERS) 1040 MUIRFIELD DRIVE HANOVER PARK, IL. 60133 JEANNINE GAINE: 630-240-1298 jeannine.gaine@pentair.com	L.S.I. (MENU BOARDS) 10000 ALLIANCE ROAD CINCINNATI, OH 45242 BRITTANY KOESTER: 513-372-3391 OR 513-315-3725	INTEGRATED CONTROL CORP. (KITCHEN MINDER) 748 PARK AVENUE HUNTINGTON, NY 11743 JOHN PATTI: 631-673-5100 EXT 325	CHARTER HOUSE INC. (DECOR) 4660 136 AVENUE HOLLAND, MI. 49424 BARB ZILM: 800-314-7659 OR 317-774-8880 barbara.zilm@charter-house.com www.gotochi.com
C MUDDOX BRICK CO. FACE BRICK) 875 BRADSHAW ROAD ACRAMENTO, CA 95827 16-859-6320		SUMMITVILLE TILE CO (REPLACEMENT STRATA TILE) 330-223-1511		RHEEM (WATER HEATERS) 101 BELL ROAD MONTGOMERY, AL. 36117 800-621-5622 OR CONTACT HAINES, JONES, & CADBURY (MISCELLANEOUS)	SELECTO SCIENTIFIC, INC (WATER FILTERS) 3980 LAKEFIELD COURT SUWANEE, GA. 30024 EHUD LEVY: 678-475-1445 edlevy@selectoinc.com	FEDERAL HEATH SIGN CO (AWNINGS, CANOPIES AND SIGNS) 12704 DUPONT CIRCLE TAMPA, FL. 33626 FIONA PAUL: 800-284-3284 EXT. 19 fpaul@federalheath.com	DUKE MANUFACTURING (PRODUCT HOLDING UNITS) 2305 NORTH BROADWAY ST. LOUIS MO. 63102 SUE SCIUTO: 800-735-3853 EXT 1260 ssciuto@dukemfg.com	SEATING CONCEPTS (DECOR) 125 CONNELL STREET ROCKDALE, IL. 60436 ZACH DEPYSSLER: 815-483-2244 zdepyssler@seating-concepts.com
VISION 5 - METALS DDISON STEEL TRUCTURAL STEEL) DDISON, IL 6-747-1554		DIVISION 10 - SPECIALTIES BOBRICK PRODUCTS (RESTROOM ACCESSORIES, TOILET PARTITIONS* AND HARDWARE) CONTACT: HAINES, JONES, & CADBURY (MISCELLANEOUS) *GREEN PRODUCT	KOALA KARE PRODUCTS (BABY CHANGING STATIONS) CONTACT: HAINES, JONES, & CADBURY (MISCELLANEOUS)	A.O. SMITH (WATER HEATERS) 600 E. JOHN CARPENTER FREEWAY, SUITE 200 IRVING, TX. 75062 800-447-1953 972-719-5900	N.C.A. NATIONAL HVAC PRODUCTS, LLC. (AIR CONDITIONING - FULL SERVICE) 4585 140 AVENUE NORTH CLEARWATER, FL. 33762 877-530-0078	CUMMINGS SIGNS, INC (AWNINGS, CANOPIES AND SIGNS) 105 DALTON PLACE WAY KNOXVILLE, TN 37912 AMANDA HICKMAN: 865-862-4416 amanda.hickman@cummingssigns.com	FRYMASTER CORPORATION (FRYERS) 8700 LINE AVE SHREVEPORT, LA 71106 LAURA DODD: 318-865-1711 eqorders@frymaster.com	FCC COMMERCIAL FURNITURE (DECOR) 8452 OLD HWY. 99 NORTH ROSEBURG, OR. 97470 PRESTON O'HARA: 541-464-5284 OR 800-322-7328 EXT 284 preston.ohara@fccfurn.com
		AMERICAN STANDARD (RESTROOM ACCESSORIES) 1 CENTENNIAL AVENUE PISCATAWAY, NJ. 08854 CONTACT HAINES, JONES, & CADBURY (MISCELLANEOUS)	COLUMBIA VORTEX (HAND DRYERS) 825 GARLAND STREET 866-337-7286 EXT. 1136	CARRIER CORPORATION (AIR CONDITIONING) 6304 CARRIER PARKWAY SYRACUSE, NY. 13221 DEBORAH ROY-JONES: 315-432-7941 800-690-1086	LOREN COOK CO (EXHAUST FANS) 2015 E. DALE SPRINGFIELD, MO 65803-4637 KEN DICKSON: 813-966-9200 ken.dickson@tampabay.rr.com	ENTERA SIGNS (AWNINGS, CANOPIES AND SIGNS) 1200 ENTERA DRIVE PANAMA CITY, FL. 32401 850-797-1779	GAYLORD INDUSTRIES (HOODS) 10900 SOUTH AVERY STREET TUALATIN, OR. 97062 JOHN ANDERSON: 971-223-1238 john.anderson@gaylordusa.com	CASABLANCA DESIGN GROUP (DECOR) 811 PICKENS INDUSTRIAL DRIVE MARIETTA, GA 30026 JOHN HARRISON: 770-423-9575 John.Harrison@cdg.com
IVISION 7 - THERMAL MOISTURE PROTECTION URO-LAST ROOFING FLAT ROOFING) 25 MORLEY DRIVE AGINAW, MI 48601 NDY BEUTHIN: 800-432-9331 AMANTHA PICKELMAN 989-758-1048 OR 989-930-9826	G.A.F. (FLAT ROOF) 1361 ALPS ROAD WAYNE, NJ. 07470 (201) 628-3000 800-766-3411	ZURN INDUSTRIES (PLUMBING FIXTURES) CONTACT: HAINES, JONES, AND CADBURY (MISCELLANEOUS)	WORLD DRYER, CO (HAND DRYERS) CONTACT: HAINES, JONES, AND CADBURY (MISCELLANEOUS)	TRANE (AIR CONDITIONING UNITS, RTU's/SPLIT SYSTEMS CONTROLS) 2884 CORPORATE WAY MIRAMAR, FL. 33025 AL MARTINEZ: 954-499-2289 OR 800-440-9554 bkhvac@trane.com	AMEREX CORPORATION (FIRE PROTECTION SYSTEMS) 7595 GADSDEN HIGHWAY TRUSSVILLE, AL 35173-0081 LISA JONES: 205-655-5760 ljones@amerex-fire.com www.amerex-fire.com	SIGN RESOURCE (AWNINGS, CANOPIES AND SIGNS) 6135 DISTRICT BLVD. MAYWOOD, CA. 90270 RAMON ORTIZ: 323-326-6463 rortiz@signresource.com	LANCER (DRINK DISPENSERS) 6655 LANCER BLVD SAN ANTONIO, TX. 78219 MIKE KRAWETZKE: 817-692-5094 michael.krawetzke@lancercorp.com	FACILITY CONCEPTS, INC (FCI) (DECOR) 7676 ZIONSVILLE ROAD INDIANAPOLIS, IN 46268 KEN WEAVER: 800-915-8890 EXT. 103 kweaver@fcius.com CALVIN DURR: 800-915-8890 EXT 303 cdurr@fcius.com
RRIDGE ROOFING METAL ROOF) LER HALL N ANTONIO, TX. 0-650-7047	TAMKO ROOFING PRODUCTS (FLAT ROOFING) P.O. BOX 1404 JOPLIN, MO. 64802 800-641-4691	SAN JAMAR (RESTROOM ACCESSORIES & SUPPLIES) 555 KOOPMAN LANE ELKHORN, WI. 262-723-6133 www.sanjamar.com OR CONTACT HAINES, JONES, & CADBURY (MISCELLANEOUS)		AMERICAN STANDARD (TOILET, URINAL, FAUCETS) 1 CENTENNIAL AVE. PISCATAWAY, NJ. 08855 800-442-1902 OR CONTACT: HAINES, JONES, & CADBURY (MISCELLANEOUS)		ALLEN INDUSTRIES, INC (AWNINGS, CANOPIES AND SIGNS) 11351 49TH STREET NORTH CLEARWATER, FL 33762 THERESA TRIMMER: 800-677-3075 EXT. 3422 theresa.trimmer@allenindustries.com	NIECO CORPORATION (BROILERS) 7950 CAMERON DRIVE WINDSOR, CA 95492 CHRISTINA NEAT: 707-284-7100 sales@nieco.com	INTERIOR SYSTEMS, INC (DECOR) 241 NORTH BROADWAY, SUITE 600 MILWAUKEE, WI 53202 JIM ZIELINSKI: 414-232-3502 JZielinski@isiamerica.com JASON FREDRICKSON: 414-224-0972 jfredrickson@isiamerica.com
RESTONE METAL PRODUCTS IETAL ROOF) 0 WEST 96TH STREET DIANAPOLIS, IN 46260 USUKE KOREEDA: 615-345-9991 reedayusuke@firestonebp.com	BASF CORPORATION (POLYURETHANE ROOFING SYSTEMS) 1703 CROSS POINT AVE HOUSTON, TX 77054 MOSES M CLARK, JR: 315-263-4665	UNIVERSAL MANUFACTURING (RESTROOM ACCESSORIES) 5366 CRESTVIEW DR. MEMPHIS, TN. 38134 901-458-5881 800-821-1414				LEKTRON, INC (PARAPET LIGHT BANDS) 7450 E. 46th PLACE TULSA, OK. 74145 KEVIN RUBOTTOM 800-634-4059 OR 918-622-4978 EXT 309 krubottom@lektroninc.com	PITCO (FRYERS) 10 FERRY STREET CONCORD, NH. 03301 BONNIE BOLSTER: 603-230-5529 bbolster@pitco.com	COMMERCIAL INTERIOR MANUFACTURERS, INC (LIMITED DÉCOR ITEMS) 158 HOLLY STREET JASPER, GA. 30143 706-253-4761 STEVE BOUDREAU steve@cimgbiz.com AUSTIN HOLAN austin@cimgbiz.com
UVISION 8 - DOORS AND WINDOWS UIKSERV PRIVE-THRU WINDOWS) L441 BRITTMOORE PARK DRIVE OUSTON, TX. 77041 OO-388-8307 TEVEN BERT pert@quikserv.com	MARLITE (DOOR, ALUMINUM FRAMES) 202 HARGER STREET DOVER, NH 44622 800-377-1221 KURT HORSTMANN khorstmann@marlite.com			DIVISION 16 - ELECTRICAL LSI INDUSTRIES INC. (INTERIOR AND EXTERIOR LIGHTING, SURVEYS AND PHOTOMETRICS) 10000 ALLIANCE ROAD CINCINNATI, OH. 45242 BRITTANY KOESTER: 513-372-3391 OR 513-315-3725	SECURITY LIGHTING SYSTEMS (EXTERIOR SITE AND BUILDING LIGHTING, SURVEYS AND PHOTOMETRICS) 2100 GOLF ROAD, SUITE 460 ROLLING MEADOWS, IL. 60008 ERIC HILLESLAND: 630-636-8493 ehillesland@security lighting.com	FRANKE (KITCHEN EQUIPMENT, SMALLWARES, HOODS) 800 AVIATION PARKWAY SMYRNA, TN. 37086 CUSTOMER SERVICE: 800-877-5178 fs-bkparts.us@franke.com	TAYLOR ULTIMATE SERVICES, INC (SHAKE MACHINE, FROZEN BEVERAGE MACHINE) 1780 NORTH COMMERCE PKWY WESTON, FL. 33326 TINA SMART: 954-217-9100 tina@taylorus.com	NAUTICAL FURNISHINGS, LLC (LIMITED DÉCOR ITEMS) 60 NW 60TH STREET FT. LAUDERDALE, FL 33309 MICHAEL HOGLUND: 954-771-1100 mhoglund@nauticalfurnishings.com
ADY ACCESS RIVE THRU WINDOWS & AIR CURTAINS) 15 ARTHUR DRIVE WEST HICAGO, IL. 60185 LLY MCGOLDRICK: 800-621-5045 EXT 113 Hy@ready-access.com	UNIVERSAL MANUFACTURING CO (HOLLOW METAL FRAMES & DOORS, WOOD DOORS, HARDWARE (HINGES, LOCKS, ETC) 5366 CRESTVIEW RD. MEMPHIS, TN. 38134 901-458-5881 OR 800-821-1414			3M SOUND PRODUCTS (DRIVE-THRU SOUND SYSTEM & SATELITE ANTENNA) 3M CENTER BLDG. 223-2N-20 ST. PAUL, MN. 55144-1000 JOE CIAMPI: 704-771-2449 jjciampi@mmm.com	CREE / HERMITAGE LIGHTING NATIONAL ACCOUNTS (INTERIOR AND EXTERIOR LIGHTING, SURVEYS AND PHOTOMETRICS) 3640 TROUSDALE DRIVE NASHVILLE, TN. 37204 STEVE FRIEDMAN: 847-830-1444 OR WYATT CULVER: 615-843-3379 800-264-3383	QUALSERV SOLUTION (KITCHEN EQUIPMENT, SMALLWARES) 7400 SOUTH 28th STREET FORT SMITH, AR. 72908 BECKY DUBOSE: 479-221-1467 bdubose@qualservsolutions.com	PLAY SYSTEMS (DIV. OF SUPERIOR INT. INDUSTRIES, INC) (PLAYGROUND MANUFACTURER) 1050 COLUMBIA DR. CARROLLTON, GA 30717 JUAN CUELLAR: 770-832-6660 EXT. 1517 jcuellar@siibrands.com	ARMSTRONG STRATEGIC ACCOUNTS (CEILING TILE) 2500 COLUMBIA AVENUE LANCASTER, PA. 17604 LOUIS JOHN: 407-697-6768 800-442-4212 Ijjohn@armstrongceilings.com OR ARMSTRONG STRATEGIC ACCOUNTS (800) 442-4212
	3M COMMERCIAL CORE DIVISION (WINDOW FILM) 3M CENTER ST. PAUL, MN 704-771-2449 OR 800-328-0033			SECURITY PRODUCTS, INC (REAR DOOR ALARM) 30950 COREAL DRIVE, SUITE B COARSEGOLD, CA. 93614 BOB BARR OR EMILY BEACH: 800-452-5276 orders@security productsinc.com	HM ELECTRONICS, INC (HME) (DRIVE-THRU SOUND SYSTEM) 14110 STOWE DRIVE POWAY, CA. 92064 PAUL KOOSER: 800-848-4468 paulk@hme.com	H & K INTERNATIONAL (KITCHEN EQUIPMENT, SMALLWARES, HOODS) 2200 SKYLINE DR DALLAS, TX 75223 HEATHER VALVERDE: 214-818-3521 heather.valverde@hki.com	SPI INDUSTRIES (PLAYGROUND MANUFACTURER) BOX 100, R.R. #2, JOINT ST. SHALLOW LAKE, ON, NOH 2KO CANADA CYNTHIA MASTERS: 519-935-2174 OR 519-378-4356 cmasters@spiplastics.com www.spiplastics.com	USG INTERIORS (CEILING TILE) CHRIS BENJAMIN: 312-436-5458 cbenjamin@usg.com
				N.C.A. NATIONAL HVAC PRODUCTS, LLC. (MASTER CONTROL SYSTEM) 4585 140 AVENUE NORTH CLEARWATER, FL. 33762 877-530-0078	SUNCOAST ENVIRONMENTAL CONTROLS, INC. (ELECTRICAL SWITCH GEAR) 8655 115th AVENUE NORTH LARGO, FL. 34643 877-544-6679	INTERNATIONAL COLD STORAGE (ICS) (WALK-IN COOLERS / FREEZERS, DRY STORAGE COMPARTMENTS) 215 EAST 13th STREET ANDOVER, KS. 67002 LISA MOORE: 800-835-0001 EXT 4177 lisa.moore@icsco.com	SOFT PLAY, LLC (PLAYGROUND MANUFACTURER, SAFETY SURFACING, NON-CONTAINED PLAY EQUIPMENT) 13620 EAST REESE BLVD. SUITE 300 HUNTERSVILLE, NC. 28078 JIM SWINTEK: 704-948-3448 jim.swintek@softplay.com	MITYLITE (2020 LIGHT CHAIRS AND BARSTOOLS) 1301 WEST NORTH OREM, UT KAREN EDWARDS: 561-213-2810
				HILL PHOENIX POWER SYSTEMS DIVISION (FACTORY INTEGRATED SWITCH GEAR) 8166 INDUSTRIAL BLVD COVINGTON, GA. 30014 PAUL BROWN: 678-699-0129 paul.brown@hillphoenix.com	TRANE CO. (ENERGY MANAGEMENT PANEL) 2884 CORPORATE WAY MIRAMAR, FL. 33025 AL MARTINEZ: 954-499-2289 ammartinez@trane.com	3M FOOD SERVICE BUSINESS (DRIVETHRU COMMUNCATION PRODUCTS, MAINTENANCE PRODUCTS, MATTING AND TRACTION PRODUCTS, MONITOR STRIPS, TAPES AND DISPENSERS, LAMINATING SYSTEMS) 3M CENTER BLDG. 223-2N-20 ST. PAUL, MN. 55144-1000 JOE CIAMPI: 704-771-2449 jjciampi@mmm.com	MOSS RETAIL AND ENVIRONMENTS (GRAPHICS) 2643 WEST CHICAGO AVE CHICAGO, IL 60622 DJ SCANDIFF: 773-435-7600 EXT 617 ROB LORTS: 773-435-7600 EXT 655 rlorts@mossinc.com	TWENTY FOUR 7 GLOBAL SOLUTIONS, INC. (2020 LIGHT AND GARDEN GRILL CHAIRS AND BARSTOOLS) 898 NORTH SEPULVEDA BLVD, SUITE 465 EL SEGUNDO, CA 90245 BARRY WOON: 323-319-2722
						HM ELECTRONICS, INC (HME) (DRIVE-THRU WIRELESS INTERCOMS, DRIVE-THRU SPEED OF SERVICE TIMERS, DIGITAL SURVEILLANCE SYSTEMS) 14110 STOWE DRIVE POWAY, CA. 92064 PAUL KOOSER: 800-848-4468 paulk@hme.com	VGS, INC (GRAPHICS) 1696 MABRY MILL DRIVE, SW NORTH CANTON, OH 44709 GREG MOROZ: 201-528-9680 ORDER EMAIL: BURGERKING@VGS-INC.COM	WAUSAU TILE, INC (EXTERIOR DÉCOR) P.O. BOX 1520 WAUSAU, WI 54402-1520 STEVE THUT: 800-388-8728 EXT 320 sthut@wausautile.com
								MISCELLANEOUS HAINES, JONES, AND CADBURY

NO. DATE REVISION BY					
WHITNEY BAILEY COX & MAGNANI. LLC	300 East Joppa Road Sulte 200 Baltimore, MD 21286 410.512.4500 www.wbcm.com			Designing Infrastructure for Tomorrow ®	
prepared duly lice laws of t	d or appr nsed pro the State	nat these oved by ofessiona of Maryl Expiratio	me, and I archited and.	that I a ct unde	am a er the
MANI IFACTI IRERS AND SUBBLIFRS			ALIERATIONS - BURGER NING # 937 I	BURGERS OF BALTIMORE 2110 EMMORTON ROAD	BEL AIR, MARYLAND 21015

DESIGNED: JMM

HAINES, JONES, AND CADBURY
(PACKAGE PRICING ON MULTIPLE ITEMS PLUMBING,
TILE, RESTROOM ACCESSORIES, ETC)
310 SW 24TH STREET
BENTONVILLE, AR 72712
BARRY BRYANT:479-899-3555
barry.bryant@hjcinc.com

STRUCTURAL GENERAL NOTES

1. CODE

A. ALL CONSTRUCTION SHALL CONFORM TO 2018 INTERNATIONAL BUILDING CODE, AND HARFORD COUNTY LOCAL AMENDMENTS.

DESIGN LOADING

A. THE DESIGN DEAD LOAD FOR THE FRAMING IS AS FOLLOWS:

EXISTING ROOF DL = 13 PSF (ROOF, FRAMING AND CEILING) SOURCE: EXISTING STRUCTURAL DRAWINGS DATED 10/12/95

NEW ROOF DL = 25 PSF

B. THE FOLLOWING LIVE LOADS WERE USED IN DESIGN:

IBC 1603.1.2 - ROOF LIVE LOAD ROOF LIVE LOAD = 30 PSF

IBC 1603.1.3 - ROOF SNOW LOAD

GROUND SNOW LOAD (P_G) = 30 PSF FLAT SNOW LOAD (P_F) = 21 PSF SNOW EXPOSURE FACTOR (C_E) = 1.0 SNOW LOAD IMPORTANCE FACTOR (I) = 1.0 THERMAL FACTOR (C_T) = 1.0

IBC 1603.1.4 - WIND LOAD ULTIMATE DESIGN WIND SPEED (V_{ULT}) = 115 MPH NOMINAL DESIGN WIND SPEED (V_{ASD}) = 89 MPH RISK CATEGORY = II WIND EXPOSURE = C INTERNAL PRESSURE COEFFICIENT = ± 0.18

3 GENERA

- A. THE CONTRACTOR SHALL FIELD CHECK AND VERIFY ALL DIMENSIONS AND ELEVATIONS OF EXISTING WORK PRIOR TO FABRICATION OF ANY NEW MATERIALS.
- B. THE CONTRACTOR IS ADVISED THAT ALL PLANS, DIMENSIONS, AND DETAILS DEPICT FIELD CONDITION AS SHOWN. MINOR VARIATIONS ARE TO BE EXPECTED AND ANY DEVIATIONS FROM THE CONTRACT DOCUMENTS SHALL BE APPROVED BY THE ARCHITECT IN WRITING PRIOR TO PROCEEDING.
- C. IT SHALL BE THE CONTRACTOR'S RESPONSIBILITY TO EXAMINE THE EXISTING BUILDING DURING THE COURSE OF CONSTRUCTION AND IMMEDIATELY ADVISE THE ARCHITECT OF ANY AREAS WHERE THE STRUCTURE EXHIBITS DISTRESS OR FAILURE.
- D. IT IS THE CONTRACTOR'S RESPONSIBILITY TO SATISFY HIMSELF AS TO THE LOCATION OF ANY UTILITIES IN THE IMMEDIATE VICINITY OF CONSTRUCTION SO AS TO PREVENT DAMAGE TO THEM. SHOULD ANY DAMAGE TO SUCH UTILITIES OCCUR THE CONTRACTOR SHALL BE REQUIRED TO REPAIR SUCH DAMAGE AT HIS OWN EXPENSE AND TO THE SATISFACTION OF THE OWNER.
- E. THE CONTRACTOR SHALL PROVIDE ALL SHORING, NEEDLING AND BRACING AS REQUIRED TO SUPPORT THE EXISTING STRUCTURE. THE CONTRACTOR SHALL EXAMINE THE EXISTING STRUCTURE TO DETERMINE THE EXTENT OF NECESSARY SHORING, NEEDLING AND UNDERPINNING. THE CAPACITY AND METHOD USED FOR SHORING AND NEEDLING SHALL BE THE RESPONSIBILITY OF THE CONTRACTOR.
- F. ALL WORK SPECIFIED HEREIN SHALL BE INSPECTED IN ACCORDANCE WITH THE BUILDING CODE AND ALL LOCAL ORDINANCES. THE OWNER OR CONTRACTOR SHALL HIRE AN EXPERIENCED, QUALIFIED INSPECTOR TO PERFORM ALL THE REQUIRED INSPECTION WORK. THE ENGINEER WILL NOT PERFORM THE REQUIRED INSPECTION AS A PART OF THEIR DESIGN SERVICES. THE ENGINEER MAY VISIT THE SITE TO ASCERTAIN GENERAL CONFORMANCE WITH THE CONTRACT DOCUMENTS. SUCH SITE VISITS ARE NOT TO BE CONSTRUED AS MEETING ANY INSPECTION REQUIREMENTS UNLESS THE ENGINEER SPECIFICALLY SO STATES IN WRITING.
- G. ANY REVIEW OF STRUCTURAL ITEM SHOP DRAWINGS BY (THE STRUCTURAL ENGINEER) IS FOR GENERAL CONFORMANCE WITH THE DESIGN CONCEPT AS PRESENTED BY THE CONTRACT DOCUMENTS. NO DETAILED CHECK OF QUANTITIES OR DIMENSIONS WILL BE MADE. SEE WBCM SHOP DRAWING STAMP FOR RESPONSIBILITIES OF EACH PARTY.
- H. SHOP DRAWINGS FOR ALL STRUCTURAL ELEMENTS SHOWN ON THE CONTRACT DOCUMENTS MUST BE SUBMITTED BY THE GENERAL CONTRACTOR. IF A CONTRACTOR OR OWNER FAILS TO SUBMIT THE SHOP DRAWINGS, THE ENGINEER WILL NOT BE RESPONSIBLE FOR THE STRUCTURAL CERTIFICATION OR FOR THE DESIGN OF THE PROJECT.
- I. FOOTINGS ARE DESIGNED FOR AN ASSUMED BEARING CAPACITY OF 2000 PSF. CONTRACTOR SHALL VERIFY SOIL PRESSURE IN THE FIELD. IF FOUND TO BE LESS THAN THIS VALUE, THE FOOTINGS WILL HAVE TO BE REDESIGNED.

4. CAST-IN-PLACE CONCRETE

4A. GENERAL CONSTRUCTION

A. ALL CONCRETE WORK SHALL CONFORM TO THE LATEST APPROVED (BY LOCAL GOVERNMENT) EDITIONS OF THE FOLLOWING A.C.I. AND A.S.T.M. DOCUMENTS:

SPECIFICATIONS FOR STRUCTURAL CONCRETE FOR BUILDINGS ACI-301 ACI-302,1R FLOOR AND SLAB CONSTRUCTION ACI-318 BUILDING CODE REQUIREMENTS FOR REINFORCED CONCRETE ACI-214 COMPRESSION TESTS ACI-306 COLD WEATHER ACI-315 DETAILING ACI-347 FORMWORK ACI-305 HOT WEATHER ACI-211 PROPORTIONS OF CONCRETE ACI-304 PLACING CONCRETE ACI-ASCE/423 UNBONDED TENDONS ASTM C94 READY-MIX CONCRETE

B. ALL FIELD AND LAB TESTING OF CONCRETE SHALL CONFORM TO THE LATEST APPROVED (BY LOCAL GOVERNMENT) EDITIONS OF ASTM:

ASTM C31 FIELD CYLINDER SPECIMENS ASTM C143 SLUMP TEST ASTM C231 AIR CONTENT (WHEN REQUIRED) ASTM C39 LAB TESTING CYLINDERS C172 ASTM SAMPLING FRESH CONCRETE ASTM C42 HARDENED CORES (WHEN REQUIRED)

C. ALL CONCRETE, UNLESS NOTED OTHERWISE, SHALL BE STONE AGGREGATE CONCRETE HAVING A MINIMUM COMPRESSIVE STRENGTH OF 4000 PSI AT 28 DAYS. ALL CONCRETE EXPOSED TO WEATHER SHALL HAVE AN AIR ENTRAINMENT OF 5%±1%. NO ADMIXTURES CONTAINING CALCIUM CHLORIDE SHALL BE PERMITTED. MAXIMUM AGGREGATE SIZE FOR CONCRETE SHALL BE 1", AND MAXIMUM SLUMP SHALL BE 4", AND 3" FOR SLABS ON GRADE. ALL CONCRETE, EXCEPT FOOTINGS, SHALL CONTAIN A WATER REDUCING ADMIXTURE.

- D. ALL CONCRETE MIX DESIGNS AND ADMIXTURES SHALL BE APPROVED BY THE ARCHITECT 30 DAYS PRIOR TO INITIATION OF FIRST POUR.
- E. ALL REINFORCING BARS SHALL CONFORM TO ASTM A-615 GRADE 60. WELDED WIRE FABRIC SHALL CONFORM TO ASTM A-185.
- F. CONCRETE EXPOSED TO PUBLIC VIEW SHALL MEET THE REQUIREMENTS FOR ARCHITECTURAL CONCRETE OF ACI 301.
- G. ALL FORMWORK SHALL BE IN ACCORDANCE WITH THE AMERICAN CONCRETE INSTITUTE "FORMWORK FOR CONCRETE", SPECIAL PUBLICATION NO. 4 AND ACI'S "STANDARD RECOMMENDED PRACTICE FOR CONCRETE FORMWORK" (ACI-347, LATEST LOCAL APPROVED EDITION).
- H. ALL LAP SPLICES SHALL BE CLASS "B" (1'-0" MIN.) EXCEPT AS NOTED ON PLANS. BEND OUTSIDE FACE WALL HORIZONTAL REINFORCING 1'-0" AROUND ALL CORNERS OR PROVIDE 4'-0" LONG CORNER BARS TO MATCH HORIZONTAL REINFORCING.
- I. PROVIDE CONCRETE PROTECTION FOR REINFORCING BARS AS FOLLOWS:

FOOTINGS

- J. WHERE CONTINUOUS BARS ARE CALLED FOR, THEY SHALL BE RUN CONTINUOUSLY AROUND CORNERS AND LAPPED AT NECESSARY SPLICES OR HOOKED AT DISCONTINUOUS ENDS. LAPS SHALL BE NOT LESS THAN THE TYPICAL SPLICE LENGTH UNLESS NOTED.
- K. REINFORCEMENT SHALL BE CONTINUOUS THROUGH ALL CONSTRUCTION JOINTS UNLESS OTHERWISE INDICATED ON THE DRAWINGS. AT VERTICAL CONSTRUCTION JOINTS.

WOOD FRAMING

5A. GENERAL WOOD FRAMING

- A. STRUCTURAL SOLID WOOD JOISTS, BEAMS, COLUMNS AND STUDS SHALL BE SOUTHERN PINE #2 SURFACED DRY AT A MAXIMUM OF 19% MOISTURE CONTENT. ALL FABRICATION, ERECTION, OTHER PROCEDURES, AND MINIMUM UNIT STRESSES SHALL CONFORM TO THE CURRENT "NATIONAL DESIGN SPECIFICATION FOR WOOD CONSTRUCTION".
- B. ALL WOOD FRAMING SHALL BE FABRICATED AND ERECTED IN ACCORDANCE WITH THE AMERICAN INSTITUTE OF TIMBER CONSTRUCTION SPECIFICATION AITC 105 "RECOMMENDED PRACTICE FOR THE ERECTION OF STRUCTURAL TIMBER FRAMING, AITC 106," "CODE OF STANDARD PRACTICE", AND "THE NATIONAL DESIGN SPECIFICATION FOR WOOD CONSTRUCTION", LATEST EDITION, AS PUBLISHED BY THE NATIONAL FOREST PRODUCTS ASSOCIATION.
- C. ALL WOOD PLATES BEARING ON CONCRETE WALL SHALL BE WOLMANIZED PRESSURE TREATED LUMBER AS MANUFACTURED BY KOPPERS COMPANY OR AN APPROVED ALTERNATE.
- D. ANCHOR ALL SILL PLATES TO CONCRETE SLABS OR MASONRY WALLS WITH 5/8" DIAMETER ANCHOR BOLTS WITH 15" MIN. EMBEDMENT DEPTH AND 2" HOOK SPACED AT MAX. 32" ON CENTER. PROVIDE 2 ANCHOR BOLTS MINIMUM PER PLATE.
- E. ALL LAMINATED VENEER LUMBER (LVL) SHALL BE FABRICATED TO PRODUCE THE FOLLOWING MINIMUM ALLOWABLE STRESSES:

EXTREME FIBER IN BENDING F = 2,900 PSIMODULUS OF ELASTICITY E = 2,000,000 PSI

5B. WOOD WALLS AND COLUMNS

- A. ALL PERIMETER STUD BEARING WALLS AND INTERIOR BEARING WALLS SHALL BE 2X6 @ 16" O/C UNLESS NOTED OTHERWISE. PROVIDE SOLID BRIDGING AT MID HEIGHT OF ALL STUD WALLS TO 9'-0" HIGH UNLESS NOTED OTHERWISE. STUD WALLS OVER 9'-0" SHALL BE PROVIDED WITH 2 ROWS OF SOLID BRIDGING LOCATED AT THE THIRD POINT OF THE STUD HEIGHT UNLESS NOTED OTHERWISE.
- B. PROVIDE DOUBLE STUDS AT ALL CORNERS, SIDES OF ALL OPENINGS, WINDOWS AND DOORS, AND BENEATH ALL WOOD BEAMS AND LINTELS UNLESS NOTED OTHERWISE ON PLANS. DOUBLE STUDS BENEATH WOOD BEAMS AND LINTELS SHALL BE CARRIED THROUGH ANY INTERMEDIATE FLOOR FRAMING TO THE TOP OF FOOTINGS OR MASONRY FOUNDATION WALLS.

5C. PLYWOOD

- A. ALL PLYWOOD SHALL MEET THE REQUIREMENTS OF THE PLYWOOD DESIGN SPECIFICATIONS AS PUBLISHED BY THE AMERICAN PLYWOOD ASSOCIATION.
- B. ENTIRE ROOF DECK SHALL BE 5/8"-24/0 PLYWOOD. PROVIDE PLY CLIPS AT CENTERLINE OF PLYWOOD SPAN AT ALL EDGES PARALLEL TO SPAN.
- C. PLYWOOD SHEATHING SHALL BE CONTINUOUS OVER A MINIMUM OF 2 SPANS.
- D. PLYWOOD SHALL BE SECURELY FASTENED 3/8" FROM THE EDGE.
- E. PLYWOOD 1/2" IN THICKNESS AND LESS SHALL BE PROVIDED WITH PLY-CLIPS ALONG EDGES AT MIDSPAN. PLYWOOD 5/8" AND THICKER SHALL EITHER HAVE TONGUE AND GROOVE EDGES OR PLY-CLIPS AT MIDSPAN. FOR 48" SPANS PROVIDE 2 PLY CLIPS AT THIRD JOINTS OR TONGUE AND GROOVE PLYWOOD.
- F. MINIMUM NAIL SIZE NO. 11 GAGE, 1-3/4" LONG, 7/16" HEAD, DIAMOND POINT, GALVANIZED. ALTERNATE NAILS MAY BE USED IF THEIR DIMENSIONS ARE NOT LESS THAN THE SPECIFIED VALUES.
- G. END JOINTS OF ADJACENT COURSES OF GYPSUM BOARD SHEATHING SHALL NOT OCCUR OVER THE SAME STUD.
- H. WHERE BLOCKING IS REQUIRED BLOCKING SHALL BE THE SAME SIZE AS TYPICAL STUDS AND SHALL BE PROVIDED AT ALL JOINTS THAT ARE PERPENDICULAR TO STUDS.
- NAILS SHALL BE SPACED NOT LESS THAN 3/8" FROM EDGES AND ENDS OF GYP BOARD SHEATHING.
- NAIL SPACING SPECIFIED APPLIES TO ALL STUDS, TOP AND BOTTOM PLATES, AND BLOCKING.

6. STRUCTURAL AND MISCELLANEOUS STEEL

A. GENERAL AND NEW CONSTRUCTION

- ALL STRUCTURAL AND MISCELLANEOUS STEEL SHALL CONFORM TO THE FOURTEENTH EDITION OF THE AISC "SPECIFICATION FOR STRUCTURAL STEEL BUILDINGS" AND ALL ITS SUPPLEMENTS, AND TO THE AISC "CODE OF STANDARD PRACTICE FOR STEEL BUILDINGS AND BRIDGES."
- 2) ALL STRUCTURAL STEEL SHALL BE AS FOLLOWS:

W-SHAPES ASTM A992, FY = 50,000 PSI
MISCELLANEOUS STEEL ASTM A572 GRADE 50, FY = 50,000 PSI
RECTANGULAR/SQUARE HSS ASTM A500 GRADE C, FY = 50,000 PSI

- 3) NO OPENINGS IN BEAMS SHALL BE PERMITTED WITHOUT THE WRITTEN PERMISSION OF THE ENGINEER.
- 4) THE USE OF A GAS-CUTTING TORCH IN THE FIELD FOR CUTTING HOLES OR FOR CORRECTIONS FABRICATION ERRORS WILL NOT BE PERMITTED ON NEW STRUCTURAL FRAMING MEMBERS EXCEPT WITH THE WRITTEN APPROVAL OF THE ARCHITECT FOR EACH SPECIFIC CONDITION.
- 5) FIELD STRUCTURAL STEEL TO BE INSPECTED BY QUALIFIED INSPECTORS APPROVED BY THE STRUCTURAL ENGINEER AND RETAINED BY THE CONTRACTOR. FIELD INSPECTION REPORTS TO BE FILED WITH THE STRUCTURAL ENGINEER WITHIN 5 DAYS OF TIME OF ACTUAL INSPECTION. INSPECTORS MUST BE NOTIFIED OF ALL PHASES OF CONSTRUCTION AND WELDING BY GENERAL CONTRACTOR.
- 6) ALL WELDED CONNECTIONS SHALL BE DONE WITH E70XX ELECTRODES. SHOP AND FIELD WELDS SHALL BE MADE BY APPROVED CERTIFIED WELDERS AND SHALL CONFORM TO THE AMERICAN WELDING SOCIETY CODE FOR BUILDINGS AWS D1.1. WELDS SHALL DEVELOP THE FULL STRENGTH OF MATERIALS BEING WELDED UNLESS OTHERWISE NOTED.
- 7) ALL BUTT WELDS SHALL BE FULL PENETRATION BUTT WELDS IN ACCORDANCE WITH THE STRUCTURAL WELDING CODE (ANSI/AWS D1.1). THESE WELDS SHALL BE MADE ONLY BY OPERATORS QUALIFIED BY PRESCRIBED TESTS IN THE STRUCTURAL WELDING CODE IN BUILDING CONSTRUCTION OF THE AMERICAN WELDING SOCIETY. ACCEPTANCE TO BE SUBJECT TO THE INSPECTION AND REVIEW OF AN INDEPENDENT INSPECTION AGENCY.
- 8) WELDING SEQUENCE AND TECHNIQUE SHALL BE SUCH THAT DISTORTION OF STEEL MEMBERS IS MINIMIZED AND UNDUE DISTORTION IS AVOIDED.

7. POST-INSTALLED ANCHORS

A. ANCHORS IN CONCRETE AND MASONRY

- POST INSTALLED ANCHORS SHALL BE USED ONLY WHERE SPECIFIED ON STRUCTURAL CONTRACT DRAWINGS
- 2) THE INSTALLATION OF POST INSTALLED ANCHORS FOR MISSING OR MISPLACED CAST IN-PLACE ANCHORS SHALL BE APPROVED BY THE ENGINEER OF RECORD
- 3) EXISTING EMBEDDED ITEMS IN THE CONCRETE STRUCTURE (I.E., REINFORCING BARS, CONDUIT, ETC.) SHALL NOT BE CUT UNLESS APPROVED BY THE STRUCTURAL ENGINEER OF RECORD.
- 4) SUBMITTAL OF ALL PROPOSED PRODUCTS, WITH TECHNICAL DATA AND CURRENT ICC-ESR REPORTS IS REQUIRED FOR REVIEW AND APPROVAL BY ENGINEER OF RECORD. ADDITIONAL APPLICATION CALCULATIONS MAY BE REQUIRED BY THE ENGINEER OF RECORD.
- 5) ALL ANCHORS SHALL BE INSTALLED IN STRICT ACCORDANCE WITH MANUFACTURER'S PRINTED INSTALLATION INSTRUCTIONS (MPII) IN CONJUNCTION WITH EDGE DISTANCE, SPACING AND EMBEDMENT DEPTH AS INDICATED ON THE CONTRACT DRAWINGS.
- 6) THE CONTRACTOR SHALL ARRANGE FOR A MANUFACTURER'S FIELD REPRESENTATIVE TO PROVIDE INSTALLATION TRAINING FOR ALL PRODUCTS TO BE USED, PRIOR TO COMMENCEMENT OF WORK. ONLY TRAINED INSTALLERS SHALL PERFORM POST INSTALLED ANCHOR INSTALLATION. A RECORD OF TRAINING SHALL BE KEPT ON SITE AND BE MADE AVAILABLE TO THE ENGINEER OF RECORD AS REQUESTED.
- 7) ADHESIVE ANCHORS INSTALLED IN HORIZONTAL TO VERTICALLY OVERHEAD ORIENTATION TO SUPPORT SUSTAINED TENSION LOADS SHALL BE DONE BY A CERTIFIED ADHESIVE ANCHOR INSTALLER (AAI) AS CERTIFIED THROUGH ACI/CRSI (ACI 318-14 17.8). PROOF OF CURRENT CERTIFICATION SHALL BE SUBMITTED TO THE ENGINEER FOR APPROVAL PRIOR TO COMMENCEMENT OF INSTALLATION.
- 8) ADHESIVE ANCHORS MUST BE INSTALLED IN CONCRETE AGED A MINIMUM OF 21 DAYS (ACI 318-14 17.1.2).
- 9) PROVIDE SPECIAL INSPECTION FOR ALL MECHANICAL AND ADHESIVE ANCHORS PER THE APPLICABLE BUILDING CODE AND PER THE CURRENT ICC-ES REPORT (IBC 2015 TABLE 1705.3 NOTE B).
- 10) SUBSTITUTION REQUESTS, FOR PRODUCTS OTHER THAN THOSE SPECIFIED BELOW, SHALL BE SUBMITTED BY THE CONTRACTOR TO THE ENGINEER OF RECORD ALONG WITH CALCULATIONS THAT ARE PREPARED & SEALED BY A REGISTERED PROFESSIONAL ENGINEER. THE CALCULATIONS SHALL DEMONSTRATE THAT THE SUBSTITUTED PRODUCT IS CAPABLE OF ACHIEVING EQUIVALENT PERFORMANCE VALUES (MINIMUM) OF THE SPECIFIED PRODUCT USING THE APPROPRIATE DESIGN PROCEDURE AND/OR STANDARDS(S) AS REQUIRED BY ACI 318-14 CHAPTER 17.
- 11) THE FOLLOWING MANUFACTURER'S HAVE BEEN PRE-APPROVED FOR
- a. POWERS FASTENERSb. HILTI INC
- c. SIMPSON

B. CONCRETE ANCHORS

- MECHANICAL ANCHORS SHALL HAVE BEEN TESTED AND QUALIFIED FOR USE IN ACCORDANCE WITH ACI 355.2 AND ICC-ES AC193 FOR CRACKED, UNCRACKED AND SEISMIC CONCRETE RECOGNITION.
- 2) ADHESIVE ANCHORS SHALL HAVE BEEN TESTED AND QUALIFIED FOR USE IN ACCORDANCE WITH ACI 355.4 AND ICC-ES AC308 FOR CRACKED, UNCRACKED AND SEISMIC CONCRETE RECOGNITION.
- 3) CAST-IN-PLACE INSERTS SHALL HAVE BEEN TESTED AND QUALIFIED FOR USE IN ACCORDANCE WITH ICC-ES AC446 FOR CRACKED, UNCRACKED AND SEISMIC CONCRETE RECOGNITION.

C. MASONRY ANCHORS

- 1) MECHANICAL ANCHORS SHALL HAVE BEEN TESTED AND QUALIFIED FOR USE IN ACCORDANCE WITH ICC-ES AC01 OR AC106.
- 2) ADHESIVE ANCHORS SHALL HAVE BEEN TESTED AND QUALIFIED FOR USE IN ACCORDANCE WITH ICC-ES AC58.

8. MASONRY

- A. ALL MASONRY CONSTRUCTION AND MATERIALS USED THEREIN (CONCRETE MASONRY, CLAY MASONRY, MORTAR, GROUT AND STEEL REINFORCEMENT) SHALL CONFORM TO "BUILDING CODE REQUIREMENTS FOR MASONRY STRUCTURES" (ACI 530/ASCE 5/TMS 402) AND "SPECIFICATIONS FOR MASONRY STRUCTURES" (ACI 530.1/ASCE 6/TMS 602) IN ALL RESPECTS. WHERE ANCHORS (INCLUDING ANCHOR BOLTS) ARE INDICATED TO BE GROUTED IN CELLS OF HOLLOW CMU, THE CELL CONTAINING THE ANCHOR (OR ANCHOR BOLT) SHALL BE FULLY GROUTED AND IN ADDITION TO THIS CELL THE CELLS ABOVE, BELOW, TO EACH SIDE, AND THE FOUR CELLS ON EACH 45 DEGREE DIAGONAL ADJACENT TO THE CELL CONTAINING THE ANCHOR/ANCHOR BOLT SHALL BE FULLY GROUTED AND THE EIGHT SURROUNDING CELLS SHALL BE FULLY GROUTED.
- B. UNLESS OTHERWISE NOTED CONCRETE MASONRY UNITS SHALL HAVE A MINIMUM NET AREA COMPRESSIVE STRENGTH OF 2,000 PSI. TYPE "S" PORTLAND CEMENT/LIME MORTAR SHALL BE USED FOR ALL MASONRY.
- C. MASONRY BEARING WALLS SHALL CONSIST OF STANDARD HOLLOW UNITS CONFORMING TO ASTM C 90 UNLESS OTHERWISE NOTED. WHERE SOLID UNITS ARE REQUIRED, PROVIDE UNITS CONFORMING TO ASTM C 145. CONCRETE MASONRY SHALL BE SAMPLED AND TESTED BY THE MASONRY SUPPLIER ACCORDING TO THE REQUIREMENTS OF "BUILDING CODE REQUIREMENTS FOR MASONRY STRUCTURES" (ACI 530/ASCE 5/TMS 402) AND "SPECIFICATIONS FOR MASONRY STRUCTURES" (ACI 530.1/ASCE 6/TMS 602) AND RESULTS SUBMITTED TO THE ENGINEER FOR APPROVAL. USE FULL HEAD JOINTS, FILL COLLAR JOINTS 100% SOLID, BOND PIERS INTO WALLS BY TOOTHING, AND BOND WALLS TO CROSS-WALLS BY TOOTHING.
- D. ALL MORTAR SHALL CONFORM TO THE REQUIREMENTS FOR PROPORTIONS, MIXING, STRENGTH, SAMPLING, TESTING, AND APPLICATION FOR PORTLAND CEMENT/LIME TYPE "S" MORTAR AS DESCRIBED IN ACI 530.
- E. MASONRY CONSTRUCTION IS TO BE INSPECTED BY AN EXPERIENCED, QUALIFIED INSPECTOR APPROVED BY THE STRUCTURAL ENGINEER. INSPECTION IS TO BE PROVIDED IN ACCORDANCE WITH THE ACI/ASCE/TMS CODE AND SPECIFICATION.
- F. ALL SOLID CMU IS TO BE 100% SOLID CMU OR HOLLOW CMU WITH ALL CELLS FILLED 100% WITH GROUT CONFORMING TO ASTM C 476.
- G. LOOSE LINTELS FOR MASONRY WALLS SHALL BE FOR EACH 4" WIDTH OF MASONRY ONE STEEL ANGLE AS FOLLOWS:

0'-0" TO 3'-0" \(\alpha \) 1/2" \(\times \) 1/2" \(\times \) 5/16" \(\alpha \) 1/2" \(\times \) 5/16" \(\alpha \) 1/2" \(\times \) 5/16"

3'-1" TO 5'-0" ∠4" x 3 1/2" x 5/16" 5'-1" TO 6'-6" ∠5" x 3 1/2" x 3/8" 6'-7" TO 8'-0" ∠6" x 3 1/2" x 3/8"

- H. ALL ANGLES SHALL HAVE THEIR SHORT LEG OUTSTANDING AND 6" MINIMUM BEARING LINTELS OVER OPENINGS IN INTERIOR NON-BEARING MASONRY PARTITIONS NOT OTHERWISE SPECIFIED SHALL BE PRECAST LIGHTWEIGHT CONCRETE LINTELS WITH 1 NO. 5 BAR TOP AND BOTTOM FOR EACH 4" WIDTH. ALL MULTIPLE ANGLE LINTELS SHALL BE TACK WELDED TOGETHER AT ENDS AND AT THIRD POINTS. SHORE LINTELS TO PREVENT ROTATION DURING CONSTRUCTION.
- I. LAP ALL VERTICAL REINFORCING 48 BAR DIAMETERS MINIMUM.
- J. ALL EXTERIOR WALLS AND ALL WALLS SUPPORTING LOADS OTHER THAN THEIR OWN WEIGHT SHALL BE CONSTRUCTED OF LOAD BEARING UNITS.
- K. ALL MASONRY WALLS SHALL BE REINFORCED WITH NO. 9 GAGE TRUSS-TYPE HOT DIPPED GALVANIZED JOINT REINFORCEMENT SPACED VERTICALLY AT 16" O/C U.N.O. PROVIDE CORNER AND TEE PIECES AT ALL INTERSECTIONS. LAP ALL JOINT REINFORCEMENT 6" MINIMUM.
- L. PROVIDE 16" MINIMUM DEPTH OF 100% SOLID MASONRY OR HOLLOW BLOCK FILLED SOLID WITH GROUT BELOW ALL LINTELS.
- M. BRACE AND SHORE ALL NEW MASONRY WALLS AS REQUIRED UNTIL ROOF DECKS HAVE BEEN COMPLETELY INSTALLED.
- N. PROVIDE SOLID BLOCK OR FILL WALL SOLID WITH GROUT DIRECTLY BELOW ALL CHANGES IN WALL THICKNESS OR CONSTRUCTION AS REQUIRED TO PROVIDE CONTINUOUS BEARING FOR ALL FACE SHELLS OF BLOCK.
- O. PROVIDE 8" DEEP SOLID BEARING BELOW ALL WOOD JOISTS AND STUDS BEARING ON MASONRY WALLS. SOLID BEARING SHALL BE SOLID BLOCK OR BRICK OR HOLLOW BLOCK FILLED SOLID WITH GROUT.

2									
	NI, LLC uite 200 0.21286 m.com								

WHITNEY BAILEY COX & MAGNANI, LLC
300 East Joppa Road Suite 200
Baltimore, MD 21286
410.512.4500 www.wbcm.com

Designing Infrastructure for Tomorrow ®

I hereby certify that these documents were prepared or approved by me, and that I am a duly licensed professional engineer under the laws of the State of Maryland.

License # _____ Expiration Date: __/_/2022

GENERAL NOTES


TERATIONS - BURGER KING # 957


DESIGNED: FC
DRAWN: CG
CHECKED: MWS
SCALE: AS NOTED
DATE: 01/29/2021
PROJECT: 2018.0375.04.0

DRAWING:

S001

PERMIT SUBMISSION 01-29-2021

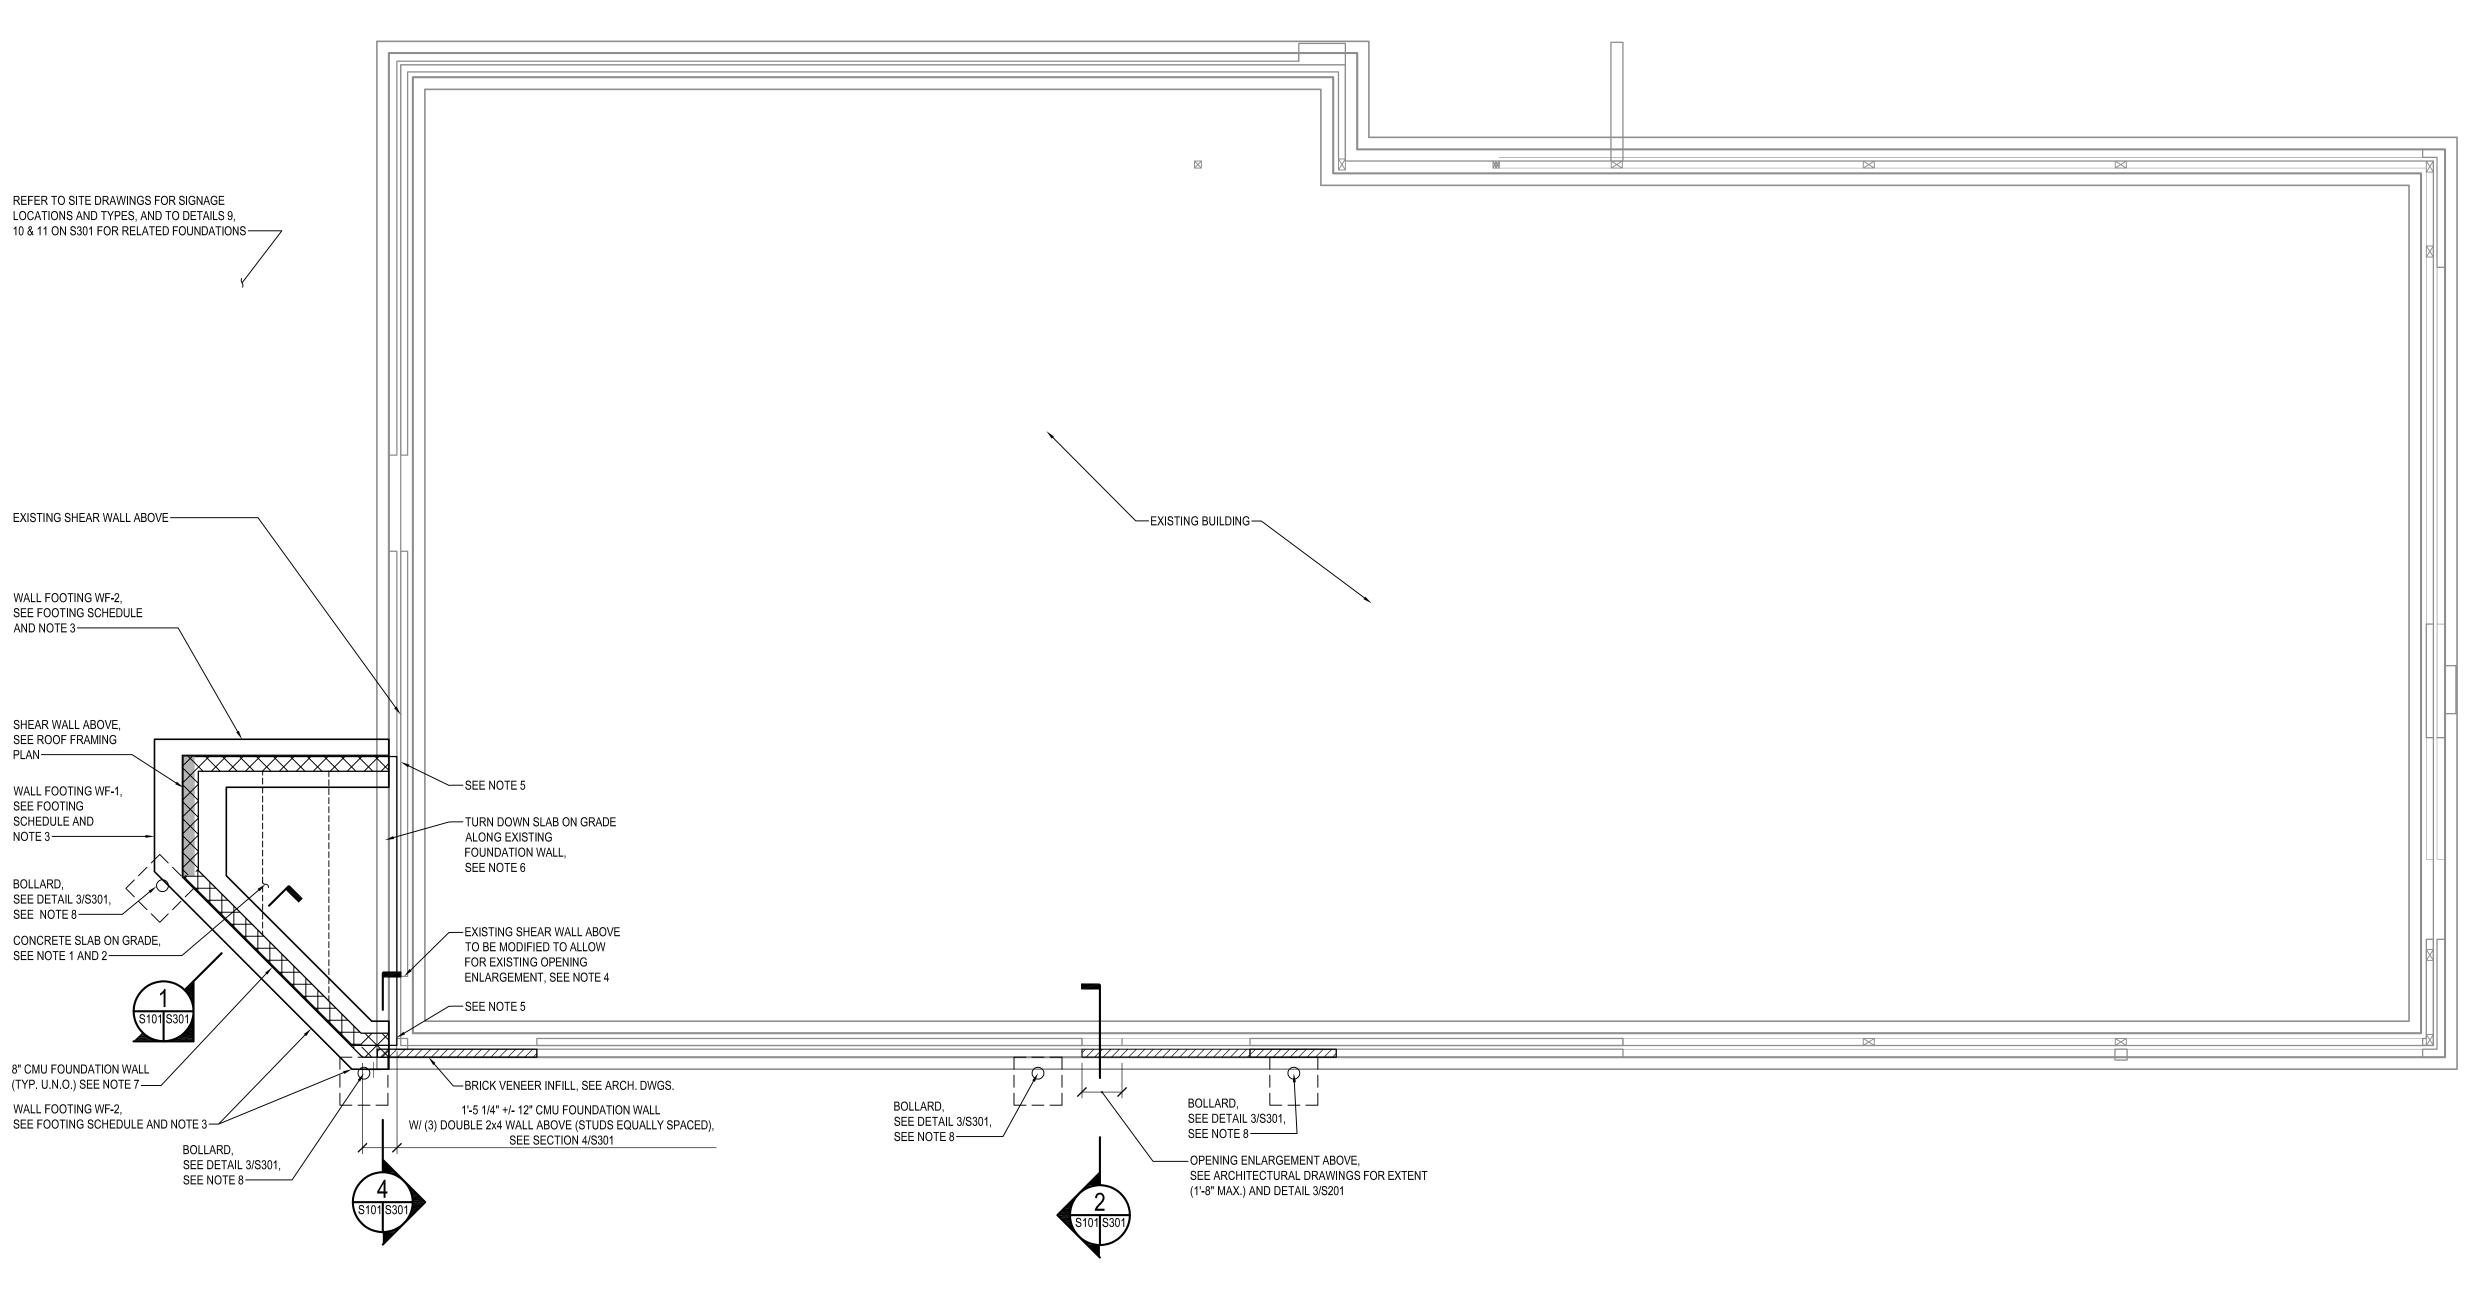

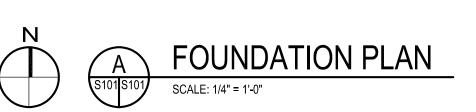

FOUNDATION PLAN NOTES:

- 1. FINISH FLOOR ELEVATION TO MATCH EXISTING, SEE ARCH. DWGS.
- 2. CONCRETE SLAB ON GRADE SHALL BE 5" CONCRETE SLAB REINFORCED W/ 6x6-W2.9xW2.9 WWF PLACED OVER 4" THICK LAYER OF #57 STONE & 10 MIL VAPOR BARRIER.
- 3. BOTTOM OF FOOTING TO MATCH BOTTOM EXISTING ADJACENT FOOTINGS OR TO BE 2'-6" MIN. BELOW GRADE, WHICHEVER IS GREATER. IF BOTTOM OF EXISTING FOOTING IS FOUND TO BE LOCATED AT AN ELEVATION LESSER THAN 2'-6" BELOW GRADE, UNDERPINNING OF EXISTING FOOTING WILL BE REQUIRED.
- 4. RELOCATE EXISTING END WOOD STUDS, HOLDOWN AND ALL CONNECTED PARTS OF EXISTING SHEAR WALL TO ALLOW FOR EXISTING OPENING ENLARGMENT (SEE ARCH. DWGS FOR EXTENT (MAX. 6-1/2" WIDTH INCREASE) AND ADDITIONAL INFORMATION), USE 5/8" DIAMETER ASTM F1554 GR 36 THREADED ROD W/ HIT-RE 500 V3 ADHESIVE W/ 6" MIN. EMBEDMENT DEPTH IN EXISTING CONCRETE @ RELOCATED HOLDOWN. MODIFY EXISTING PLYWOOD SHEATHING AND RECONNECT IT TO RELOCATED END STUDS W/ 10d NAILS @ 6" O/C.
- 5. SEE DETAIL 8/S301 FOR NEW FOOTING AT EXISTING WALL AND DETAIL 2/S301 FOR CONNECTION BETWEEN EXISTING AND NEW CMU WALLS
- 6. TURN DOWN SLAB ON GRADE TO TOP OF EXISTING CMU LEDGE AT INTERFACE WITH EXISTING SLAB / FOUNDATION WALL. ADDITIONAL REINFORCEMENT TO BE #4 @ 24" O/C L-SHAPED BARS, 24" MIN. HORIZONTAL LENGTH, VERTICAL LENGTH TO BE COORDINATED WITH TOP ELEVATION OF EXISTING FOOTING (VIF). PROVIDE 1/2" EXPANSION JOINT MATERIAL @ INTERFACE W/ EXISTING SLAB / FOUNDATION WALL.
- 7. SEE SECTION 1/S301 FOR CMU FOUNDATION WALL INFORMATION AND DETAIL 7/S301 FOR TYPICAL REINFORCED MASONRY CONSTRUCTION.
- 8. COORDINATE LOCATION OF BOLLARDS WITH ARCHITECTURAL AND SITE DRAWINGS, EXISTING BUILDING FOUNDATIONS, WALLS, ETC. MUST NOT BE DEMOLISHED.
- 9. SEE ARCH. DRAWINGS FOR DIMENSIONS AND ELEVATIONS NOT SHOWN

WALL FOOTING SCHEDULE									
	SIZ	ZE	REINFORCEMENT						
MARK	DEPTH	WIDTH	LONGITUDINAL	TRANSVERSAL					
WF-1	12"	3'-0"	(4) #5 CONT.	#5 @ 24" O/C					
WF-2	12"	2'-0"	(3) #5 CONT.	#5 @ 24" O/C					

PERMIT SUBMISSION 01-29-2021

I hereby certify that these documents were prepared or approved by me, and that I am a duly licensed professional engineer under the laws of the State of Maryland. License # _____ Expiration Date: __/__/2022 FOUNDATION PLAN - BURGER ERATIONS. DESIGNED: FC

OIOI

CG

PROJECT: 2018.0375.04.0

MWS

AS NOTED 01/29/2021

DRAWN:

CHECKED:


DRAWING:

SCALE:

P:\2018\18037504\Drawings\03-Struct\2018037504-S101_Foundation Plan.dwg

CAUTION:

IF THIS DRAWING IS A REDUCTION, USE THE GRAPHIC SCALES.

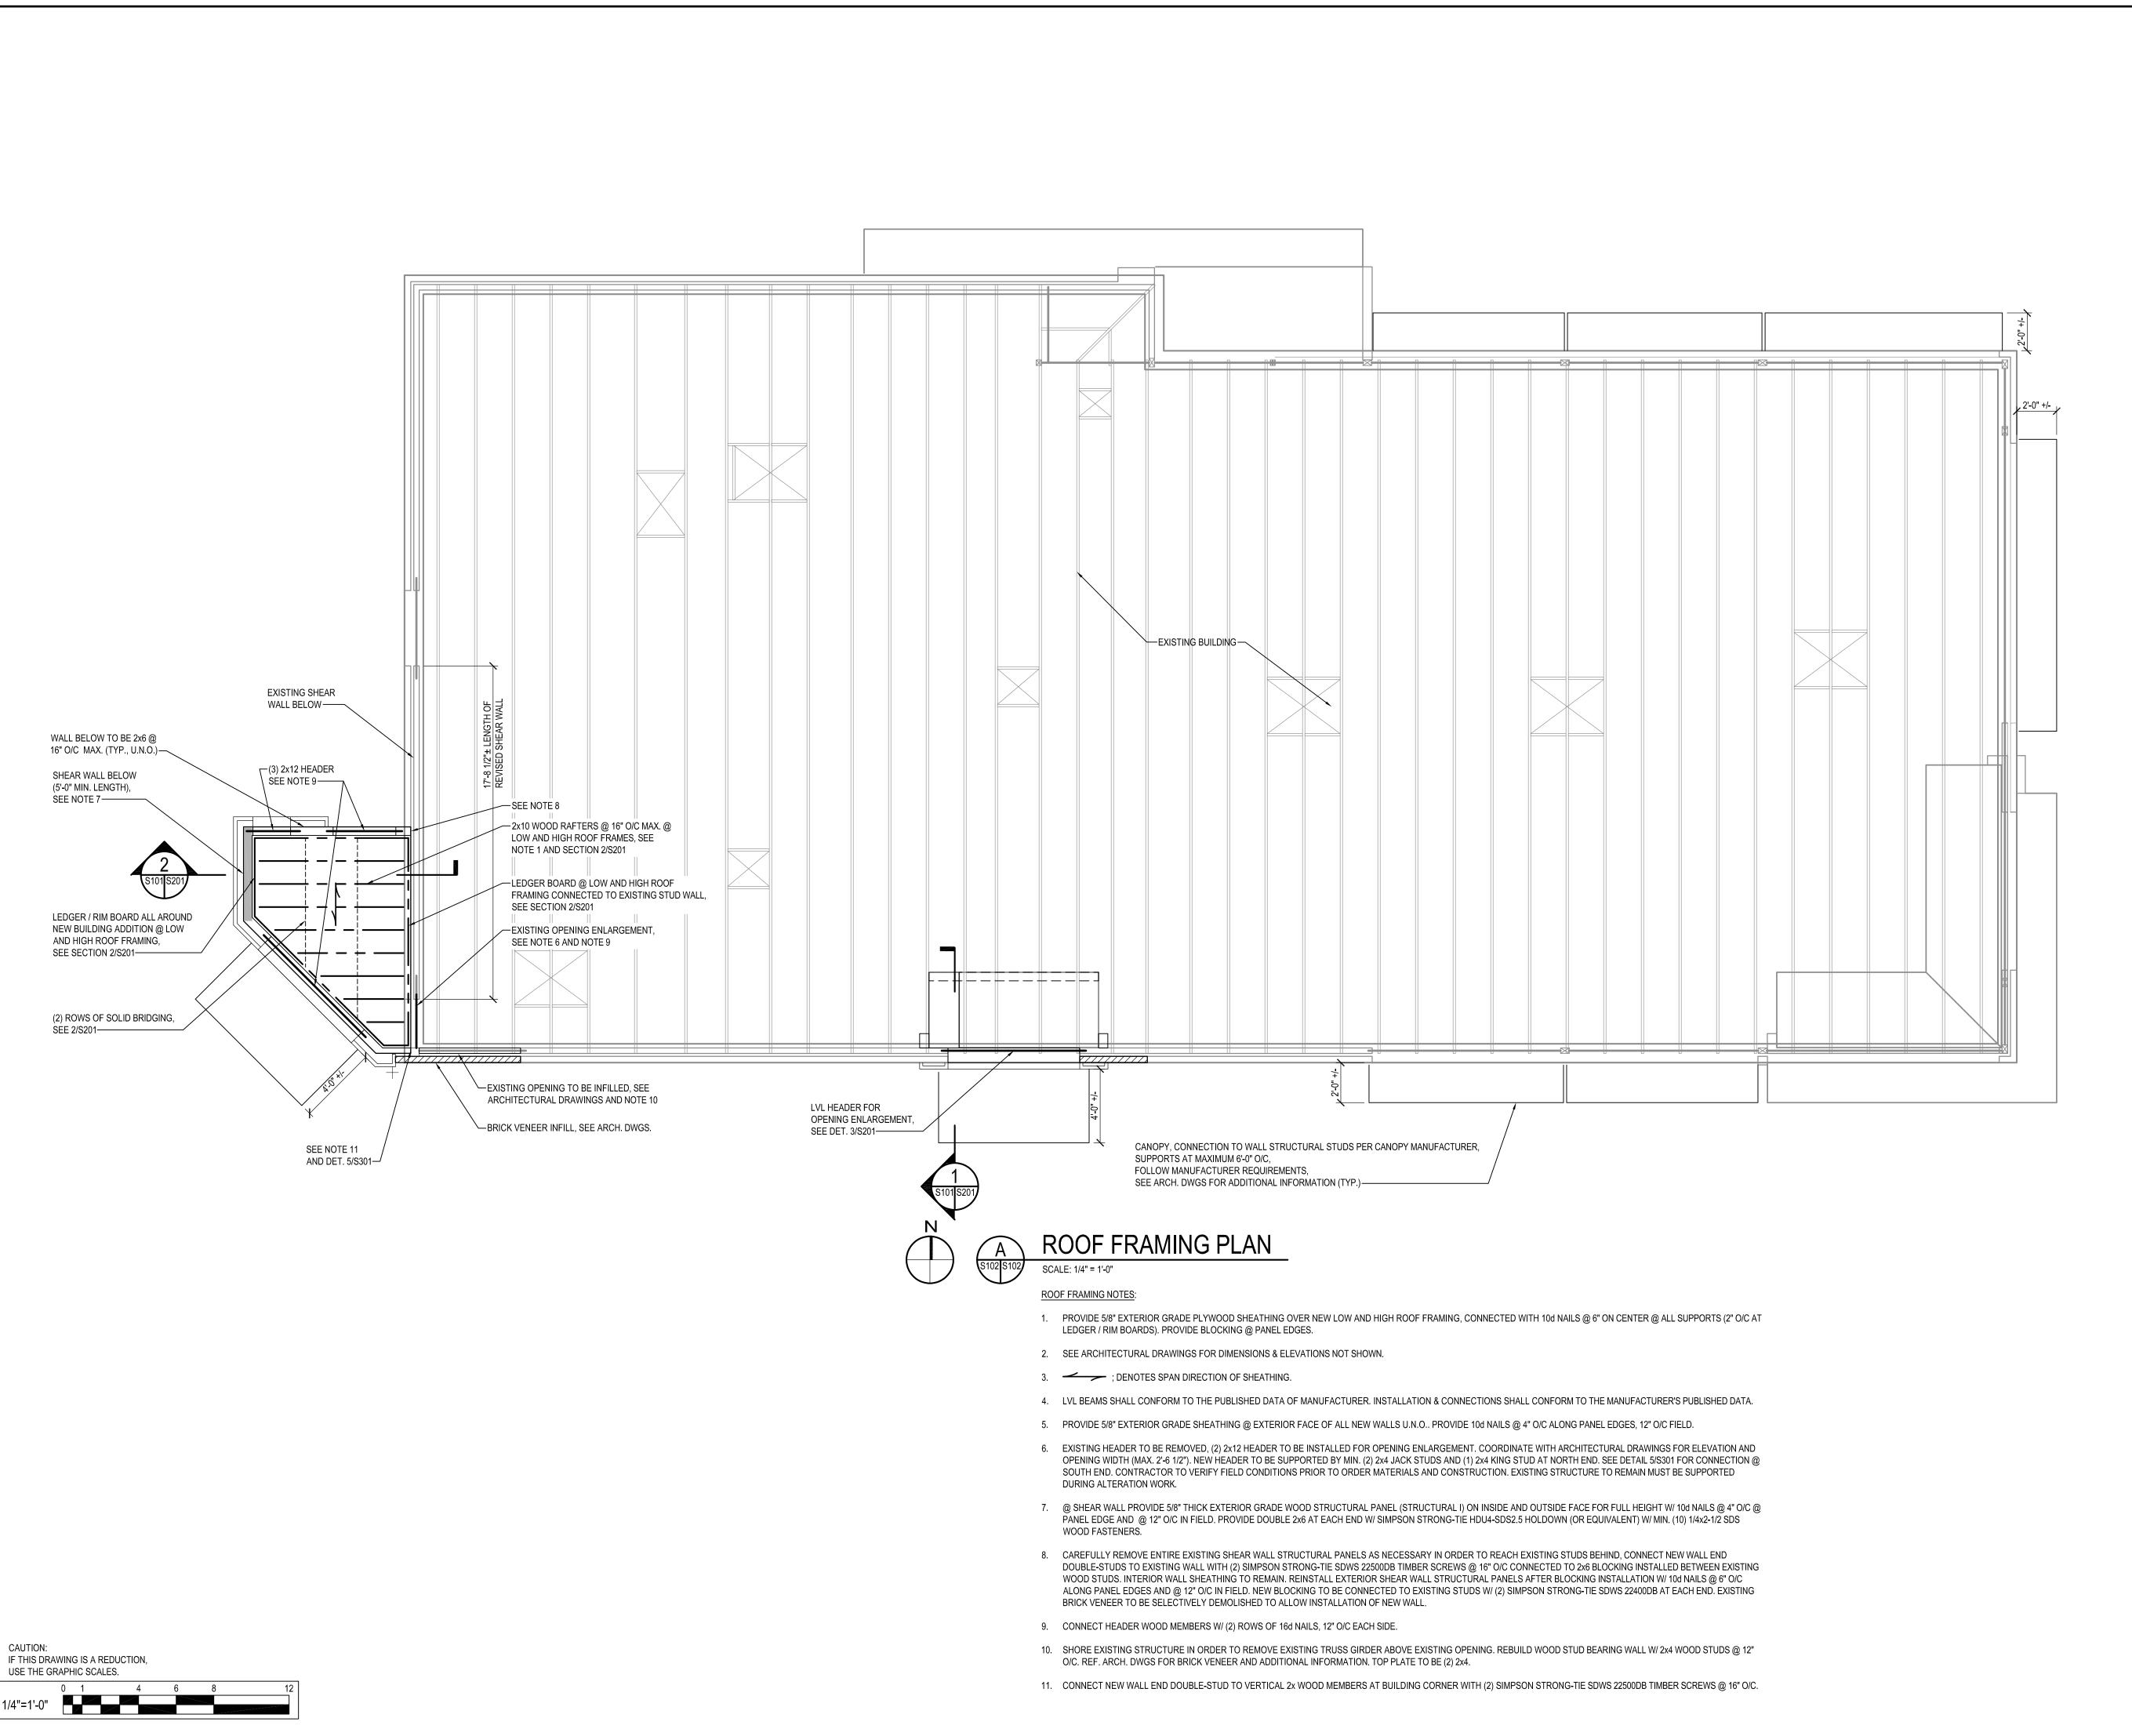

I hereby certify that these documents were prepared or approved by me, and that I am a duly licensed professional engineer under the laws of the State of Maryland. License # _____ Expiration Date: __/__/2022


BURGER


RATIONS

ROOF


DESIGNED: FC DRAWN: CG MWS CHECKED: SCALE: AS NOTED 01/29/2021 PROJECT: 2018.0375.04.0 DRAWING:


PERMIT SUBMISSION 01-29-2021

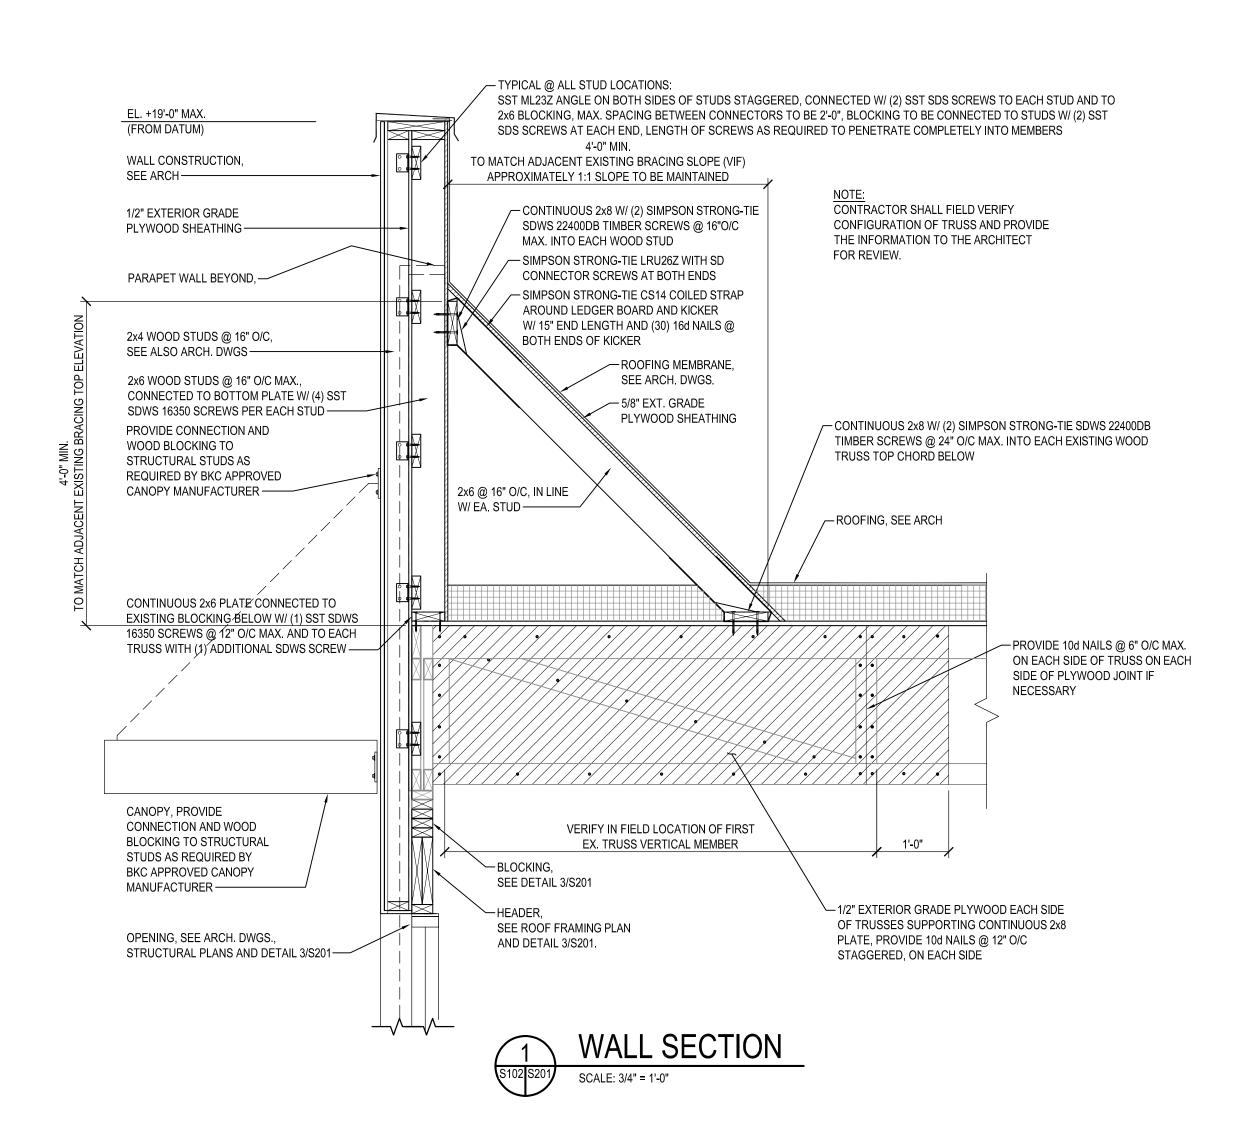

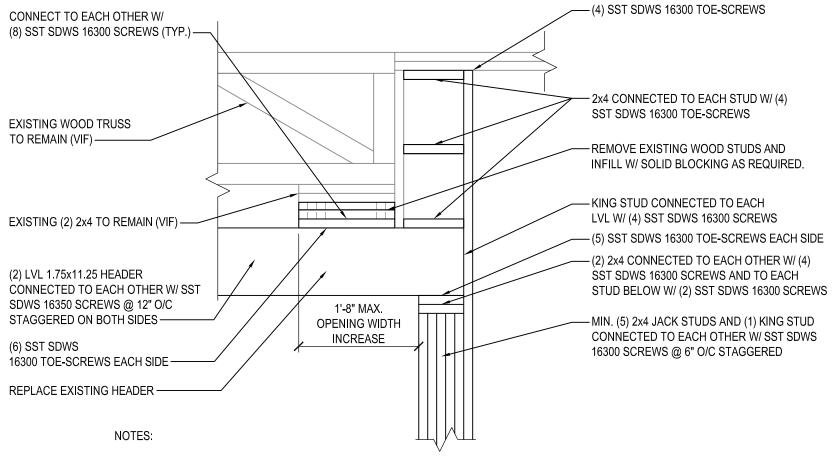

- DETAIL DESIGN IS BASED ON EXISTING STRUCTURAL DRAWINGS. FIELD CONDITIONS MAY BE DIFFER AND MUST BE VERIFIED BY CONTRACTOR PRIOR TO ORDER MATERIALS AND CONSTRUCTION.
- EXISTING STRUCTURE TO REMAIN MUST BE SUPPORTED DURING ALTERATION WORK.
- DETAIL DESIGN CONCEPT TO BE USED ALSO AT OPPOSITE END TO SUPPORT NEW LVL HEADER
- REFER TO THE ARCHITECTURAL DRAWINGS FOR REQUIRED OPENING WIDTH AND HEIGHT.

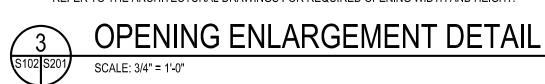

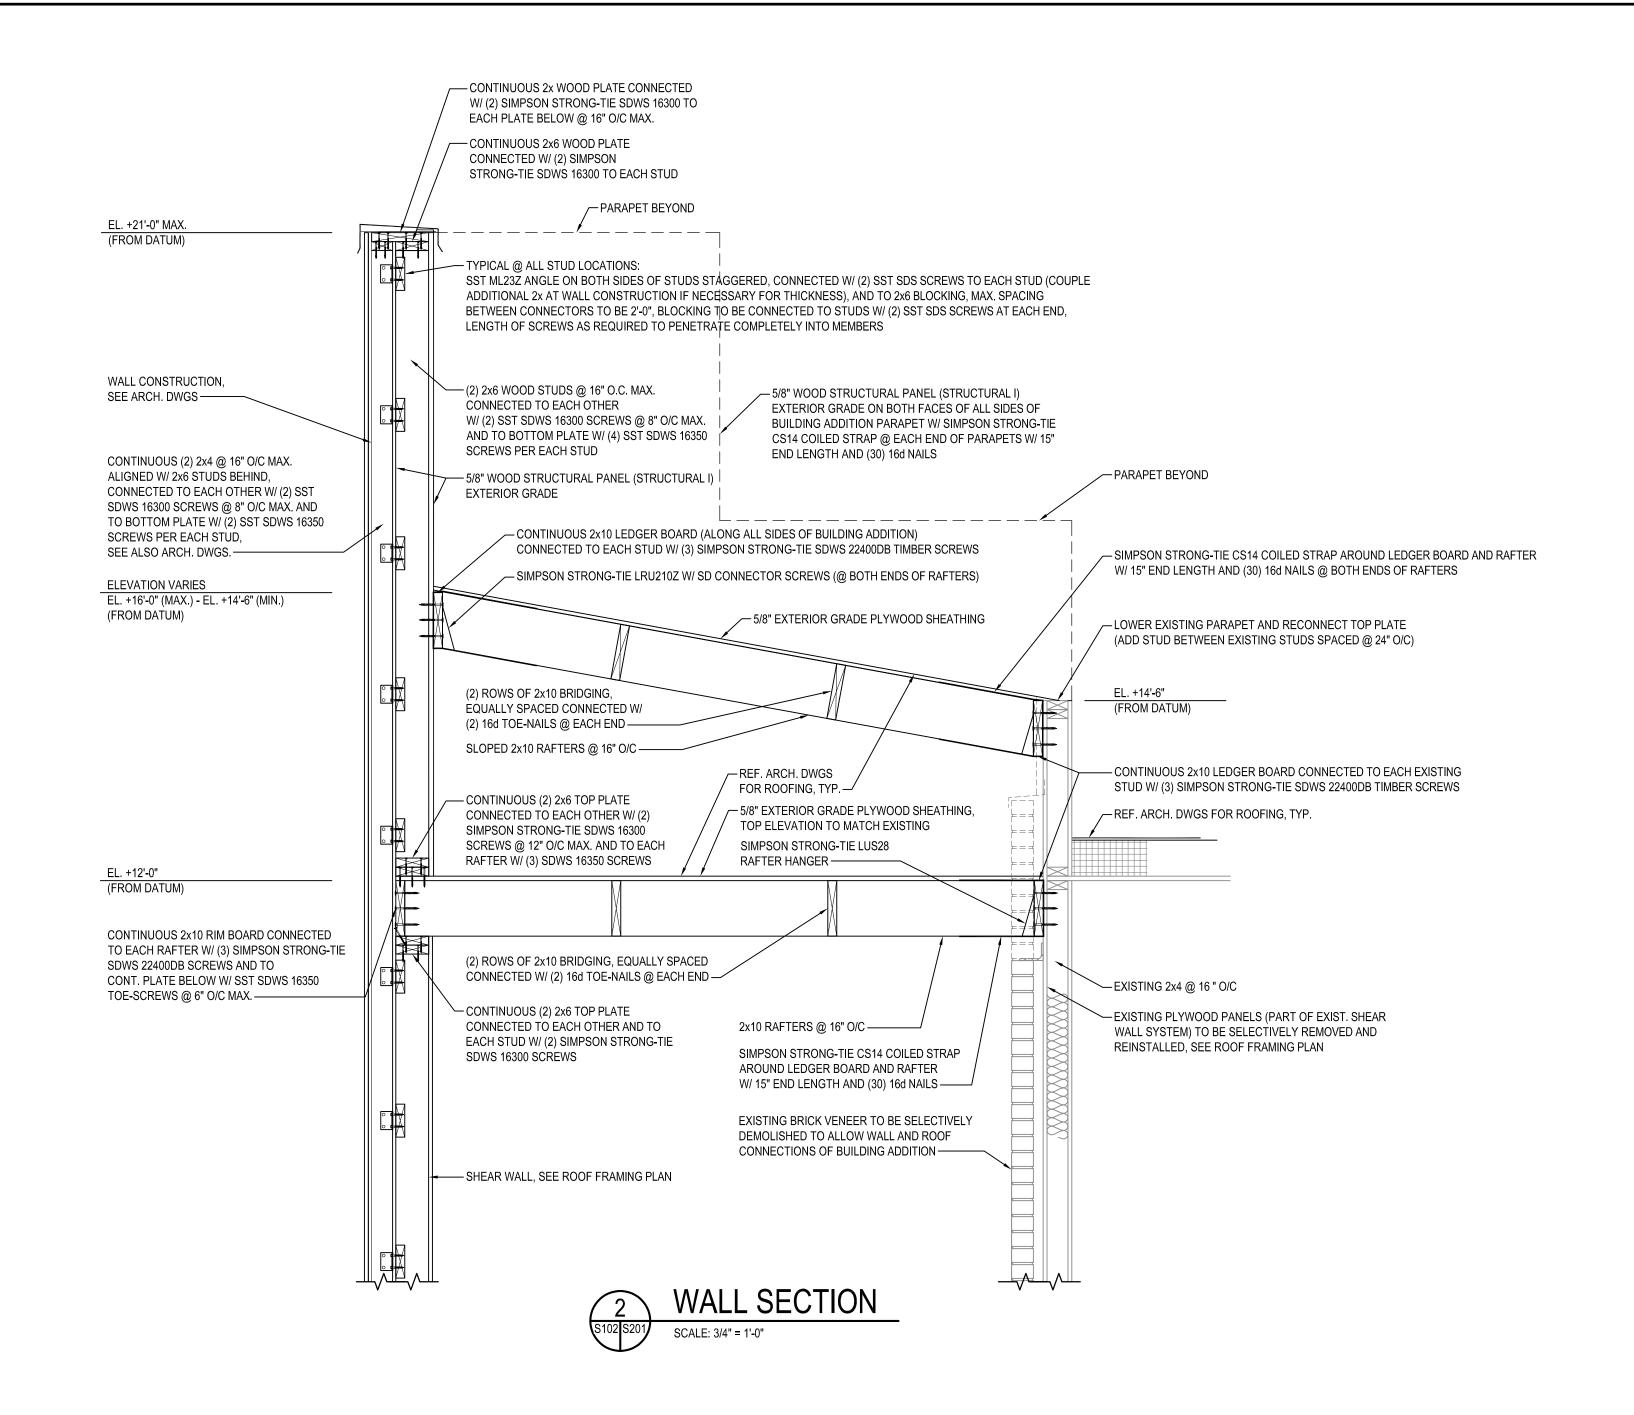


I hereby certify that these documents were prepared or approved by me, and that I am a duly licensed professional engineer under the laws of the State of Maryland. License # _____ Expiration Date: __/__/202 - BURGER SECTIONS RATIONS DESIGNED: DRAWN: CG CHECKED: MWS SCALE AS NOTED 01/29/2021 PROJECT: 2018.0375.04.0 DRAWING:


PERMIT SUBMISSION 01-29-2021

© WBCM 2018

CAUTION:

IF THIS DRAWING IS A REDUCTION, USE THE GRAPHIC SCALES.

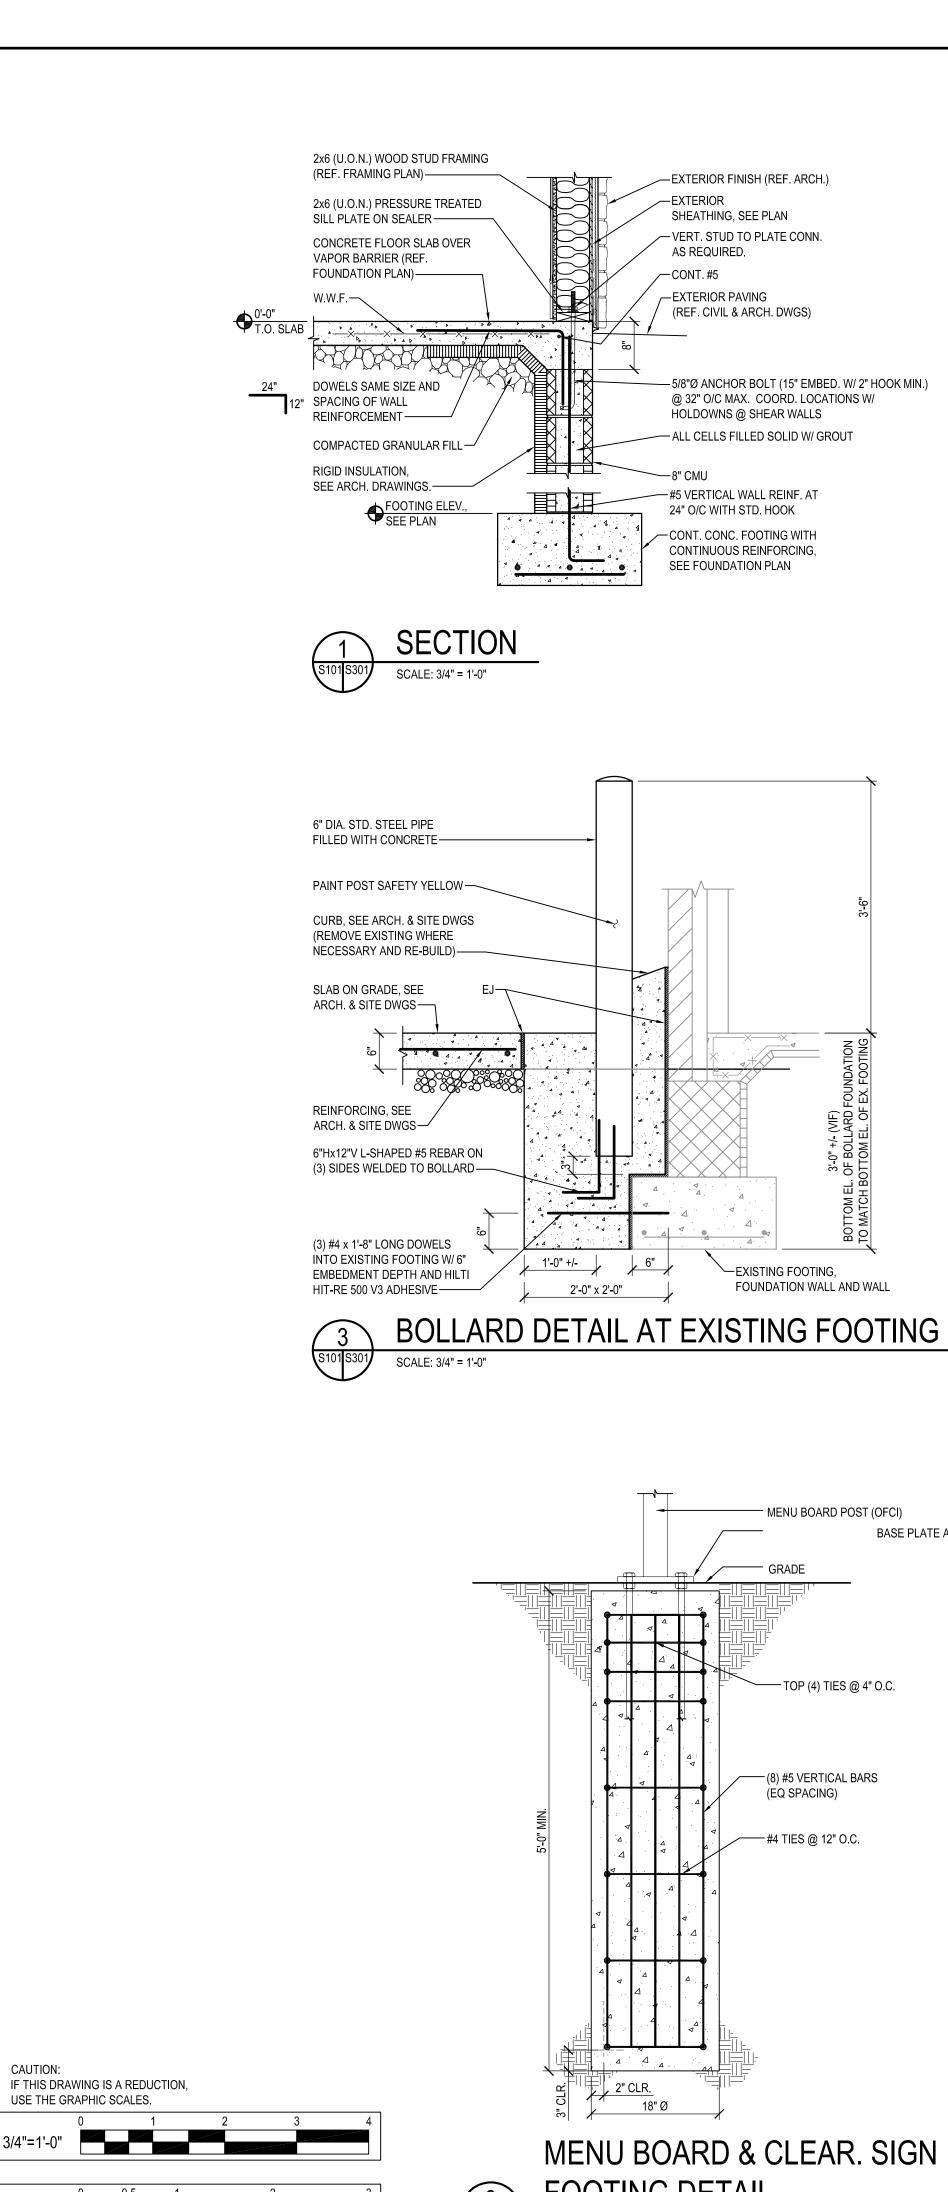

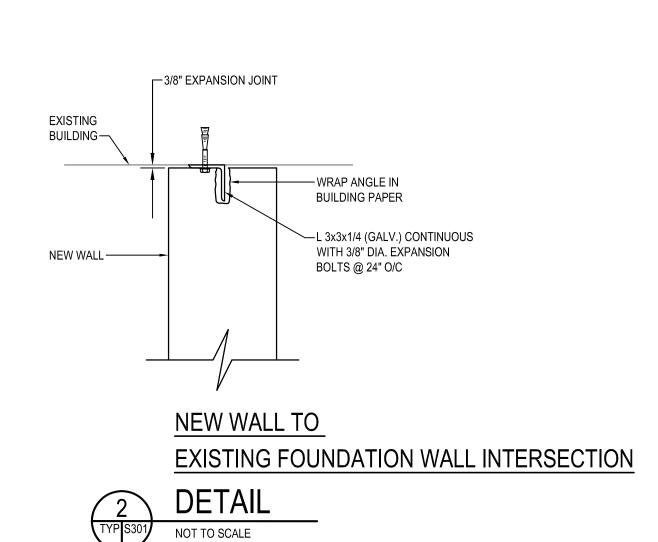

EXTERIOR FINISH (REF. ARCH.)

- VERT. STUD TO PLATE CONN.

(REF. CIVIL & ARCH. DWGS)

HOLDOWNS @ SHEAR WALLS

—#5 VERTICAL WALL REINF. AT

—CONT. CONC. FOOTING WITH CONTINUOUS REINFORCING,

24" O/C WITH STD. HOOK

SEE FOUNDATION PLAN

- ALL CELLS FILLED SOLID W/ GROUT

5/8"Ø ANCHOR BOLT (15" EMBED. W/ 2" HOOK MIN.)

@ 32" O/C MAX. COORD. LOCATIONS W/

-EXISTING FOOTING,

FOUNDATION WALL AND WALL

- MENU BOARD POST (OFCI)

TOP (4) TIES @ 4" O.C.

(8) #5 VERTICAL BARS (EQ SPACING)

-----#4 TIES @ 12" O.C.

MENU BOARD & CLEAR. SIGN

FOOTING DETAIL

DRIVE THROUGH

BASE PLATE ANCHORS AND ASSEMBLY (OFCI)—

CANOPY POST (OFCI) —

SCALE: 1" = 1'-0"

#4 TIES @ 12" O/C

(18) #7 VERTICAL BARS


DRIVE THRU ORDER CONFIRMATION


UNIT & CANOPY FOOTING DETAIL

SHEATHING, SEE PLAN

AS REQUIRED.


EXTERIOR PAVING

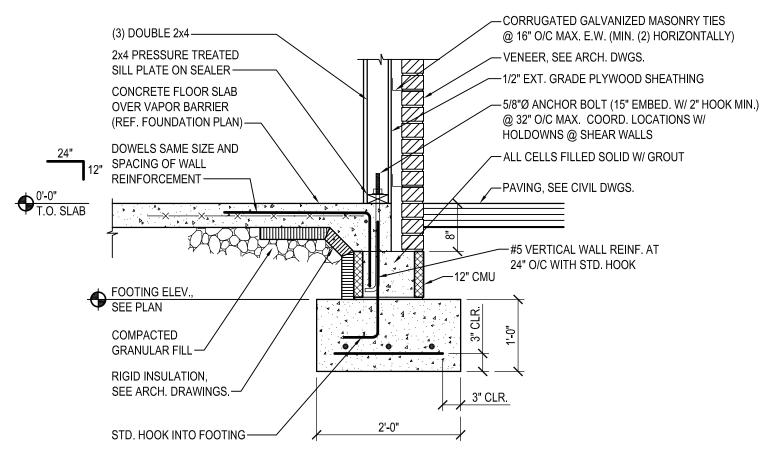

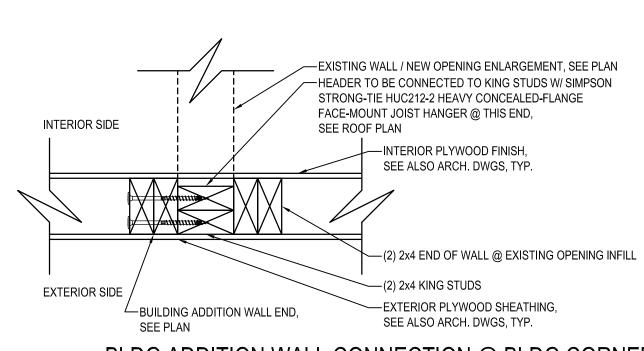


BLDG ADDITION WALL CONNECTION @ BLDG CORNER




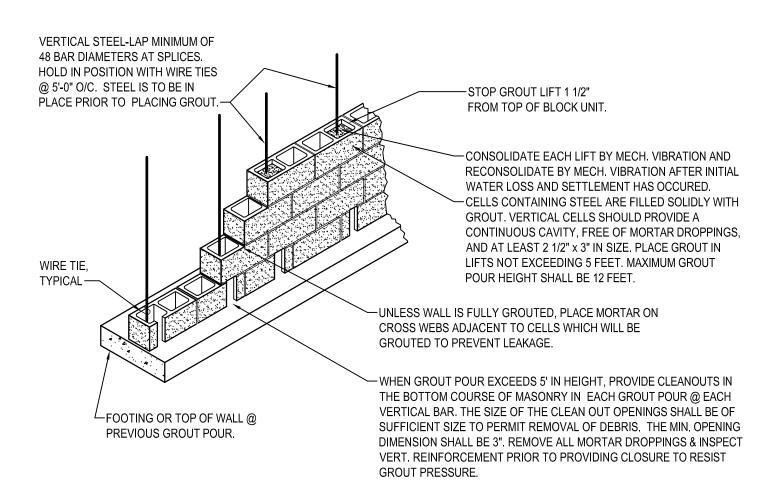



SECTION

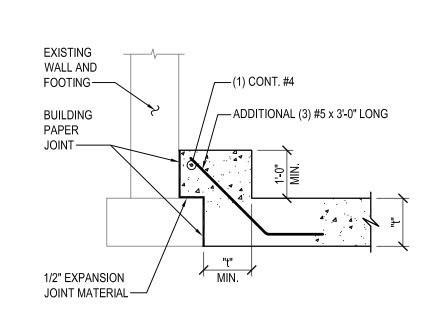

REINFORCED MASONRY CONSTRUCTION

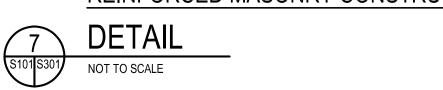

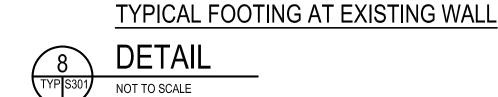

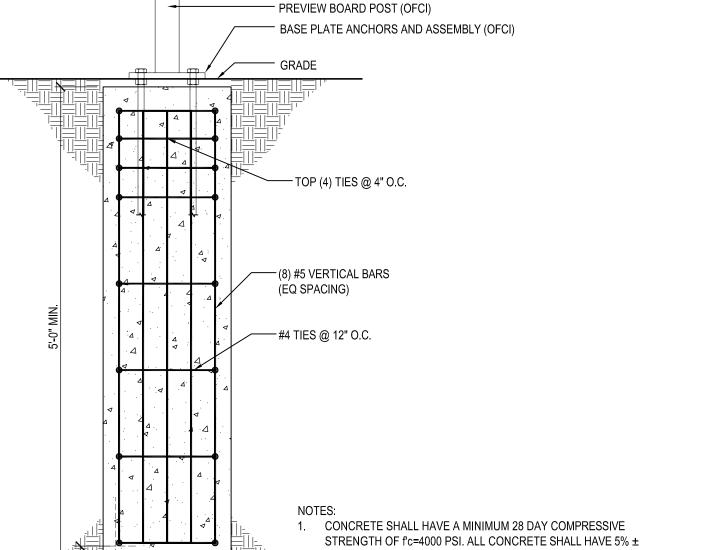

PREVIEW BOARD **FOOTING DETAIL**

		•	√ .			7		= = = -		
<u> </u>		A	<u> </u>	✓	4				-	
		•		-	Δ Δ				- TOI	DP (4) TIES @ 4" O.C.
		⊿ • - ∠	√	Δ		4				
		Ä		Δ	⊿ 1	Δ 4				
			<u>A</u>	. ✓						VERTICAL BARS PACING)
5'-0" MIN.		1	4		<	_ △	✓	щ	TIE	
2-0			Δ Δ <i>δ</i>		Δ <i>∀</i>	4		#4	· IIE	ES @ 12" O.C.
			Δ	٨	Δ		4			
		∀	2	Δ. 4						
		4	→	. ⊿	7	Δ				
			 M	Δ . · · · · · · · · · · · · · · · · · · ·	,				NC	OTES:
			_	.7				<u>-</u> = -	1.	CONCRETE SHALL HAVE A MINIMUM 28 DAY COMPRESSIVE STRENGTH OF f'c=4000 PSI. ALL CONCRETE SHALL HAVE 5% ± 1% ENTRAINED AIR.
۷	R		. ⊿ . 2" (△ CLR.	<u>.</u>	<u> </u>			2.	ALL REINFORCING SHALL BE ASTM A-615 GRADE 60.
	3" CLR.			16'	'Ø		1		4.	AND EXISTING BUILDING FOUNDATIONS. COORDINATE INSTALLATION WITH OWNER.
		_	- 、 /	. —	1 A			. –	•	

TERATIONS - BURGER DESIGNED:

I hereby certify that these documents were

prepared or approved by me, and that I am duly licensed professional engineer under the


License # _____ Expiration Date: __/__/20

laws of the State of Maryland.


DESIGNED.	10
DRAWN:	CG
CHECKED:	MWS
SCALE:	AS NOTED
DATE:	01/29/2021
PROJECT:	2018.0375.04.0
DRAWING:	

S301

PERMIT SUBMISSION 01-29-2021

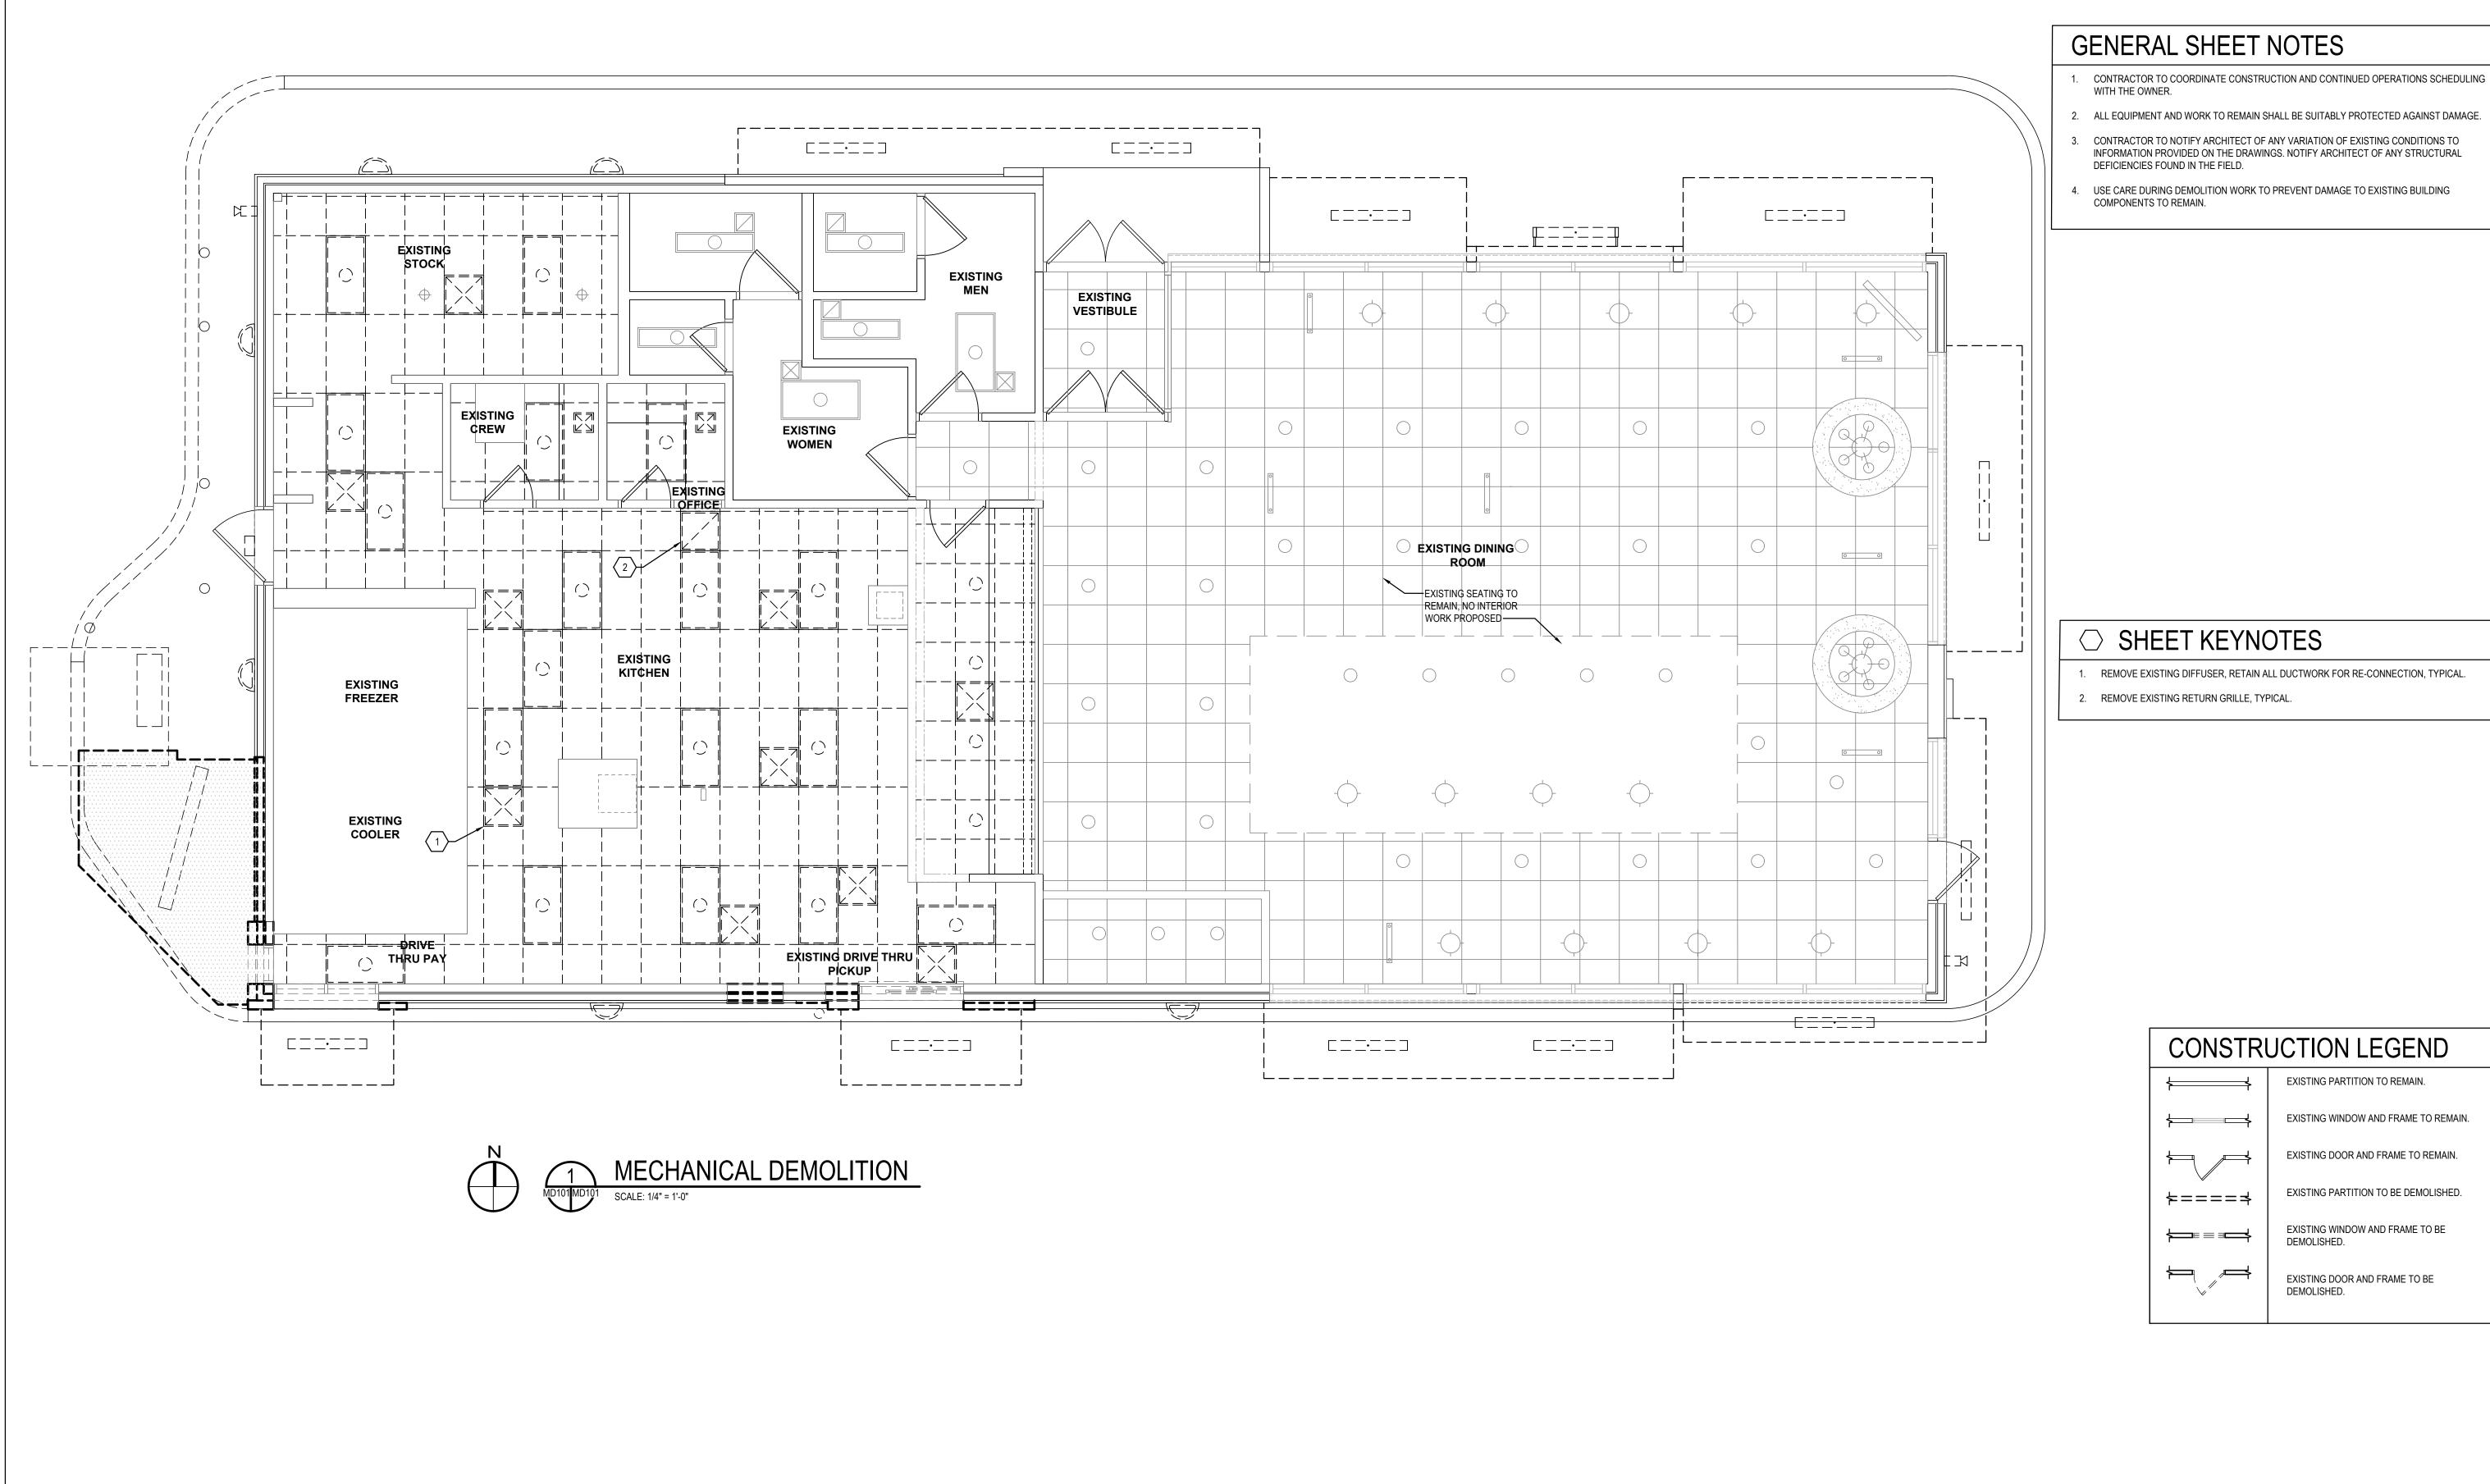


- 3. CONTRACTOR TO NOTIFY ARCHITECT OF ANY VARIATION OF EXISTING CONDITIONS TO INFORMATION PROVIDED ON THE DRAWINGS. NOTIFY ARCHITECT OF ANY STRUCTURAL
- 4. USE CARE DURING DEMOLITION WORK TO PREVENT DAMAGE TO EXISTING BUILDING

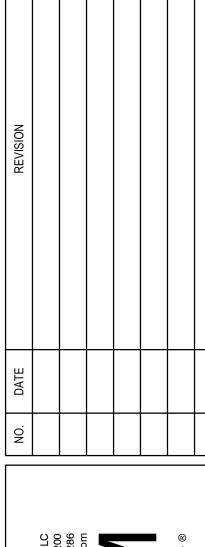

○ SHEET KEYNOTES

- 1. REMOVE EXISTING DIFFUSER, RETAIN ALL DUCTWORK FOR RE-CONNECTION, TYPICAL.

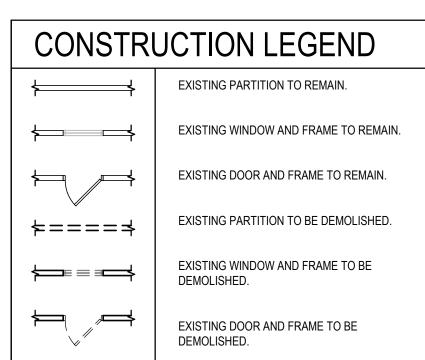

CAUTION: IF THIS DRAWING IS A REDUCTION,

USE THE GRAPHIC SCALES.

I hereby certify that these documents were prepared or approved by me, and that I am a duly licensed professional engineer under the laws of the State of Maryland.

License # 45531 Expiration Date: 06/03/2022


MECHANICAL DEMOLITION TERATIONS - BURGER KING


DESIGNED: SWC LHD CHECKED: JWA SCALE: AS NOTED DATE: 04/12/2021 PROJECT: 2018.0375.04.0

> DRAWING: MD101

04-21-2021 BID SET SUBMISSION

P:\2021\21002 - Burger King Emorton Road\09-Drawings\CAD Drawings\Mech\21002 - MD101 - Mechanical Demolition.dwg

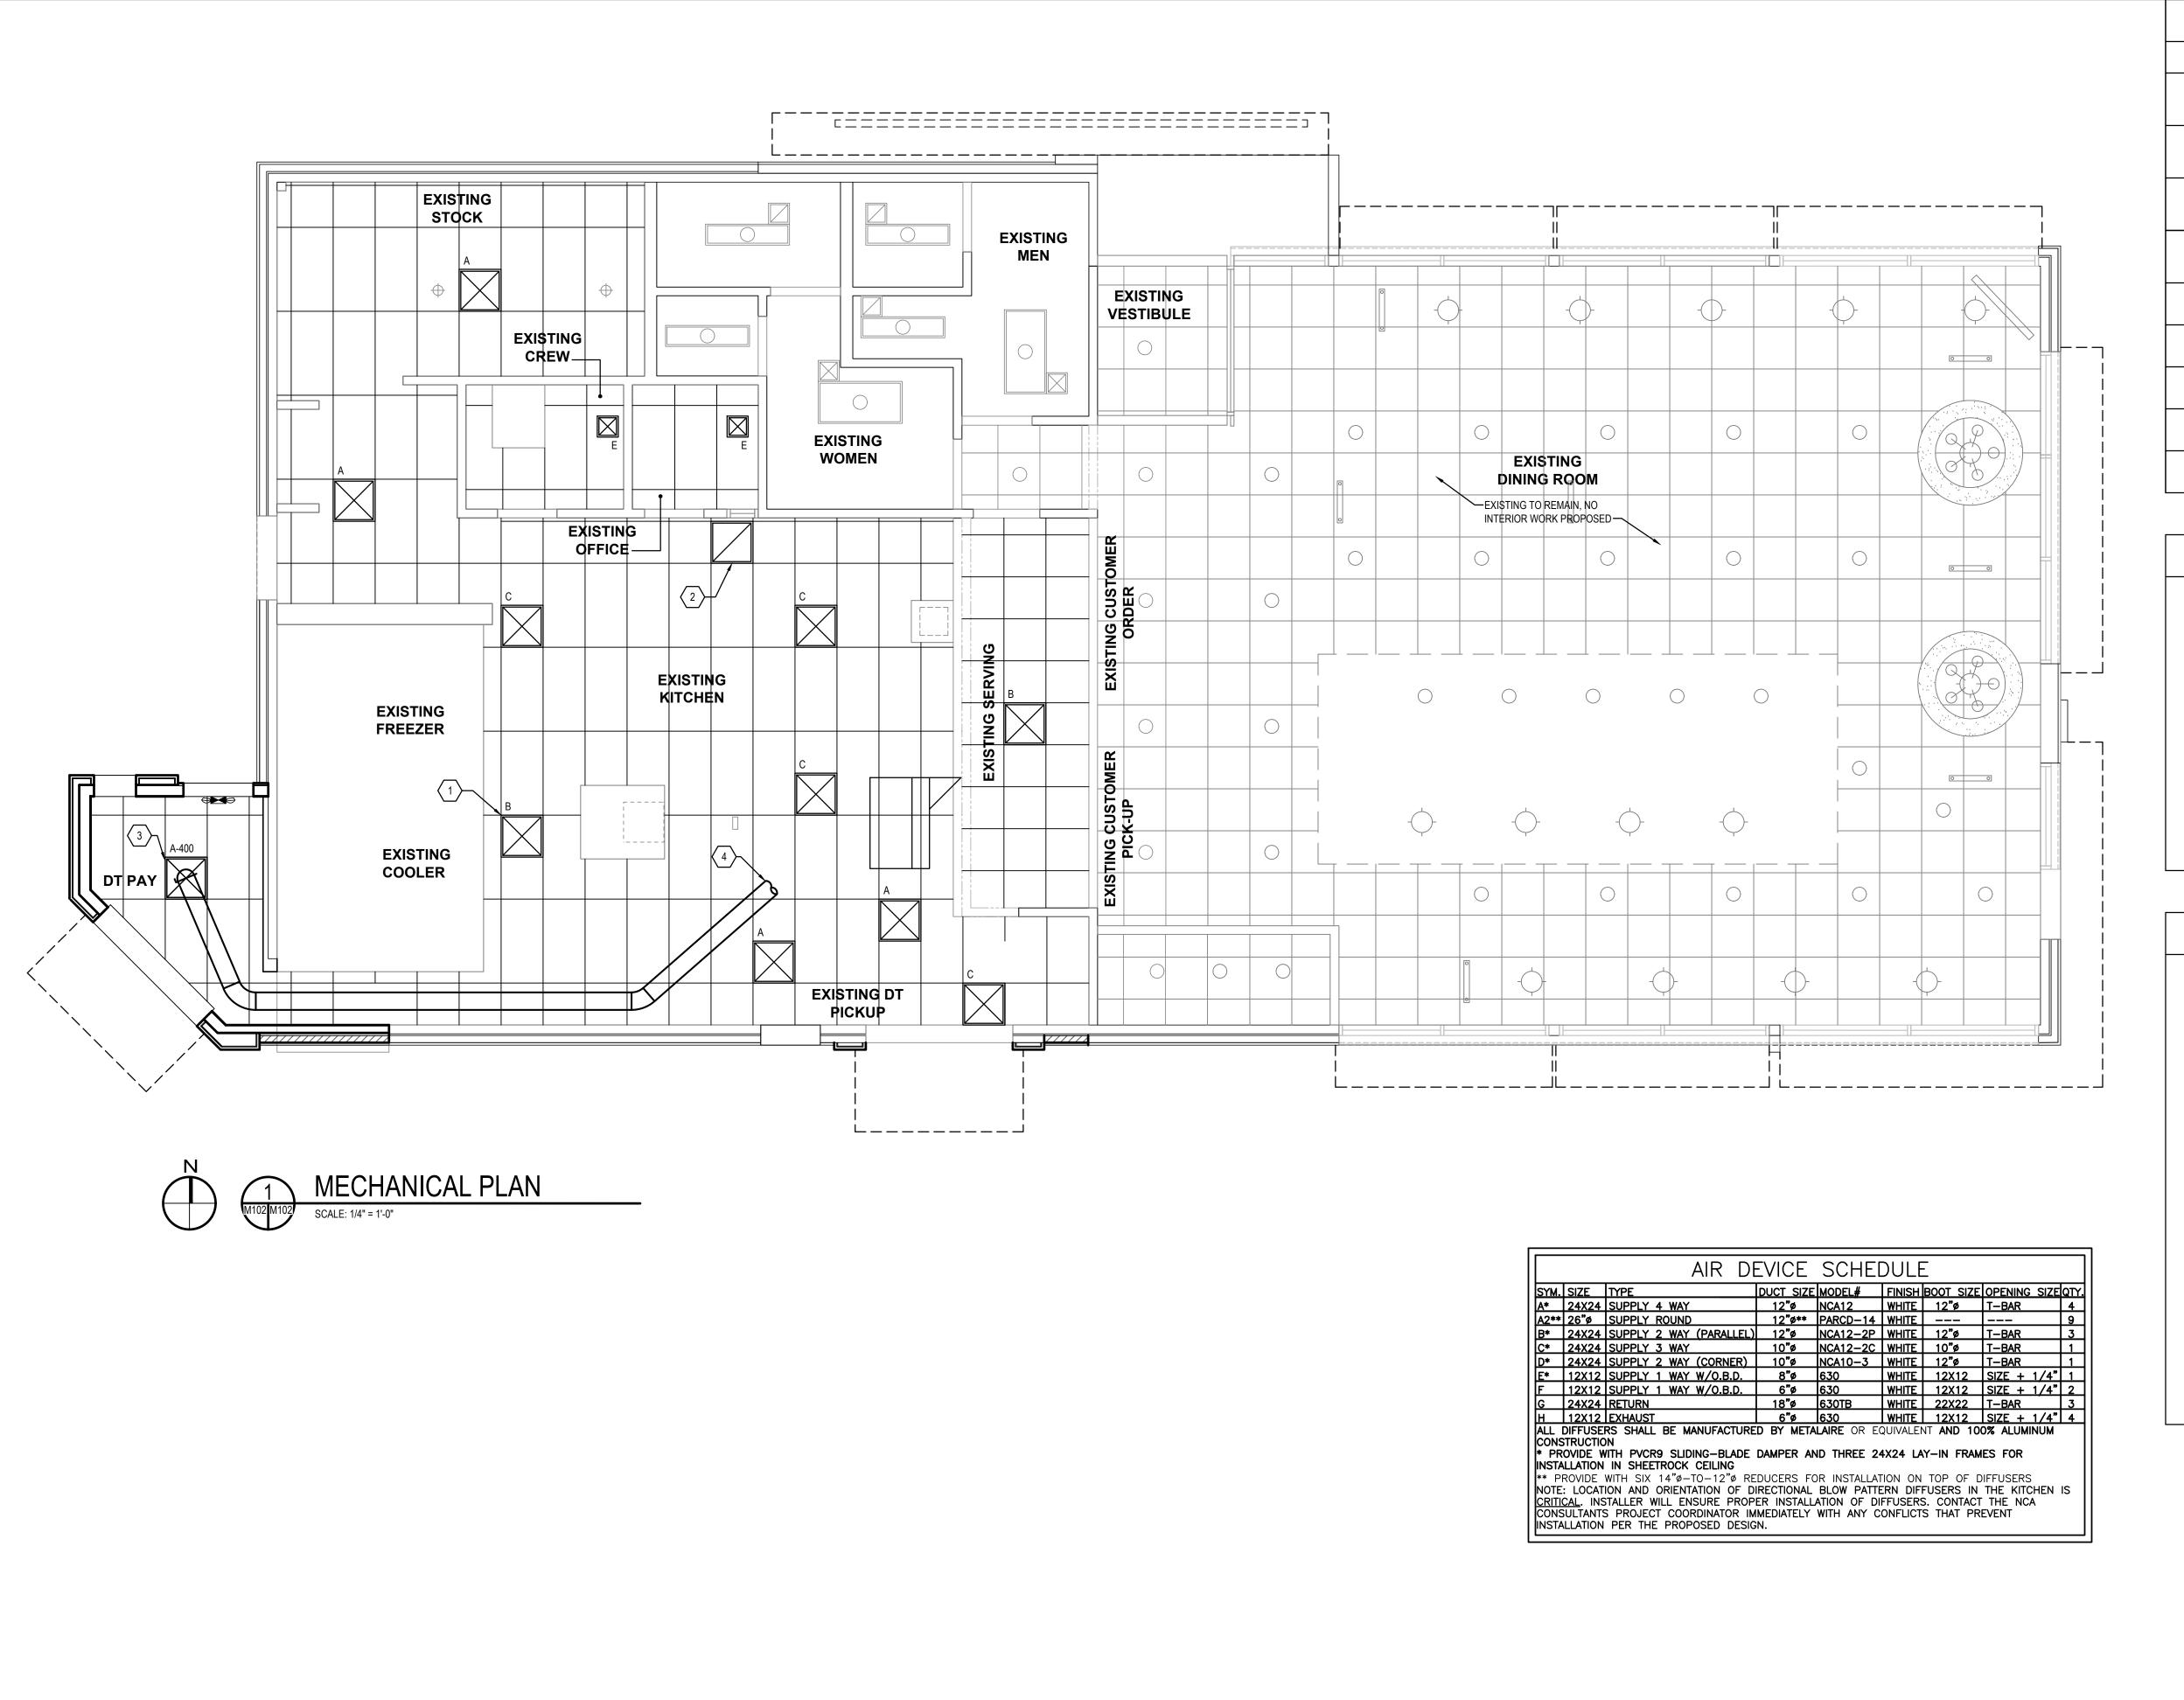

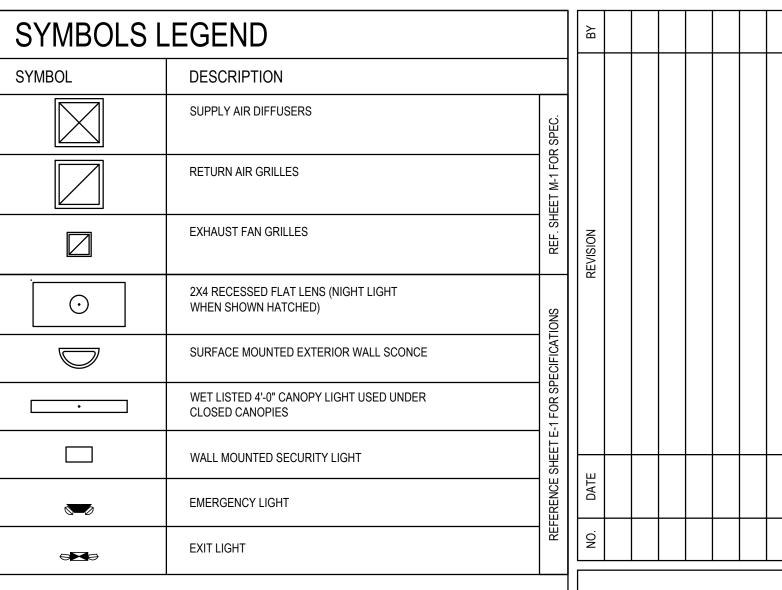

CONTRACTOR SHALL TAKE NOTE OF EXISTING THROW PATTERN OF DIFFUSERS PRIOR TO DEMOLITION AND REPLACEMENT DIFFUSER SHALL MATCH EXISTING PATTERN AND ORIENTATION.



○ SHEET KEYNOTES

- 1. PROVIDE NEW DIFFUSER, TYPICAL. MATCH EXISTING AIR DISTRIBUTION PATTERN.
- 2. PROVIDE NEW RETURN GRILLE, TYPICAL.
- 3. PROVIDE NEW DIFFUSER AT LISTED CFM.
- 4. PROVIDE 10"Ø FLEX DUCT TO EXISTING SUPPLY PLENUM BOX IN APPROXIMATELY LOCATION.

I hereby certify that these documents were prepared or approved by me, and that I am a duly licensed professional engineer under the laws of the State of Maryland.

License # 45531 Expiration Date: 06/03/2022

- BURGER KIN **TIONS**

DESIGNED: SWC DRAWN: LHD CHECKED: JWA SCALE: AS NOTED DATE: 04/12/2021

2018.0375.04.0 PROJECT: DRAWING:


M102

IF THIS DRAWING IS A REDUCTION, USE THE GRAPHIC SCALES.

CAUTION:

04-21-2021 BID SET SUBMISSION

P:\2021\21002 - Burger King Emorton Road\09-Drawings\CAD Drawings\Mech\21002 - M102 - Mechanical Plan.dwg

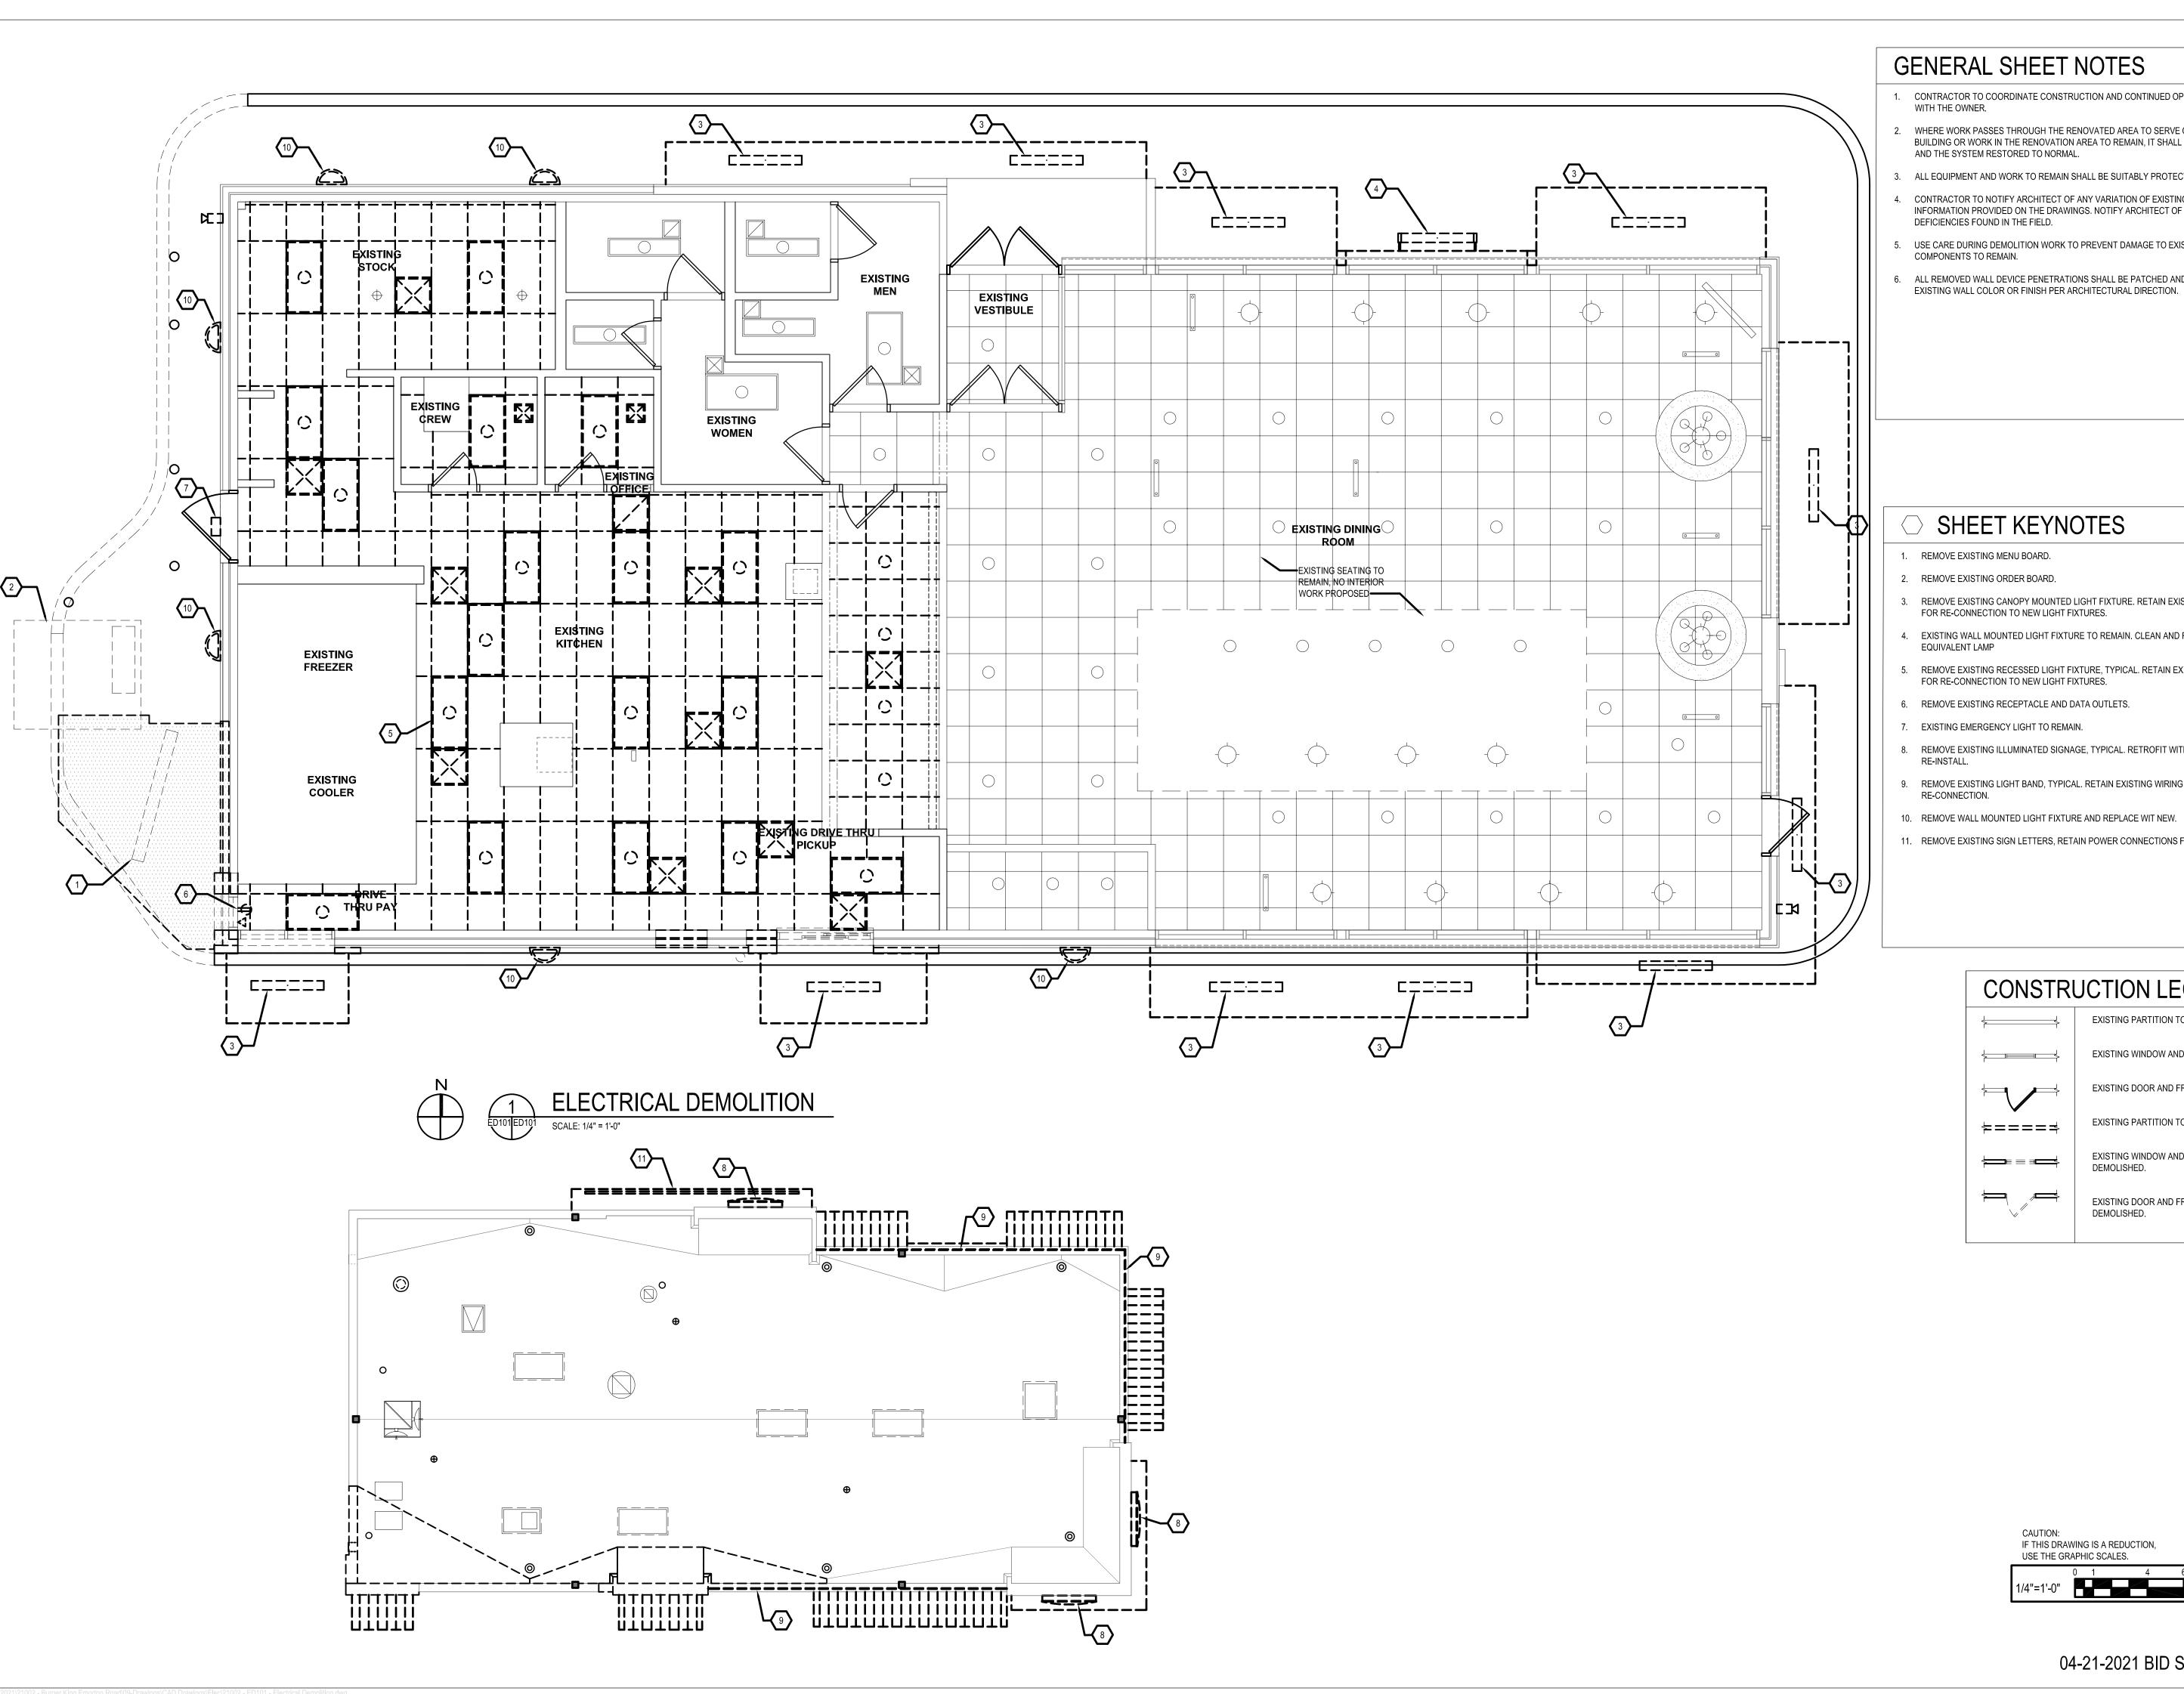

- 1. CONTRACTOR TO COORDINATE CONSTRUCTION AND CONTINUED OPERATIONS SCHEDULING
- WHERE WORK PASSES THROUGH THE RENOVATED AREA TO SERVE OTHER PORTIONS OF THE BUILDING OR WORK IN THE RENOVATION AREA TO REMAIN, IT SHALL BE SUITABLY RELOCATED
- ALL EQUIPMENT AND WORK TO REMAIN SHALL BE SUITABLY PROTECTED AGAINST DAMAGE.
- CONTRACTOR TO NOTIFY ARCHITECT OF ANY VARIATION OF EXISTING CONDITIONS TO INFORMATION PROVIDED ON THE DRAWINGS. NOTIFY ARCHITECT OF ANY STRUCTURAL DEFICIENCIES FOUND IN THE FIELD.
- 5. USE CARE DURING DEMOLITION WORK TO PREVENT DAMAGE TO EXISTING BUILDING
- ALL REMOVED WALL DEVICE PENETRATIONS SHALL BE PATCHED AND PAINTED TO MATCH

SHEET KEYNOTES

- 1. REMOVE EXISTING MENU BOARD.
- REMOVE EXISTING ORDER BOARD.
- 3. REMOVE EXISTING CANOPY MOUNTED LIGHT FIXTURE. RETAIN EXISTING WIRING AND CONDUIT FOR RE-CONNECTION TO NEW LIGHT FIXTURES.
- 4. EXISTING WALL MOUNTED LIGHT FIXTURE TO REMAIN. CLEAN AND RE-LAMP FIXTURE WITH LED
- 5. REMOVE EXISTING RECESSED LIGHT FIXTURE, TYPICAL. RETAIN EXISTING WIRING AND CONDUIT FOR RE-CONNECTION TO NEW LIGHT FIXTURES.
- 6. REMOVE EXISTING RECEPTACLE AND DATA OUTLETS.
- 8. REMOVE EXISTING ILLUMINATED SIGNAGE, TYPICAL. RETROFIT WITH LED SOURCE AND
- 9. REMOVE EXISTING LIGHT BAND, TYPICAL. RETAIN EXISTING WIRING AND CONDUIT FOR
- 10. REMOVE WALL MOUNTED LIGHT FIXTURE AND REPLACE WIT NEW.
- 11. REMOVE EXISTING SIGN LETTERS, RETAIN POWER CONNECTIONS FOR RECONNECTION.

CONSTRUCTION LEGEND

EXISTING PARTITION TO REMAIN. EXISTING WINDOW AND FRAME TO REMAIN. **——** EXISTING DOOR AND FRAME TO REMAIN. EXISTING PARTITION TO BE DEMOLISHED. **\$====** EXISTING WINDOW AND FRAME TO BE DEMOLISHED.

EXISTING DOOR AND FRAME TO BE DEMOLISHED.

CAUTION: IF THIS DRAWING IS A REDUCTION, USE THE GRAPHIC SCALES.

04-21-2021 BID SET SUBMISSION

ED101

LHD

JWA

AS NOTED

04/12/2021

2018.0375.04.0

DESIGNED: SWC

DRAWN:

SCALE:

DATE:

CHECKED:

PROJECT:

I hereby certify that these documents were

prepared or approved by me, and that I am a duly licensed professional engineer under the

License # 45531 Expiration Date: 06/03/2022

laws of the State of Maryland.

ELECTRICAL DEMOLITION

WBCM 2018

		Interior Lighting Finishes	Sun	plier	Inst	aller	BK	
tem	Description	Finish		Others		Others		Notes
_1A	Accent	Supplier: Nautical Furnishings		X		X		Contact: 954.771.1100
_ 1/ (Pendant	Part #: SP30S-18-60D-927-03 (BK304)		^		^	Α	Rep: Michael Hoglund
	Lighting	Finish: Cast Aluminum w/ Orange Acce	nt				^	itep. Michael Flogiana
	(center tables)	Lamp: Edison, LED, 10W 2700K	in.					Install bottom of pendant 6'-6" AFF
L1B	Accent	Supplier: Nautical Furnishings		Х		X		Contact: 954.771.1100
LID	Pendant	Part #: BK305		_ ^		^	В	
		Finish: Antique Bronze w/ Cage					В	Rep: Michael Hoglund
	Lighting							
	(community	Lamp: Edison LED 8W 2700K or						Beforts plane for installation heights
140	tables)	Clear Antique Style LED, 6W 2700K		\ \ \ \ \ \ \ \ \ \ \ \ \ \ \ \ \ \ \		- V		Refer to plans for installation heights
L1C	White	Item: 4" Dia White Recessed Downlight		Х		X	0.4	Contact: 615.843.3379
	Can Light	Part #: Juno, SP36671-WHTRM						Rep: Wyatt Culver, Hermitage Light
	(placed in	Size: 4" Downlight					at GWB	Email: wyattc@hlg.co
	drywall soffits)	Trim: White						
		Lamp: 15 Watt, 3000K						
L1D	Black	Item: 4" Dia Black Recessed Downlight		Х		X		Contact: 615.843.3379
	Can Light	<i>Part</i> #: SP36671-BLTRM						Rep: Wyatt Culver, Hermitage Light
	(used with	Size: 4" Downlight					at ACT	Em ail: wyattc@hlg.co
	ceiling tile	Trim: Black						
	only)							
L1E	White	Item: 4" D White Recessed Wallwasher		X		X		Contact: 615.843.3379
	Wallwasher	Part #: Juno, SP36671G2					D4w	Rep: Wyatt Culver, Hermitage Light.
	(placed in	Size: 4" Wallwasher					at GWB	Email: wyattc@hlg.co
	soffits to	Trim: # 39, White						
	highlight walls)	Lamp: 12.5 Watt, 3000K						
L1F	Black	Item: 4" D Black Recessed Wallwasher	•	Х		Х		Contact: 615.843.3379
		Part #: SP36671G2/39C BL RFD44875		^			D4b	Rep: Wyatt Culver, Hermitage Light.
	(used with	Size: 4" Wallwasher						Email: wyattc@hlg.co
	ceiling tile	Trim: Black					ut Ao I	Linuii. Wyddio@riig.oo
	only)	Lamp: 12.5 Watt, 3000K						
L1G	Track	Not Applicable	-	 				
	Lighting	HOLAPPHOUSIC						
	(to accent							
	wall shelves							
	in lounge)							
L1H		Not Applicable						
ЦПП		NOT Аррисарте						
	Area							
	Lighting							
	(open truss							
	only)							245.040.0070
L1I	Accent	Item: 2" Dia White Recessed Downlight		X		X		Contact: 615.843.3379
	Trellis	<i>Part</i> #: Juno, SP34378B-9-F1-SN					G	Rep: Wyatt Culver, Hermitage Light
	Lighting	Size: 2"W x 4-1/8" H						Email: wyattc@hlg.co
		Trim: Satin Nickel						
		Lamp: 10 Watt, 3000K						Cut Hole Size: 2-5/8" D
L1J	Accent	Item: 2"D White Recessed Wallwasher		X		X		Contact: 615.843.3379
	Trellis	Part #: Juno, SP34378A-930-F1-SN					G1	Rep: Wyatt Culver, Hermitage Light
	Lighting	Size: 2"W x 4-1/8" H						Email: wyattc@hlg.co
	(Adjustable)	Trim: Satin Nickel						
		Lamp: 10 Watt, 3000K						Cut Hole Size: 2-5/8" D
		•						
L1K	Sconce	Not Applicable						
	Light							
	(optional)							
Additi	onal supplier(s)	available per BK Light Fixture Schedu	ile Avai	lable at	design	withbk.c	om	<u></u>
	(-)	, , , , , , , , , , , , , , , , , , , ,			3.1			
Specif	ications are for	REFERENCE ONLY and are current fr	om the	date of	the las	t revisio	n. See	architecturals for undated
		MIV VMIIVIII II						

			BURGER KING 20/20	GARDEN GR	ILL EXTERIOR	₹			
			EXTERIOR LIGH			•			
			ALL REMODELS	& NEW CONSTRU	CTION				
11/7/2017									
TYPE		VENDOR	CATALOG No.	WATTAGE	COLOR TEMP.	REMARKS			
		CREE				RECESSED SOFFIT LIGHT			
K (NEW	1	SECURITY	851/852-60-U-WH	42	5000				
CONST.)	8	LSI	XSPS S LED SS CW 120 GWT DFL	43	5000				
		VAOPTO				1			
		CREE				1. FOR REMODELS ONLY			
К		SECURITY	851/852-60-U-WH	42	5000	2. RECESSED SOFFIT LIGHT			
(REMODELS)	0	LSI	XSPS S LED SS CW 120 GWT DFL	43	5000	1			
		VAOPTO							
		CREE	RS-30WLED-DO-5V-120-5300K	30	5300	1, OPTIONAL CLOSED CANOPY FIXTURE			
		SECURITY	RWSC30LED-WD-PS-MT	30	5000	2. PROVIDED BY SIGN SUPPLIER WITH CANOPY			
L		LSI	WP35LF3X9U57KMSV	12	5700				
(DOWN ONLY)		KONTECH	KON-40-WS	40	5000				
		VAOPTO	VO-WS-DW40D	40	5000				
		ENERGYWISE	EWKON-40-WS	40	5000]			
		CREE	RS-42WLED-UD-SV-120-5300K	30	5300	1. EXTERIOR WALL FIXTURE			
		SECURITY	RWSC30LED-UD-PS-MT	30	5000	2. OPEN CANOPY FIXTURE 3. PROVIDED BY SIGN SUPPLIER WITH CANOPY			
L		L\$I	WP36LF13X9U57KMSV	12 UP / 12 DOWN	5700	OT ITO A POLICE DE CHOIT CONTENT AND THE CHIEF I			
(UP/DOWN)		KONTECH	KON-60-WS-DU	60	5000				
		VAOPTO	VO-WS-DW60UD	60	5000				
		ENERGYWISE	EWKON-60-WS-DU	60	5000				
	-	KONTECH	KON-DVP-182-14-JY	40	5000	1. TO BE USED AT AWNINGS			
M		VAOPTO	VO-RP-40DW277-4	40	5000	2. OPTIONAL CLOSED CANOPY FIXTURE 3. PROVIDED BY SIGN SUPPLIER WITH AWNING/CANOPY			
						7,7			
		CREE	E.WP1X031Z7	27	4000	1. WALL MOUNTED SECURITY LIGHT			
		SECURITY	WGH-1LU-M	41	5000	2. BRONZE FINISH			
N		LSI	SFCMWBLEDPL150UEBRZ	33	5000				
		VAOPTO	VO-WP-DW-N50	50	5000				
		ENERGYWISE	EWALED-WPDS240	40	5000				
	1	CREE	LFL-A-(3,4,6,8)-DO-UL-BZ-53K-EA	3'-26 / 4'-35 6'-52 / 8'-70	5300	1. CONTINUOUS ARCHON TOWER LIGHTING			
	THE STATE OF	SECURITY	HIRAF-HE-LED(96,72, 48,36)DO-120-DB	8.5 / FT.	5200	2, DOWNLIGHT ONLY			
0				,		3. TO BE PLACED AT TOP OF ARCHON TOWER			
	T					4. TO BE BRONZE FINISH			
		CREE	LFL-A-{3,4}-UO-UL-BZ-53K	3'-18 / 4'-23	5300	1. CONTINUOUS ARCHON TOWER LIGHTING			
_	The state of the s	SECURITY	HIRAF-HE-LED(48,36)UO-120-DB	50	5200	2. UPLIGHT ONLY			
P			, , ,	†		3. TO BE PLACED ABOVE ARCHON TOWER CANOPY			
				1		4. TO BE BRONZE FINISH			
		CREE	OSQ-A-DA AA-X-T-57K-UL-COLOR	166	5700	1. FINISH TO BE BLACK, BRONZE OR SILVER			
		SECURITY	VP-L-80NB-180-5K-T4-UNV-RA-COLOR	180	5000				
POLE	Anthon	LSI	XLCMFTLEDHOCWUE-COLOR	276	5104	1			
		VAOPTO	VO-SL-NW-A56	120	5000	1			
		ENERGYWISE	EWEC724M2	209	5000	1			
		TAPICAL NAIRE	6 44 6 6 7 E 7 E 7 E	203	2000				
			CONTACT	INFORMATIO	N				
	CREE		HERMITAGE "MASTER CONSOLIDATOR"	1	GYWISE	KONTECHUSA			
9	TEVE FRIEDN	/AN	WYATT CULVER	· · · · · · · · · · · · · · · · · · ·	R WADDICK	MIGUEL MARTINEZ			
	847-830-14		615-843-3379		25-1336	866-236-8701			
steve			wyatt@hlg.co		rgywisemail.com				
	CURITY LIGH		y an imparim		Opto	DAVE VAN DER BEEK			
	ERIC HILLESLA				E RAMOS				
	620 626 Q46				17.5789	727-919-1816			

ONLY)		KONTECH	KON-40-WS	40	5000								
0,		VAOPTO	VO-WS-DW40D	40	5000				JUNO	SP36671-WHTRM	15	3000	1. 4" DIAMETER, WHITE, RECESSED DOWN
		ENERGYWISE	EWKON-40-WS	40	5000			Sellin -	CREE	CR4-575L-27K-12-E26	9.5	2700	2. TO BE USED WITH GWB CEILING
		CREE	RS-42WLED-UD-SV-120-5300K	30	5300	1. EXTERIOR WALL FIXTURE	C4w						-
		SECURITY	RWSC30LED-UD-PS-MT	30	5000	2. OPEN CANOPY FIXTURE 3. PROVIDED BY SIGN SUPPLIER WITH CANOPY			ENERGYWISE	EWMLEDDL4IN	11	2700	_
L		L\$I	WP36LF13X9U57KMSV	12 UP / 12 DOWN	5700				SECURITY	LB4A 6L 30K 9 WH / IBXQL	9	3000	
(UP/DOWN)		KONTECH	KON-60-WS-DU	60	5000		C4b		JUNO	SP36671-BLTRM			1. 4" DIAMETER, BLACK, RECESSED DOWN
		VAOPTO	VO-WS-DW60UD	60	5000	_	C45		CREE	CR4-575L-27K-12-E26-MODBLK	9.5	2700	TO BE USED WITH ACOUSTICAL CEILING TIL
		ENERGYWISE KONTECH	EWKON-60-WS-DU KON-DVP-182-14-JY	60 40	5000 5000	1. TO BE USED AT AWNINGS			JUNO	SP36671G2 / 39 WWH	12.5	3000	1. 4" DIAMETER, WHITE, RECESSED DOWN
М		VAOPTO	VO-RP-40DW277-4	40	5000	2. OPTIONAL CLOSED CANOPY FIXTURE	D4w		SECURITY	LBE4A 6L 30K 9 WH / IBXQL	g	3000	WALL WASHER
		773113	9 W 111 TOD 43 2 7 7 T		3500	3. PROVIDED BY SIGN SUPPLIER WITH AWNING/CANOPY							2. TO BE USED WITH GWB CEILING
		CREE	E.WP1X031Z7	27	4000	1. WALL MOUNTED SECURITY LIGHT			IUNO	CD2CC74C2 / 20C BL DED4407F	12.5	3000	1. 4" DIAMETER, BLACK, RECESSED DOWN
		SECURITY	WGH-1LU-M	41	5000	2. BRONZE FINISH			JUNO	SP36671G2 / 39C BL RFD44875	12.5	3000	WALL WASHER
N		LSI	SFCMWBLEDPL150UEBRZ	33	5000		D4b						2. TO BE USED WITH ACOUSTICAL CEILING
		VAOPTO	VO-WP-DW-N50	50	5000								
		ENERGYWISE	EWALED-WPDS240	40	5000				JUNO	R600L3KNBZ	10	2700	TRACK LIGHT
	WX O	CREE	LFL-A-(3,4,6,8)-DO-UL-BZ-53K-EA	3'-26 / 4'-35 6'-52 / 8'-70	5300	1, CONTINUOUS ARCHON TOWER LIGHTING	E						
0	FIE S	SECURITY	HIRAF-HE-LED(96,72, 48,36)DO-120-DB	8.5 / FT.	5200	2. DOWNLIGHT ONLY							
	1					3. TO BE PLACED AT TOP OF ARCHON TOWER			JUNO	SP34378B-9-F1-SSN	10	3000	2" DIAMETER DOWN LIGHT, SATIN NICKEL
						4. TO BE BRONZE FINISH	G		ZANIBONI	D2LUNA20930A3CSNP0BK0P	9	3000	_
		CREE	LFL-A-(3,4)-UO-UL-BZ-53K	3'-18 / 4'-23	5300	1. CONTINUOUS ARCHON TOWER LIGHTING	3		ZANIBONI	DZLUNAZUSSUASCSNIPUBRUP	•	3000	-
Р	No.	SECURITY	HIRAF-HE-LED(48,36)UO-120-DB	50	5200	2. UPLIGHT ONLY							
						3. TO BE PLACED ABOVE ARCHON TOWER CANOPY			JUNO	SP34378A-930-F1-SN	10	3000	2" DIAMETER WALL WASHER, SATIN NICKE
						4. TO BE BRONZE FINISH	G1	3	ZANIBONI	D2LUN2O0930A3C5NP0BK0D	9	3000	
		CREE	OSQ-A-DA AA-X-T-57K-UL-COLOR	166	5700	1. FINISH TO BE BLACK, BRONZE OR SILVER							
POLE	Application of the same of the	SECURITY	VP-L-80NB-180-5K-T4-UNV-RA-COLOR	180 276	5000 5104	_			CREE	CL-E-TFA04A-24R-40N	42	4000	1. TO BE USED IN KITCHEN
POLE		VAOPTO	XLCMFTLEDHOCWUE-COLOR VO-SL-NW-A56	120	5000	_			SECURITY	LJT24-40-MLG-FSA-12-EU-C388	45	4000	2. 2x4 RECESSED
		ENERGYWISE	EWEC724M2	209	5000	_	ı		LSI	SFP24 LED 50 UE DIM 40	50	4000	-
		LIVERGITVISE	C05CC7 2-71912	203	5000				VAOPTO	VO-PL-2NW4-50	60	4100	_
			CONTACT	INFORMATION	<u> </u>								_
	CREE		HERMITAGE "MASTER CONSOLIDATOR"		GYWISE	KONTECHUSA		+	ENERGYWISE	EWMLFP24EP4841	48	4100	
	STEVE FRIEDI	MAN	WYATT CULVER	JENNIFER	R WADDICK	MIGUEL MARTINEZ		10.40	CREE	CL-E-TR14L2404U	42	3500	1. FOR REMODELS ONLY
	847-830-14		615-843-3379	877-23	25-1336	866-236-8701			SECURITY	LJT14-35LWG-FSA12-EDU-C388	27	3500	2. TO BE USED IN RESTROOMS
	e.friedman@		wyatt@hlg.co		gywisemail.com		1		LSI	SFP14 LED 40 UE DIM 35 FK14	40	3500	3. 1x4 RECESSED
<u> </u>	ECURITY LIGH				Opto	DAVE VAN DER BEEK			VAOPTO	VO-PL-1XWW4-50	50	3000	
	ERIC HILLESL				RAMOS 17-5789	727-919-1816 DAVIDV2009@AT⊤.NET			ENERGYWISE	EWMLFP14EP3535	35	3500	
guotatí	:630-636-84 ons@security				opto.com	DAVIDVZQQS@ATT.NET			CREE	CL-E-TFA03A-22R-40N	32	3500	1. TO BE USED IN PLAYGROUND
-	LSI				•	JIM MILES			SECURITY	LJT22-35MLG-FSA12 EU	35	3500	2. 2x2 RECESSED
	CURT GOO	DD				727-560-7985	PG		LSI	SFP22 LED 30 UE DIM 35 FK22	30	3500	Z. ZAZ REGEGGED
	404-655-84	40				JIM@FLORIDAELECTRONIC.NET			VAOPTO	VO-PL-2XWW2-36	36	3000	\dashv
curt.g	ood@lsi-indu	istries.com							ENERGYWISE			3500	_
									1	EWMLFP22EP3535	36	3500	EMERGENCY LIGHT
				NOTES					CREE	EM22RWH	11		EMENGENCI EGITI
			CHEDULE MAY BE USED ON THIS PROJECT. REFER T					STATE OF THE PARTY	SECURITY	CU2	1	3000	_
1. NOT ALL LI	SHT FIXTURES 1	TYPES SHOWN ON S	CHEDULE MAY BE USED ON THIS PROJECT. REFER 1	TO LIGHTING PLAN FOI	R PROJECT SPECIFIC 1	TYPES AND QUANTITIES.	EM	11 333	LSI	LTEMWH	(2) 1 LED		_
									VAOPTO	VO-EM	2	5000	<u> </u>
									ENERGYWISE	EWCU2	1	3000	
									CREE	EXDMBRWH	11		EXIT / EMERGENCY LIGHT
									SECURITY	CCRRC	4		
							EMX	EXIT	LSI	LPRXRUWBWHLD11R	(2) 1 LED		
								19	VAOPTO	VO-EMX-R1	2	5000	
									ENERGYWISE	EWCCR	4	3000	
											i i		
									CREE	WS4-50L-57K-10V-FD	55	5300	TO BE USED IN WALK IN BOX ONLY
								4	-	WS4-50L-57K-10V-FD LXEM4-50ML-RFA-EU		5300 5000	TO BE USED IN WALK IN BOX ONLY
							WIB		CREE SECURITY LSI		55 53 52		TO BE USED IN WALK IN BOX ONLY

c 100			BURGER KING 20/20 GARDE INTERIOR LIGHT FIXTUR			
6/2017			LOW PROFILE TE	RELLIS		
TYPE		VENDOR	CATALOG No.	WATTAGE	COLOR TEMP	REMARKS
	1	NAUTICAL	BK304 & SP30S-18-60D-927-03	10	2700	SHAKER PENDANT LAMP
Α			LED EDISON STYLE 10 WATT]
		NAUTICAL	BK305 & LED 8W EDISON INCANDESCENT	6	2700K	BRONZE CAGE PENDANT LIGHT
В			LED CLEAR ANTIQUE STYLE 6 WATT			-
	\forall					
	1	NAUTICAL	BK305 & LED 8W EDISON INCANDESCENT	6	2700K	BRONZE CAGE WALL SCONCE LIGHT
B1			LED CLEAR ANTIQUE STYLE 6 WATT			-
	$\overline{\Box}$					4 AN DIAMATTER WHITE RECESSED DOMAINING
	Miller	JUNO	SP36671-WHTRM	15	3000	1. 4" DIAMETER, WHITE, RECESSED DOWN LIG 2. TO BE USED WITH GWB CEILING
C4w		CREE	CR4-575L-27K-12-E26	9.5	2700	1
		ENERGYWISE	EWMLEDDL4IN	11	2700	-
		SECURITY	LB4A 6L 30K 9 WH / IBXQL	9	3000	1. 4" DIAMETER, BLACK, RECESSED DOWN LIG
C4b		JUNO	SP36671-BLTRM	2.5	2700	TO BE USED WITH ACOUSTICAL CEILING TILES
		CREE	CR4-575L-27K-12-E26-MODBLK	9.5	2700	1. 4" DIAMETER, WHITE, RECESSED DOWN LIG
D4w		JUNO	SP36671G2 / 39 WWH	12.5	3000	WALL WASHER
∪4W		SECURITY	LBE4A 6L 30K 9 WH / IBXQL	9	3000	2. TO BE USED WITH GWB CEILING
		JUNO	SP36671G2 / 39C BL RFD44875	12.5	3000	1. 4" DIAMETER, BLACK, RECESSED DOWN LIG
D4b		10140	95 3007 TGZ / 33C BL KFD448/3	12.3	3000	WALL WASHER
TM					1	2. TO BE USED WITH ACOUSTICAL CEILING TIL
		JUNO	R600L3KNBZ	10	2700	TRACK LIGHT
E		35110	Habbanian	10	2700	1
						1
	Calls	JUNO	SP34378B-9-F1-SSN	10	3000	2" DIAMETER DOWN LIGHT, SATIN NICKEL FIN
G		ZANIBONI	D2LUNA20930A3CSNP0BK0P	g	3000	1
						1
		JUNO	SP34378A-930-F1-SN	10	3000	2" DIAMETER WALL WASHER, SATIN NICKEL F
G1		ZANIBONI	D2LUN2O0930A3CSNP0BK0D	9	3000	1
						1
		CREE	CL-E-TFA04A-24R-40N	42	4000	1. TO BE USED IN KITCHEN
		SECURITY	LJT24-40-MLG-FSA-12-EU-C388	45	4000	2. 2x4 RECESSED
I		LSI	SFP24 LED 50 UE DIM 40	50	4000	
		VAOPTO	VO-PL-2NW4-50	60	4100	
		ENERGYWISE	EWMLFP24EP4841	48	4100	
		CREE	CL-E-TR14L2404U	42	3500	1. FOR REMODELS ONLY
		SECURITY	LJT14-35LWG-FSA12-EDU-C388	27	3500	2. TO BE USED IN RESTROOMS
J		LSI	SFP14 LED 40 UE DIM 35 FK14	40	3500	3. 1x4 RECESSED
		VAOPTO	VO-PL-1XWW4-50	50	3000	
		ENERGYWISE	EWMLFP14EP3535	35	3500	
		CREE	CL-E-TFA03A-22R-40N	32	3500	1. TO BE USED IN PLAYGROUND
		SECURITY	LJT22-35MLG-FSA12 EU	35	3500	2. 2x2 RECESSED
PG		LSI	SFP22 LED 30 UE DIM 35 FK22	30	3500	
		VAOPTO	VO-PL-2XWW2-36	36	3000	_
		ENERGYWISE	EWMLFP22EP3535	36	3500	EMERGENCY LIGHT
		CREE SECURITY	EM22RWH CU2	11	3000	- EMERGENOT EGIT
EM	11 332	LSI	LTEMWH	(2) 1 LED	3000	1
		VAOPTO	VO-EM	2	5000	1
		ENERGYWISE	EWCU2	1	3000	1
		CREE	EXDMBRWH	11		EXIT / EMERGENCY LIGHT
		SECURITY	CCRRC	4	1	1
EMX	EXIT	LSI	LPRXRUWBWHLD11R	(2) 1 LED]
	19	VAOPTO	VO-EMX-R1	2	5000	
		ENERGYWISE	EWCCR	4	3000	
		CREE	WS4-50L-57K-10V-FD	55	5300	TO BE USED IN WALK IN BOX ONLY
	1	SECURITY	LXEM4-50ML-RFA-EU	53	5000	_
WIB		LSI	EG34SLEDHOCWUE	52	5300	4
		VAOPTO	VO-TF-14W	32	5000	

	CONTACT INFORMATI	ON	
<u>CREE</u>	HERMITAGE "MASTER CONSOLIDATOR"	ENERGYWISE	JUNO / ACUITY BRANDS
STEVE FRIEDMAN	WYATT CULVER	JENNIFER WADDICK	BRETT D KINZLER
847-830-1444	615-843-3379	877-225-1336	o 847-813-8350 m 847-312-1578
steve.friedman@cree.com	wyatt@hlg.co	jennifer@energywisemail.com	brett.kinzler@acuitybrands.com
SECURITY LIGHTING	NAUTICAL FURNISHINGS	<u>VaOpto</u>	ZANIBONI LIGHTING
ERIC HILLESLAND	MICHAEL HOGLUND	ERIC DE RAMOS	JENNIFER MORRIS
630-636-8493	954-771-1100	702-517-5789	727-213-0410
quotations@securitylighting.com	mhoglund@nauticalfurnishings.com	eric@vaopto.com	southeastusa@zanibonilighting.com
LSI CUPT COOR			
CURT GOOD			
404-655-8440			
curt.good@lsi-industries.com			

NOTES 1. NOT ALL LIGHT FIXTURES TYPES SHOWN ON SCHEDULE MAY BE USED ON THIS PROJECT. REFER TO LIGHTING PLAN FOR PROJECT SPECIFIC TYPES AND QUANTITIES. 2. PENDANT FIXTURES "A" MUST BE CENTERED OVER TABLE TOPS. COORDINATE WITH DÉCOR DRAWINGS. 3. EXCEPT FOR DROPPED CEILING OPTION, ALL LIGHT FIXTURES IN DINING ROOM AREA & RESTROOM CORRIDOR ARE TO BE SUPPORTED FROM EXPOSED ROOF TRUSSES. 4. CONTRACTOR TO NOTIFY LIGHTING SUPPLIER OF THE FOLLOWING: FIXTURE TYPES "C" AND "D" WILL BE REQUIRED TO BE LENS AT THE LOCATIONS OVER THE SERVICE

AREA AND OVER THE SELF-SERVE DRINK AREA. FIXTURE TYPE "I" WILL REQUIRE A LENS OR TUBE GUARD AT THOSE LOCATIONS.

ВУ				
REVISION				
DATE				
NO.				




I hereby certify that these documents were prepared or approved by me, and that I am a duly licensed professional engineer under the laws of the State of Maryland.


License # 45531 Expiration Date: 06/03/2022

LIGHTING FIXTURE SCHEDULE

DESIGNED:	SWC	
DRAWN:	LHD	
CHECKED:	JWA	
SCALE:	AS NOTED	
DATE:	04/12/2021	
PROJECT:	2018.0375.04.0	
	DRAWN: CHECKED: SCALE: DATE:	DRAWN: LHD CHECKED: JWA SCALE: AS NOTED DATE: 04/12/2021

E101

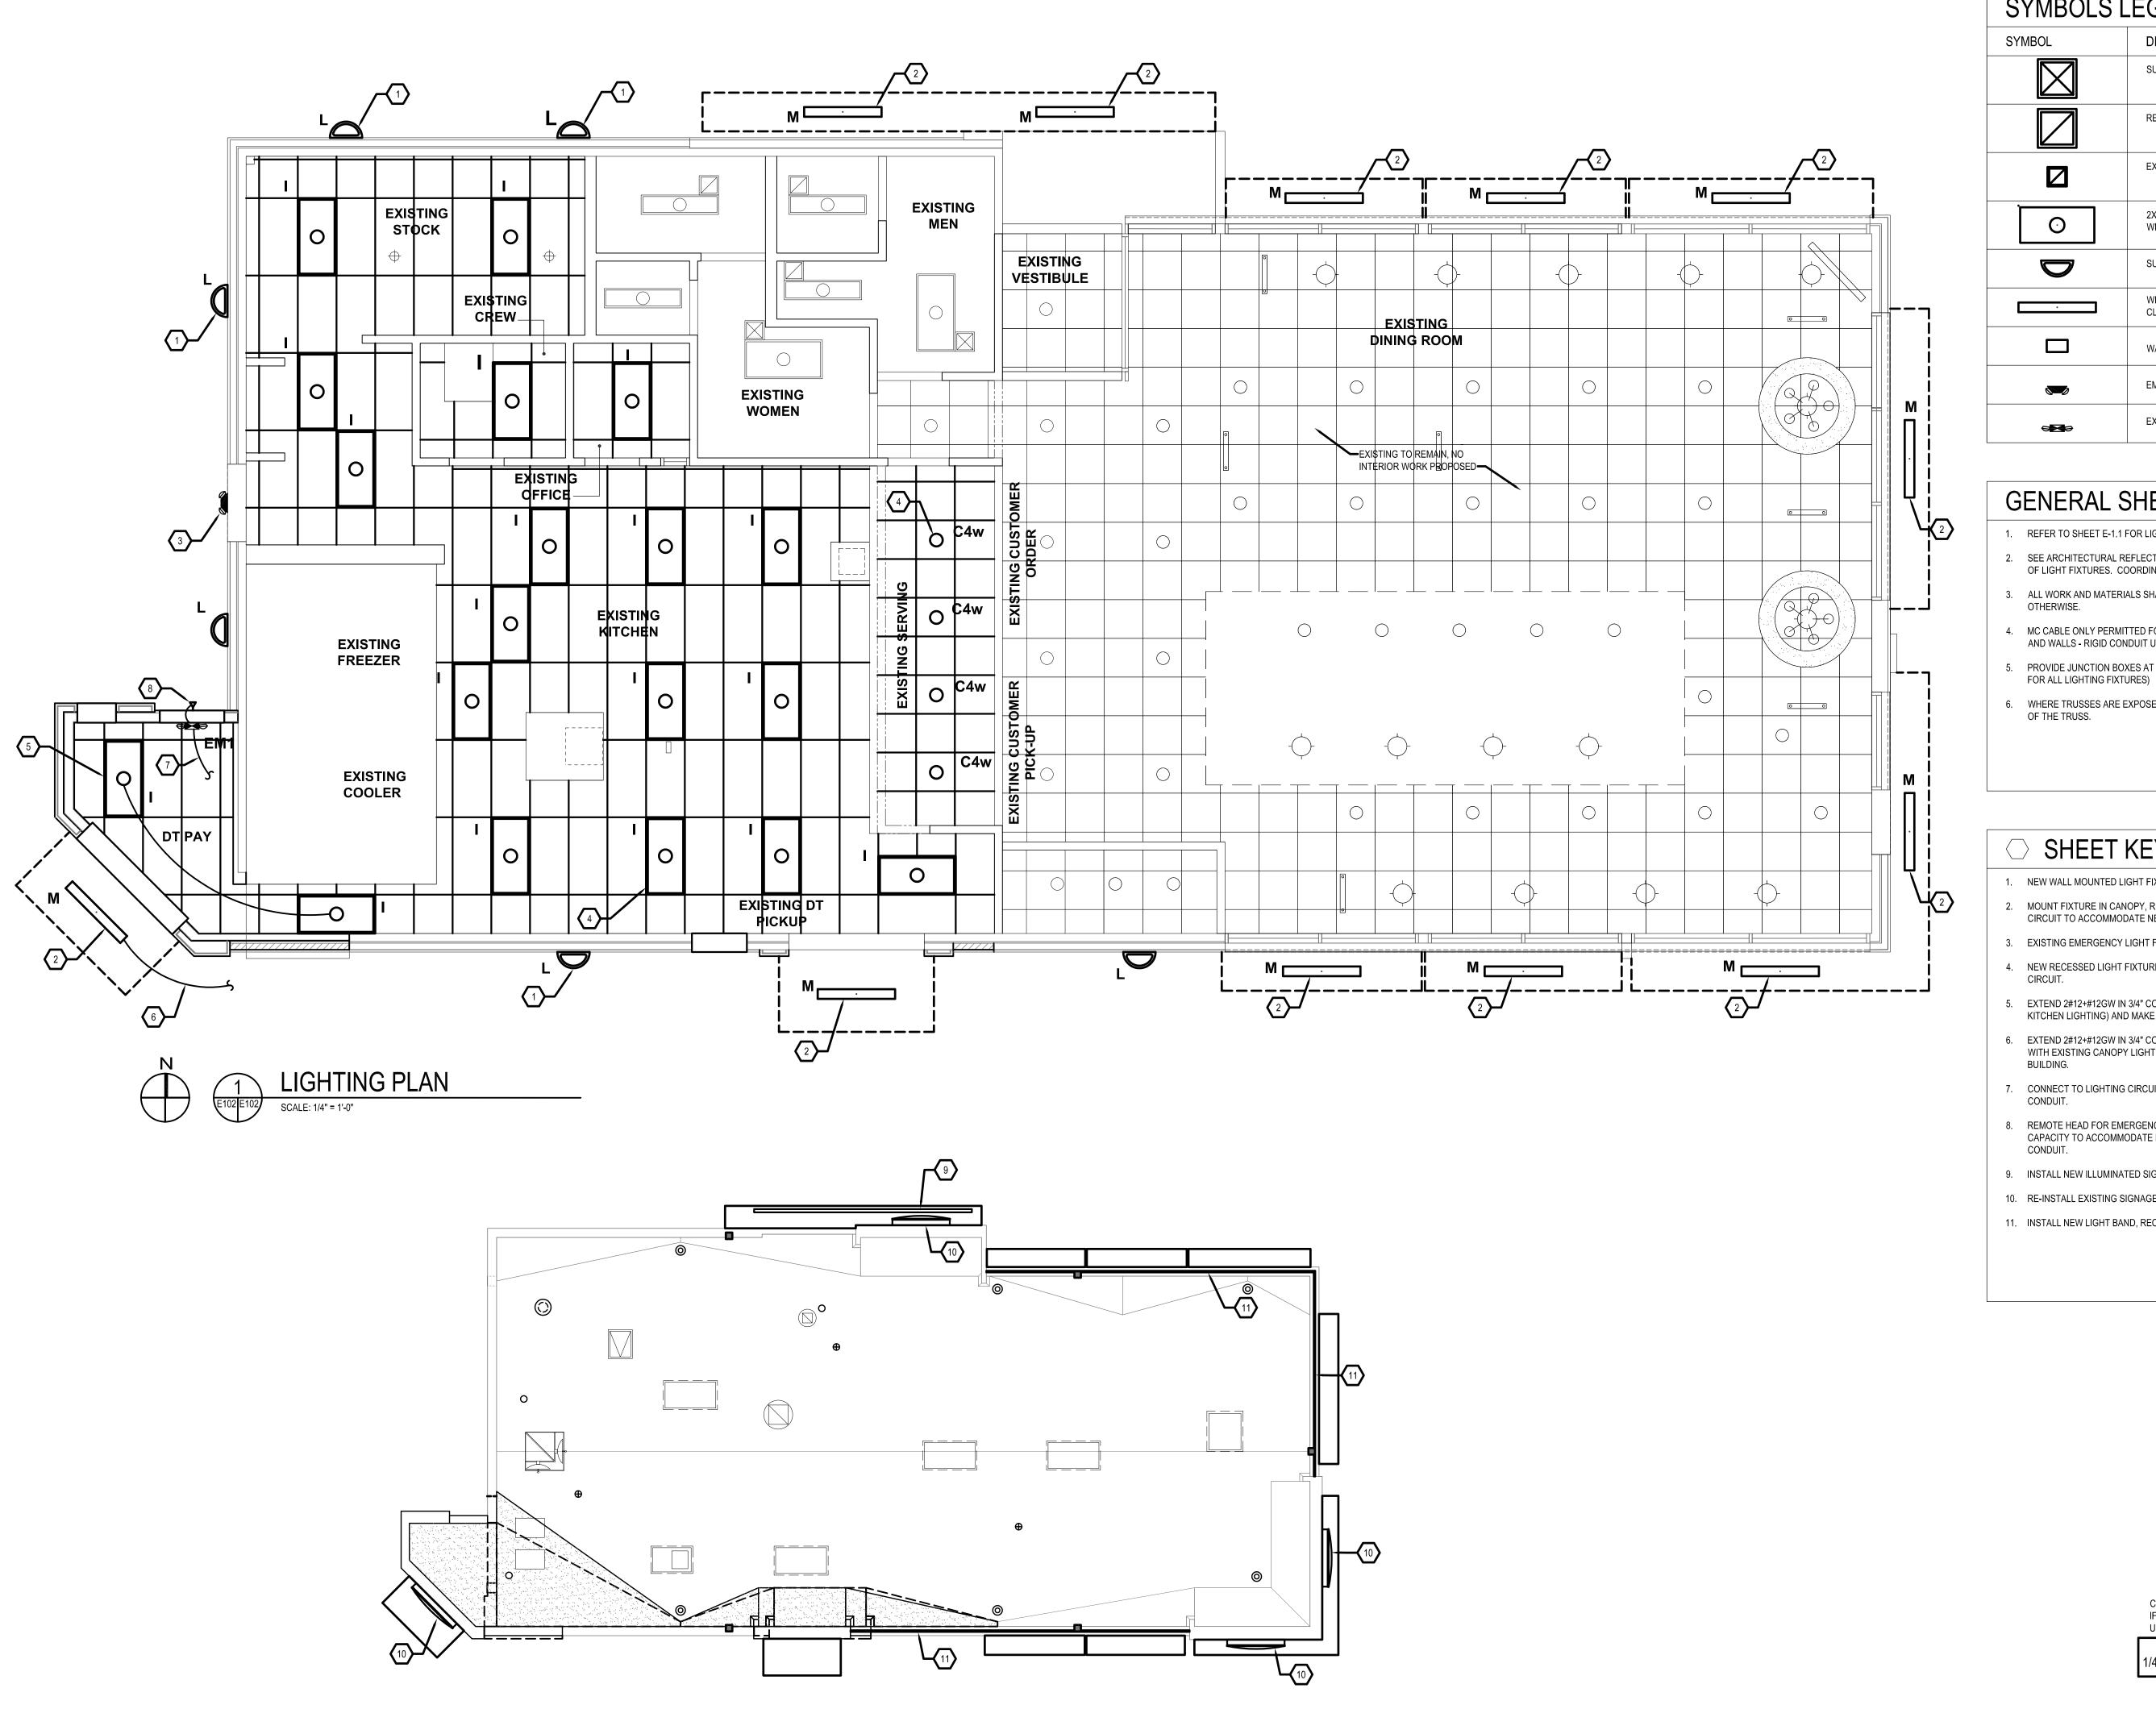

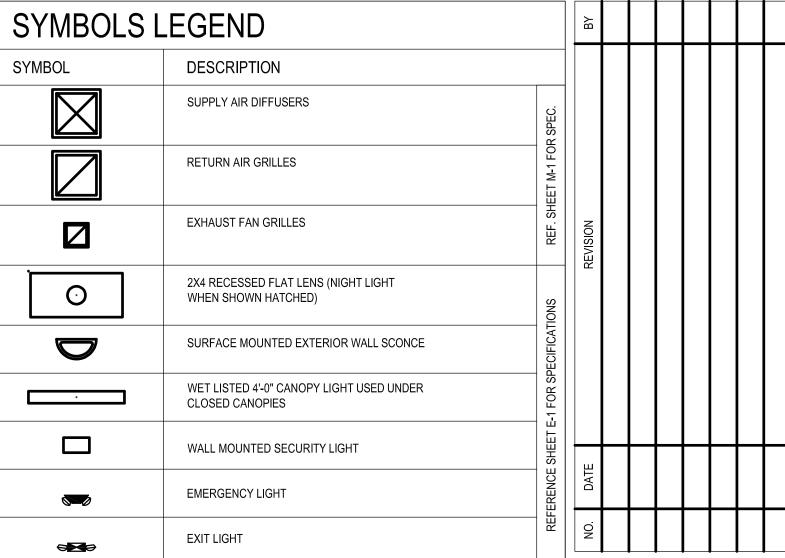

- 1. REFER TO SHEET E-1.1 FOR LIGHT FIXTURE SPECIFICATIONS
- 2. SEE ARCHITECTURAL REFLECTED CEILING PLAN FOR EXACT LOCATION AND MOUNTING HEIGHTS OF LIGHT FIXTURES. COORDINATE FIXTURE LOCATIONS WITH DECOR DRAWINGS.
- 3. ALL WORK AND MATERIALS SHALL BE BY THE ELECTRICAL CONTRACTOR UNLESS NOTED
- 4. MC CABLE ONLY PERMITTED FOR LIGHT WHIPS. ALL OTHER TO BE E.M.T CONDUIT IN CEILING AND WALLS - RIGID CONDUIT UNDER SLAB.
- 5. PROVIDE JUNCTION BOXES AT LIGHT FIXTURES PER MANUFACTURERS REQUIREMENTS. (TYPICAL
- 6. WHERE TRUSSES ARE EXPOSED, RUN ALL ELECTRICAL CONDUITS ABOVE THE BOTTOM CHORD OF THE TRUSS.

SHEET KEYNOTES

- 1. NEW WALL MOUNTED LIGHT FIXTURE, TYPICAL. RE-CONNECT TO EXISTING LIGHTING CIRCUIT.
- 2. MOUNT FIXTURE IN CANOPY, RE-CONNECT TO EXISTING CIRCUIT. EXTEND EXISTING LIGHTING CIRCUIT TO ACCOMMODATE NEW CANOPY LIGHT LOCATION.
- 3. EXISTING EMERGENCY LIGHT FIXTURE TO REMAIN.
- 4. NEW RECESSED LIGHT FIXTURE IN NEW CEILING, TYPICAL. RE-CONNECT TO EXISTING LIGHTING
- 5. EXTEND 2#12+#12GW IN 3/4" CONDUIT TO NEAREST ADJACENT FIXTURE (CONTROLLED WITH KITCHEN LIGHTING) AND MAKE ALL CONNECTIONS.
- 6. EXTEND 2#12+#12GW IN 3/4" CONDUIT TO NEAREST ADJACENT CANOPY FIXTURE (CONTROLLED WITH EXISTING CANOPY LIGHTING) AND MAKE ALL CONNECTIONS. ROUTE ALL WIRING INSIDE
- 7. CONNECT TO LIGHTING CIRCUIT IN SAME AREA AHEAD OF SWITCH LEG WITH 2#12+#12GW IN 3/4"
- 8. REMOTE HEAD FOR EMERGENCY LIGHTING, PROVIDE INDOOR UNIT WITH SUFFICIENT BATTERY CAPACITY TO ACCOMMODATE REMOTE HEAD LOAD. CONNECT WITH 2#12+#12GW IN 3/4"
- 9. INSTALL NEW ILLUMINATED SIGNAGE ON NEW CANOPY, RECONNECT TO EXISTING CIRCUIT.
- 10. RE-INSTALL EXISTING SIGNAGE, RECONNECT TO EXISTING CIRCUIT.
- 11. INSTALL NEW LIGHT BAND, RECONNECT TO EXISTING CIRCUIT.

I hereby certify that these documents were prepared or approved by me, and that I am a

License # 45531 Expiration Date: 06/03/2022

laws of the State of Maryland.

LIGHTING PLAN

duly licensed professional engineer under the

IF THIS DRAWING IS A REDUCTION, USE THE GRAPHIC SCALES.

2018.0375.04.0 E102

LHD

AS NOTED

04/12/2021

DESIGNED: SWC

DRAWN:


SCALE:


DATE:


CHECKED:

PROJECT:

04-21-2021 BID SET SUBMISSION

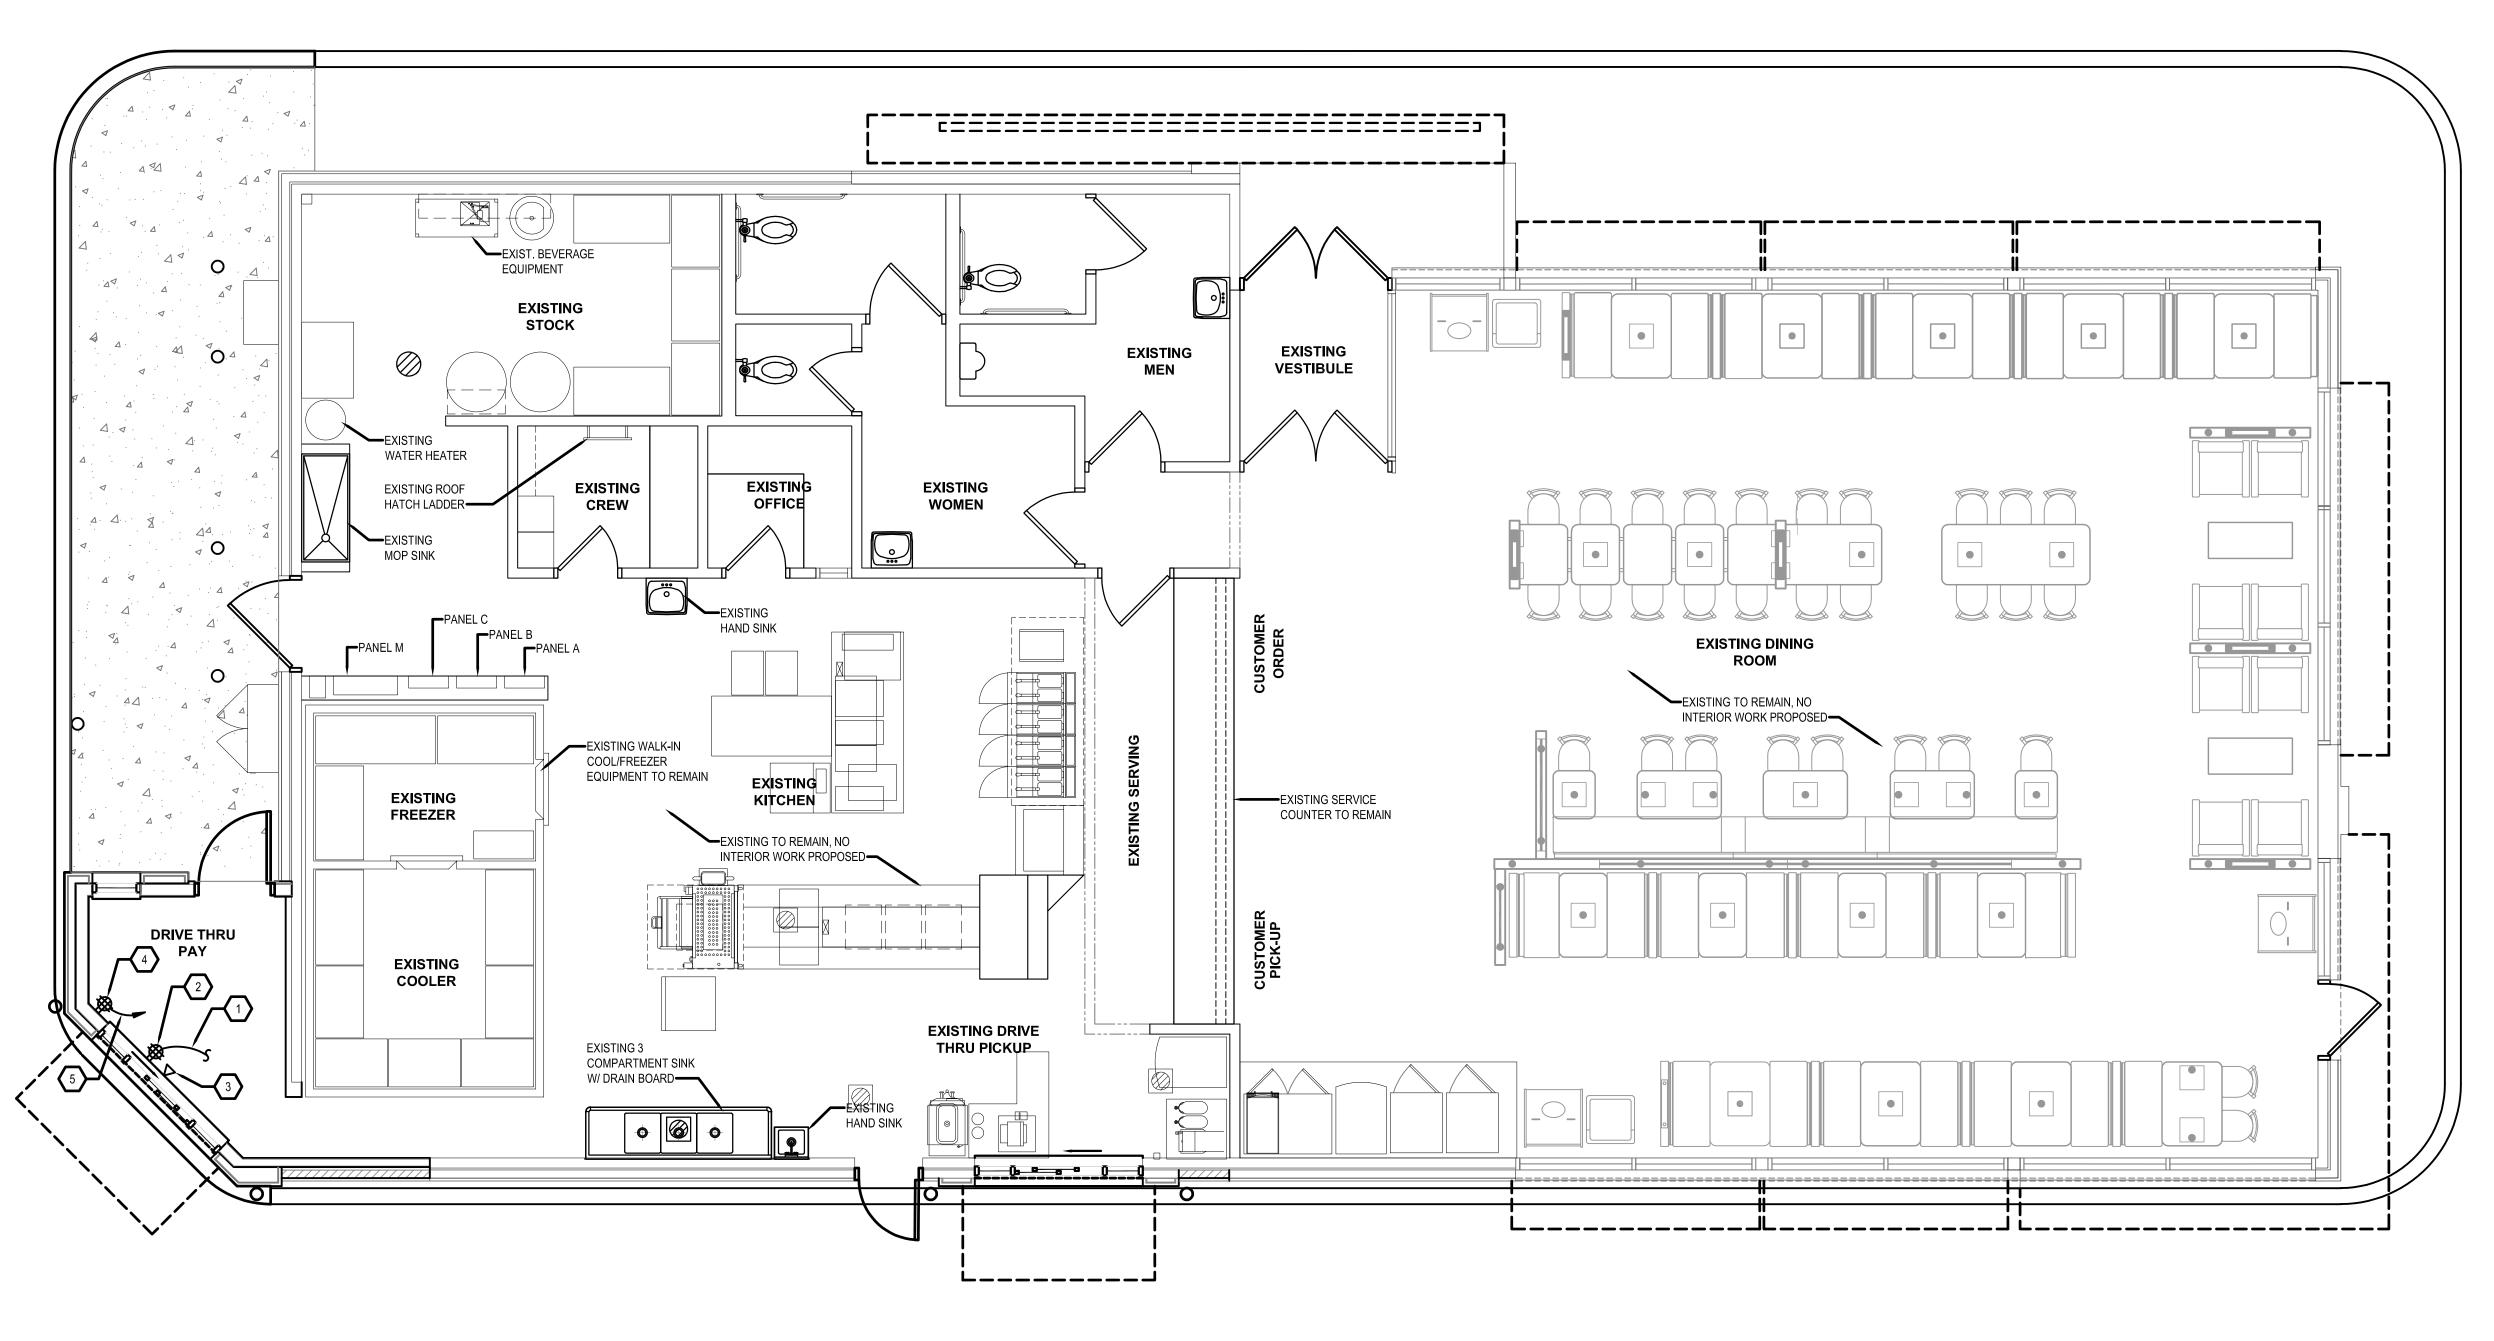

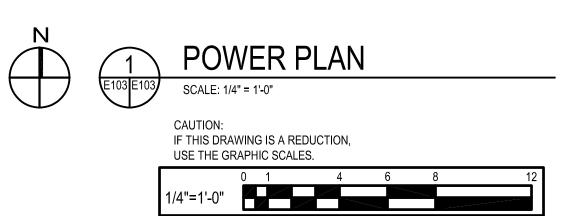

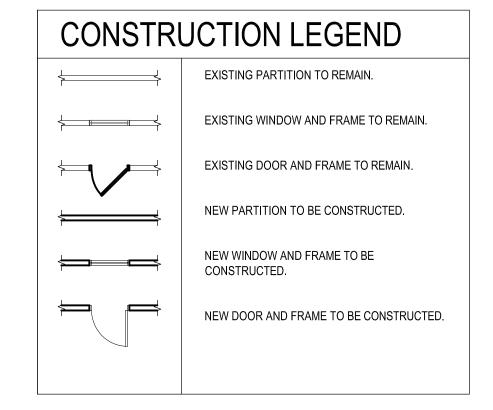


SHEET KEYNOTES

- 2#12+#12GW IN 3/4" CONDUIT, EXTEND AND CONNECT TO EXISTING RECEPTACLE CIRCUIT PREVIOUSLY SERVING DRIVE THRU WINDOW RECEPTACLE.
- 2. DOUBLE DUPLEX RECEPTACLE (WHITE) WITH STAINLESS STEEL COVER PLATE, 2P., 3W., 20A., 125V. NEMA 5-20R CONFIGURATION. MOUNT AT 18" ABOVE FINISHED FLOOR UNLESS OTHERWISE
- 3. DATA OUTLET, SINGLE GANG BACK BOX WITH 3/4" CONDUIT WITH BUSHED ENDS TO ACCESSIBLE CEILING.
- 4. DOUBLE DUPLEX RECEPTACLE (WHITE) WITH STAINLESS STEEL COVER PLATE, 2P., 3W., 20A., 125V. NEMA 5-20R CONFIGURATION. MOUNT AT 72" ABOVE FINISHED FLOOR.

5. 2#12+#12GW IN 3/4" CONDUIT BACK TO PANEL A. PROVIDE 1P-20A CB IN EXISTING SPACE AND MAKE ALL CONNECTIONS. PANEL A IS A SIEMENS TYPE S1 PANEL BOARD.

04-21-2021 BID SET SUBMISSION

NO. DATE REVISION B

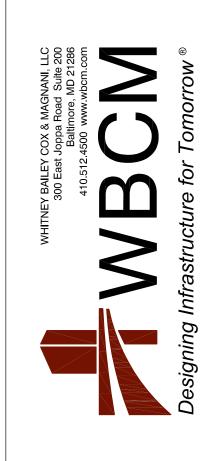

I hereby certify that these documents were prepared or approved by me, and that I am a duly licensed professional engineer under the laws of the State of Maryland.

License # 45531 Expiration Date: 06/03/2022

3URGER KING # 9571

ALTERATIONS - B

DESIGNED:

DRAWN:

CHECKED: JWA

SCALE: AS NOTED

DATE: 04/12/2021

PROJECT: 2018.0375.04.0

DRAWING:

E103

		208Y/120V,3ø,4W ERE BUS	INE	W CIRC	A M		N BOLL	<u>, </u>		100% RATE			LOCATION: KITCHEN 100% RATED NEUTRAL BUS 22,0					
CONN			BR	EAKER		CIRCL	JIT WIR	ING			BR	EAKER		CIRCL	IIT WIRII	NG	СО	
KVA	CKT	DESCRIPTION	Р	AMPS	NO	SIZE	GND	С	СКТ	DESCRIPTION	Р	AMPS	NO	SIZE	GND	С	K١	
	1	LTG: OFFICE/STORAGE	1	20	-	-	-	-	2	LTG: EMERGENCY-EXIT	1	20	-	-	-	-		
	3	DISPLAY SIGNS	1	20	-	-	-	-	4	LTG: DINING ROOM	1	20	-	-	-	-		
	5	RELAY PANEL	1	20	-	-	-	-	6	LTG: DINING ROOM	1	20	-	-	-	-		
	7	LIGHT BAND	1	20	-	-	-	-	8	MENUBOARD	1	20	-	-	-	-		
	9	LIGHT BAND	1	20	-	-	-	-	10	LTG: RESTROOM	1	20	-	-	-	-		
	11	SOFFIT LIGHTS	1	20	-	-	-	-	12	LTG: KITCHEN	1	20	-	-	-	-		
	13	LIGHT BAND	1	20	-	-	-	-	14	LTG: PENDANTS	1	20	-	-	-	-		
	15	LIGHT BAND	1	20	-	-	-	-	16	REC:	1	20	-	-	-	-		
	17	SOFFIT LIGHTS	1	20	-	-	-	-	18	SPARE	1	20	-	-	-	-		
	19	MANSARD SIGN	1	20	-	-	-	-	20	LTG: EXTERIOR WALL	1	20	-	-	-	-		
	21	SOFFIT LIGHTS	1	20	-	-	-	-	22	SPARE	2	40	-	-	-	-		
	23	SPARE	1	20	-	-	-	-	24	SPARE	-	-	-	-	-	-		
	25	BROILER	2	20	-	-	-	-	26	EXHAUST FAN	3	20	-	-	-	-		
	27	-	-	-	-	-	-	-	28	-	-	-	-	-	-	-		
	29	LOGO SIGN	1	20	-	-	-	-	30	-	-	-	-	-	-	-		
	31	SPARE	2	20	-	-	-	-	32	SPARE	1	20	-	-	-	-		
	33	-	-	-	-	-	-	-	34	SPARE	1	20	-	-	-	-		
	35	MENU BOARD	1	20	-	-	-	-	36	SPARE	1	20	-	-	-	-		
	37	SPARE	1	20	-	-	-	-	38	SPARE	1	20	-	-	-	-		
	39	SPEAKER PEDESTAL	1	20	-	-	-	-	40	SPARE	2	30	-	-	-	-		
	41	DRIVETHRU RECEPTACLE	1	20	2	12	12	3/4	42	SPARE	-		-	-	-	-		

/OLTA	GE: 2	08Y/120V,3ø,4W										CATION					
250	AMPI	ERE BUS		125	A M	LO				100% RATED) NE	UTRAL	BUS			22,00	0 A.I.
CONN			BR	EAKER		CIRCL	JIT WIRI	NG			BR	EAKER		CIRCL	IT WIRI	NG	COI
KVA	CKT	DESCRIPTION	Р	AMPS	NO	SIZE	GND	С	СКТ	DESCRIPTION	Р	AMPS	NO	SIZE	GND	С	K۷
	1	FRY STATION CHASE REC	2	20	-	-	-	-	2	REC: DINING ROOM	1	20	-	-	-	-	
	3	-	-	-	1	-	-	-	4	REC: DRIVE THRU	1	20	-	-	-	-	
	5	COFFEE REC	2	20	-	-	-	-	6	UNDERCOUNTER REFRIG	1	20	-	1	-	-	
	7	-	-	-	-	-	-	-	8	REC: HOT CHOCOLATE	1	20	-	-	-	-	
	9	REC: STOCK ROOM	1	20	-	-	-	-	10	REC: REACH IN FREEZER	1	20	-	-	-	-	
	11	DRINK SYSTEM	1	20	-	-	-	-	12	HAND DRYER	1	20	-	-	-	-	
	13	FRY STATION CHASE REC	2	20	-	-	-	-	14	HAND DRYER	1	20	-	-	-	-	
	15	-	-	-	-	-	-	-	16	REC: OFFICE	1	20	-	-	-	-	
	17	REC:	1	20	-	-	-	-	18	REC: SERVICE COUNTER	1	20	-	-	-	-	
	19	FRY STATION CHASE REC	2	20	-	-	-	-	20	VEGETABLE CUTTER	1	20	-	-	-	-	
	21	-	-	-	-	-	-	-	22	TIME CLOCK	1	20	-	-	-	-	
	23	FRYER CONTROL	1	20	-	-	-	-	24	DRINK SYSTEM	1	20	-	-	-	-	
	25	GRILL CONTROL	1	20	-	-	-	-	26	REC: DINING RM COFFEE	2	30	-	-	-	-	
	27	FRYER CONTROL	1	20	-	-	-	-	28	-	-	-	-	-	-	-	
	29	FRYER CONTROL	1	20	-	-	-	-	30	FRY STATION CHASE REC	2	20	-	-	-	-	
	31	ICE MACHINE	2	20	-	-	-	-	32	-	-	-	-	-	-	-	
	33	-	-	-	-	-	-	-	34	DRINK MACHINE	1	20	-	-	-	-	
	35	SPACRE	1	30	-	-	-	-	36	SPARE	1	20	-	-	-	-	
	37	BISCUIT OVEN	3	30	-	-	-	-	38	SPARE	1	20	-	-	-	-	
	39	-	-	-	-	-	-	-	40	EGG COOKER	2	40	-	-	-	-	
	41			-	-	-		-	42	-	-	-	-	-	-	-	

PANE	LC	(EXISTING)									МО	UNTING	: RE	CESSE)			
VOLTA	GE: 2	208Y/120V,3ø,4W	NE	W CIRC	UITS	SHOW	N BOL)			LO	CATION	: KIT	CHEN				
250	AMP	ERE BUS		125	A M	LO				100% RATE	D NE	UTRAL	BUS		22,000 A.I.O			
CONN			BR	EAKER		CIRCL	JIT WIR	ING			BR	EAKER		CIRCU	IT WIRII	NG	CONN	
KVA	CKT	DESCRIPTION	Р	AMPS	NO	SIZE	GND	С	CKT	DESCRIPTION	Р	AMPS	NO	SIZE	GND	С	KVA	
	1	SHAKE MACHINE	3	15	-	-	-	-	2	COOLER	2	20	-	-	-	-		
	3	-	-	-	-	-	-	-	4	-	-	-	-	-	-	-		
	5	-	-	-	-	-	-	-	6	COOLER/FREEZER LTG	1	20	-	-	-	-		
	7	AIR COMPRESSOR	1	20	-	ı	-	-	8	FREEZER	3	30	-	-	1	-		
	9	DRINK CARBONATORS	1	20	-	ı	-	-	10	-	-	-	-	-	-	-		
	11	WATER FILTER	1	20	-	-	-	-	12	-	-	-	-	-	-	-		
	13	BULK CO2	1	20	-	-	-	-	14	EXISTING CIRCUIT	1	20	-	-	-	-		
	15	REC: STORAGE ROOM	1	20	-	-	-	-	16	EXISTING CIRCUIT	1	20	-	-	-	-		
	17	EXISTING CIRCUIT	1	20	-	1	-	-	18	EXISTING CIRCUIT	2	30	-	-	1	-		
	19	SPACE	1	-	-	1	-	-	20	EXISTING CIRCUIT	-	-	-	-	-	-		
	21	EXISTING CIRCUIT	2	50	-	ı	-	-	22	EXISTING CIRCUIT	2	20	-	-	-	-		
	23	-	-	-	-	ı	-	-	24	EXISTING CIRCUIT	-	-	-	-	-	-		
	25	SPACE	1	-	-	ı	-	-	26	EXISTING CIRCUIT	2	20	-	-	-	-		
	27	EXISTING CIRCUIT	1	20	-	1	-	-	28	EXISTING CIRCUIT	-	-	-	-	-	-		
	29	EXISTING CIRCUIT	1	20	-	ı	-	-	30	EXISTING CIRCUIT	2	20	-	-	-	-		
	31	SPEAKER POST 1	1	20	2	12	12	1"	32	EXISTING CIRCUIT	-	-	-	-	-	-		
	33	SPEAKER POST 2	1	20	2	12	12	1"	34	-	2	30	-	-	-	-		
	35	ODMB 1	1	20	2	12	12	1"	36	EXISTING CIRCUIT	-	-	-	-	-	-		
	37	ODMB 2	1	20	2	12	12	1"	38	-	2	30	-	-	-	-		
	39	CAMERA POWER SUPPLY	1	20	2	12	12	1"	40	EXISTING CIRCUIT	-	-	-	-	-	-		
	41	SPACE	1	-	-	-	-	-	42	-	1	20	-	-	-	-		
OTAL	CON	NECTED LOAD		0.0	KVA					KVA PER PHASE:	Α	0.0	В	0.0	С	0.0		

ВУ				
REVISION				
DATE				
NO.				



I hereby certify that these documents were prepared or approved by me, and that I am a duly licensed professional engineer under the laws of the State of Maryland.

License # 45531 Expiration Date: 06/03/2022


PANEL SCHEDULES

RATIONS - BURGER KING # 9571

BURGERS OF BALTIMORE
2110 FMMORTON ROAD


	DESIGNED:	SWC	
	DRAWN:	LHD	
	CHECKED:	JWA	
	SCALE:	AS NOTED	
	DATE:	04/12/2021	
	PROJECT:	2018.0375.04.0	
		•	

E104

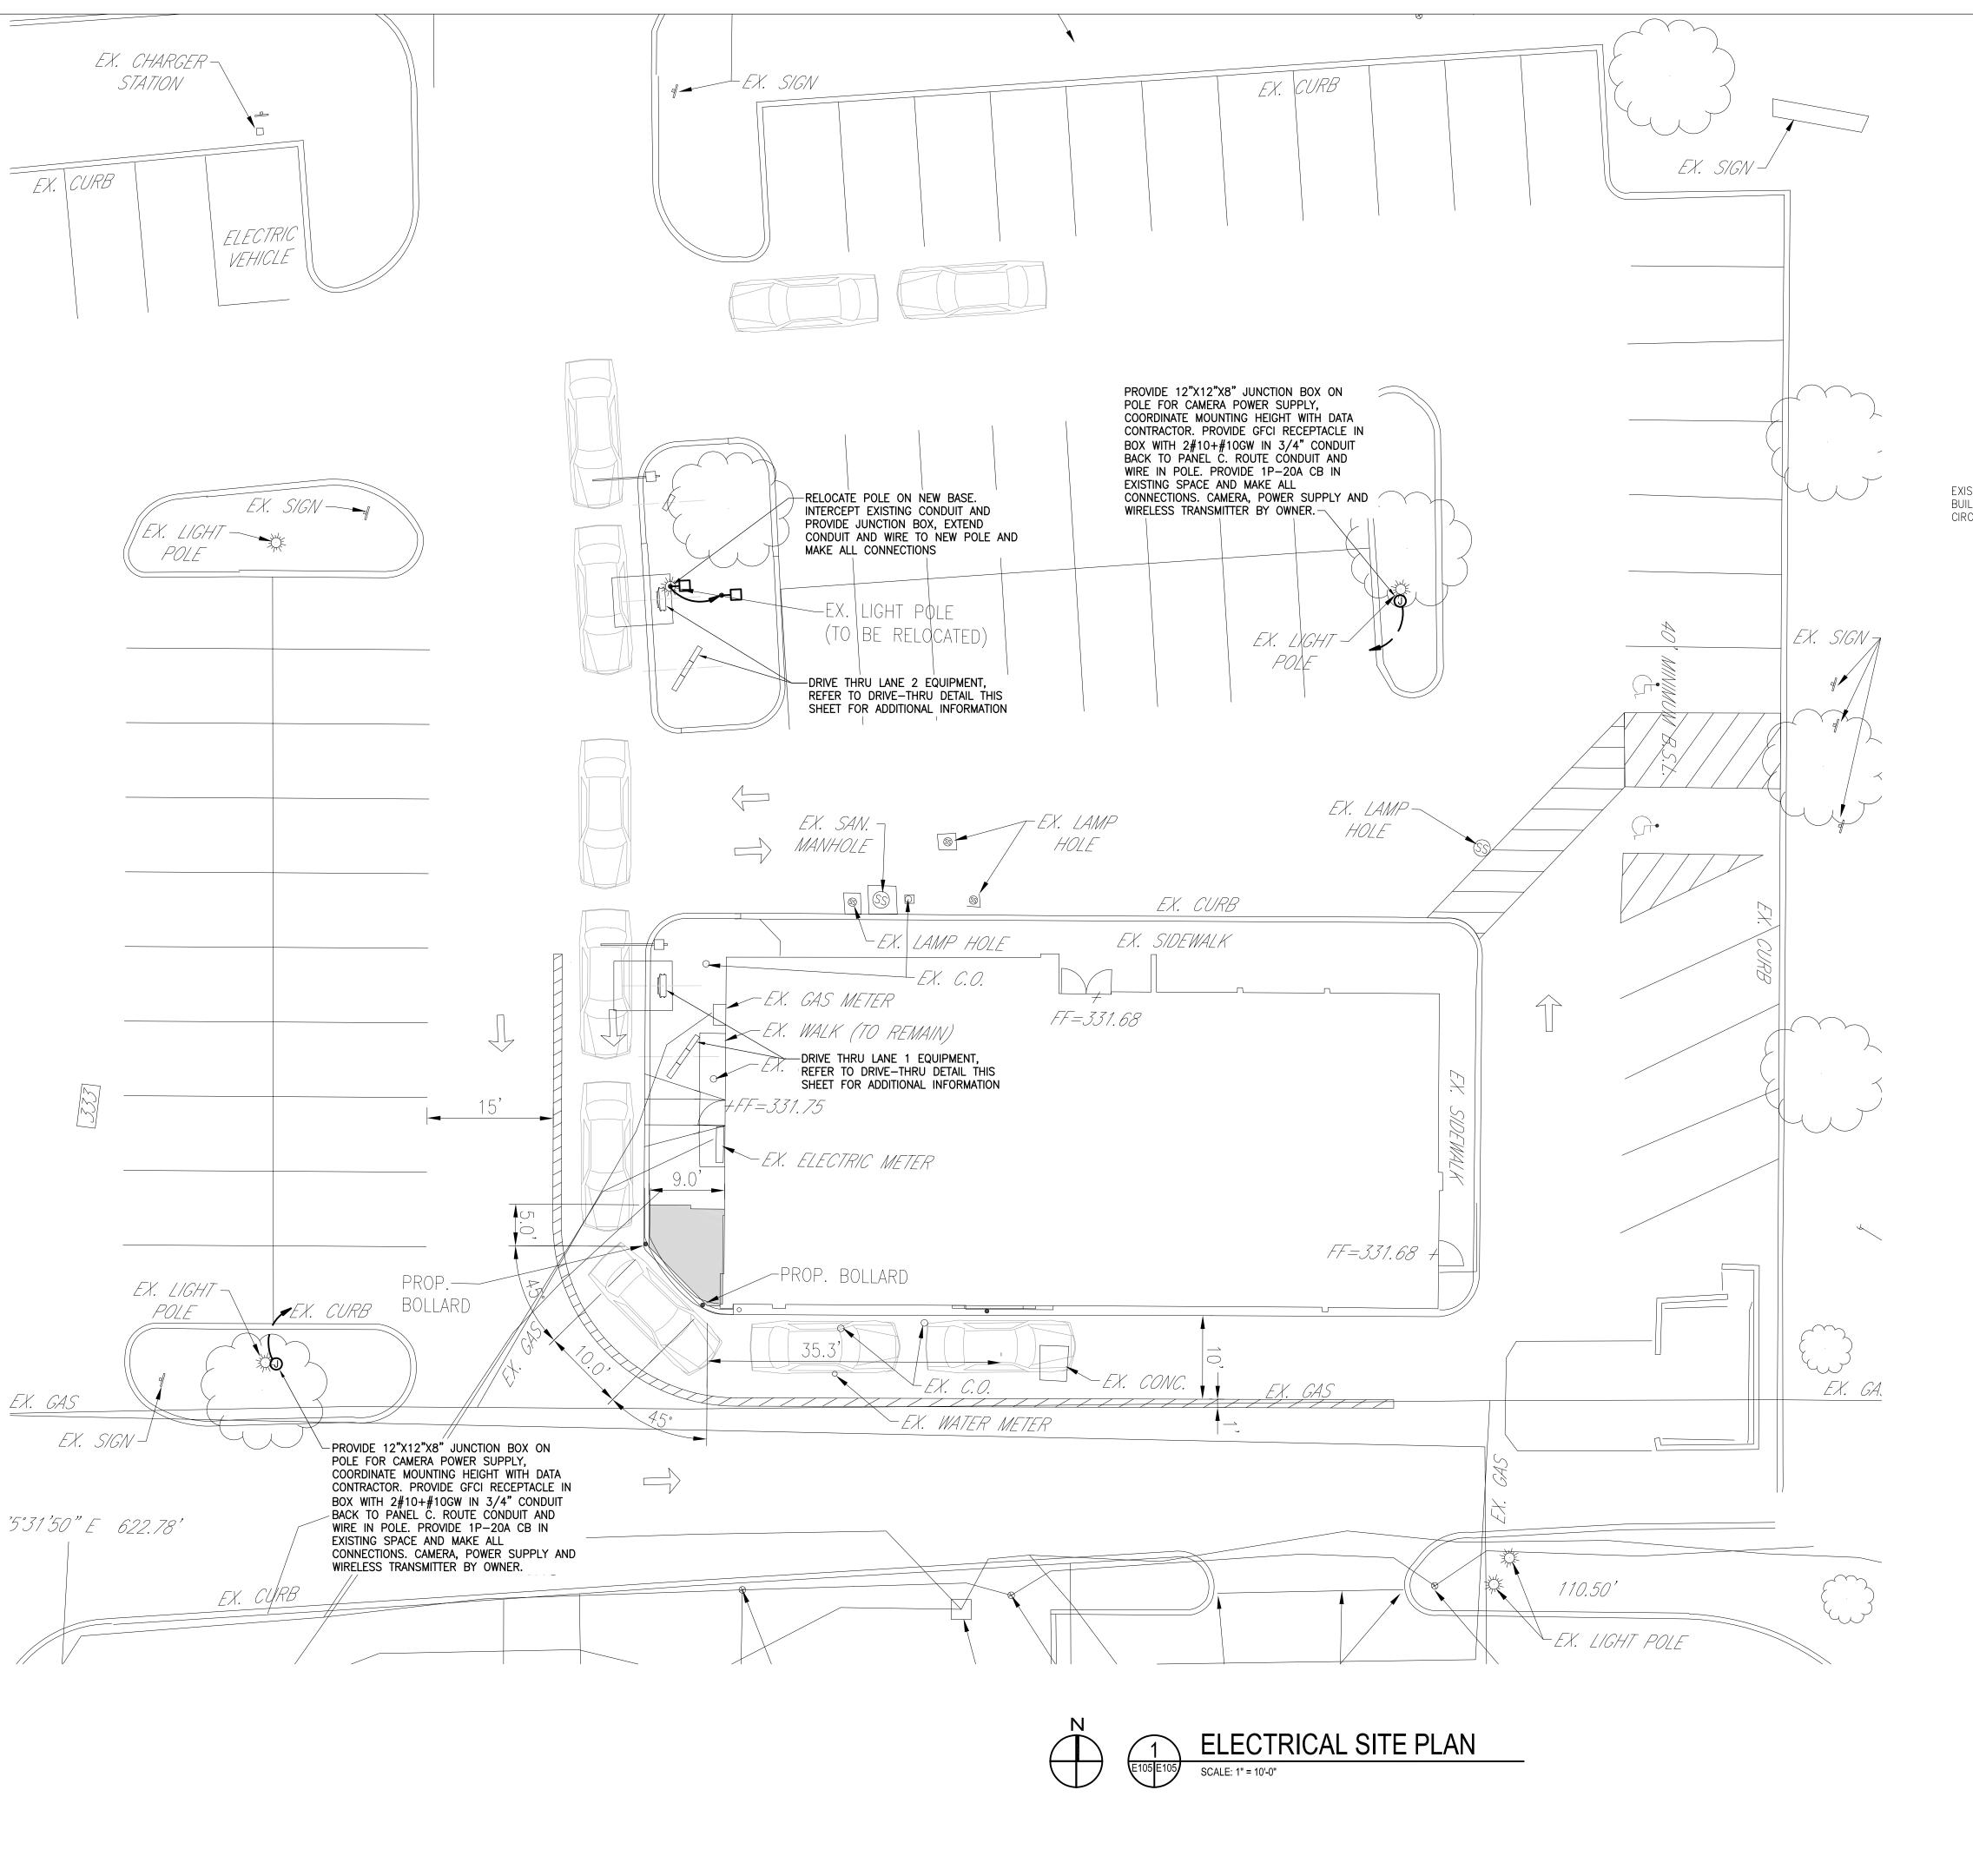

GENERAL NOTES

- 1. COORDINATE ALL NEW WORK WITH SITE UTILITIES.
- 2. CUT AND PATCH EXISTING PAVED AREAS INCLUDING PARKING, CURBS, SIDEWALKS AND LOTS REQUIRED FOR INSTALLATION OF ELECTRICAL
- 3. ALL EXTERIOR LIGHTING CONDUITS/RACEWAYS SHALL HAVE DETECTABLE MARKING TAPE.
- 4. COORDINATE INSTALLATION OF ELECTRICAL WORK WITH EXISTING AND FINAL GRADING. REFER TO CIVIL PLANS.

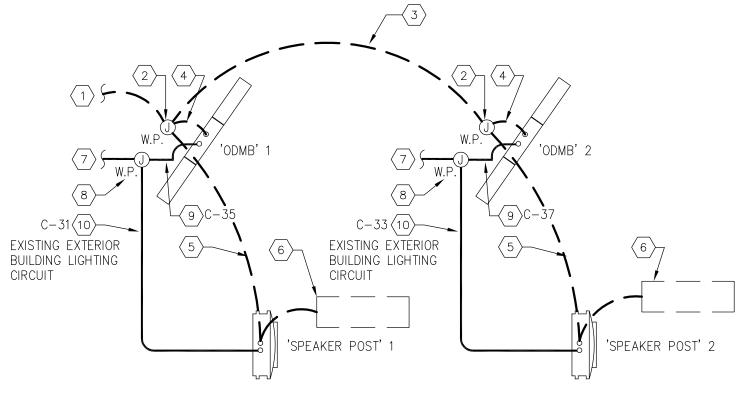

LANE 1 DRIVE-THRU EQUIPMENT

LANE 2 DRIVE-THRU EQUIPMENT

KEYED NOTES - DRIVE THRU:

- 1. 2" UNDERGROUND DATA CONDUIT FROM DRIVE—THRU. ROUTE CONDUIT UP IN NEW DRIVETHRU WALL AND INTO ACCESSIBLE CEILING SPACE.
- WATERPROOF JUNCTION DATA BOX LOCATED BEHIND 'ODMB'.
 2" UNDERGROUND DATA CONDUIT TO LANE 2.
- 4. 3/4" PVC SWEPT INTO 'ODMB' FOOTER.
- 5. 3/4" PVC SWEPT INTO 'SPEAKER POST'.
- 6. 1/2" PVC SWEPT INTO 'SPEAKER POST' FROM UNDER CONCRETE LOOP.
- ELECTRICAL

 7. 1" UNDERGROUND POWER CONDUIT TO DEDICATED CIRCUIT. REFER TO PANEL SCHEDULE. ROUTE CONDUIT UP IN NEW DRIVETHRU WALL AND
- INTO ACCESSIBLE CEILING SPACE.

 8. WATERPROOF JUNCTION POWER BOX LOCATED BEHIND 'ODMB'.
- 9. 1/2" CONDUIT SWEPT INTO 'ODMB' FOOTER FOR DEDICATED POWER.
 REFER TO PANEL SCHEDULE.
- 10. 3/4" CONDUIT SWEPT INTO 'SPEAKER POST' FOOTER FOR DEDICATED POWER. REFER TO PANEL SCHEDULE. 2#12+#12GW IN 1" CONDUIT, CONNECT TO EXISTING EXTERIOR BUILDING MOUNTED LIGHTING CIRCUIT.
- 1. 2" UNDERGROUND DATA CONDUIT FROM DRIVE-THRU.
- 2. WATERPROOF JUNCTION DATA BOX LOCATED BEHIND 'ODMB'.3. 2" UNDERGROUND DATA CONDUIT TO LANE 2.
- 4. 3/4" PVC SWEPT INTO 'ODMB' FOOTER.
 5. 3/4" PVC SWEPT INTO 'SPEAKER POST'.
- 6. 1/2" PVC SWEPT INTO 'SPEAKER POST' FROM UNDER CONCRETE LOOP.
- 7. 1" UNDERGROUND POWER CONDUIT TO DEDICATED CIRCUIT. REFER TO PANEL SCHEDULE.
- 8. WATERPROOF JUNCTION POWER BOX LOCATED BEHIND 'ODMB'.
 9. 1/2" CONDUIT SWEPT INTO 'ODMB' FOOTER FOR DEDICATED POWER REFER TO
- 9. 1/2" CONDUIT SWEPT INTO 'ODMB' FOOTER FOR DEDICATED POWER. REFER TO PANEL SCHEDULE.
 10. 3/4" CONDUIT SWEPT INTO 'SPEAKER POST' FOOTER FOR DEDICATED POWER. TIE INTO BUILDING LIGHT CIRCUIT. REFER TO PANEL SCHEDULE.

- POLE WITH BELL BOTTOM GASKETED HANDHOLE COVER WITH FUSE AND HOLDER FLANGE WITHIN POLE, ACCESSIBLE BUSHED CONDUIT FROM HANDHOLE -STUB-UPS, 4" MINIMUM GROUND LUG -- BOLT COVER, GROUT GAP LEVELING NUTS -1" CHAMFER ALL AROUND #4 COPPER GROUND WIRE-TO POLE GROUND LUG - 30" MINIMUM EXOTHERMIC WELD COOPER GROUND ROD - 3/4" DIAMETER x 10'-0" - PVC CONDUIT 6#6 BARS VERTICAL REINFORCEMENT WITH #3 8'-0" MINIMUM -TIES AT 10" ON CENTER ANCHOR BOLTS - QUANTITIES, LENGTH, DIAMETER AND PROJECT FROM CONCRETE PER MANUFACTURER's

NOTES:

1. ALL REINFORCING STEEL TO BE ASTM A615, GRADE 60 EXCEPT TIES, TIES SHALL BE GRADE 40.

2. PROVIDE 1-1/4" CONDUIT MINIMUM TO EACH POLE FOR NORMAL POWER WIRING.

POLE BASE AND FOUNDATION

SCALE: NONE

SCALE: 1" = 10'-0"

FORM CONCRETE AGAINST

MINIMUM DIAMETER

UNDISTRIBUTED EARTH. 24"

10 0 10 20 21-2021 BID SET SUBMISSION

RECOMMENDATIONS

3" CONCRETE COVER (TYP.)

NO. DATE REVISION

REVISION



I hereby certify that these documents were prepared or approved by me, and that I am a duly licensed professional engineer under the laws of the State of Maryland.

License # 45531 Expiration Date: 06/03/2022

ALTERATIONS - BURGER KING # 9571

BURGERS OF BALTIMORE
2110 EMMORTON ROAD
BELAIR, MARYLAND 21015

DESIGNED: SWC

DRAWN: LHD

CHECKED: JWA

SCALE: AS NOTED

DATE: 04/12/2021

PROJECT: 2018.0375.04.0

DRAWING:

E105

WBCM 2018