

# BURGER KING RESTAURANT #10839

200 SOUTH FOUNTAIN GREEN ROAD BEL AIR, MARYLAND 21015

DISTRICT-03 ACCOUNT NUMBER - 057844

GRID-0004E PARCEL-0108 SUBDIVISION-0000

ZONING - B2 (COMMUNITY BUSINESS)

DWG. NO.	SHEET NO.	CHEET TITLE	DWG. NO.	SHEET NO.	CULTET TITLE
ARCHITECT		SHEET TITLE	ELECTRICAL		SHEET TITLE
G101	1	COVERSHEET, CODE ANALYSIS, ABBREVIATIONS & SYMBOLS	ED101	- 26	ELECTRICAL DEMOLITION
AD101	2	DEMOLITION FLOOR PLAN	E101	27	LIGHTING FIXTURE SCHEDULE
AD101 AD102	3	DEMOLITION FLOOR FLAN	E101	28	LIGHTING PLAN
AD102 AD103	4	DEMOLITION CELEING FEAN	E103	29	POWER PLAN
AD201	5	EXISTING BUILDING ELEVATIONS	E104	30	PANEL SCHEDULE
A101	6	NEW WORK FLOOR PLAN	E105	31	ELECTRICAL SITE PLAN
A102	7	NEW WORK CEILING PLAN		<u> </u>	EEEO THOME ONE FEMA
A103	8	REFLECTED CEILING DETAILS			
A104	9	NEW WORK ROOF PLAN			
A201	10	EXTERIOR BUILDING ELEVATIONS			
A202	11	EXTERIOR FINISH SCHEDULE			
A301	12	WALL SECTIONS			
A302	13	WALL SECTIONS			
A303	14	WALL SECTIONS			
A304	15	WALL SECTIONS			
A501	16	MISCELLANEOUS DETAILS			
A601	17	DOOR SCHEDULE AND DETAILS			
A701	18	MANUFACTURERS AND SUPPLIERS			
STRUCTUR	AL				
S001	19	GENERAL NOTES			
S101	20	FOUNDATION PLAN			
S102	21	ROOF FRAMING PLAN			
S201	22	SECTIONS			
S301	23	SECTIONS			
MECHANIC	=				
MD101	24	MECHANICAL DEMOLITION			
M101	25	MECHANICAL PLAN			

# **LOCATION MAP**

# EGRESS PLAN

KITCHEN

LONG, LENGTH or ANGLE

LAMINATE (D)

LAVATORY LINEAR FEET

LINEAR FEET

LIQUID SOAP DISPENSER

MATERIAL MAXIMUM

MECHANICAL MANUFACTURER

MINIMUM, MINUTE

**MISCELLANEOUS** 

MOLDING

MASONRY OPENING

MODIFY, MODULAR

METAL THRESHOLD

MOUNTED

NORTH

NOT APPLICABLE

NOT IN CONTRACT

NOT TO SCALE

ON CENTER

**OUTSIDE DIAMETER** 

OFFICE OVERHEAD

OPENING

OPPOSITE

PERPENDICULAR

PLASTIC LAMINATE

PLATE

PLYWOOD POWDER ACTUATED FASTENER

PRE-ENGINEERED

PRFFABRICATE

PAINT, PRESSURE TREATED

PAPER TOWEL DISPENSER

QUARRY TILE

RISER

RADIATOR or RADIUS ROOF DRAIN

REFERENCE

REFRIGERATOR

REINFORCE (ING) (ED) REQUIRED REVISION

ROOM

ROUGH OPENING

SANITARY NAPKIN DISPENSER

SCHEDULE

SECTION

SHEATHING

SILICONIZED MASONRY UNIT

SPECIFICATION

SQUARE

**SQUARE FOOT** 

SQUARE YARD

STAIN (ED)

STAINLESS STEEL

STEEL

STRUCTURE (AL)

SYMBOL

SYSTEM

TREAD

**TELEPHONE** 

**TOILET TISSUE DISPENSER** THICK

TONGUE AND GROOVE

TOP OF STEEL

TOP OF FOOTING

TREATED

TRIPLE

TURN DOWN SLAB

TYPICAL

UNDERWRITERS LABORATORIES

UNFINISHED

UNLESS NOTED OTHERWISE

VERTICAL CONTROL JOINT

VINYL COMPOSITION TILE

VERTICAL

VERIFY IN FIELD

WEST, WIDE

WATER RESISTANT

WATERPROOF (ING)

WATER CLOSET

WOOD WATER HEATER

WELDED WIRE FABRIC

WEIGHT

NUMBER

MECH

MISC

MLDG

NO or #

PLYWD

PREFAB

RFINE

SECT

SPEC

SQ FT or SF

SQ YD or SY

SYM

TOS

UNFIN

UNO

VCJ

VERT

ALTERATION - LEVEL 2

TYPE 'V-B' (NO CHANGE)

1 STORY @ 40'-0" HIGH

1 STORY @ 21'-0 HIGH

1 STORY @ 21'-0 HIGH

58 ('A' USE) + 7 = 65 OCCUPANTS


6,000 SF

2,730 SF

THE EXISTING BUILDING IS CURRENTLY


NON-SPRINKLERED (NO CHANGE)


ASSEMBLY USE - A-2' (NO CHANGE)

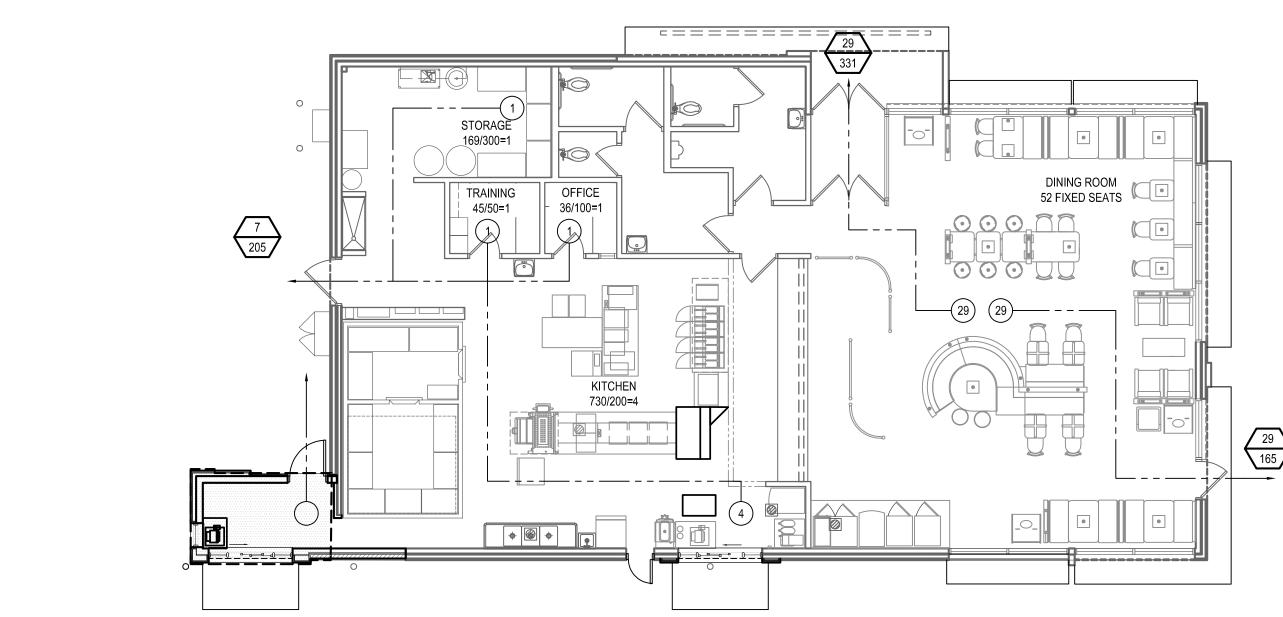

ROOM OCCUPANCY INFO OFFICE → ROOM NAME/FUNCTION TOTAL # OF OCC. -----IBC OCC AREA -ROOM SIZE (SF)

# EGRESS DOOR SYBMOL

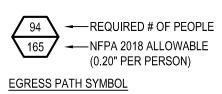

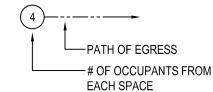

THE EGRESS CAPACITY OF 3'-0" SINGLE DOORS HAVE BEEN CALCULATED USING 33" AS AN ACTUAL CLEAR WIDTH 33"/0.20" = 165 PERSONS

- THE EGRESS CAPACITY OF 3'-8" SINGLE DOORS HAVE BEEN CALCULATED USING 41" AS AN ACTUAL CLEAR WIDTH 41"/0.20" = 205 PERSONS
- THE EGRESS CAPACITY OF 6'-0" DOUBLE DOORS HAVE BEEN CALCULATED USING 67.25" AS AN ACTUAL CLEAR WIDTH.
- ALL OF THE ABOVE CALCULATIONS ARE BASED ON NFPA 2018

PLYWOOD

PLYWOOD


(SMALL SCALE)

CRUSHED GRAVEL


COMPACT

NATURAL

FILL EARTH

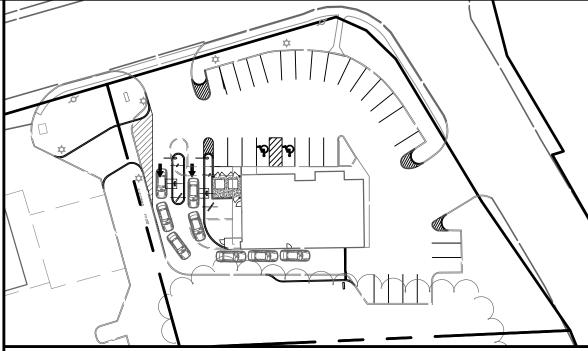



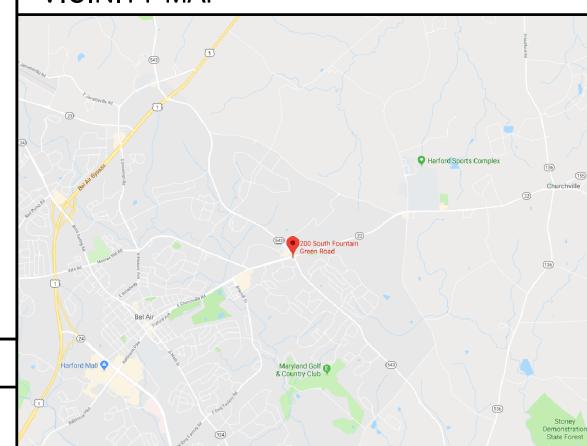

ALL WORK ASSOCIATED WITH THIS PROJECT SHALL COMPLY WITH THE FOLLOWING AS AMENDED BY

SUBCONTRACTORS & MATERIAL VENDORS SHALL COMPLY WITH CODES IDENTIFIED IN THIS CODE

2018 INTERNATIONAL BUILDING CODE

2018 INTERNATIONAL ENERGY CODE

2018 EDITION NFPA 1

2018 NFPA 101

ICC A117.1 - 2009

2018 INTERNATIONAL EXISTING BUILDING CODE

2010 ADA STANDARDS FOR ACCESSIBILITY DESIGN

MARYLAND ACCESSIBILITY CODE, COMAR 05.02.02,

2018 INTERNATIONAL MECHANICAL CODE

2019 NFPA 72 NATIONAL FIRE ALARM CODE

2018 INTERNATIONAL PLUMBING CODE

2018 INTERNATIONAL FUEL GAS CODE

2020 NATIONAL ELECTRICAL CODE

HARFORD COUNTY AND THE STATE OF MARYLAND. GENERAL CONTRACTOR AND ALL

hereby certify that these documents were prepared or approved by me, and that I am a duly licensed professional architect under the laws of the State of Maryland.

icense #6140 Expiration Date: 08/21/2022

KING BURGER TERATIONS.


CODE ONS & S

COVERSHEET, C ABBREVIATION

DESIGNED: J.M.M. DRAWN: J.M.M. CHECKED: S.C.B. SCALE: AS SHOWN 04/21/2021 PROJECT: 2018.0375.05 DRAWING:

G101

# **DETAIL SYMBOLS**

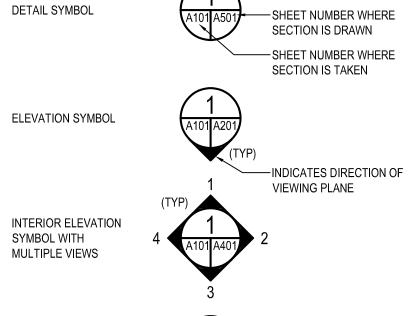


- ADDITIONAL INSTRUCTION

-DETAIL DRAWING NUMBER


WALL SECTION SYMBOL -INDICATES DIRECTION OF **CUTTING PLANE** BUILDING SECTION SYMBOL INDICATES DIRECTION OF CUTTING PLANE

**ENLARGED** 

DETAIL SYMBOL

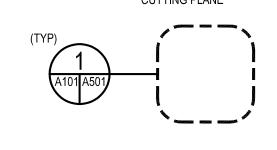

# SECTION DRAWING TITLE SYMBOL SCALE: 0" = 0"

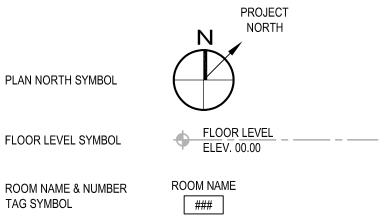

(###-#) DOOR TAG SYMBOL ₩#**>** WINDOW TAG SYMBOL

KEYNOTE TAG SYMBOL

**EQUIPMENT & FINISH** 

WALL TYPE TAG SYMBOL


TAG SYMBOL

**REVISION TAG &** 

CLOUD SYMBOL

(#)--⟨P-##⟩—

X —

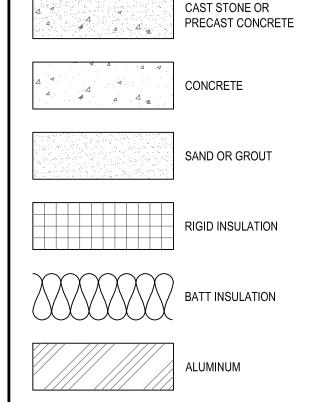

**MATERIALS** 

CMU, CONCRETE

MASONRY UNIT

\_\_\_\_\_ METAL DECKING

CUT STONE WOOD, BLOCKING & SHIMS

WOOD, FRAMING & FURRING

**ENGINEERED WOOD** 

**GENERAL NOTE** 

1. ALL PLAN DIMENSIONS ARE TO FACE OF GWB OR EXISTING SHELL, VERIFY IN FIELD. CONTRACTOR TO VERIFY ALL DIMENSIONS PRIOR TO COMMENCEMENT TO CONSTRUCTION, AND NOTIFY ARCHITECT OF ANY DISCREPANCIES.

BUILDING CODE -

ENERGY CODE -

LIFE SAFETY CODE -

6. ACCESSIBILITY -

MECHANICAL -

11. FIRE ALARM CODE -

PLUMBING -

9. ELECTRICAL -

EXISTING BUILDING CODE -

FIRE PROTECTION CODE -

DO NOT SCALE DRAWINGS. USE WRITTEN DIMENSIONS ONLY. ALL DIMENSIONS, NOTES, FINISHES AND FIXTURES SHOWN ON TYPICAL FLOOR PLANS, SECTIONS, OR DETAILS SHALL APPLY TO ALL SIMILAR, SYMMETRICAL OR OPPOSITE HAND PLANS, SECTIONS OR DETAILS.

12. AUTOMATIC SPRINKLER SYSTEMS CODE - 2019 NFPA 13

ALL DOOR JAMBS SHALL BE LOCATED 2" FROM INTERSECTING WALL, UNLESS NOTED CONTRACTOR TO PROVIDE AND INSTALL EXIT SIGNS AND EMERGENCY LIGHTING AS REQUIRED

BY APPLICABLE CODES. COORDINATE WITH ELECTRICAL DRAWINGS. GENERAL CONTRACTOR TO VERIFY ALL EXISTING UTILITIES

A. GAS SERVICE

APPLICABLE CODES

 B. DOMESTIC WATER SERVICE SANITARY D. SEWER SERVICE

E. ELECTRIC POWER SOURCE 8. COORDINATE WITH ALL EXISTING AND PROPOSED FLOOR WALL AND ROOF PENETRATIONS. 9. COORDINATE ALL NEW WORK WITH EXISTING CONDITIONS AND LANDLORD WORK.

04-21-2021 PERMIT SUBMISSION

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**ABBREVIATIONS** 

ADH

ADJ

ALUM

ARCH

BLDG

BLKHD

BOT

BOD

BUR

CHAN

CLR
CMU
COL
CONC
CONT
COORD

CTR

DEMO

DWG

ELEV

EQ EQUIP

EQUIV

**EXIST** 

EXP

FIXT

FLR

FLASH

FURN

FUR

GALV

GLZ

GWB

GYP

HDPE HDW HC

HORIZ HT

INSUL

INTER

EXP BT

CU CU FT or CF

CU YD or CY

BLK BLKG

APPROX

ACCESSIBLE

ADHESIVE

ALTERNATE

ALUMINUM

ARCHITECT

BFAM

BEARING BELOW

**BITUMINOUS** 

BUILDING

BLOCKING

BULKHEAD

BOTTOM

BOTTOM OF DECK

**BOTTOM OF FOOTING** 

BUILT UP ROOFING

CORNER GUARD

**CONTROL JOINT** 

CONCRETE MASONRY UNIT

**CONTINUE or CONTINUOUS** 

DEMOLITION or DEMOLISH

DRINKING FOUNTAIN

CENTER LINE

COLUMN

CONCRETE

COORDINATE

CARPET (ED)

CENTER

CUBIC FEET

CUBIC YARD

DEEP, DEPTH

DOUBLE

DIAMETER

DOWN

DIMENSION

DOWNSPOU<sup>\*</sup>

DRAWING

EACH

DISHWASHER

**EXPANSION JOINT** 

ELECTRIC or ELECTRICAL

ELECTRIC WATER COOLER

FI FVATION

ELEVATION

**ESTIMATE** 

**EQUIPMENT** 

EQUIVALENT

EACH WAY

EXPOSED

**EXPANSION BOLT** 

FLOOR DRAIN

FINISHED FLOOR

EXTERIOR, EXTERNAL

FIRE EXTINGUISHER

FIRE EXTINGUISHER

FINISHED OPENING

FURNISH, FURNITURE

FEET, FIRE TREATED, FOOT

GALVANIC, GALVANIZED

GYPSUM WALL BOARD

HORIZONTAL CONTROL JOINT

HIGH DENSITY POLYETHYLENE

FIXTURE

FLOOR

FLASHING

FOOTING

FURRING

GRAB BAR

GLASS

GLAZING

GYPSUM

HANDICAP

HARDWARE

**HOLLOW CORE** 

HORIZONTAL

INSULATION

INTERIOR

**JANITOR** 

JOINT

INTERNATIONAL EXISTING BUILDING CODE

2018 EDITION, CHAPTER 8

STATE OF MARYLAND FIRE

PREVENTION CODE, COMAR 29.06.01

CONSTRUCTION CLASSIFICATION

USE AND OCCUPANCY CLASSIFICATION

ALLOWABLE HEIGHT & BUILDING AREA

EXISTING HEIGHT AND BUILDING AREA

PROPOSED HEIGHT AND BUILDING AREA

FIRE PROTECTION

(IBC 18-303.3)

(IBC 18 - TABLE 601)

(IBC 18 - TABLE 503)

OCCUPANT LOAD

(IBC 18 - TABLE 1004.1.2)

(NFPA 18 - TABLE 13.1.6)

INTERMEDIATE

HEIGHT

HOLLOW METAL

INSIDE DIAMETER

CODE INFORMATION

FIRE EXTINGUISHER CABINET

**CERAMIC TILE** 

CEILING

**APPROXIMATE** 


ACOUSTICAL CEILING TILE


ABOVE FINISHED FLOOR


BABY CHANGING STATION

BELOW FINISHED FLOOP

ADJACENT, ADJOING, ADJUSTABLE

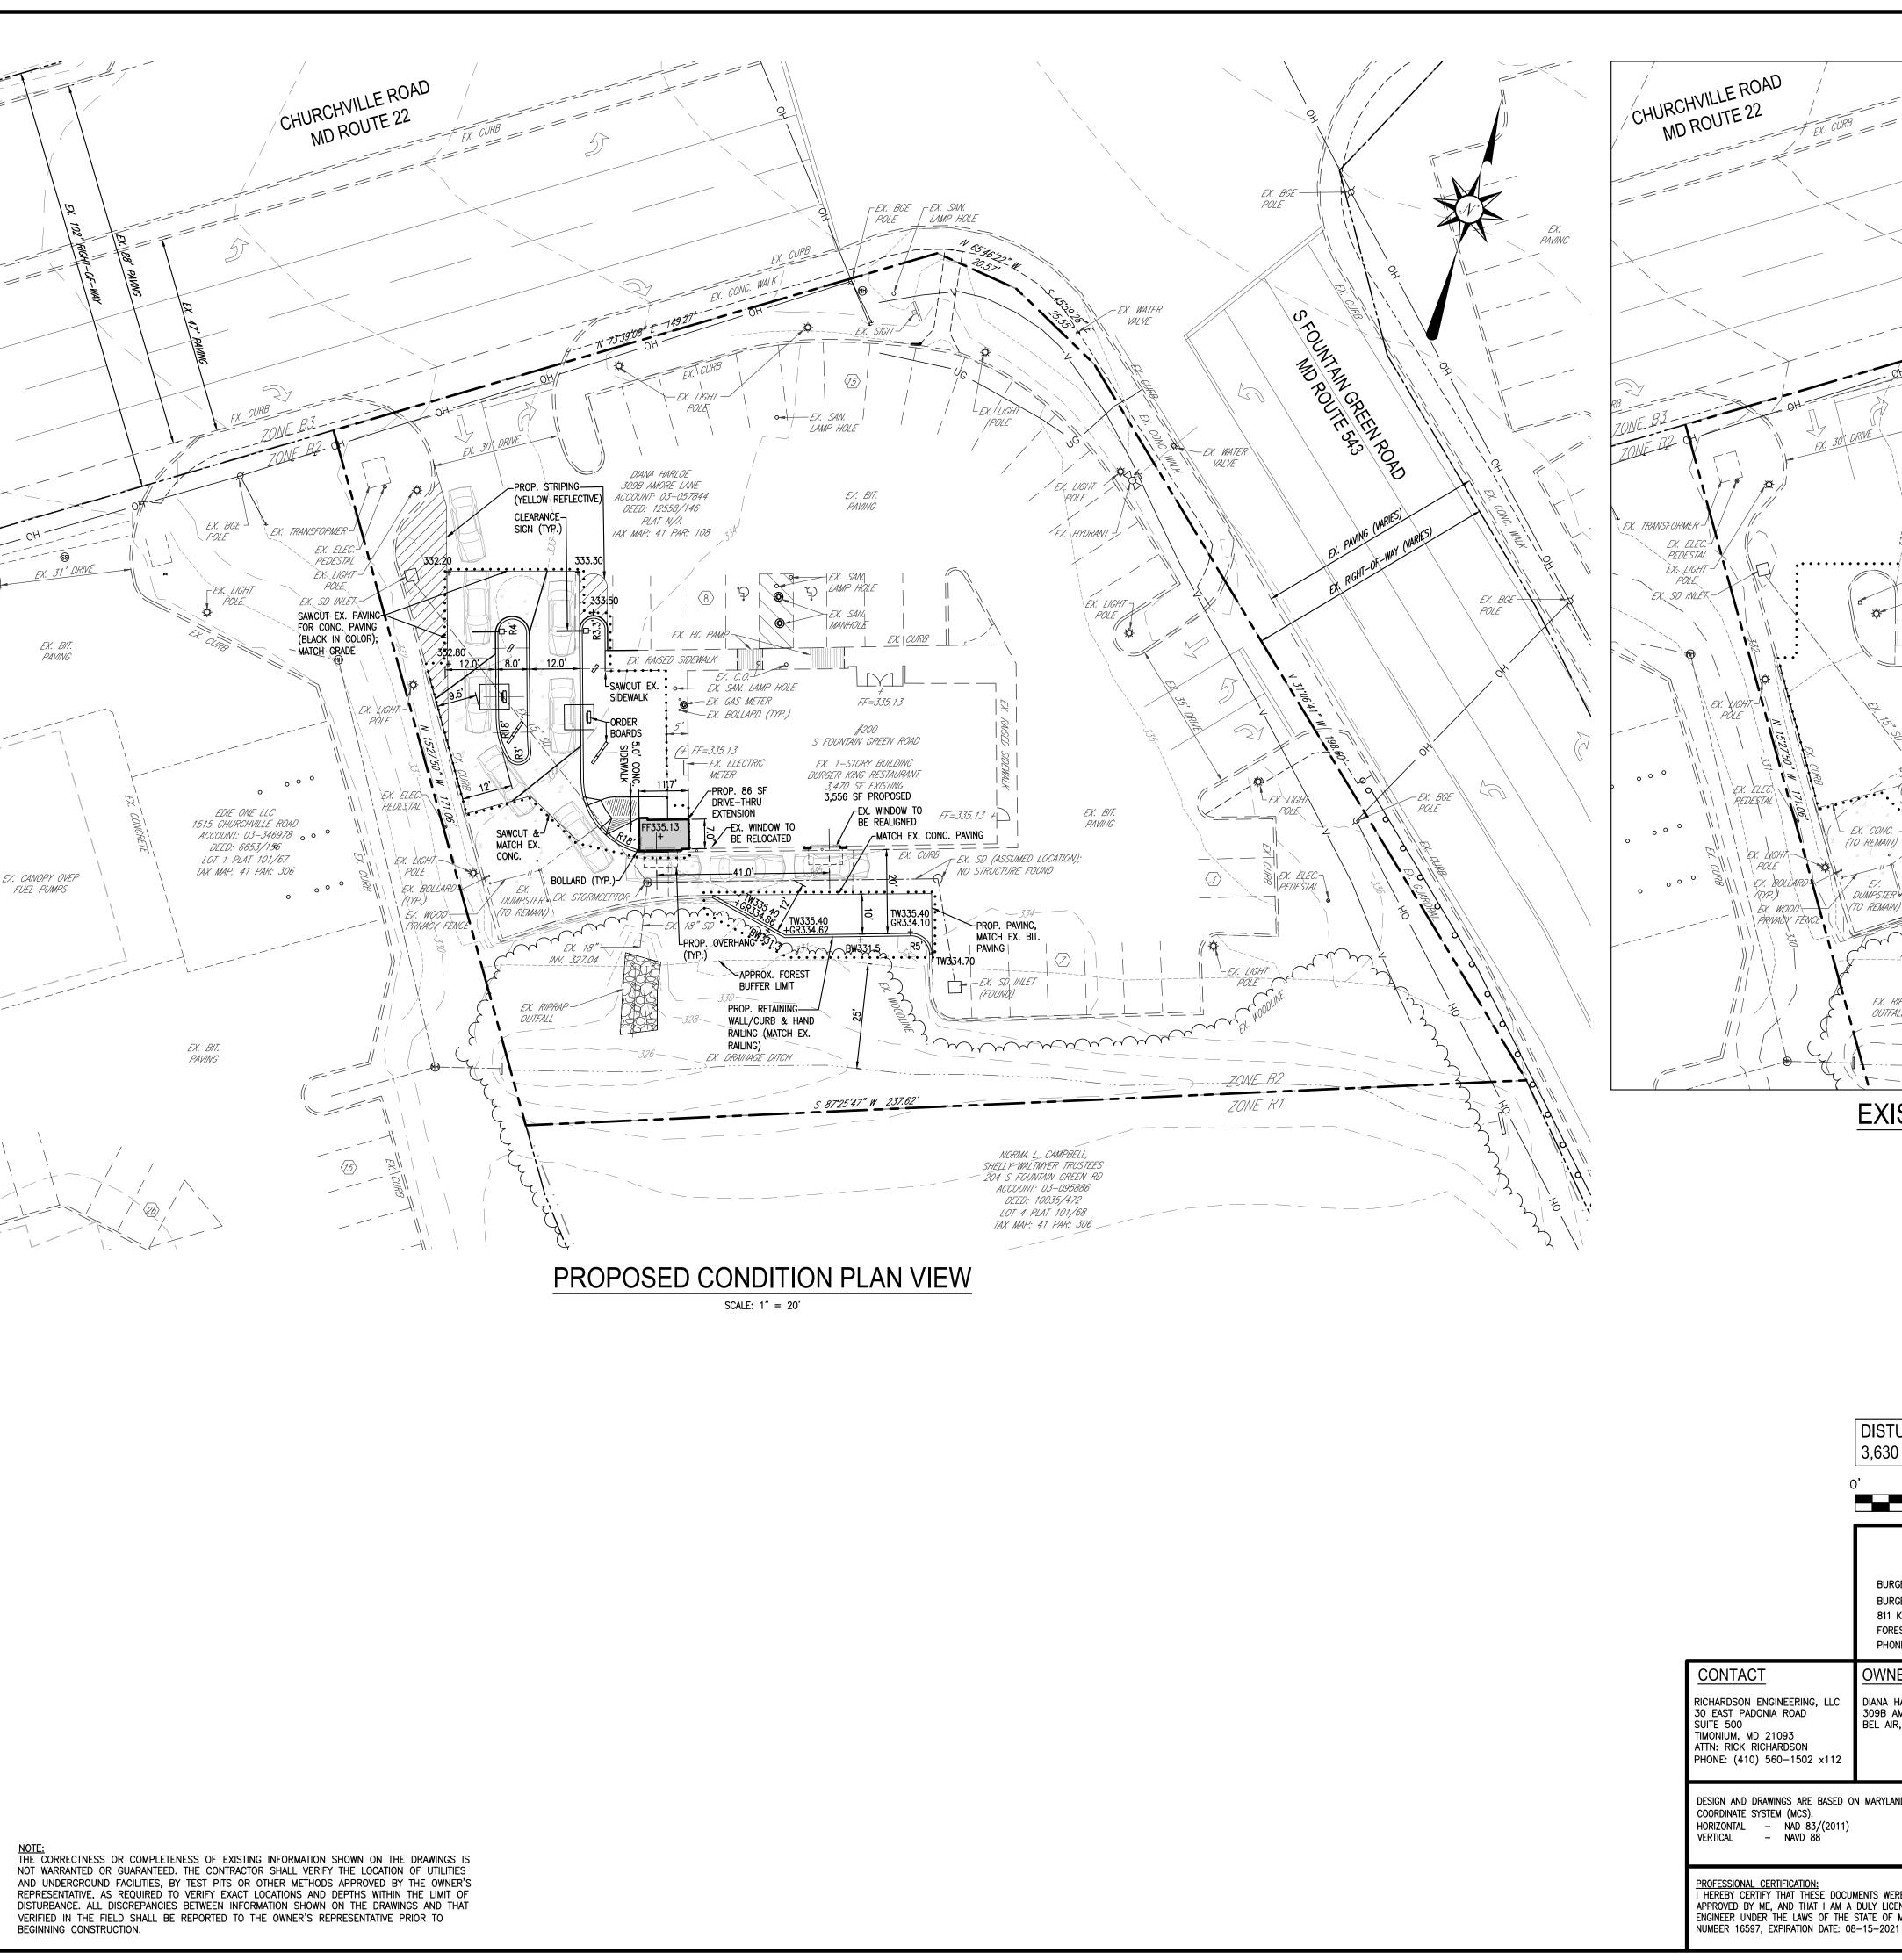

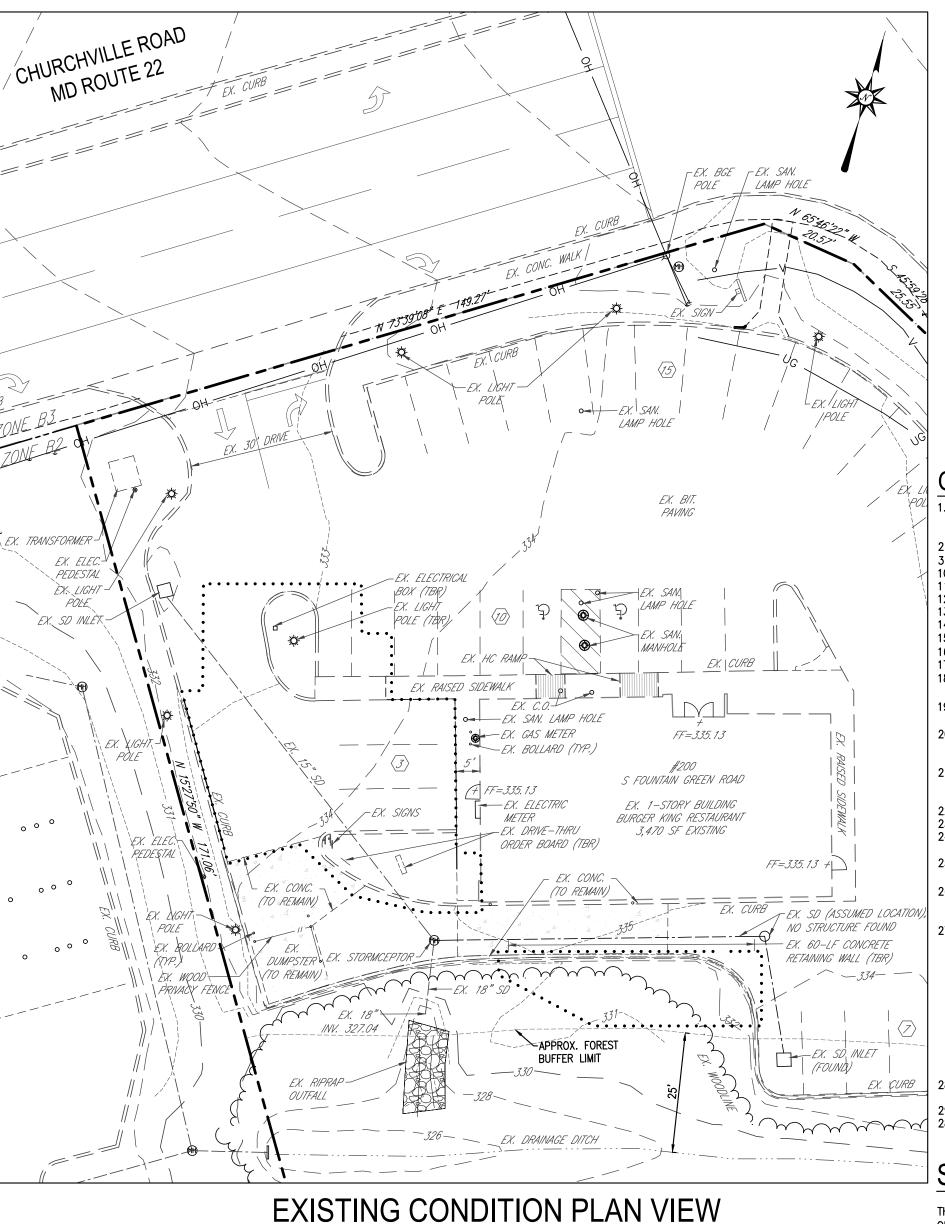

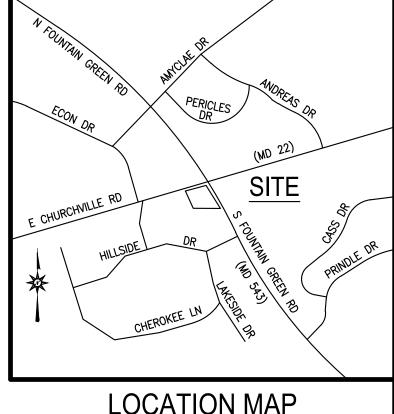

**LOCATION MAP** 

SCALE: 1" = 1000'

# **GENERAL NOTES**

GROSS AREA= 37,635 SQ.FT. OR 0.86 AC±
NET AREA= 37,635 SQ. FT. OR 0.86 AC±

. DEED REFERENCE: 12558/146 3. TAX ACCOUNT NO. 03057844 10. TAX MAP 41, GRID 4E, PARCEL 108

11. PLAT REFERENCE: NA 12. NEIGHBORHOOD: 32000.13 13. ELECTION DISTRICT: 03-23 14. COUNCILMANIC DISTRICT: E 15. LAND USE: MI (MEDIUM INTENSITY)

16. WATERSHED: BUSH RIVER 17. ZONING: B2 18. UTILITIES: EX. PUBLIC WATER / PUBLIC SEWER

PROP. (NO CHANGE) EX. RESTAURANT

PROP. (NO CHANGE) 20. BUILDING COVERAGE: 3550 SF PERMITTED: 30%

PROVIDED: 9% 21. IMPERVIOUS COVERAGE: 27,475 SF

PERMITTED: 85% PROPOSED: 73% 22. NO KNOWN PERMITS ON FILE.

23. THERE ARE NO HISTORICAL FEATURES ON SITE, NOR IS THE SITE ITSELF HISTORIC. 24. ALL PROPOSED SIGNAGE SHALL CONFORM TO THE HARFORD COUNTY ZONING REGULATIONS SECTION 267.33. 25. THIS SITE IS NOT WITHIN A FLOODPLAIN (CLASSIFIED AS FLOOD ZONE "X") PER

PANEL 24025C0162E; EFF. 04/19/16. 26. BOUNDARY AND TOPOGRAPHIC INFORMATION SHOWN HEREON WAS PREPARED BY THOMPSON & ASSOCIATES INC. ON APRIL 16, 2020, AND ALSO TAKEN FROM

COUNTY GIS TOPO. 27. PARKING CALCULATIONS (FAST-FOOD RESTAURANT):

EXISTING EXISTING = 38 SPACES (2 HANDICAP SPACE) STACKING = 7 (3 BEHIND THE ORDER BOARD) REQUIRED (1 PER 200 SF FLOOR AREA)

3,475 SF / 200 SF = 18 SPACES STACKING = 7 (5 MUST BE BEHIND ORDER BOARD)

EXISTING = 33 SPACES (2 HANDICAP SPACE)

28. THIS PLAN IS SUBJECT TO A BUILDING PERMIT SINCE THE LIMIT OF DISTURBANCE IS LESS THAN 5,000 SQ.FT. 29. LIMIT OF DISTURBANCE = 3,600 S.F.

28. ON AUGUST 4, 2020, HARFORD COUNTY APPROVED THIS PROJECT FOR A DAC

# STORMWATER MANAGEMENT NOTE

THE PROPOSED COMMERCIAL REDEVELOPMENT CONSISTS OF A 48 SF BUILDING ADDITION ONTO AN EXISTING BUILDING AND REDESIGN OF THE DRIVE-THRU TO ALLOW FOR (2) ORDER STATIONS. THE TOTAL LIMIT OF DISTURBANCE (LOD) TO COMPLETE THE PROJECT IS 3,600 SF. AS A RESULT, THIS PROJECT WILL BE EXEMPT FROM STORMWATER MANAGEMENT REQUIREMENTS SINCE THE LOD IS LESS THAN 5,000 SF.

# DAILY STABILIZATION NOTE

CONTRACTOR SHALL ONLY DISTURB THAT AREA WHICH CAN BE STABILIZED BY THE END OF THE WORK DAY. STABILIZATION SHALL BE AS FOLLOWS: 1) FOR PAVED AREAS, THE APPLICATION OF STONE BASE.

2) FOR VEGETATED AREAS,

TRAFFIC AREAS.

Richardson Engineering, LLC

a) PERMANENT SEED AND SOIL STABILIZATION MATTING OR SOD FOR ALL

STEEP SLOPES, CHANNELS OR SWALES. b) PERMANENT SEED AND MULCH FOR ALL OTHER AREAS. ANY AREAS WHICH CANNOT BE STABILIZED BY THE END OF EACH WORKING DAY MUST HAVE SILT FENCE INSTALLED ON THE DOWNSLOPE SIDE, OR STEEL PLATES FOR

DISTURBED AREA: 3,630 Sq.Ft. or 0.08 Ac.±



BURGER KING CORP. FRANCHISEE: BURGERS OF BALTIMORE, LLC 811 KENSINGTON FARM COURT FOREST HILL, MARYLAND 21050 PHONE: 410-893-1763

DIANA HARLO 309B AMORE LANE BEL AIR, MD 21015 RICHARDSON ENGINEERING, LLC 30 EAST PADONIA ROAD

**APPLICANT** BURGERS OF BALTIMORE, LLC 811 KENSINGTON FARM COURT FOREST HILL, MARYLAND 21050 ATTN: GARY EDWARDS PHONE: (410) 893-1763

DEVELOPER /

SCALE: 1" = 20'

DESIGN AND DRAWINGS ARE BASED ON MARYLAND COORDINATE SYSTEM (MCS). HORIZONTAL – NAD 83/(2011 VERTICAL – NAVD 88

PROFESSIONAL CERTIFICATION:
I HEREBY CERTIFY THAT THESE DOCUMENTS WERE PREPARED OR APPROVED BY ME, AND THAT I AM A DULY LICENSED PROFESSIONAL ENGINEER UNDER THE LAWS OF THE STATE OF MARYLAND, LICENSE



TO ACCOMPANY BUILDING PERMIT BURGER KING (STORE #10839)

200 S. FOUNTAIN GREEN ROAD BEL AIR, MD 21014

DRAWN BY:

DATE:

BTK

06/05/20


HARFORD COUNTY ELECTION DISTRICT "03-23"

REVISIONS

MARYLAND COUNCILMANIC DISTRICT "E" SCALE: CHECKED BY: PCR 1" = 20' *OB NO*.: SHEET NO.:

01 OF 01


19203

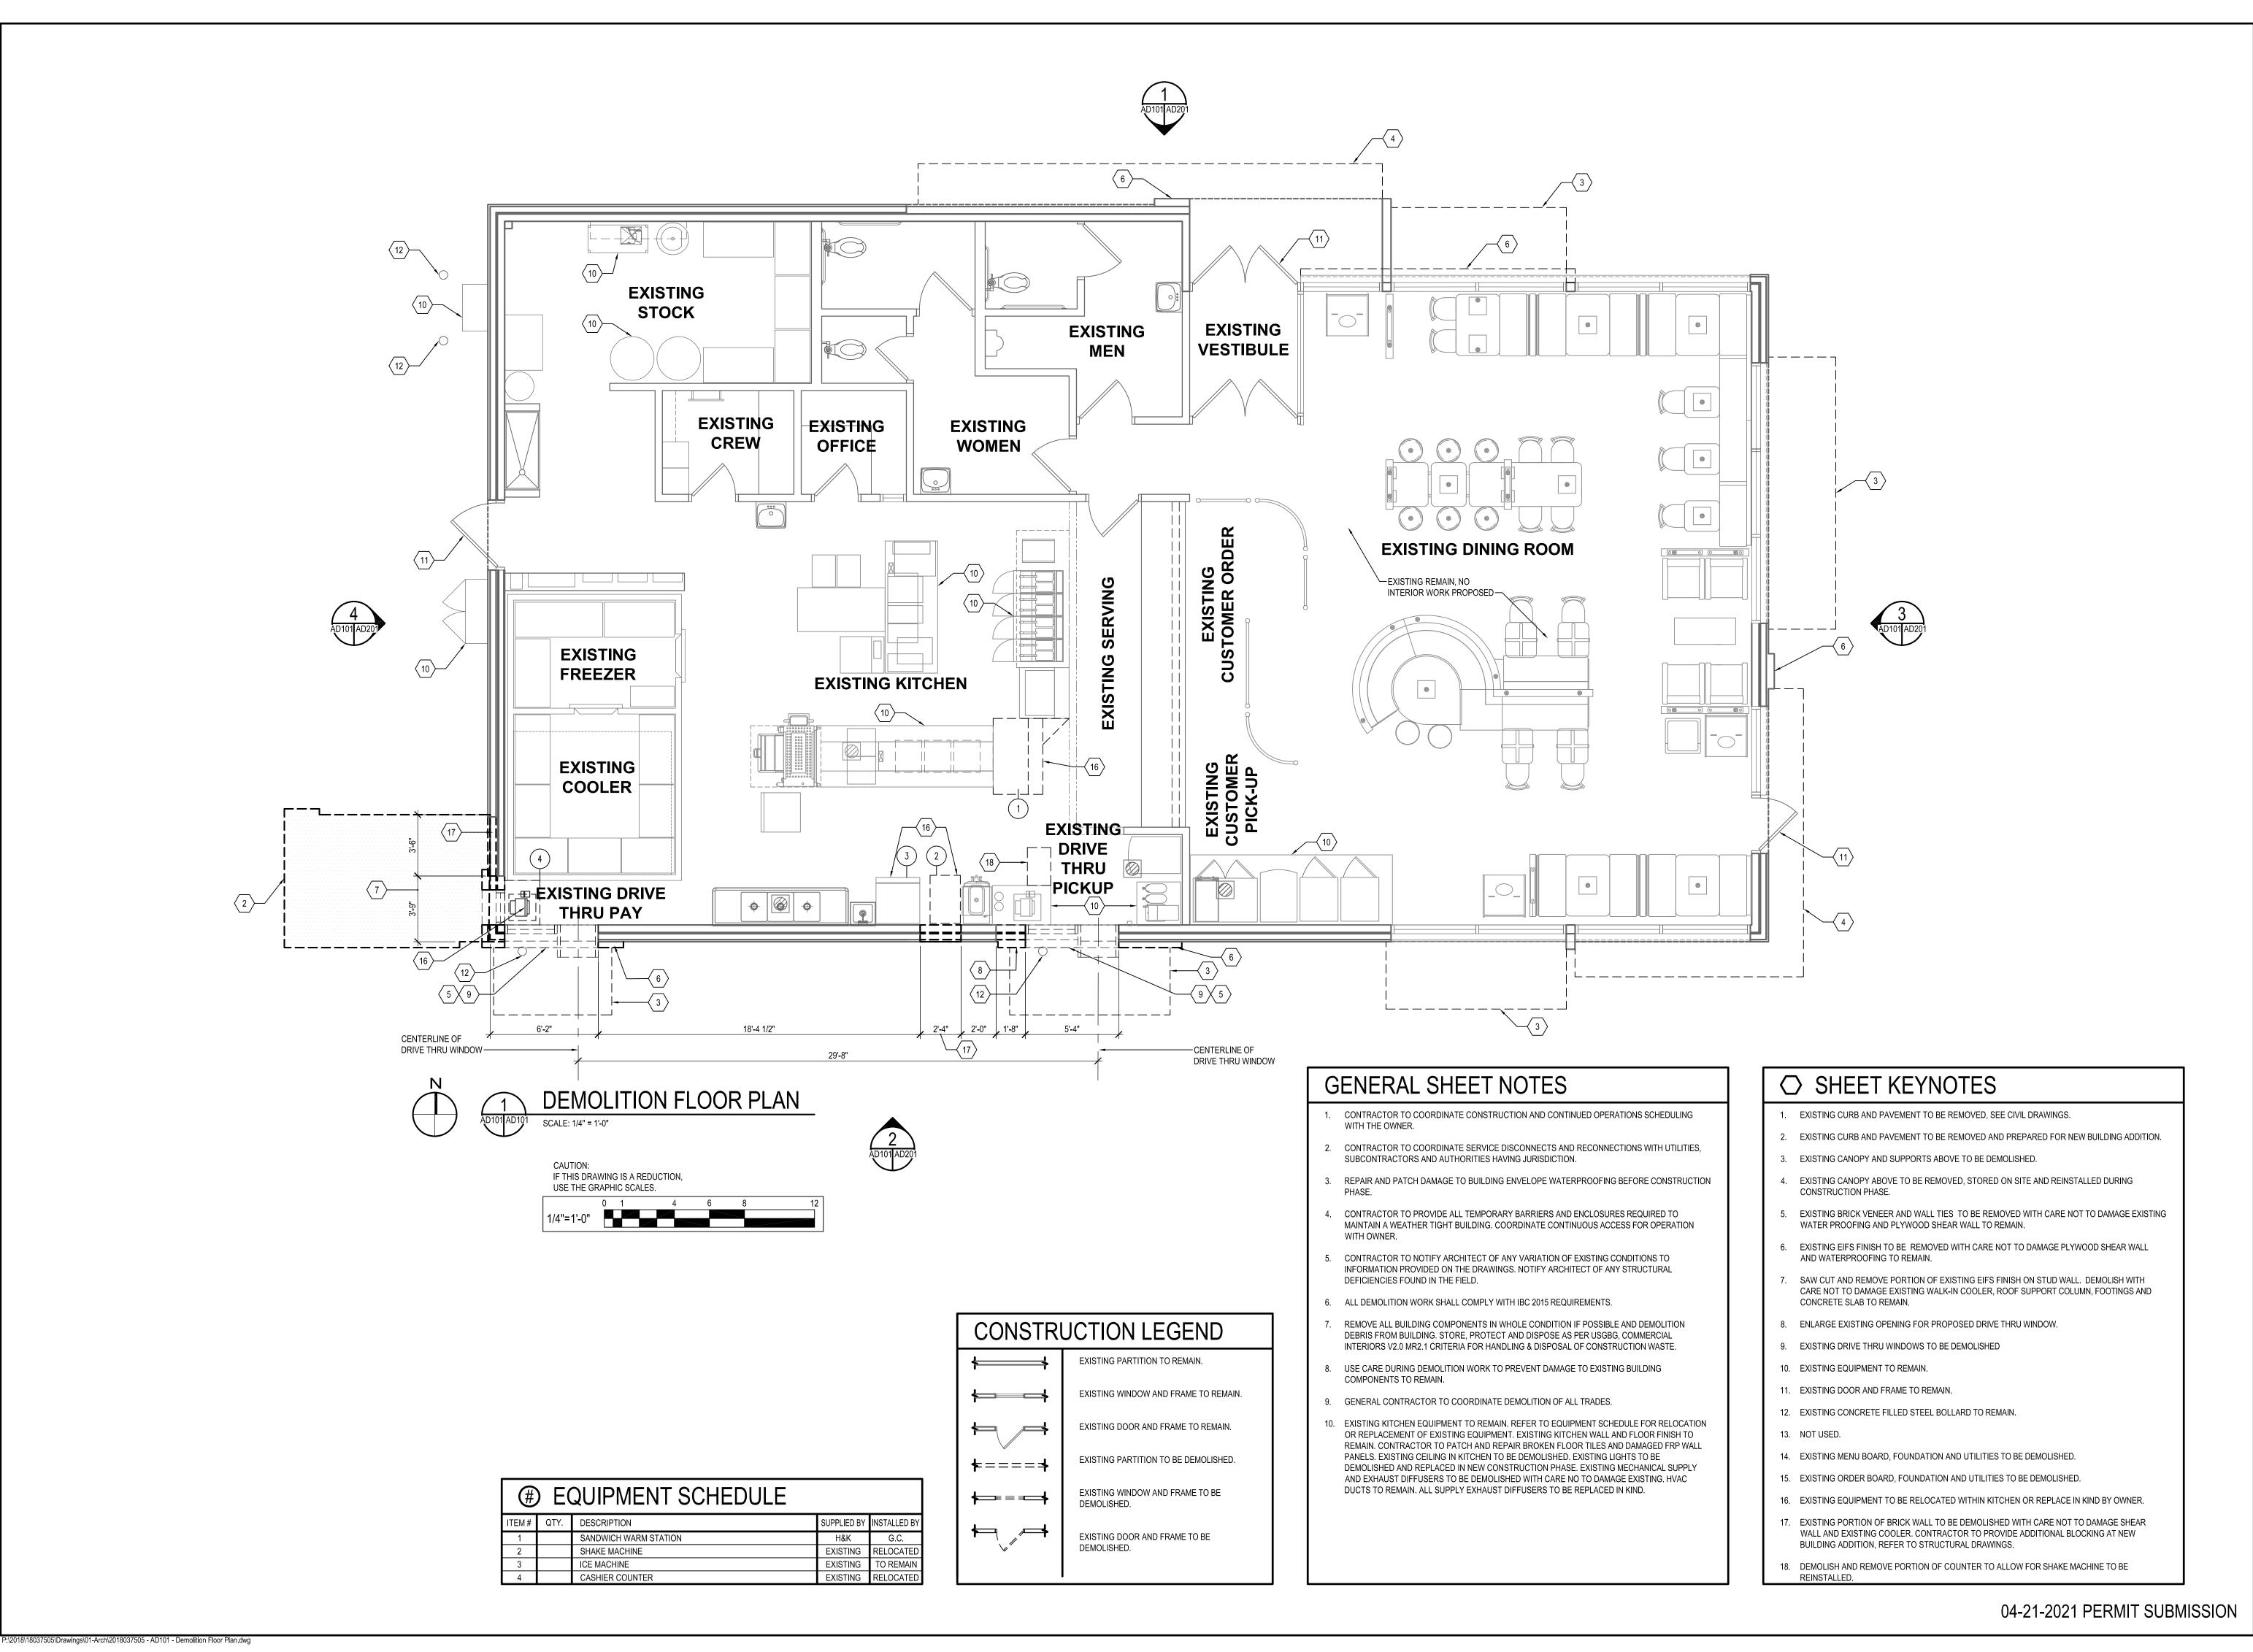

NO. DATE REVISION

LC.
00
886
Dm

Revision

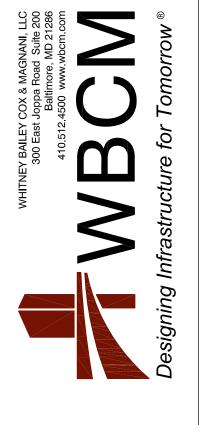

I hereby certify that these documents were prepared or approved by me, and that I am a duly licensed professional architect under the laws of the State of Maryland.

License #6140 Expiration Date: 08/21/2022

۸۸ # 10839

DEMOLITION FLOOR PLA

ALTERATIONS - BURGER KING
BURGERS OF BALTIMORE, LLC

DESIGNED: J.M.M.

DRAWN: J.M.M.

CHECKED: S.C.B.


SCALE: AS SHOWN

DATE: 04/21/2021

PROJECT: 2018.0375.05

AD101

DRAWING:

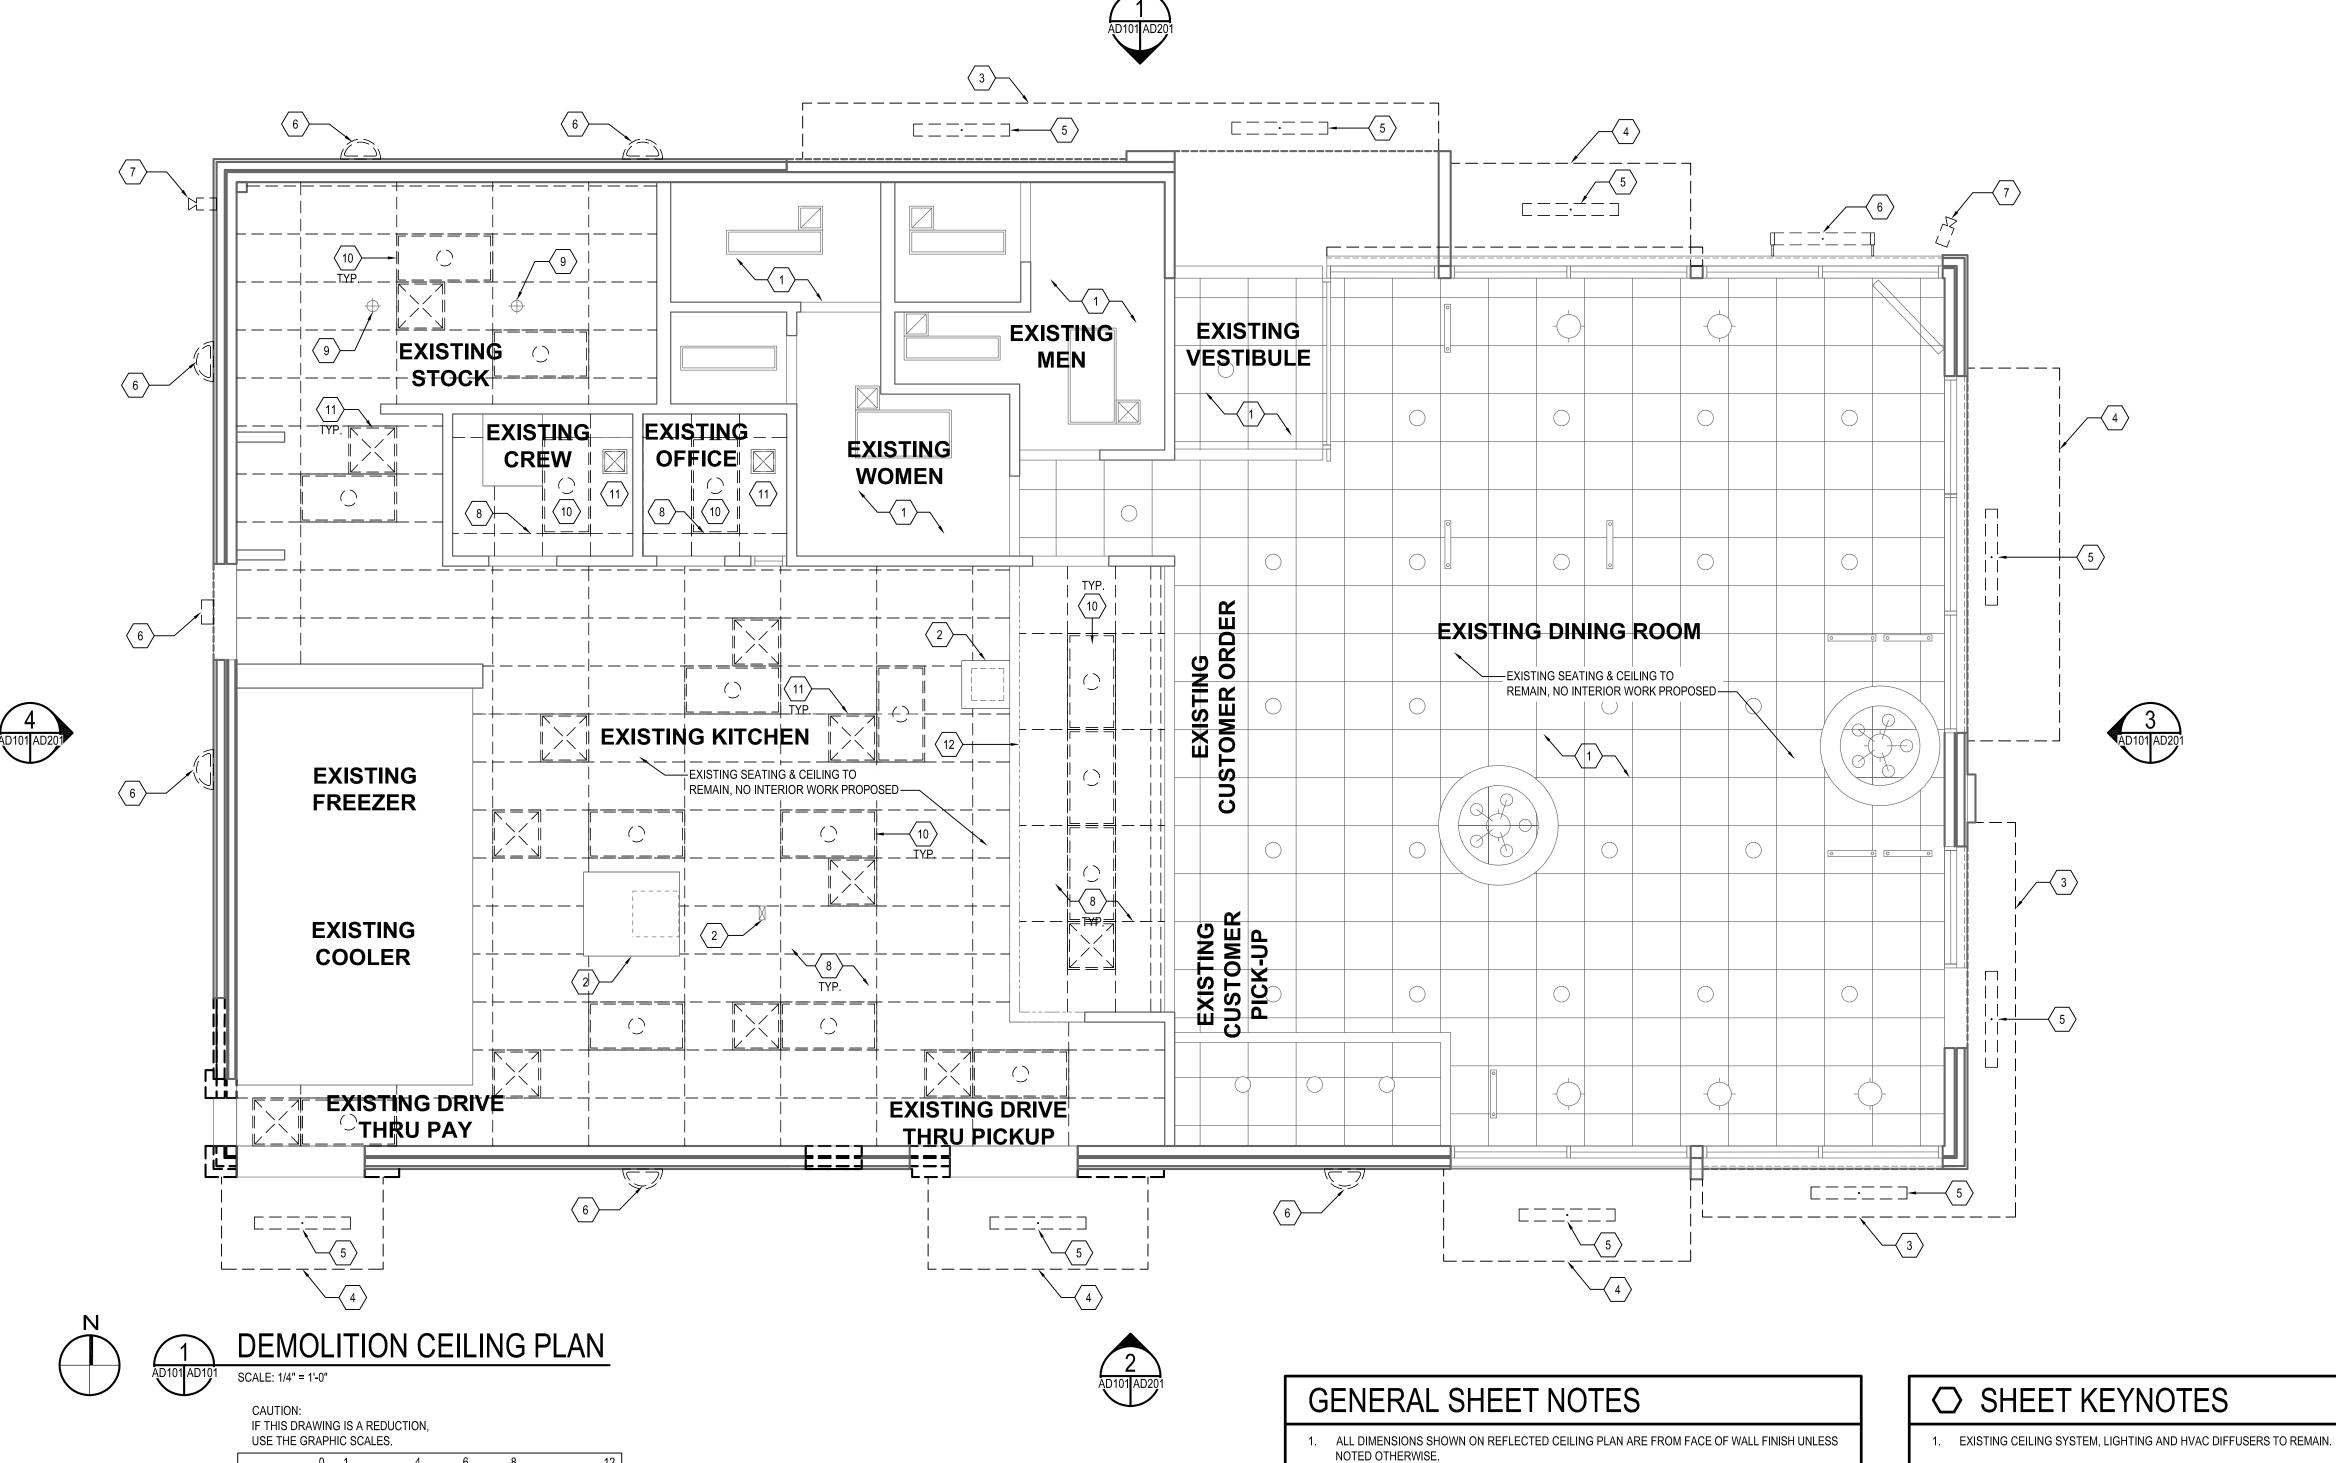

2. THE REFERENCE HEIGHTS INDICATED ON PLAN ARE FROM FINISH FLOOR (F.F.)

ADDITIONAL INFORMATION, REFER TO MECHANICAL DRAWINGS.

ADDITIONAL INFORMATION.

FOR FINISH SPECIFICATIONS.

3. CONTRACTOR SHALL VERIFY FIXTURE QUANTITIES AND ALSO MAKE PROPER ADJUSTMENTS FOR

5. ALL FIXTURES SHALL BE LOCATED IN THE CENTER OF CEILING TILES UNLESS NOTED OTHERWISE.

6. REFER TO ELECTRICAL DRAWINGS AND SCHEDULE FOR LIGHTING LAYOUT REQUIREMENTS AND

7. REFER TO FINISH SCHEDULE AND DIRECTORY OF MANUFACTURERS AND SUPPLIERS SCHEDULE

ANY CHANGES IN PLAN DUE TO ADDITIONAL REQUIREMENTS, LOCAL CODES, ETC.

4. FOR H.V.A.C. PLAN, SECTIONS, DUCT LOCATIONS, SUPPLY AND RETURN GRILLE SIZES AND

- 2. EXISTING STAINLESS STEEL FRYER, BROILER HOODS AND ELECTRICAL KITCHEN EQUIPMENT CHASE TO REMAIN.
- 3. EXISTING PRE FABRICATED CANOPY TO BE REMOVED, STORED ON SITE AND REINSTALLED
- AFTER NEW EXTERIOR WALL FINISHED WERE INSTALLED.

4. EXISTING CANOPY AND SUPPORTS TO BE REMOVED WITH CARE NOT TO DAMAGE EXISTING WALL

- FINISH TO REMAIN.
- EXISTING EXTERIOR CANOPY LIGHTING TO BE DEMOLISHED. EXISTING POWER TO REMAIN, TO BE REUSED FOR NEW LIGHTING TO BE INSTALLED. REFER TO ELECTRICAL DRAWINGS.
- 6. EXISTING EXTERIOR WALL MOUNTED BUILDING LIGHTING TO BE DEMOLISHED. EXISTING POWER TO BE REMAIN, TO BE REUSED FOR NEW LIGHTING TO BE INSTALLED. REFER TO ELECTRICAL
- 7. EXISTING WALL MOUNTED CAMERA TO BE REMOVED WITH CARE, NOT TO DAMAGE EXISTING
- EXTERIOR WALL FINISHED TO REMAIN.
- 8. EXISTING CEILING SYSTEM TO BE DEMOLISHED WITH CARE NOT TO DAMAGE EXISTING
- EQUIPMENT TO REMAIN.
- 9. EXISTING SPRINKLER HEADS TO REMAIN.
- 10. EXISTING INTERIOR LIGHTING TO BE DEMOLISHED. EXISTING POWER TO BE REMAIN, TO BE REUSED FOR NEW LIGHTING TO BE INSTALLED. REFER TO ELECTRICAL DRAWINGS.
- 11. EXISTING MECHANICAL SUPPLY AND EXHAUST DIFFUSERS TO BE DEMOLISHED WITH CARE NOT TO DAMAGE EXISTING HVAC DUCTS TO REMAIN. REFER TO MECHANICAL DRAWINGS.
- 12. EXISTING SURFACE MOUNTED MENU BOARD TO REMAIN.

NEW TOTAL						
2						
	I, LLC	21286	_	_	® <b>∧</b>	



I hereby certify that these documents were prepared or approved by me, and that I am a duly licensed professional architect under the laws of the State of Maryland.


License #6140 Expiration Date: 08/21/2022

CEILING

BURGER KING ALTERATIONS


**EXISTING REFLECTED** 

DESIGNED:	J.M.M.	
DRAWN:	J.M.M.	
CHECKED:	S.C.B.	
SCALE:	AS SHOWN	
DATE:	04/21/2021	
PROJECT:	2018.0375.05	
DRAWING:		

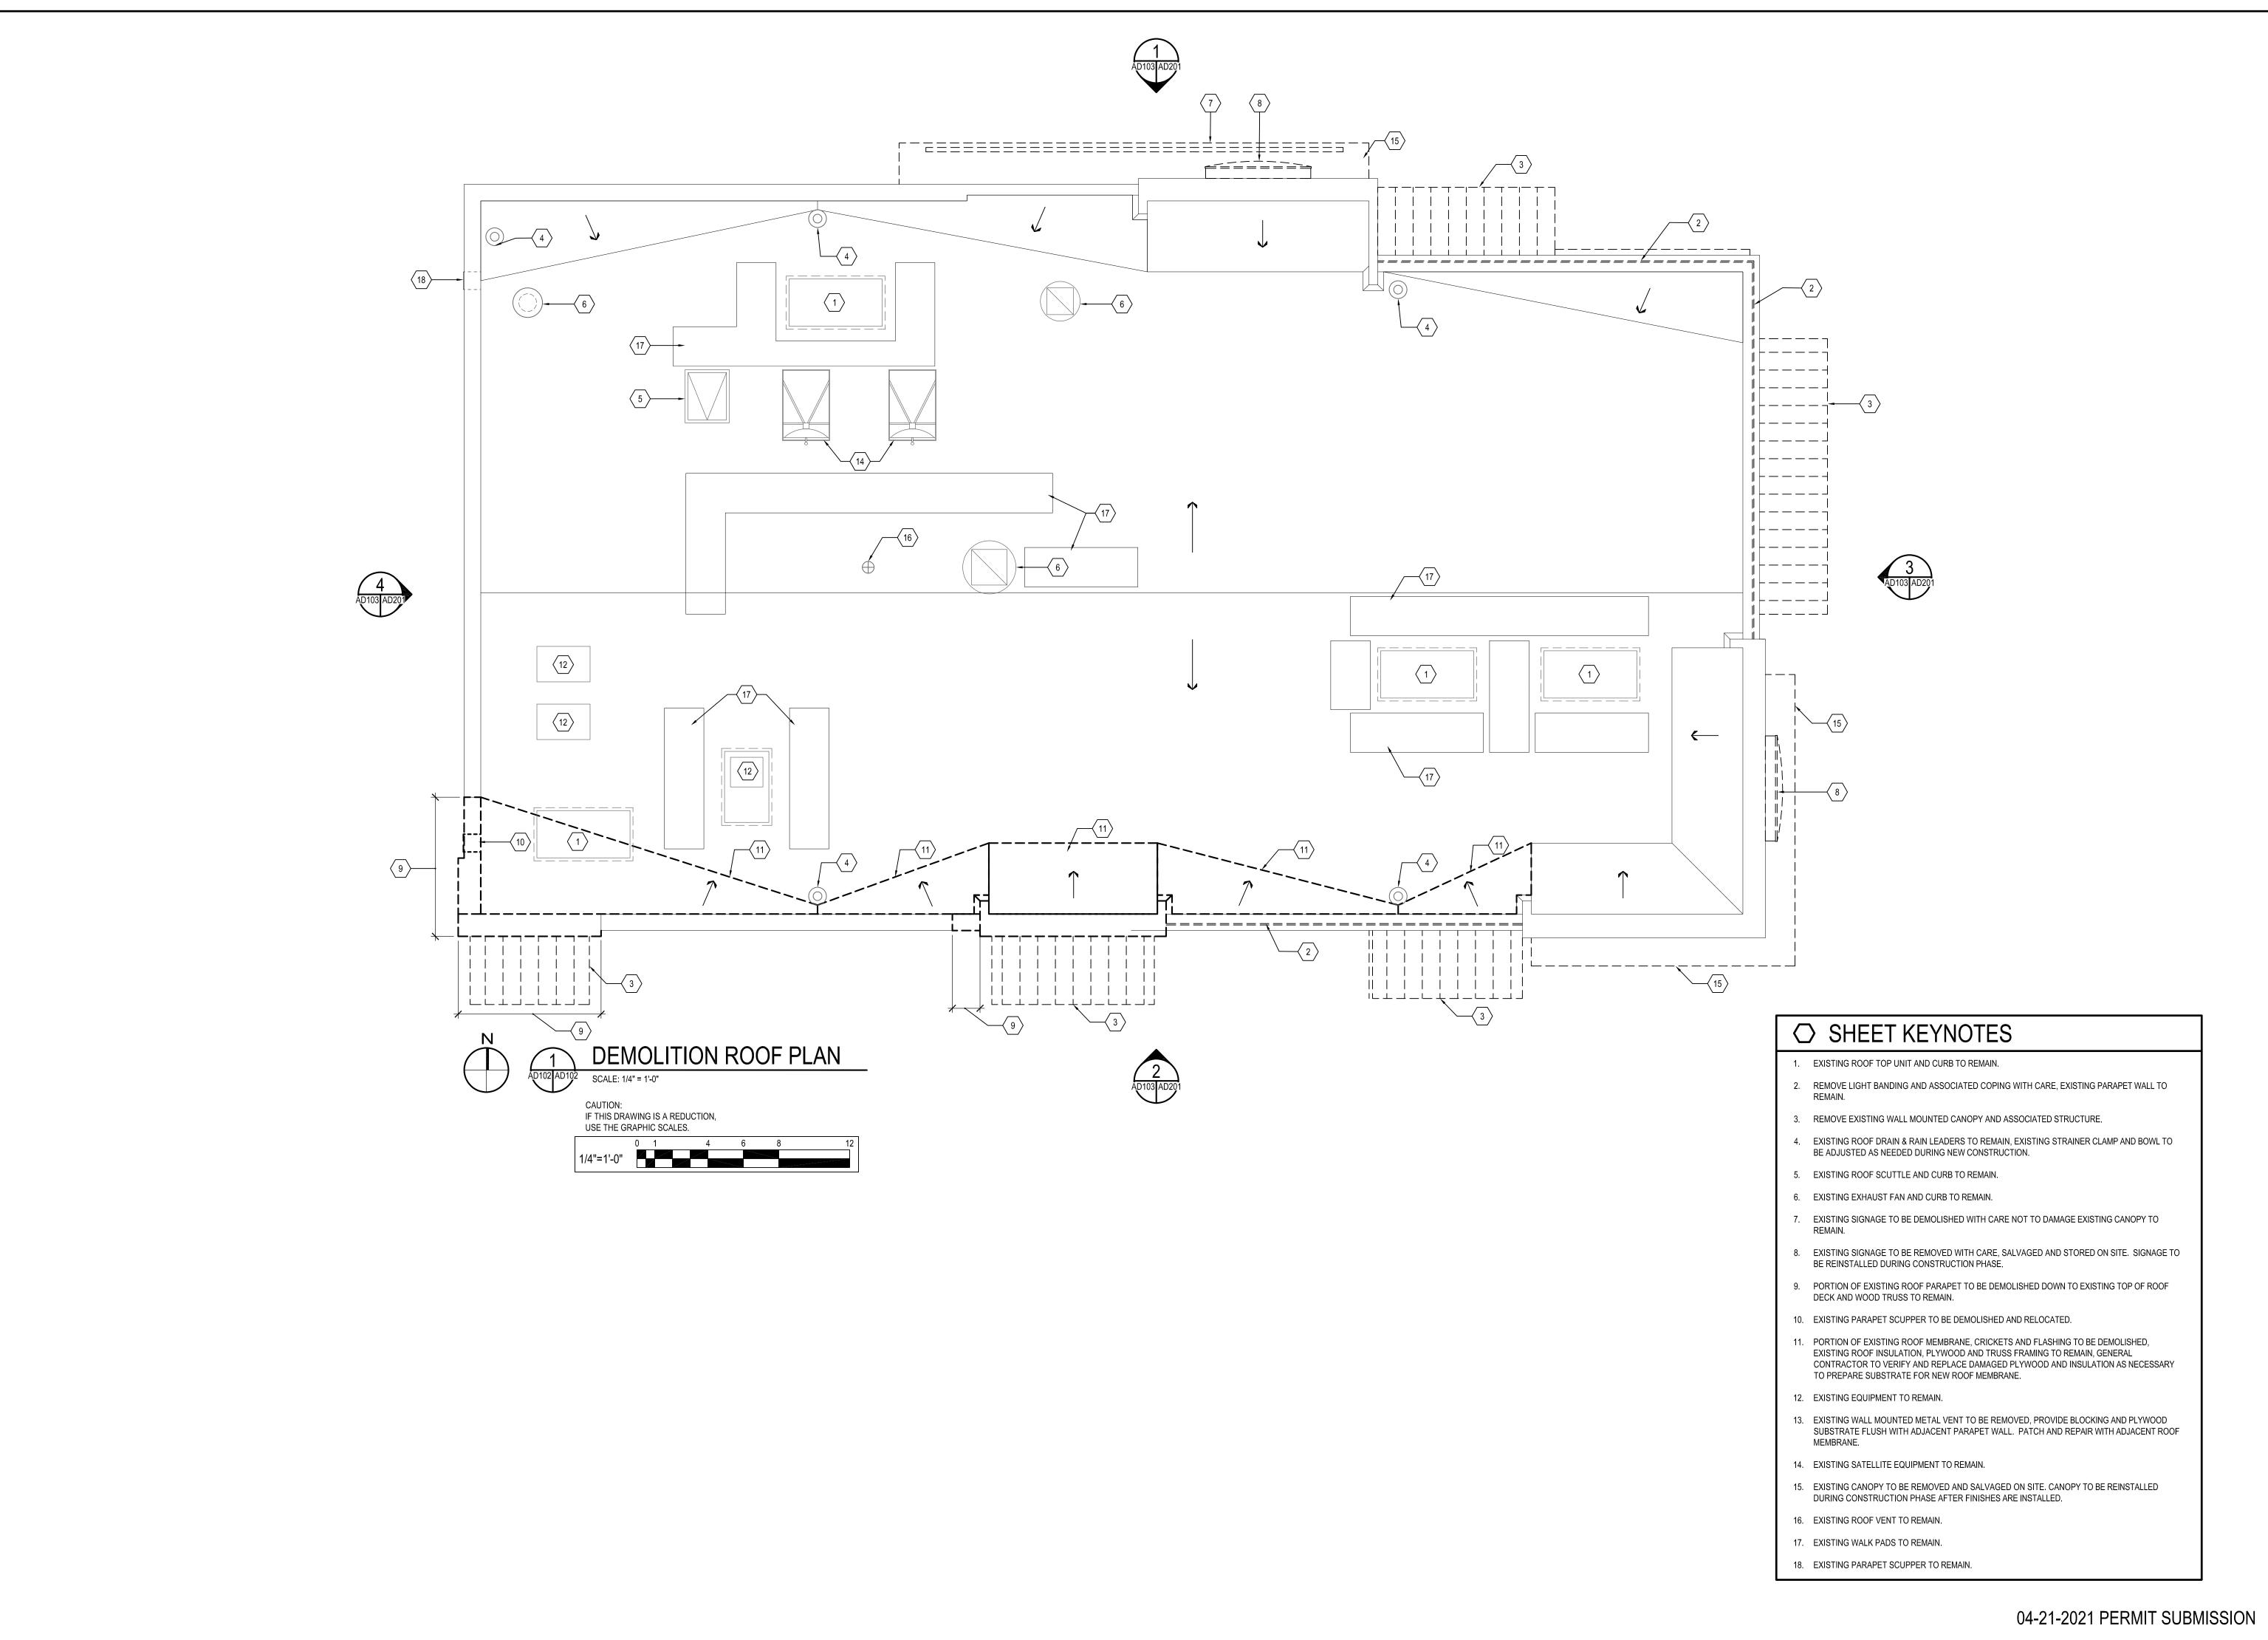

P:\2018\18037505\Drawings\01-Arch\2018037505 - AD103 - Existing Roof Plan.dwg

NO. DATE REVISION BY

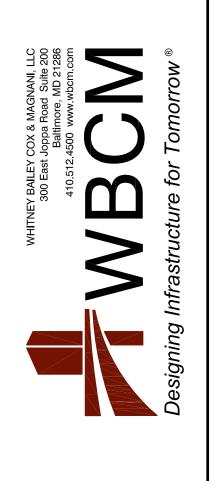

I hereby certify that these documents were prepared or approved by me, and that I am a duly licensed professional architect under the laws of the State of Maryland.

License #6140 Expiration Date: 08/21/2022


EXISTING ROOF PLAN

TERATIONS - BURGER KING # 10839

BURGERS OF BALTIMORE, LLC.
200 SOUTH FOUNTAIN GREEN ROAD

DESIGNED:	J.M.M.
DRAWN:	J.M.M.
CHECKED:	S.C.B.
SCALE:	AS SHOWN
DATE:	04/21/2021
PROJECT:	2018.0375.05
DRAWING:	

AD103

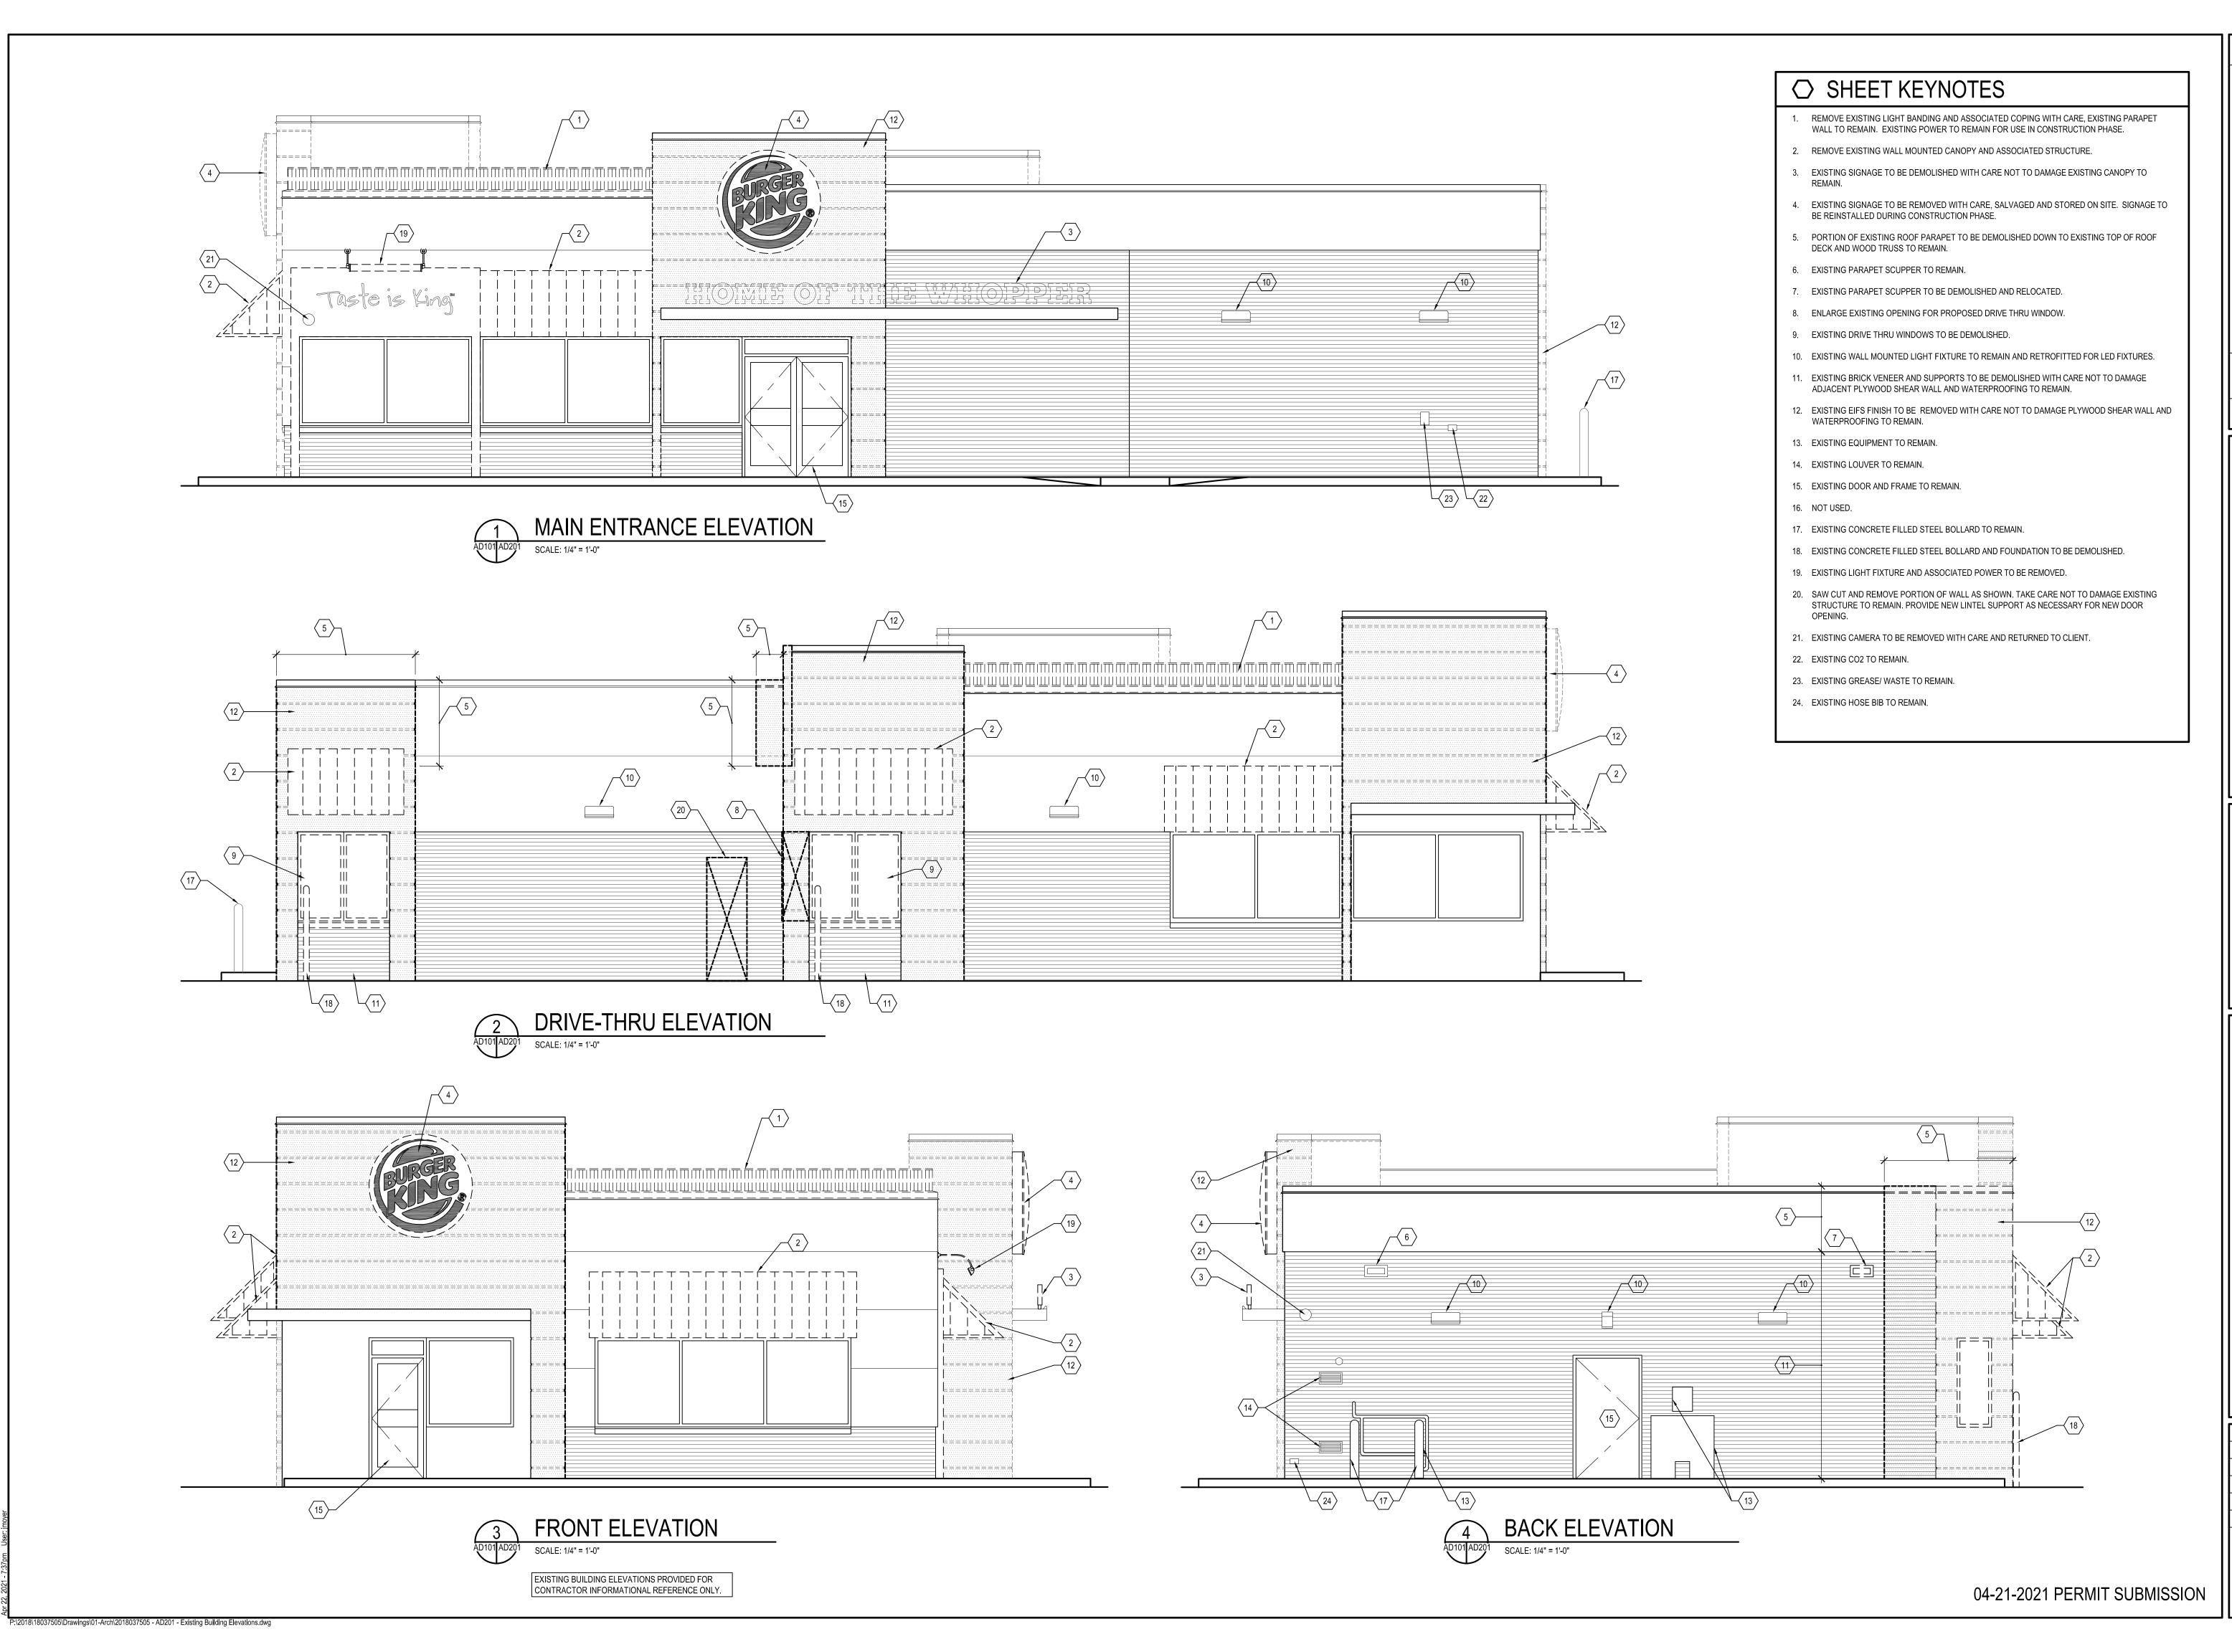

WHITNEY BAILEY COX & MAGNANI, LLC
300 East Joppa Road Suite 200
Baltimore, MD 21286
410.512.4500 www.wbcm.com

Signing Infrastructure for Tomorrow®

I hereby certify that these documents were prepared or approved by me, and that I am a duly licensed professional architect under the laws of the State of Maryland.

License #6140 Expiration Date: 08/21/2022

ALTERATIONS - BURGER KING # 10839

BURGERS OF BALTIMORE, LLC.

DESIGNED: J.M.M.

DRAWN: J.M.M.

CHECKED: S.C.B.


SCALE: AS SHOWN


DATE: 04/21/2021

PROJECT: 2018.0375.05

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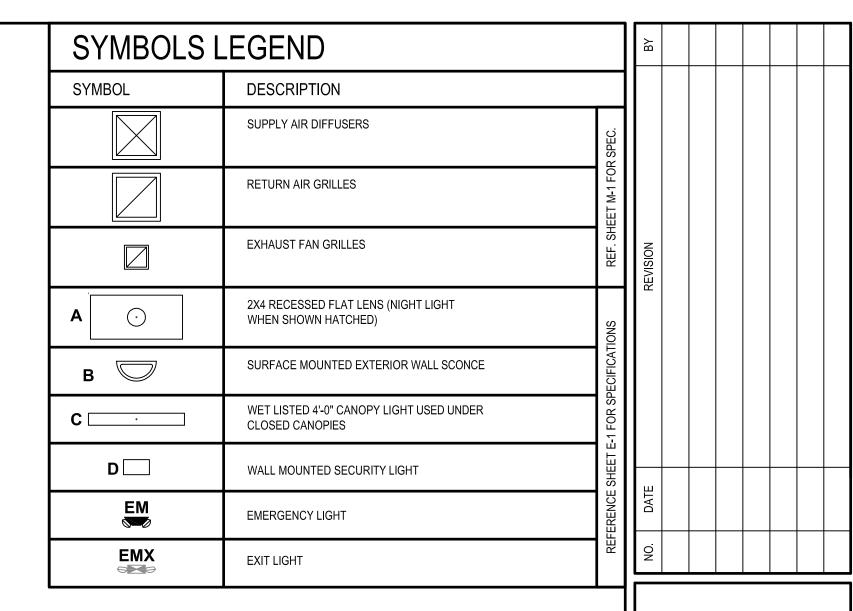


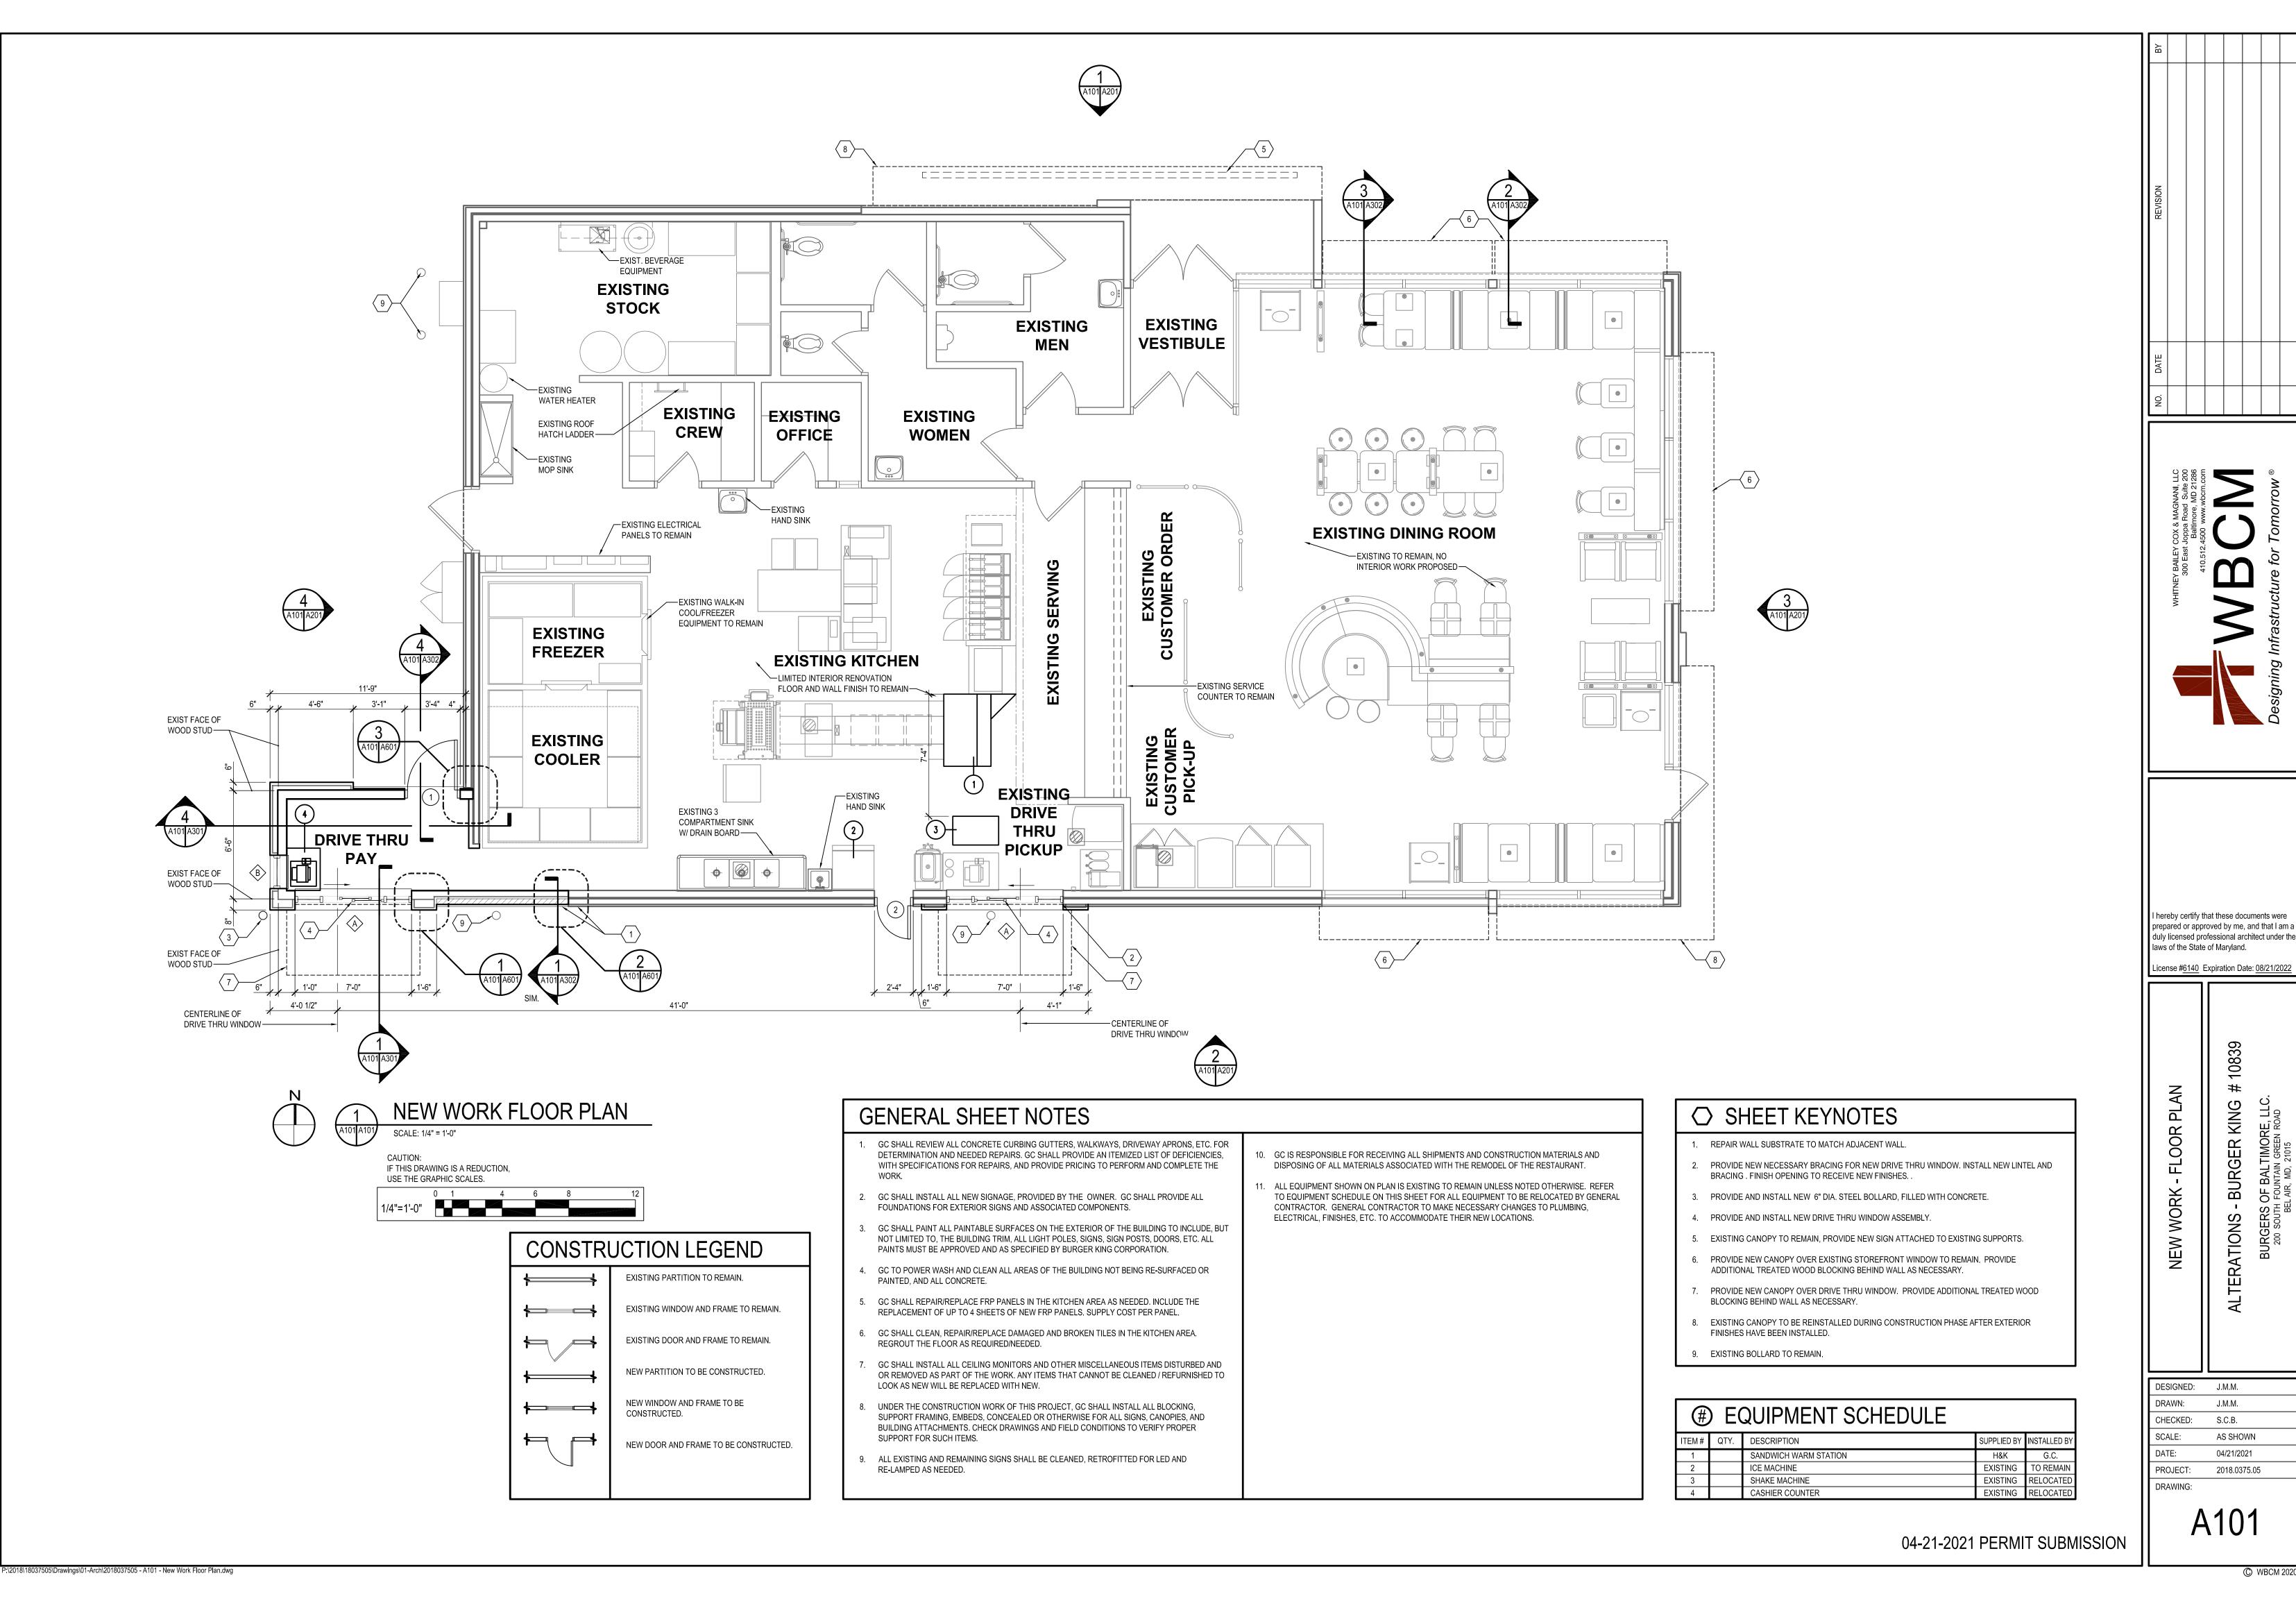

NEW WORK CEILING PLAN

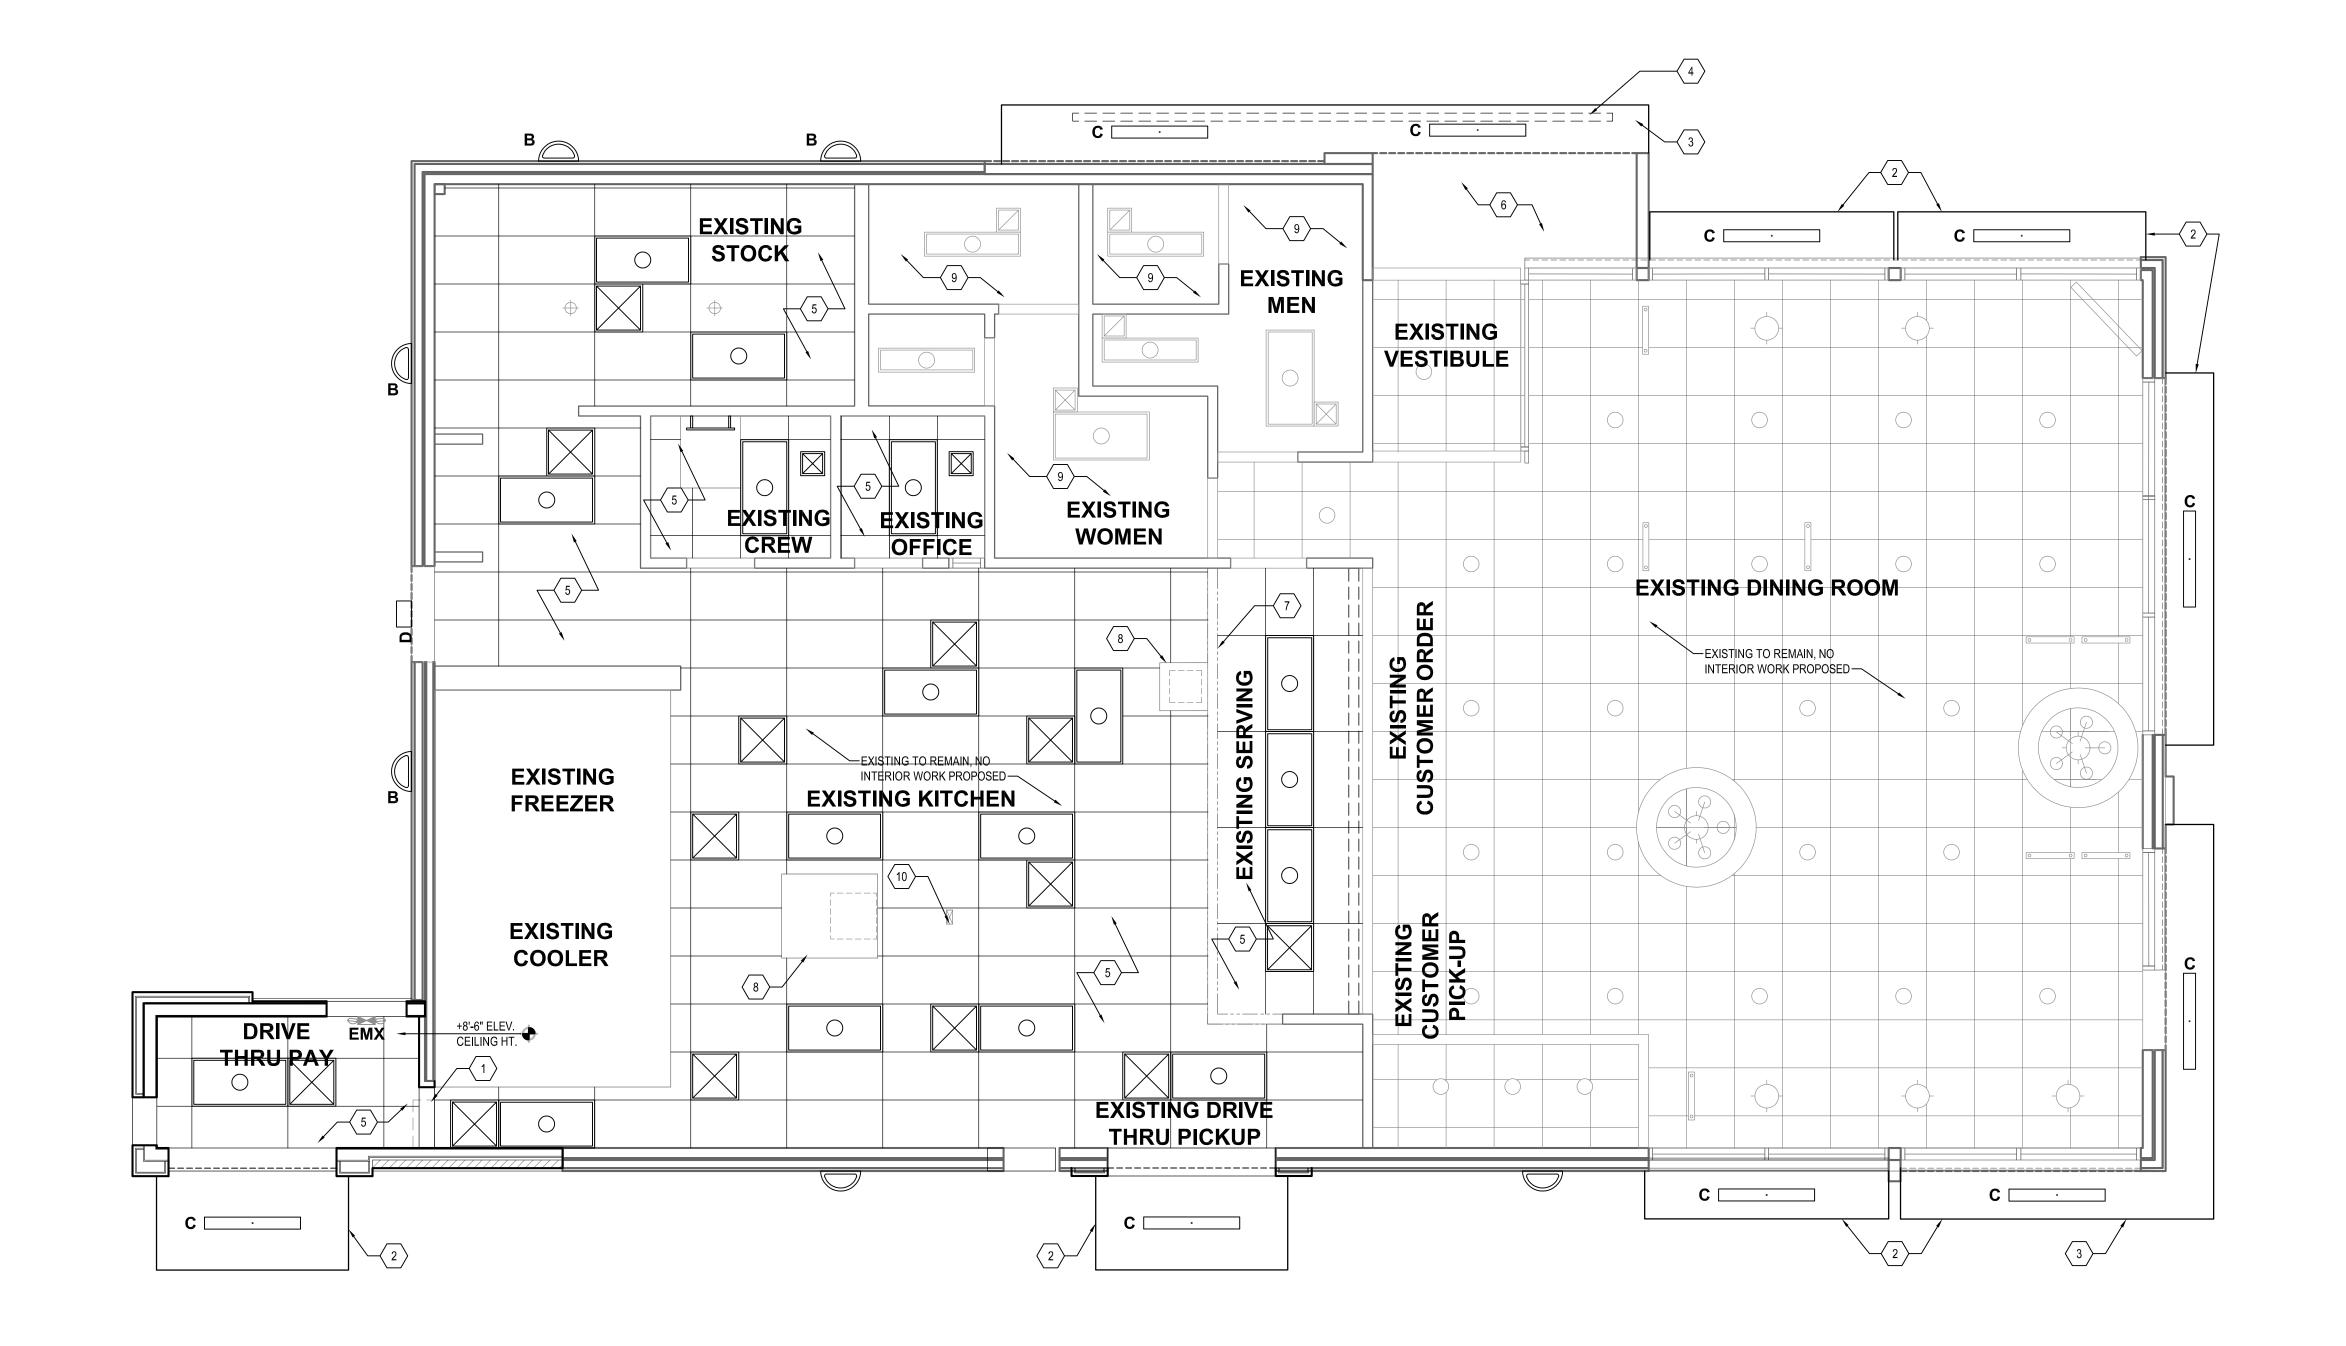SCALE: 1/4" = 1'-0"

IF THIS DRAWING IS A REDUCTION, USE THE GRAPHIC SCALES.



# GENERAL SHEET NOTES

- 1. ALL DIMENSIONS SHOWN ON REFLECTED CEILING PLAN ARE FROM FACE OF WALL FINISH UNLESS NOTED OTHERWISE.
- 2. THE REFERENCE HEIGHTS INDICATED ON PLAN ARE FROM FINISH FLOOR (F.F.)
- 4. FOR H.V.A.C. PLAN, SECTIONS, DUCT LOCATIONS, SUPPLY AND RETURN GRILLE SIZES AND ADDITIONAL INFORMATION, REFERENCE SHEET M-1.
- 5. ALL FIXTURES SHALL BE LOCATED IN THE CENTER OF CEILING TILES UNLESS NOTED OTHERWISE.
- 6. REFERENCE SHEET E-1 FOR LIGHTING LAYOUT REQUIREMENTS AND ADDITIONAL INFORMATION.
- 7. PERFORM MAINTENANCE AND CLEANING OF EXISTING EQUIPMENT, MECHANICAL UNITS, AND DUCTWORK BEFORE REINSTALLATION OF CEILING AND DIFFUSERS.

# ○ SHEET KEYNOTES

- 1. PROVIDE NEW GYPSUM BOARD BULKHEAD AT OPENING.
- 2. PROVIDE AND INSTALL NEW PREFABRICATED METAL CANOPY.
- 4. PROVIDE NEW SIGN ATTACHED TO EXISTING SUPPORTS ON EXISTING CANOPY.
- 5. NEW SUSPENDED ACOUSTIC CEILING SYSTEM TO BE INSTALLED. NEW CEILING GRID AND PANELS TO BE ALIGNED WITH EXISTING HVAC SUPPLY AND EXHAUST DUCTS TO REMAIN. NEW ACOUSTIC CEILING PANEL FINISH TO BE CERTAINTEED, VINYROCK, 24"X48" MODEL NO. 1140-CFR.
- 6. VESTIBULE SOFFIT ABOVE ENTRY, CEILING PAINT TO MATCH INTERIOR CEILING.
- 7. NEW MENU BOARD, REFER TO INTERIOR DECOR. DRAWINGS.
- 8. EXISTING MECHANICAL EXHAUST HOOD ABOVE TO REMAIN.
- 9. EXISTING GYPSUM BOARD CEILING TO REMAIN, PROVIDE NEW PAINT FINISH. EXISTING LIGHTS AND DIFFUSERS TO REMAIN.
- 10. ELECTRICAL EQUIPMENT CHASE TO REMAIN.

- CONTRACTOR SHALL VERIFY FIXTURE QUANTITIES AND ALSO MAKE PROPER ADJUSTMENTS FOR ANY CHANGES IN PLAN DUE TO ADDITIONAL REQUIREMENTS, LOCAL CODES, ETC.

- EXISTING PREFABRICATED METAL CANOPY TO REMAIN. REINSTALL AFTER EXTERIOR WALL FINISHES ARE INSTALLED

hereby certify that these documents were prepared or approved by me, and that I am a duly licensed professional architect under the laws of the State of Maryland.

License #6140 Expiration Date: 08/21/2022

ALTERATIONS - BURGER KING

REFLECTED CEILING PLAN


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l	DESIGNED:	J.M.M.
l	DRAWN:	J.M.M.
l	CHECKED:	S.C.B.
l	SCALE:	AS SHOWN
l	DATE:	04/21/2021
l	PROJECT:	2018.0375.05
1	DRAWING:	
1		

A102

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04-21-2021 PERMIT SUBMISSION

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# GENERAL NOTES

- A. THE EXISTING ROOF STRUCTURE SHALL NOT BE USED FOR STOCKPILING OF EQUIPMENT OR MATERIALS UNLESS APPROVED BY THE ARCHITECT, STRUCTURAL ENGINEER AND THE JOIST MANUFACTURER.
- B. THE ROOFING SYSTEM SHALL BE AS PER DRAWINGS AND PER MANUFACTURERS
- C. COORDINATE ROOF ELEVATIONS WITH EXISTING ROOF STRUCTURE AND EXISTING OPENING FOR MECHANICAL EQUIPMENT. REFER TO SPECIFICATION SHEET FOR ROOF RELATED ITEMS, INCLUDING GUARANTEES, CURBS, FLASHING, ETC.
- D. PER AS-BUILT DRAWINGS, EXISTING ROOF INSULATION, IS 1 1/2" THICK. REPLACEMENT INSULATION FOR NEW ROOFING SYSTEM MAY BE 6" THICK TO PROVIDE AN R-30. MODIFY EXISTING ROOF TOP EQUIPMENT SUPPORTS, ETC. TO ACCOMMODATE THIS INCREASE IN THICKNESS.
- E. MINIMUM CURB HEIGHT: 8"

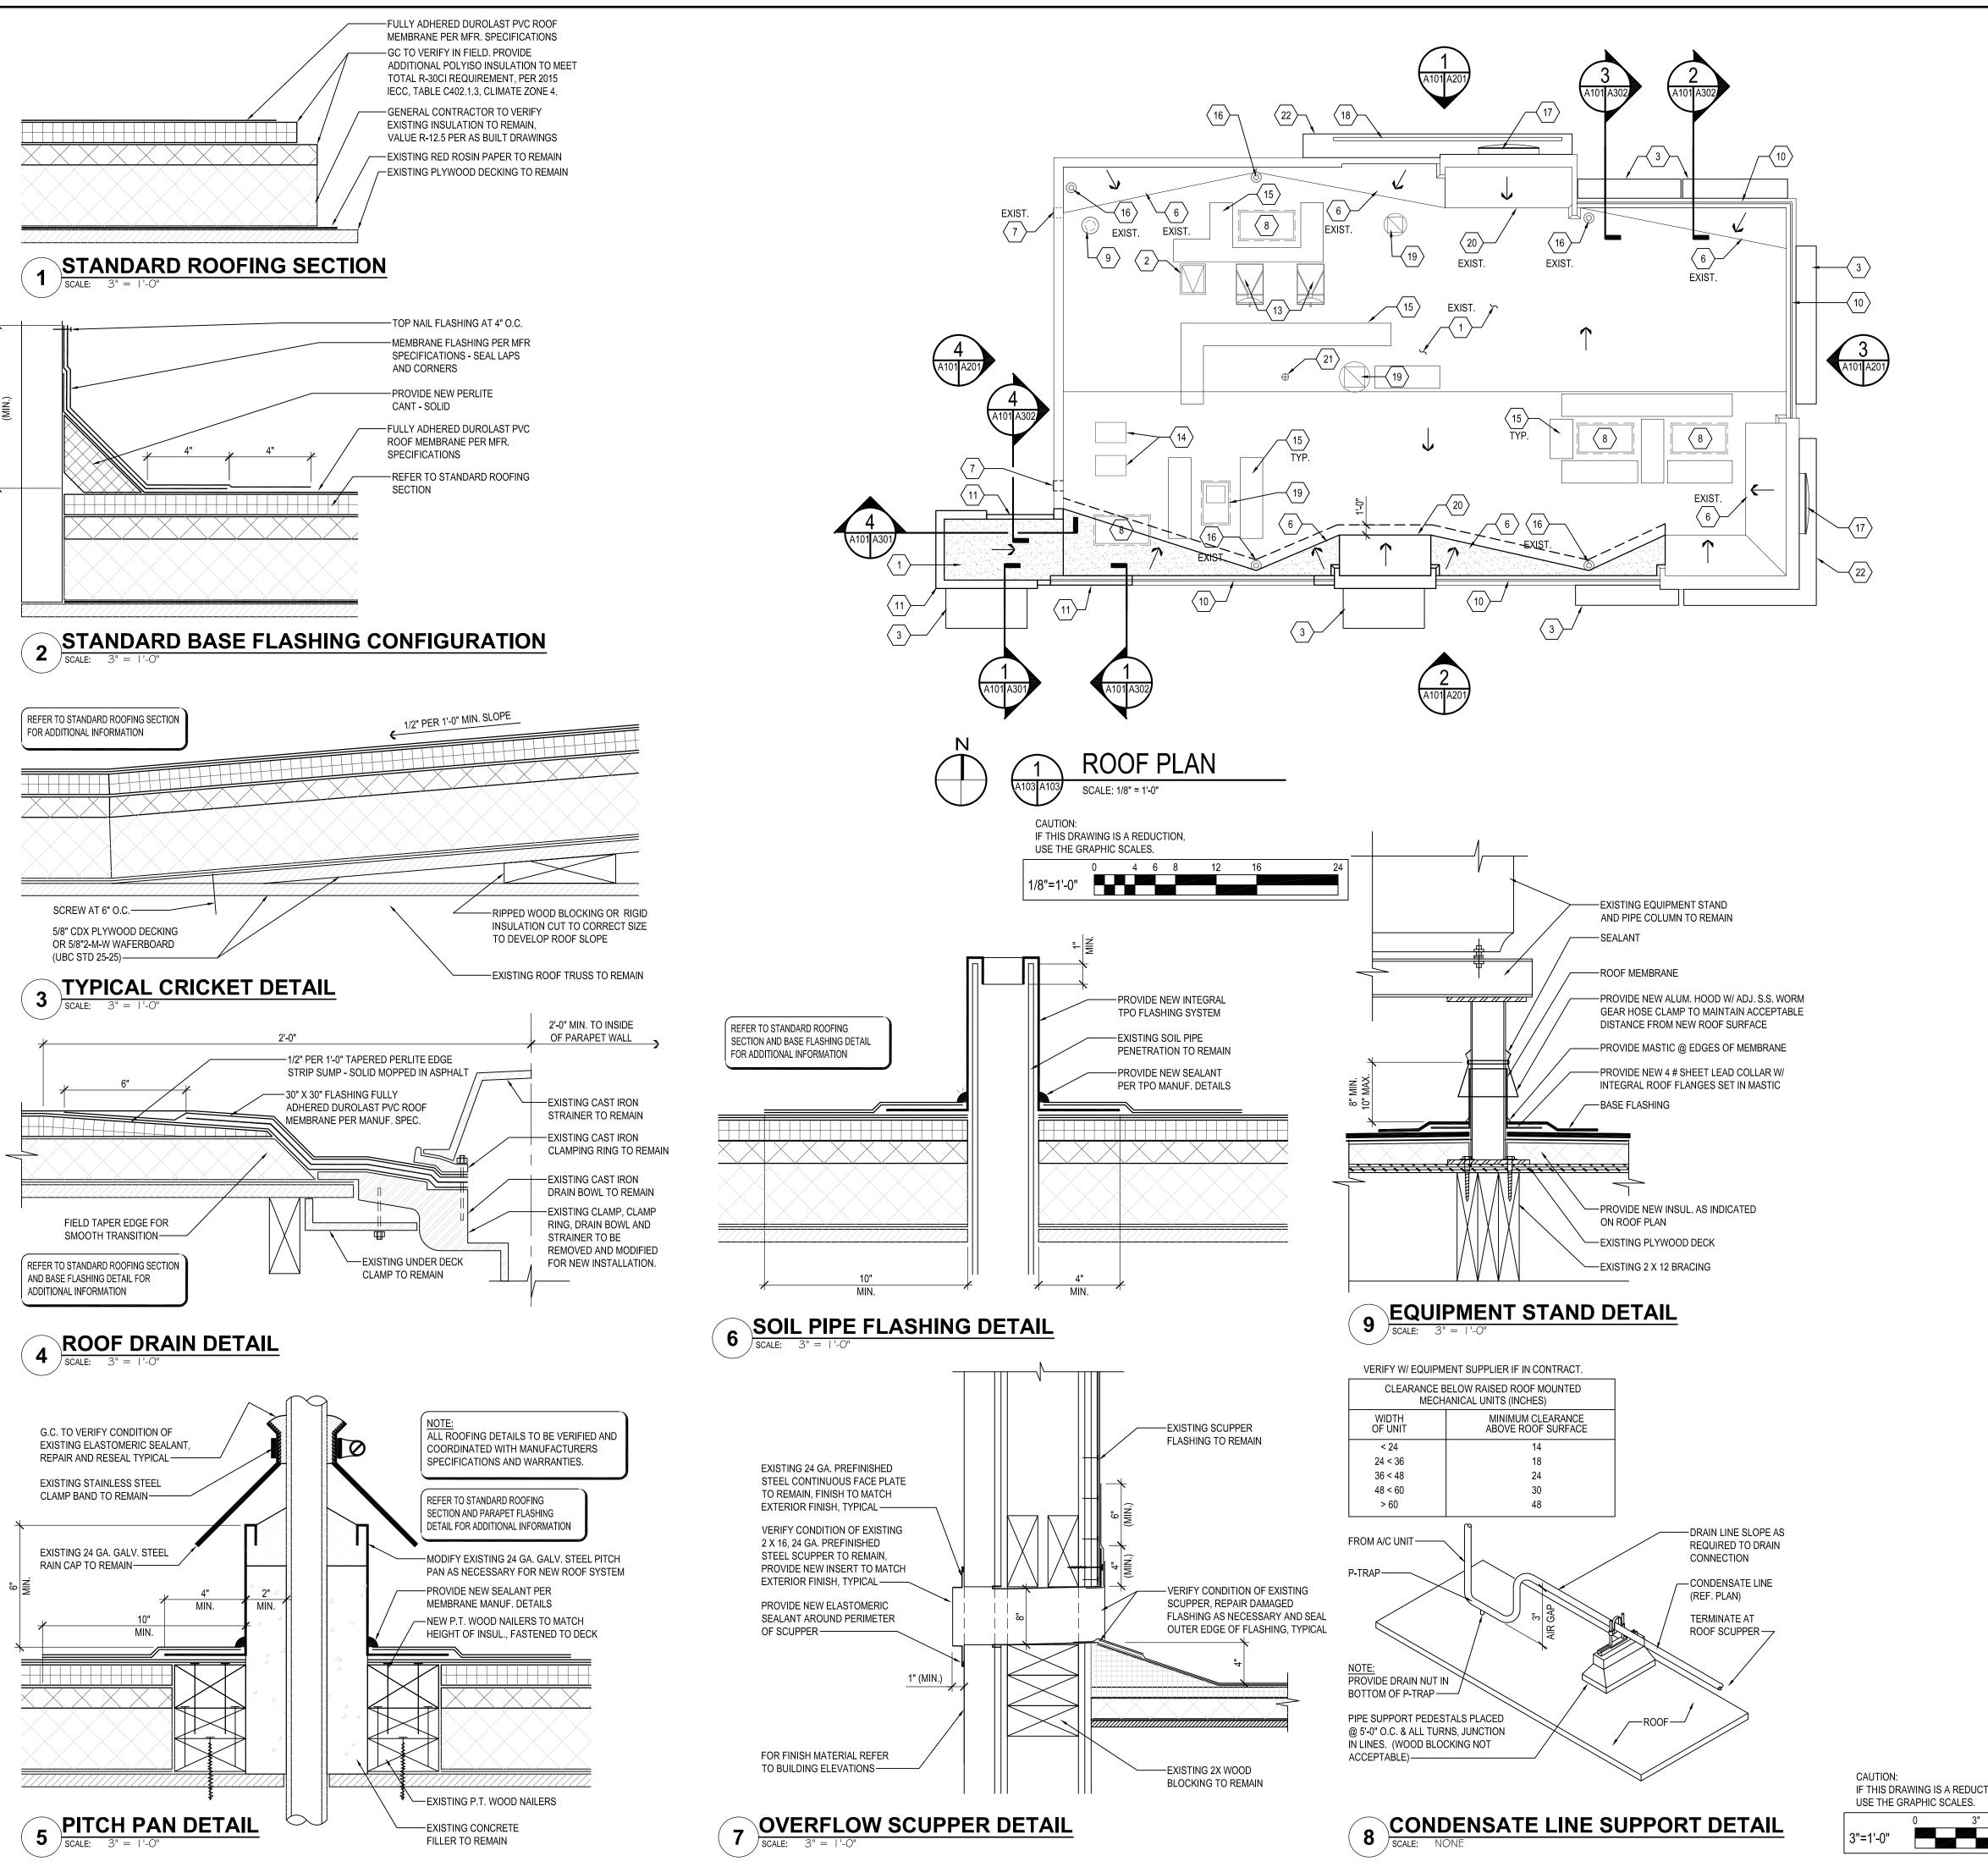SPECIFICATIONS.

# GENERAL SHEET NOTES

- 1. ROOFING SUBCONTRACTOR TO COORDINATE LOCATION OF EXISTING H.V.A.C. UNITS AND ROOF TOP ACCESSORIES WITH EXISTING OPENINGS AND EXISTING STRUCTURAL, MECHANICAL AND ELECTRICAL SYSTEMS. COORDINATE WITH STRUCTURAL, MECHANICAL AND ELECTRICAL DRAWINGS. COORDINATE PLACEMENT AND TAPERED RIGID INSULATION BOARD LAY-OUT AND SUBSEQUENT INSTALLATION IN ORDER TO AVOID PONDING WATER CONDITIONS ATTRIBUTABLE TO BOARD LAY-OUT ISSUES.
- ROOF SYSTEMS SPECIFIED SHALL BE APPLIED ONLY BY MANUFACTURER APPROVED APPLICATOR IN ORDER TO MEET GUARANTEE REQUIREMENTS.
- 3. HVAC CONDENSATE LINES TO TERMINATE AT ROOF DRAIN OR AS REQUIRED BY LOCAL CODE.
- 4. REFER TO MEP DRAWINGS FOR ADDITIONAL INFORMATION.
- 5. ALL CURBS AND PIPE PENETRATIONS SHALL HAVE A MINIMUM OF 16" CLEAR FROM EACH OTHER FOR ROOF FLASHING PURPOSES. ALL EQUIPMENT SHALL HAVE A MINIMUM OF 16" CLEAR FROM ALL ADJACENT PARAPETS. ALL HVAC MOUNTED EQUIPMENT (DISCONNECT BOXES, GFCI, PIPE SUPPORTS) SHALL NOT BE CLOSER THAN 16" FROM EACH OTHER OR CURB. NO UNISTRUT PIPE SUPPORTS SHALL BE USED AS VERTICAL MEMBERS FOR MOUNTING EQUIPMENT TO ROOF SURFACE.
- PONDING WATER IS DEFINED AS WATER THAT DOES NOT DRAIN OR DISSIPATE FROM THE ROOF WITHIN 48 HOURS AFTER PRECIPITATION.
- 7. ALL FLASHING CEMENTS, DURO-LAST MEMBRANE, PRODUCTS AND ACCESSORIES SHALL BE APPROVED BY ROOFING MANUFACTURER WITH THE MANUFACTURES'S BRAND. ALL ROOFING PRODUCTS SHALL BE AMERICAN MANUFACTURED PRODUCTS.

# ○ SHEET KEYNOTES

- 1. FULLY ADHERED DURO-LAST PVC ROOF MEMBRANE.
- 2. ROOF ACCESS SCUTTLE TO BE REMOVED, RAISE AND REINSTALLED WITH INSTALLATION OF NEW INSULATION AND ROOF SYSTEM. GENERAL CONTRACTOR TO VERIFY CONDITION OF EXISTING SCUTTLE AND REPAIR FINISH AS NECESSARY.
- 3. PREFABRICATED METAL CANOPY. REFERENCE SHEETS A304.
- 4. EXISTING VENT THROUGH ROOF, PROVIDE PREFABRICATED DURO-LAST VENT FLASHING FOR ALL VENTS AND PIPE PENETRATIONS. REFERENCE DETAIL #6, THIS SHEET.
- 5. INSTALL DURO-LAST PVC ROOF MEMBRANE SACRIFICE SHEET AS SPECIFIED AT KITCHEN EXHAUST
- 6. ROOF CRICKET WITH SLOPE TO MATCH ROOF, REFER TO DETAIL #3, THIS SHEET
- 7. OVERFLOW ROOF SCUPPERS REFER TO DETAIL #7 THIS SHEET.
- 8. ROOFTOP AIR CONDITIONING UNIT REFER TO MECHANICAL PLANS.
- 9. EXHAUST FAN REFER TO MECHANICAL PLANS.
- 10. ILLUMINATED PARAPET LIGHT BAND MP-1.
- 11. RAISED PARAPET WALL WITH NEW PRE FINISHED METAL COPING.
- 12. PVC CONDENSATE DRAIN (SIZE AS SHOWN) WITH PIPE SUPPORTS EVERY 5'-0". TERMINATE CONDENSATE DRAIN AT PRIMARY SCUPPER. REFER TO DETAIL #8, THIS SHEET FOR ADDITIONAL INFORMATION.
- 13. PROVIDE NEW PITCH PAN WITH CONDUIT OVER OFFICE FOR EXISTING SATELLITE DISH/ANTENNA TO BE REMOVED AND REINSTALLED.
- 14. EQUIPMENT STAND FOR WALK-IN BOX COOLER/FREEZER CONDENSERS AND ICE MACHINE CONDENSER. REFER TO EQUIPMENT STAND DETAIL, THIS SHEET.
- 15. ROOF WALKWAY PADS, INSTALL IN ACCORDANCE WITH MANUFACTURER'S INSTRUCTIONS.
- 16. EXISTING ROOF DRAINS. MODIFY AND EXTEND RAIN WATER LEADER, AS REQUIRED FOR NEW ROOFING SYSTEM AND THICKER INSULATION REFER TO DETAIL #4 THIS SHEET.
- 17. REINSTALL EXISTING SALVAGED SIGNAGE. SIGNAGE TO BE REINSTALLED DURING CONSTRUCTION PHASE...
- 18. NEW SIGNAGE TO BE INSTALLED
- 19. EXISTING EXHAUST FAN ON MODIFY EXISTING CURBS AND OPENING. COORDINATE WITH LOCATION OF FRYER AND BROILER BELOW. CONNECT EXISTING FRYER AND BROILER HOOD WITH ASSOCIATED DUCTWORK.
- 20. CRIPPLE ONTO OTHER SHEATHING AND RAFTERS/KICKERS.
- 21. EXISTING SEALED ROOF VENT TO REMAIN.
- 22. REINSTALL SALVAGED CANOPY. REINSTALL DURING CONSTRUCTION PHASE.
- 23. EXISTING WALL MOUNTED METAL VENT TO BE REMOVED, CAPPED AND SEALED WITH MEMBRANE ROOF PATCH. MEMBRANE PATCH SHALL BE COMPATIBLE WITH EXISTING ROOF SYSTEM AND INSTALLED PER MANUFACTURER RECOMMENDATIONS.
- 24. EXISTING ABANDONED ROOF TOP EQUIPMENT TO REMAIN
- 25. WALL MOUNTED METAL VENT REMOVED, PROVIDE BLOCKING AND PLYWOOD SUBSTRATE FLUSH WITH ADJACENT PARAPET WALL. PATCH AND REPAIR WITH ADJACENT ROOF WITH COMPATIBLE DURO-LAST ROOF MEMBRANE.

CAUTION:
IF THIS DRAWING IS A REDUCTION,
USE THE GRAPHIC SCALES.

0 3" 6" 12"
3"=1'-0"

DRAWN: J.M.M.

CHECKED: S.C.B.

SCALE: AS SHOWN

DATE: 04/21/2021

PROJECT: 2018.0375.05

DRAWING:

A103

J.M.M.

DESIGNED:

hereby certify that these documents were

prepared or approved by me, and that I am a


icense #6140 Expiration Date: 08/21/2022

BURGER

laws of the State of Maryland.


duly licensed professional architect under the


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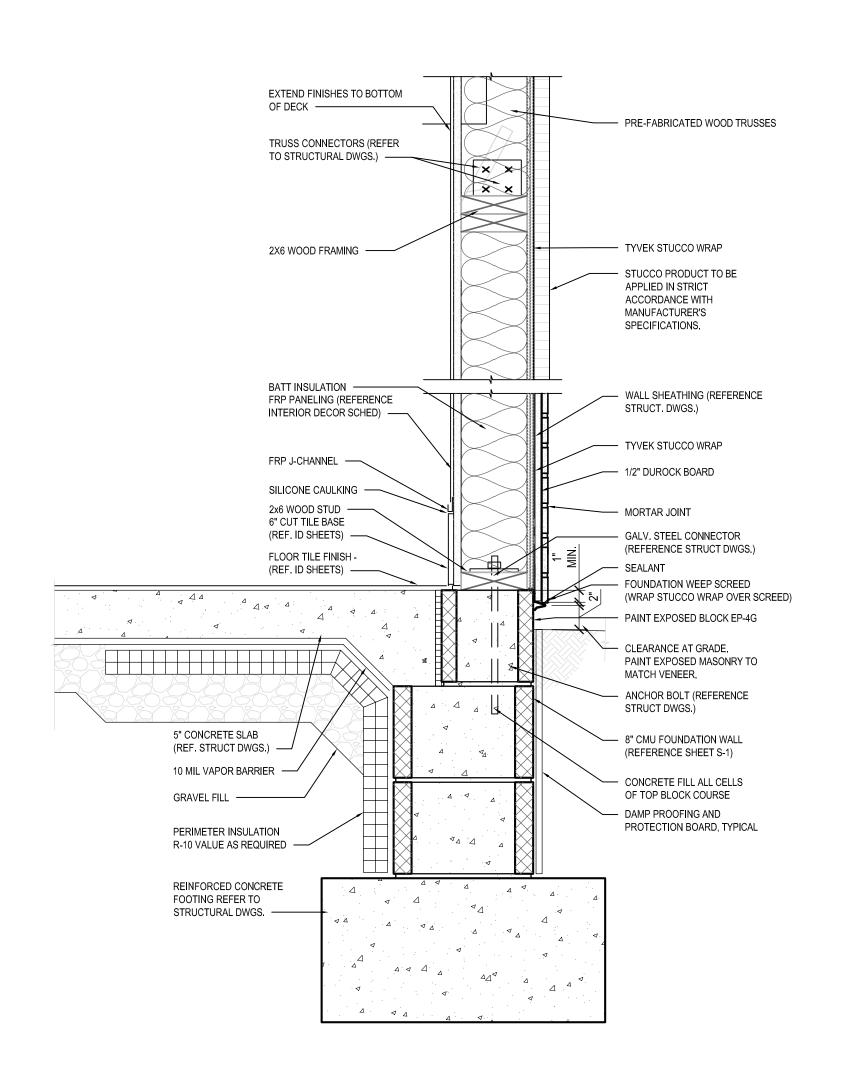
				BURGER KING - 20/20 GAR EXTERIOR MATERIALS & FINISH SCHEDULE				
08/07/19				EXTERIOR MATERIALS & FINISH SCHEDULE	(not all specs are used on every project)			
CODE	MATERIAL	LOCATION	MANUFACTURER	PRODUCT	DESCRIPTION  COLOR	DIMENSION	ADDITIONAL INFORMATION	
				MOD / QS TUMBLED (FULL BRICK)	OLDE HILLSBORO	DIMENSION	CONTACT: GABE POWERS (502) 558-4612	
			EVOLUTION BRICK	(THIN BRICK)	SIERRA TUMBLED		NOTE: USE WITH EGR-3G	
EB-1G	EXTERIOR BRICK	GENERAL	PINE HALL BRICK	FACE BRICK	OLD IRVINGTON O/S		CONTACT: THERESA BEANE (800) 334-8689 - tbeane@pinehallbrick.com	
			PINE HALL BRICK	FACE DRICK	OLD INVINGTON 0/3		NOTE: USE WITH EGR-3G  CONTACT: ERIN LYNCH (916) 206-7831	
			H.C. MUDDOX BRICK	THIN BRICK	BK WEST COAST BLEND		NOTE: USE WITH EGR-3G	
							CONTACT: JOY DETER AT EUROWEST (714) 309-9551	
ECT-1G	EXTERIOR CERAMIC TILE	ACCENT AT BUILDING FRONT	GRANITI GIANDRE / EUROWEST	SENSIBLE STONE ED5052	"RED NATURAL" STACKED BOND PATTERN	12" X 24"	OR JOY KLEIN (813) 334-3302 jklein@transamerica.com	
							NOTE: USE WITH EGR-4G	
			STO OR APPROVED EQUAL	STO POWERWALL STUCCO SYSTEM  TEXTURE: FINE SAND	COLOR TO MATCH EP-2G  PPG "DESERT DUNE"		CONTACT: TIM SALERNO AT STO CORP (407) 466-5371	
	EXTERIOR FINISH - STUCCO,		·	OR STO THERM CI EIFS SYSTEM				
EF-1G	STO, FIBER CEMENT SIDING PANELS	GENERAL			PREPAINTED TO MATCH EP-2G - PPG "DESERT DUNE"		CONTACT NICHIHA CUSTOMER SERVICE (770) 805-9466 BK@NICHIHA.COM	
			NICHIHA FIBER CEMENT	NICHIHA TUFFBLOCK	STACKED BOND PATTERN	18" X 6'	INSTALL PER MANUFACTURER'S SPECIFICATIONS	
					COLOR TO MATCH EP-4G		VERTICAL APPLICATIONS ONLY (NOT FOR USE ON SOFFITS)  CONTACT: TIM SALERNO AT STO CORP (407) 466-5371	
EF-4G	EXTERIOR FINISH STUCCO	GENERAL	STO OR APPROVED EQUAL	STO POWERWALL STUCCO SYSTEM	PPG "GRANITE"		CONTACT, TIP SALERNO AT STO CORT (407) 400 5571	
	EXTERIOR FINISH						CONTACT NICHIHA CUSTOMER SERVICE (770) 805-9466	
EF-9G	FIBER CEMENT						BK@NICHIHA.COM  INSTALL PER MANUFACTURER'S SPECIFICATIONS. VERTICAL	
							SEAMS SHALL BE MINIMIZED. ALL SPANS OF 10' OR MORE SHALL	
		EXTERIOR SIGN ARCHONS		NICHIHA FIBER CEMENT	VINTAGE WOOD EF762	"CEDAR"	18" X 10'	HAVE VERTICAL SEAMS ALIGNED IN THE CENTER OF THE ARCHON.  SEAMS TO BE CAULKED WITH EC-1G OR USE "H-MOLD"
TR-1G	ALUMINUM TRIMS						FACTORY TRIMS. ALL TRIMS SHALL BE FACTORY PAINTED	
							TO MATCH PANELS.	
							VERTICAL APPLICATIONS ONLY (NOT FOR USE ON SOFFITS)  CONTACT: MATT KLINGE AT ADFAST (314) 753-0964	
EC-1G	EXTERIOR CAULK		ADSEAL PRODUCTS	ADSEAL 458-63	"VINTAGE WOOD CEDAR"		matt.klinge@adfastcorp.com	
				PRIMER: 17-921	"DESERT DUNE" 1023-4, former "TANNERS TAUPE"		NOTE: USE WITH EF-9G  CONTACT: KEVIN LASTACY @ PPG	
EP-2G	EXTERIOR PAINT	EXTERIOR GENERAL		PAINT: 6-2045XI	PPG1023-4		Corporate National Accounts Manager	
EP-4G	EXTERIOR PAINT	EXTERIOR WAINSCOT	[	PRIMER: 17-921 PAINT: 6-2045XI	"GRANITE" 1022-6 , former "MONTERREY CLIFFS"  10YY 14/080		(616) 335-3259 klastacy@ppg.com	
				PRIMER: 6-212	"STEPPING STONE" 1010-4 , former "BURGER KING SILVER"		NOTE: FOR REMODELS ONLY	
EP-6G	EXTERIOR PAINT	LOGO SIGN CABINETS & BURGER KING CHANNEL LETTER CABINETS		PAINT: 6-230	Custom Formula		NOT FOR USE ON ROOFS.	
		EXISTING MANSARD ROOFS,		PRIMER: 17-921	"DOVER GRAY" 1001-1 , former "GRYMMYS GREY"		SEE EP-6AG & EP-6BG  NOTE: BY EXCEPTION FOR REMODELS ONLY	
EP-6AG	EXTERIOR PAINT	SHINGLES & BARREL TILE	PPG	PAINT: 90-1110	00NN 20/000			
EP-6BG	EXTERIOR PAINT	EXISTING STANDING SEAM METAL ROOF		PRIMER: 90-712 PAINT: 90-1110	"GRAY STONE" 1009-4 , former "MARCH WIND"  Custom Formula		NOTE: BY EXCEPTION FOR REMODELS ONLY	
EP-8BG	EXTERIOR PAINT	METAL COPING AT ARCHON		PRIMER: 17-921	"CARAVEL BROWN" 1079-6 , former "CEDAR"			
LF-0DG	LATERIOR PAINT	TOWERS		PAINT: 6-2045XI PRIMER: 90-712	Custom Formula  "BLACK"			
EXT-1G	EXTERIOR PAINT	POLES & POLE SIGN		PAINT: 90-353	DLACK			
EXT-2G	EXTERIOR PAINT	SIGNS		PRIMER: 90-712	Tint to match			
				PAINT: 90-375 PRIMER:	PPG 1006-6 "DECONSTRUCTION"  "TAUPE TONE"		Contact: GLENN REMLER, ARCHITECTURAL ACCOUNT EXECUTIVE	
				Loxon Concrete & Masonry A24W300	SW 7633			
EP-2G	EXTERIOR PAINT	EXTERIOR GENERAL		PAINT: Superpaint Ext Satin A89 Series			phone: (954) 547-1217	
				Satin			email: Glenn.J.Remler@Sherwin.com	
				PRIMER: Loxon Concrete & Masonry A24W300	"HOMESTEAD BROWN"  SW 7515			
EP-4G	EXTERIOR PAINT	EXTERIOR WAINSCOT		PAINT:	3W 7515			
				Superpaint Ext Satin A89 Series				
				Satin PRIMER:	FACTORY FINISH SILVER		NOTE: FOR REMODELS ONLY	
EP-6G	EXTERIOR PAINT	LOGO SIGN CABINETS & BURGER		Kem Bond HS B50A28				
		KING CHANNEL LETTER CABINETS		PAINT: Silver Brite B59S11			NOT FOR USE ON ROOFS.	
			SHERWIN-WILLIAMS	PRIMER:	"CEDAR"			
EP-8G	EXTERIOR PAINT	METAL COPING AT ARCHON		Pro Industrial Pro-Cryl Primer B66-310  PAINT:	Custom Formula			
L1 00	EXTERIOR FAINT	TOWERS		Pro Industrial High Performance Acrylic B66-650				
				Semi-Gloss PRIMER:	FACTORY FINISH BLACK			
				Pro Industrial Pro-Cryl Primer B66-310	LACTORT LINISH DLACK			
EXT-1G	EXTERIOR PAINT	POLES & POLE SIGN		PAINT:				
				Pro Industrial High Performance Acrylic B66-600 Gloss				
				PRIMER:	FACTORY FINISH TO MATCH			
EXT-2G	EXTERIOR PAINT	SIGNS		Pro Industrial Pro-Cryl Primer B66-310  PAINT:	SW 6075 "GARRET GRAY"			
5				Pro Industrial High Performance Acrylic B66-600				
	-			Gloss			NOTE: USE WITH EB-1G	
EGR-3G	GROUT	BRICK	MAPEI		#5 "CHAMOIS"			
							NOTE: USE WITH ECT-1G  *** FOR SETTING MATERIALS USE COMPLETE CONTACT RAPID SET	
EGR-4G	GROUT	CERAMIC TILE	CUSTOM BUILDING PRODUCTS	POLYBLEND SANDED	#335 "WINTER GRAY"		*** FOR SETTING MATERIALS USE COMPLETE CONTACT RAPID SET  *** SEAL GROUT WITH AQUAMIX SEALERS CHOICE GOLD	
							CONTACT, W.D. HICKMAN COMPANY (020) CTC 4700 . WWW. WTW.	
MC-1G	METAL COPING	TOP OF LIGHT BAND		PERMA SNAP PLUS	A-30 "SILVERSMITH"		CONTACT: W.P. HICKMAN COMPANY (828)676-1700 - WWW.WPH.COM	
	2	WALL CAP						
MC-2G	METAL COPING	BELOW LIGHT BAND	W.P. HICKMAN SYSTEMS, INC.	PERMA SNAP PLUS	FACTORY FINISH TO MATCH EP-2G  PPG "TANNERS TAUPE"			
I*IC-2G	METAL CUPING	DELOW LIGHT DAND	WILL LIEUWIAN STOTEMS, INC.	FERMA SIVAY PLUS	FFG TAININERS TAUPE			
					TO BE PAINTED TO MATCH EP-8G			
MC-3G	METAL COPING	TOP OF ARCHON		PERMA SNAP PLUS	PPG "CEDAR"			
							PRODUCT INFORMATION: KEVIN RUBOTTOM AT LEKTRON	
	1	PARAPET LIGHT BAND	LEKTRON *SEE APPROVED SIGN SUPPLIERS	LED LIGHT BAND		*SEE PLANS	(800) 634-4059 OR (918) 622-4978  Email: KRubottom@lektroninc.com	
MP-1G		PARAPET LIGHT BAND	SEE APPROVED SIGN SUPPLIERS I		·		Linali. Krabottomwicki omitc.com	
MP-1G		PARAPET LIGHT BAND	"SEE APPROVED SIGN SUPPLIERS				Email. Krabottom@lektromic.com	
MP-1G MP-3G	METAL CANOPY	ABOVE DOORS AND WINDOWS	*SEE APPROVED SIGN SUPPLIERS  *SEE APPROVED CANOPY SUPPLIERS	CUSTOM METAL CANOPY	COLOR: CLEAR ANODIZED	*SEE PLANS	Email. Krubottom@lektromite.com	

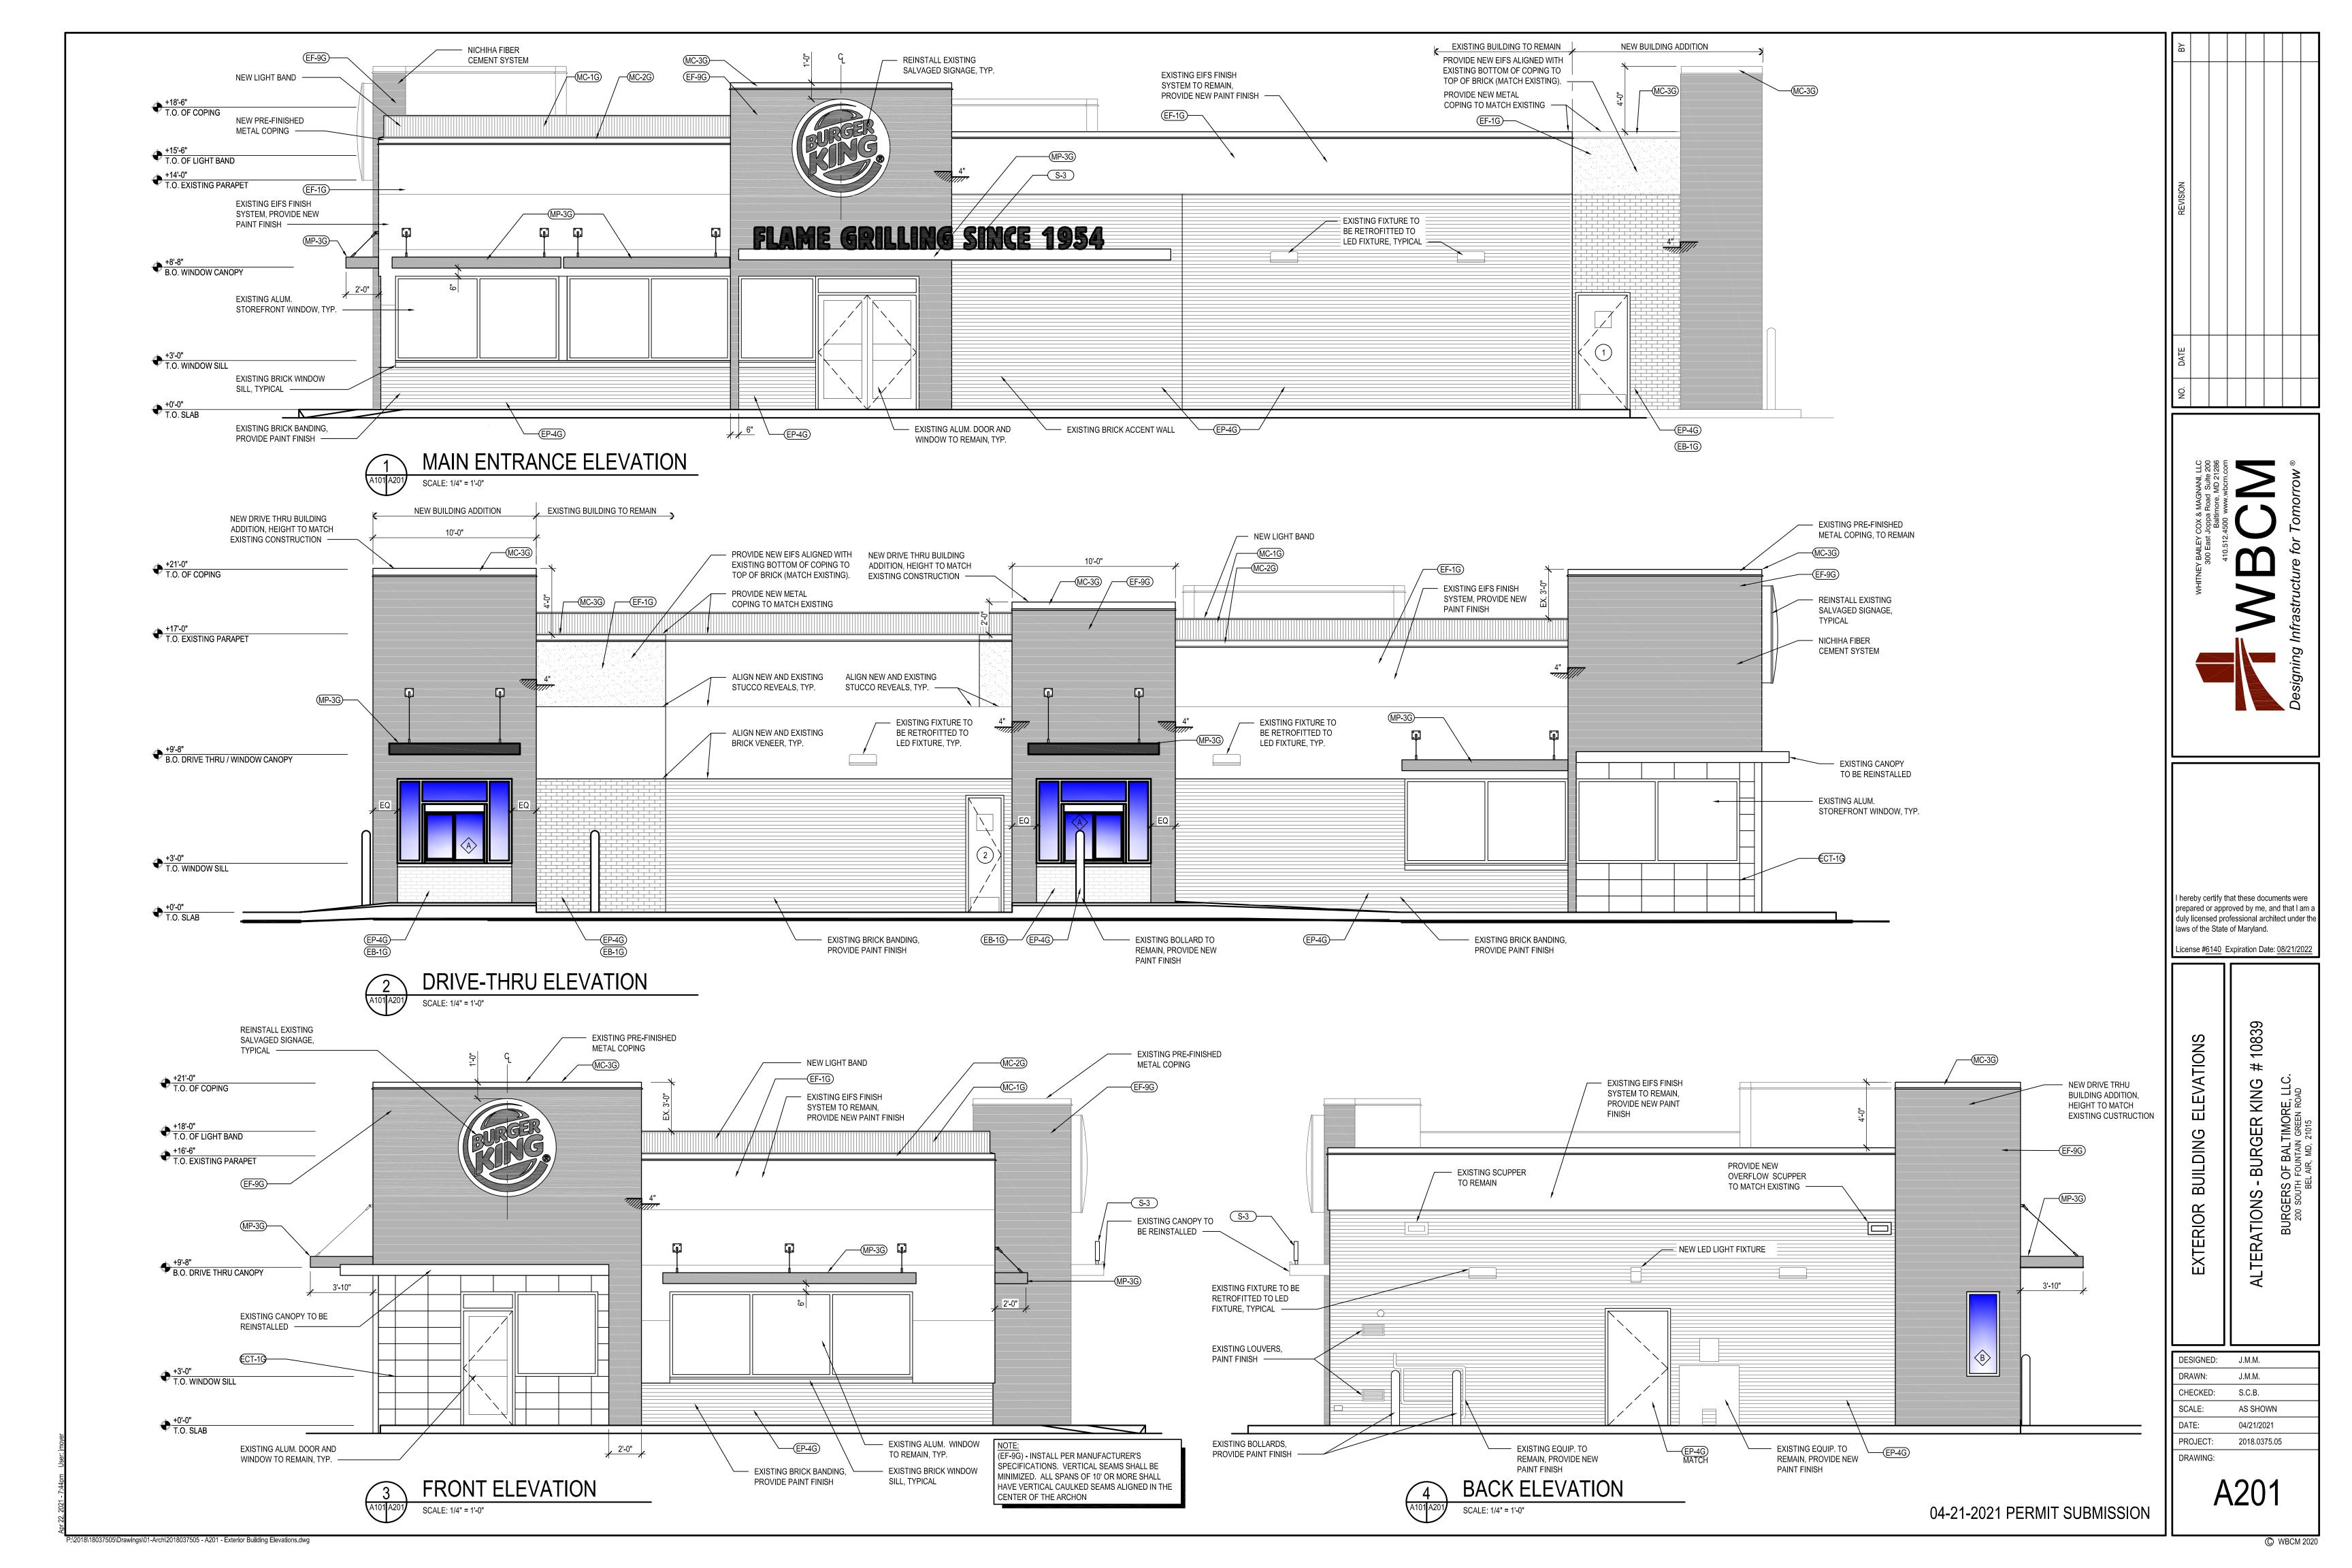
REVISION BY	
NO. DATE	
WHITNEY BAILEY COX & MAGNANI, LLC 300 East Joppa Road Suite 200 Baltimore, MD 21286 410 512 4500 www when com	Designing Infrastructure for Tomorrow ®
	Designi
prepared or app duly licensed pro laws of the State	that these documents were proved by me, and that I am a ofessional architect under the e of Maryland.  Expiration Date: 08/21/2022
EXTERIOR FINISH SCHEDULE	ALTERATIONS - BURGER KING # 10839  BURGERS OF BALTIMORE, LLC.  200 SOUTH FOUNTAIN GREEN ROAD BELAIR, MD, 21015
DESIGNED: DRAWN: CHECKED: SCALE: DATE: PROJECT: DRAWING:	J.M.M.  J.M.M.  S.C.B.  AS SHOWN  04/21/2021
	2018.0375.05



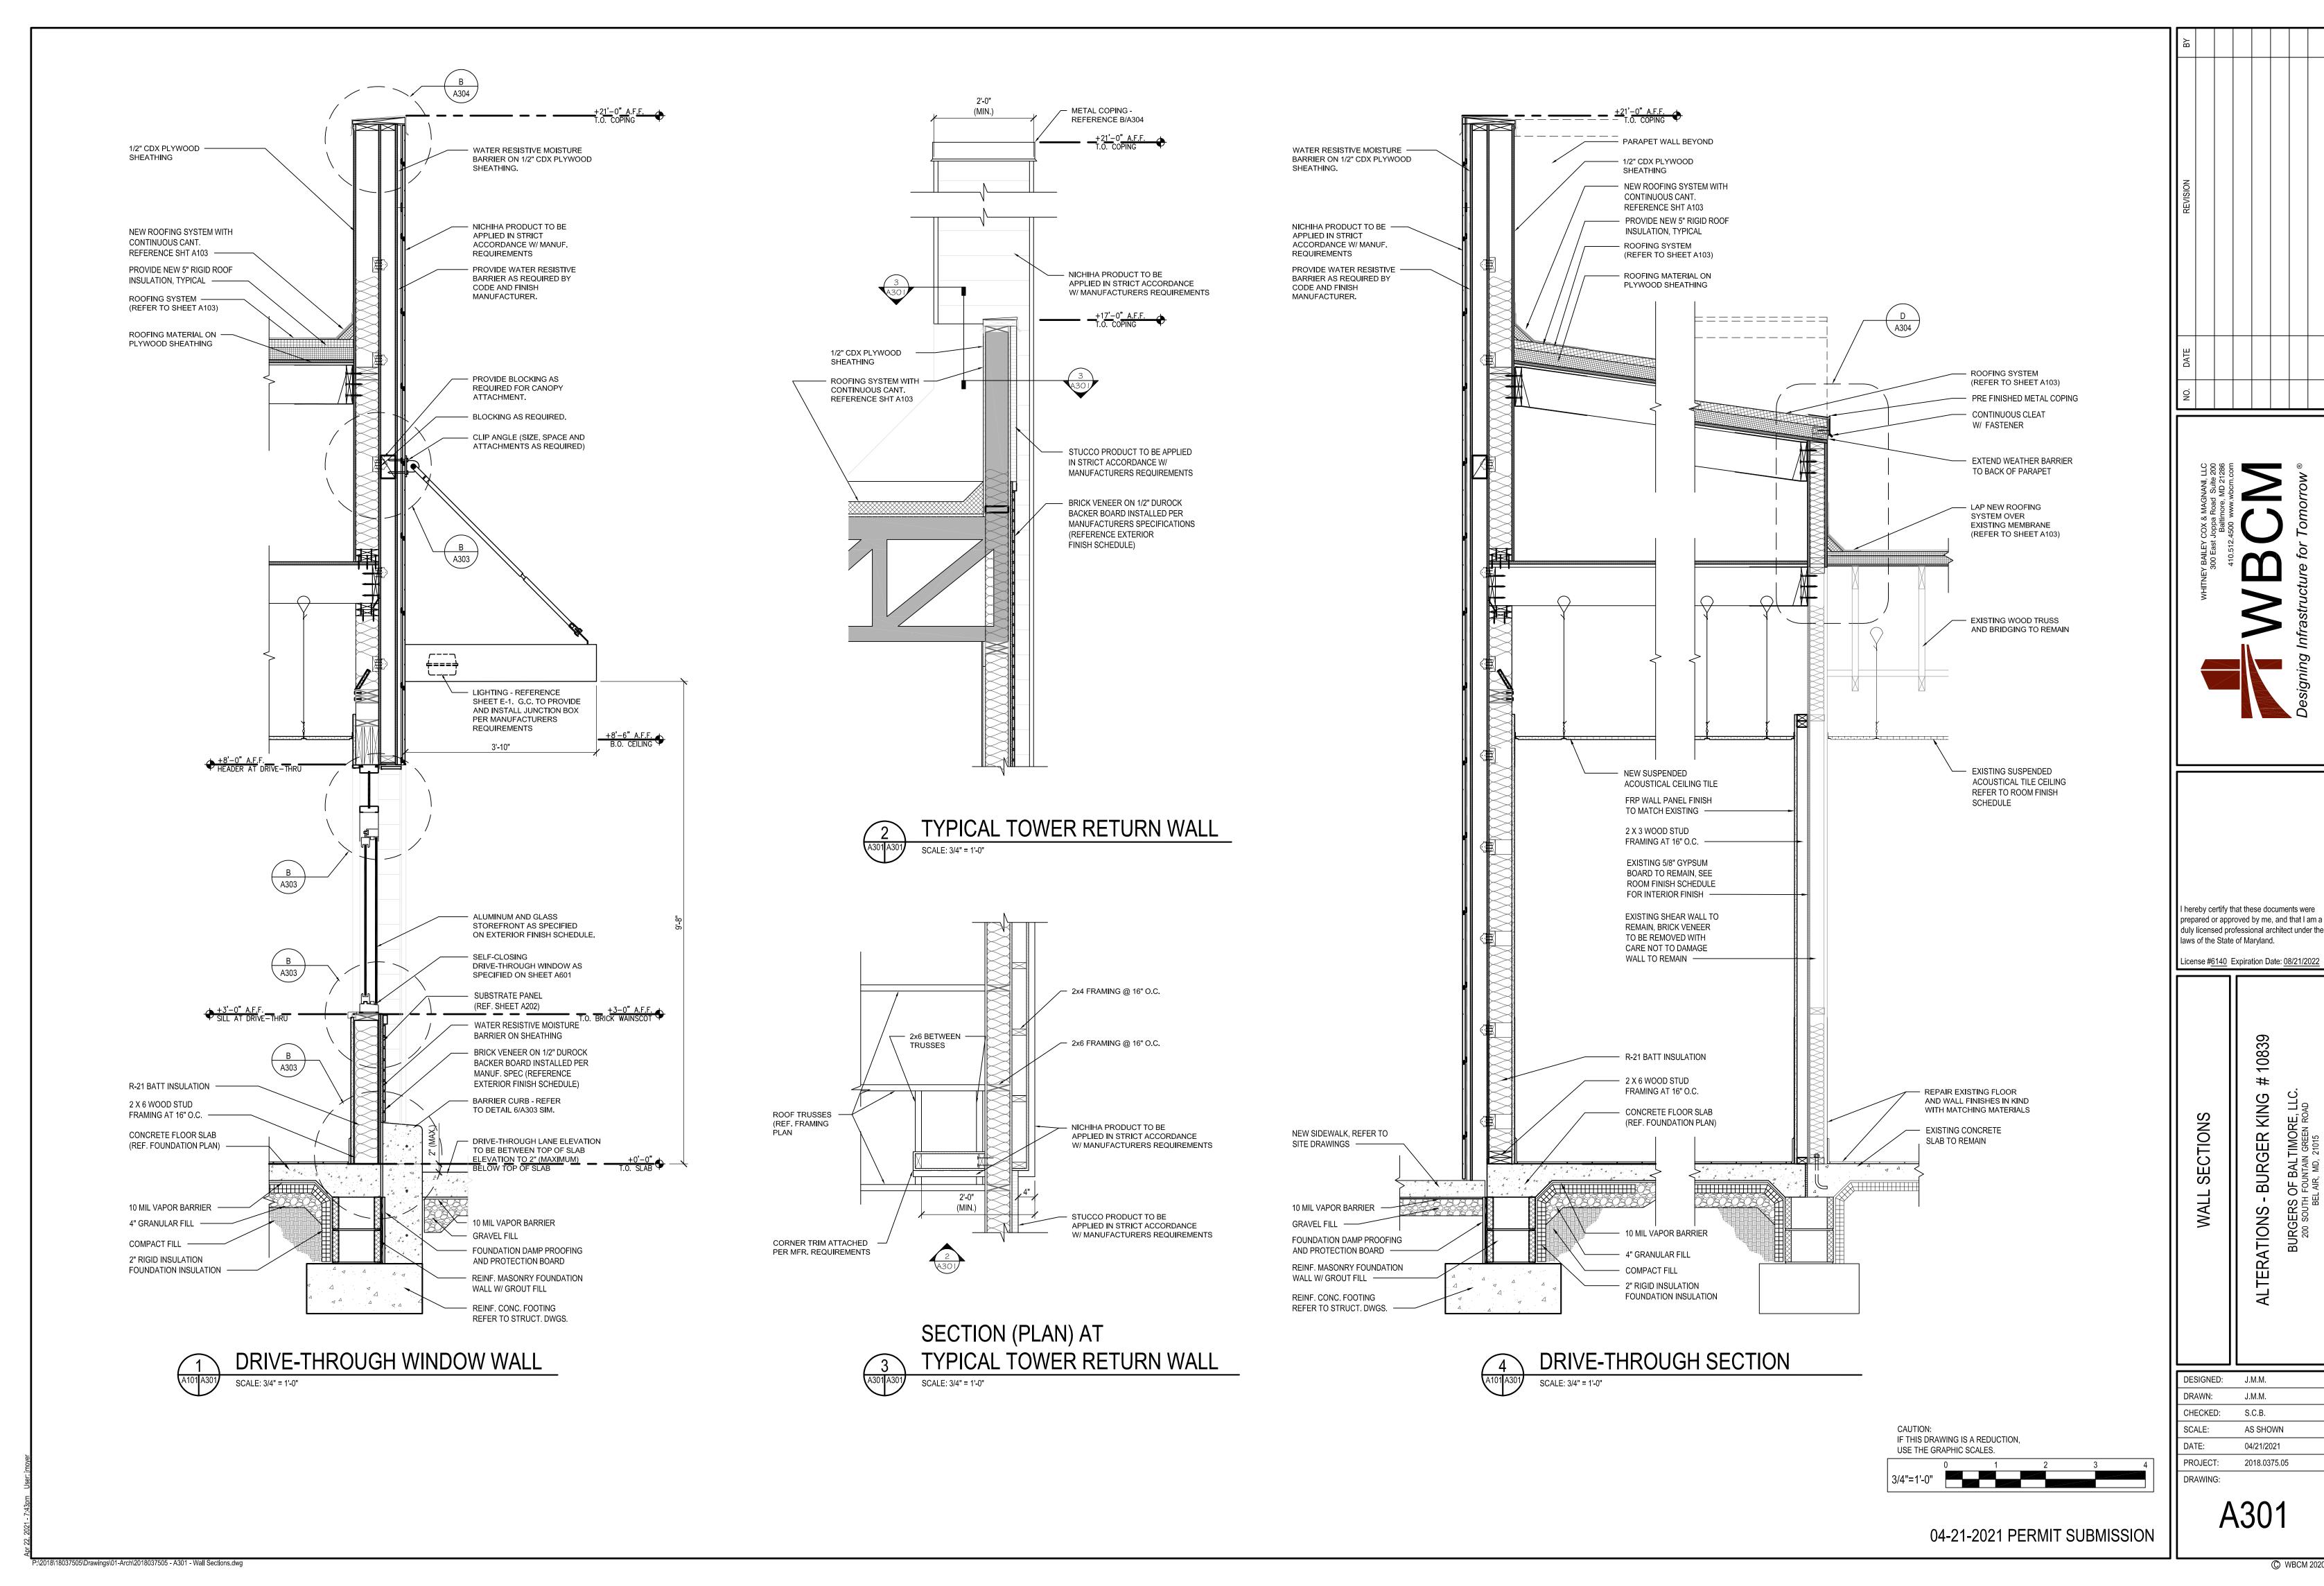



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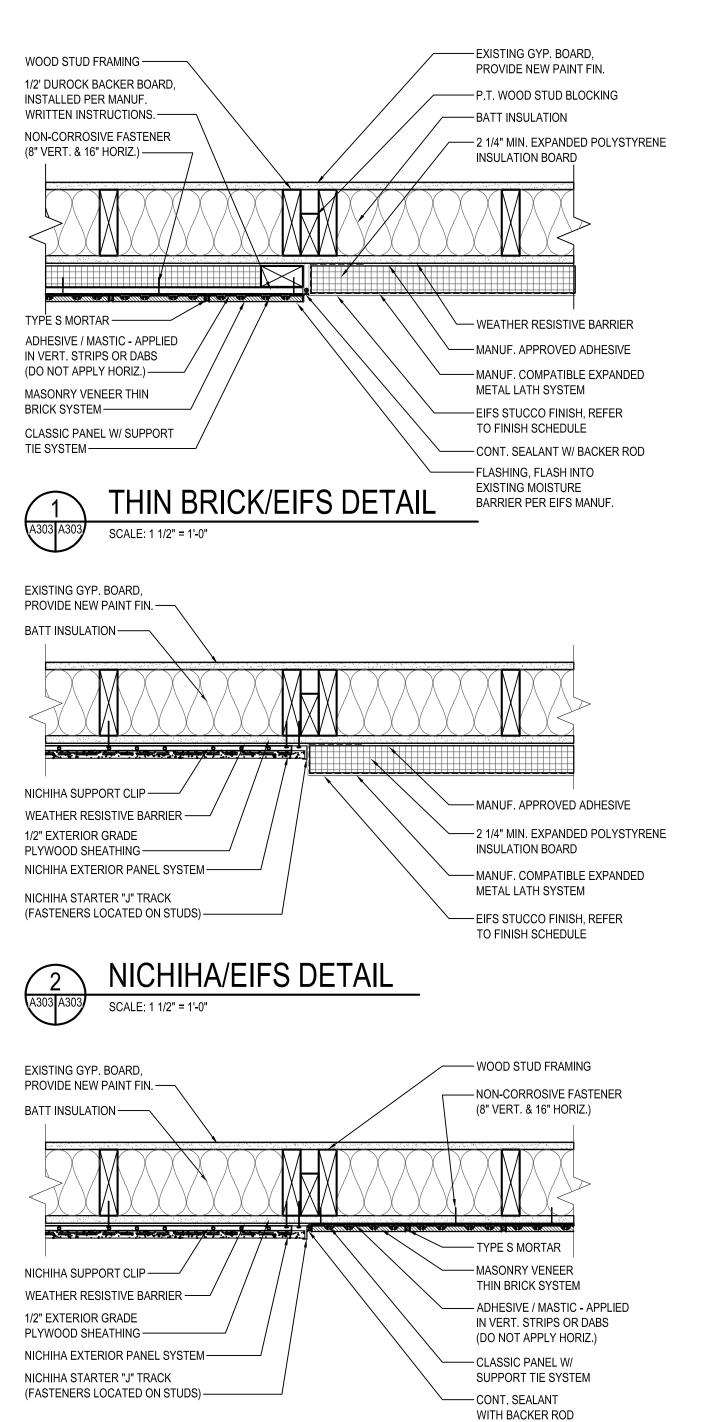


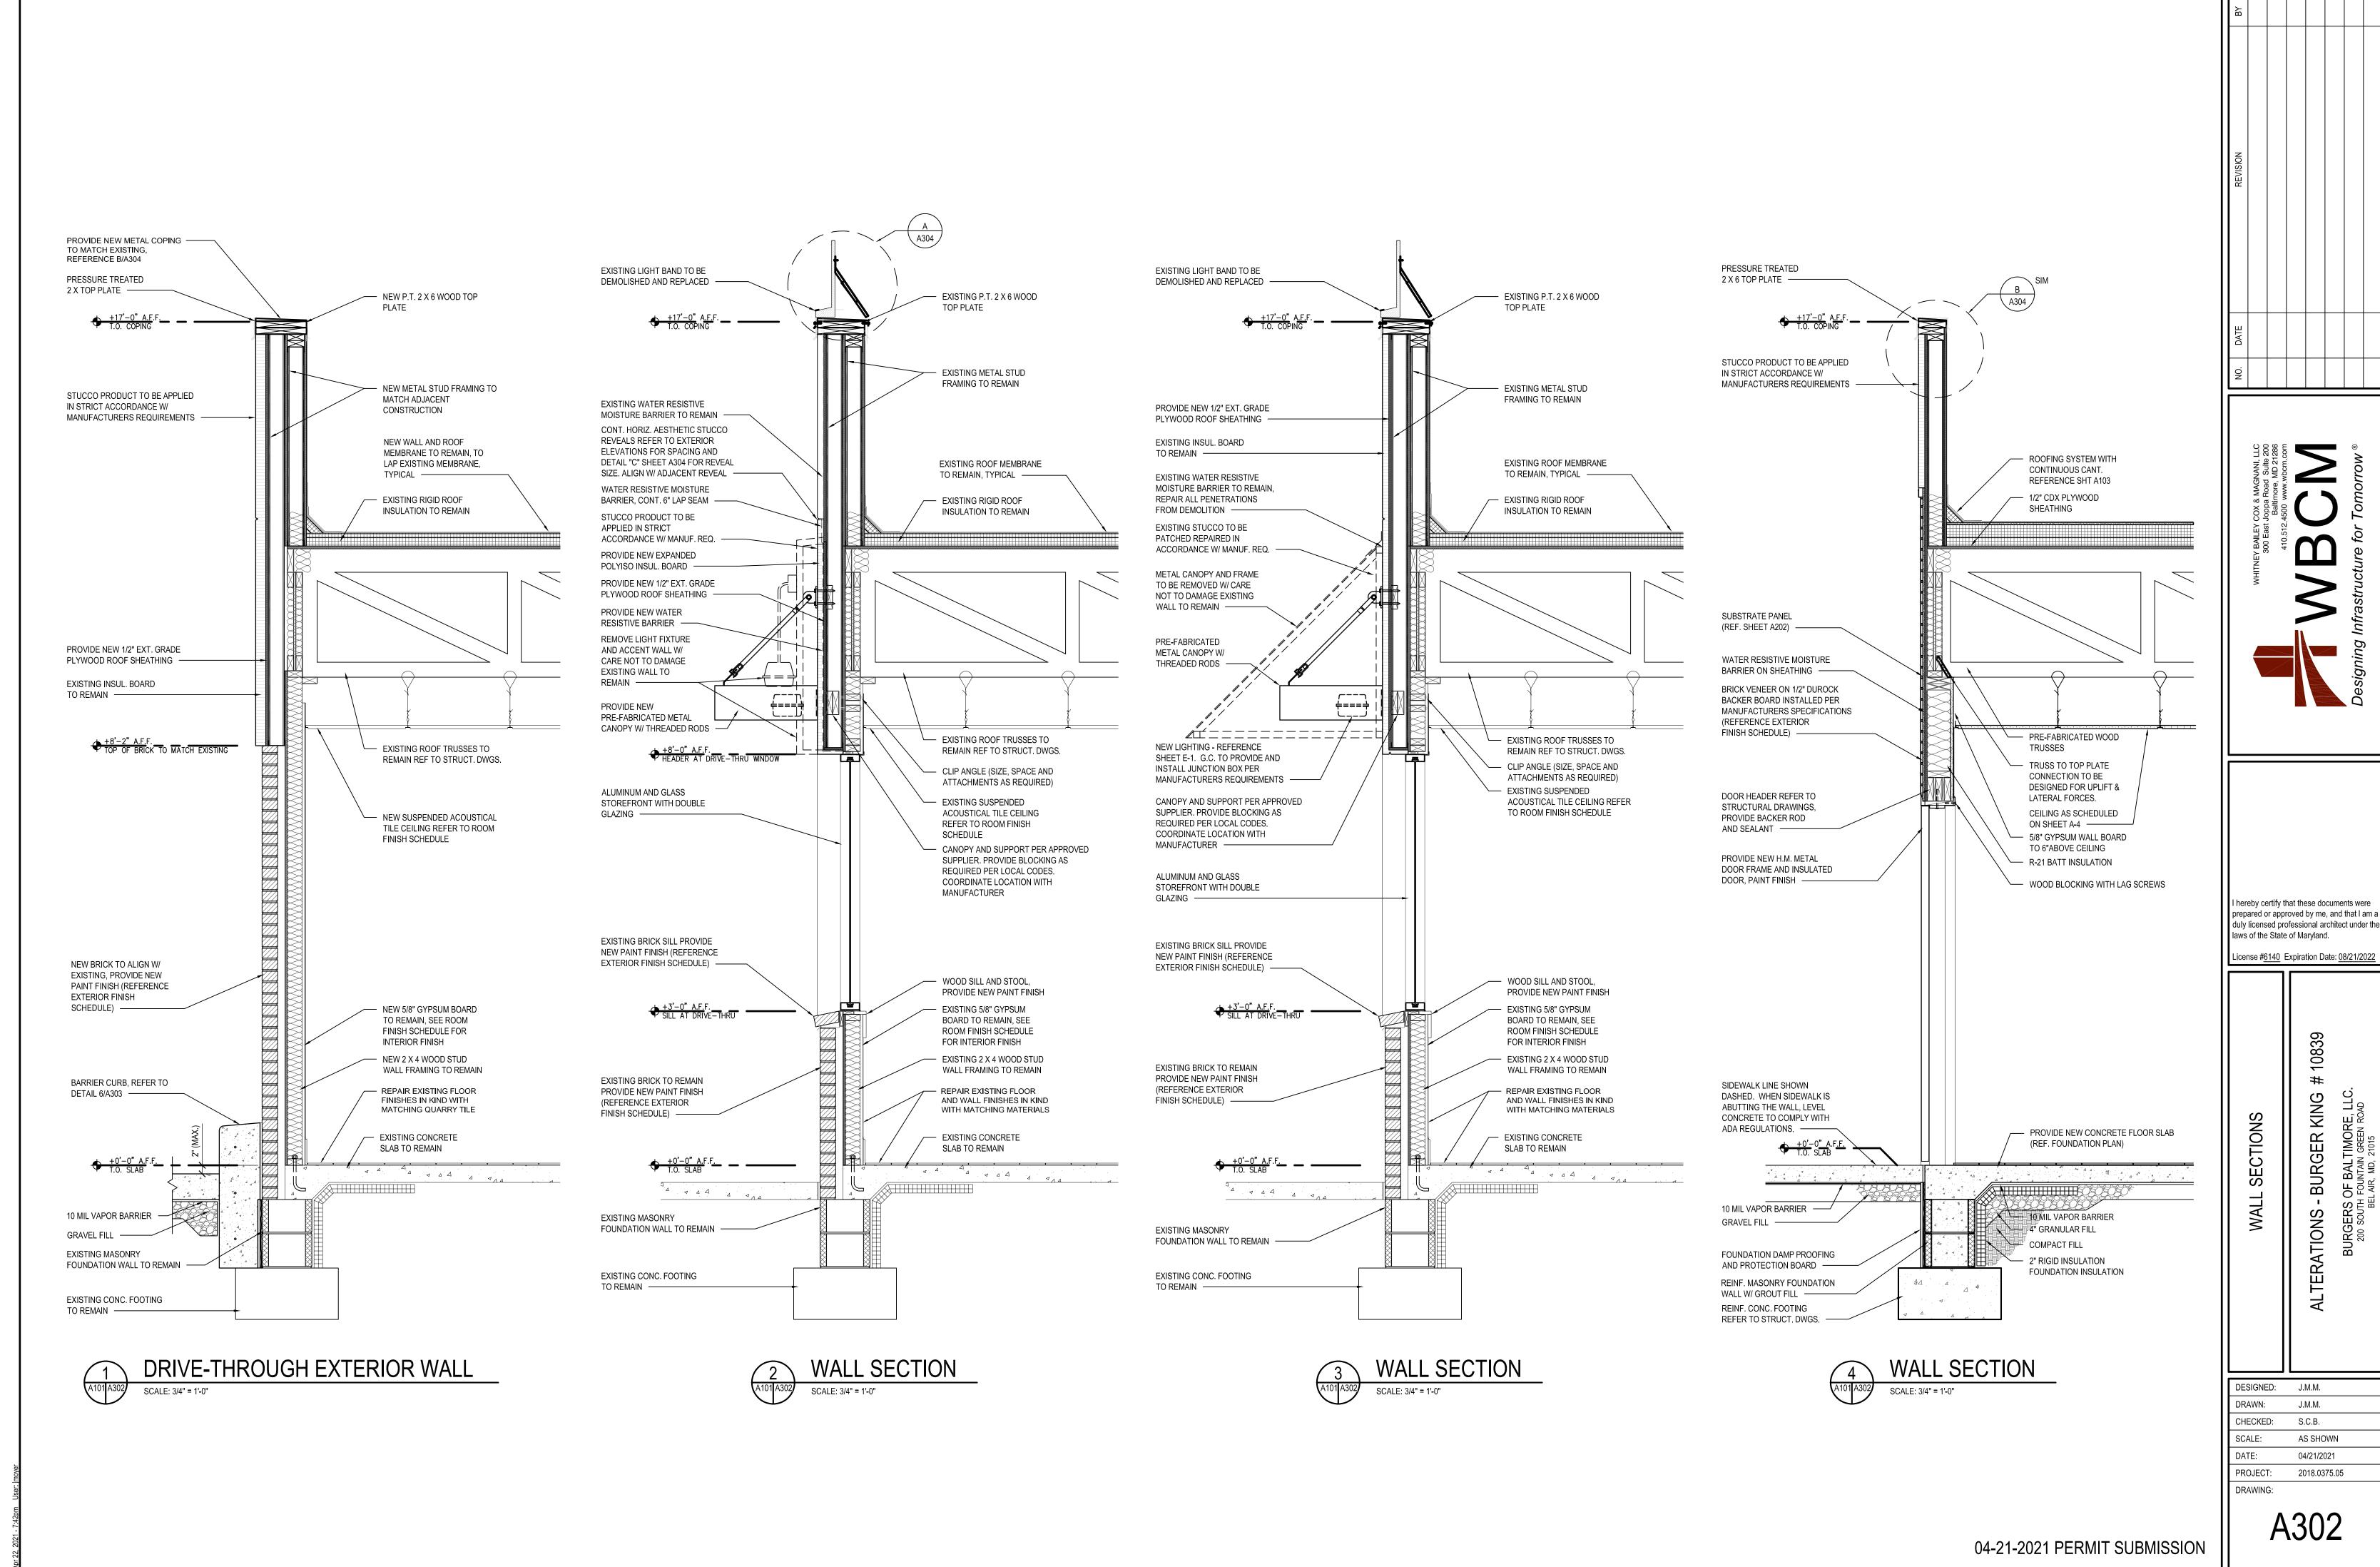


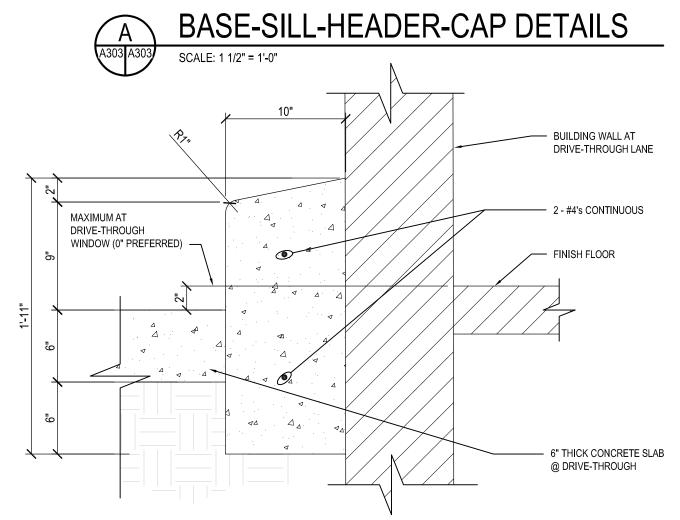
BARRIER CURB DETAIL




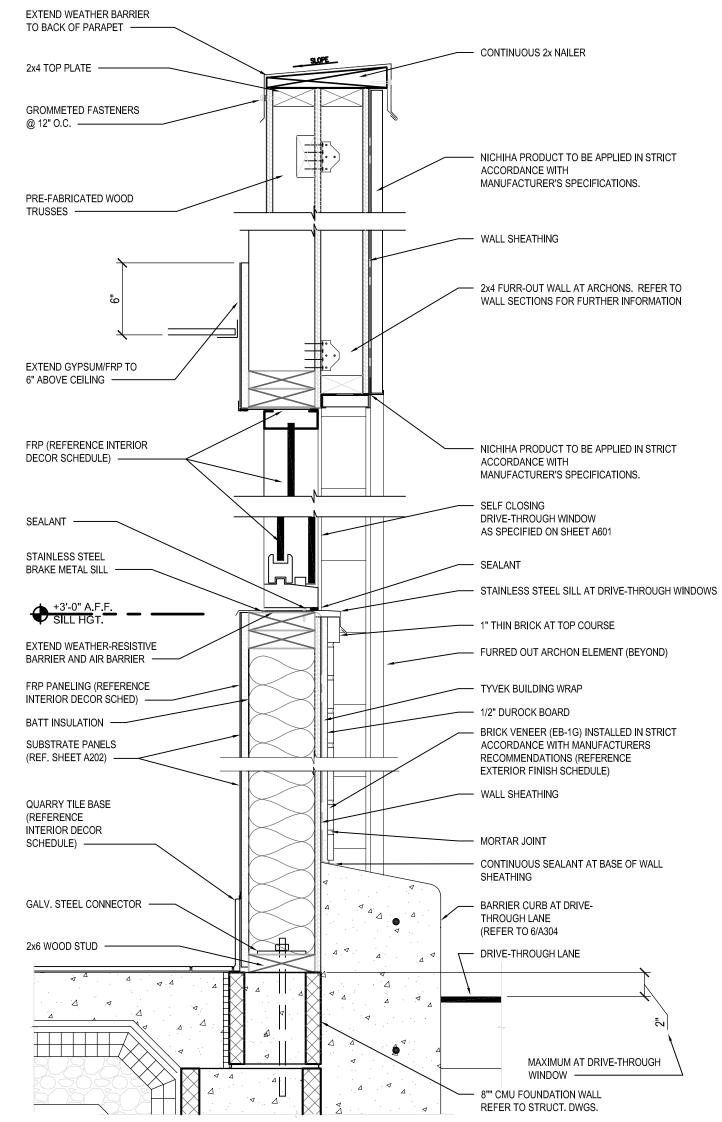


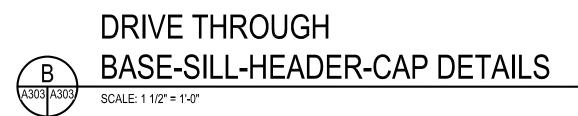


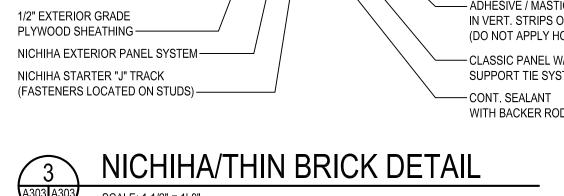

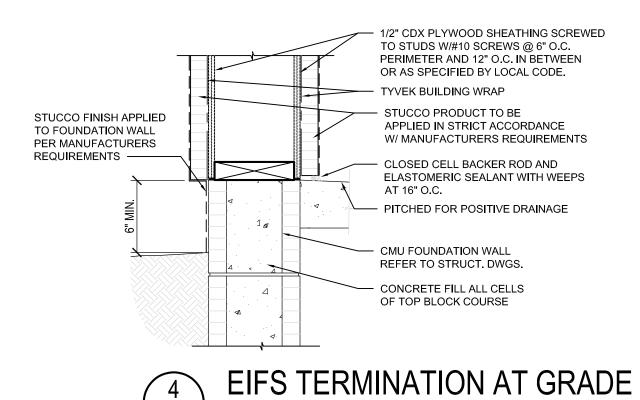

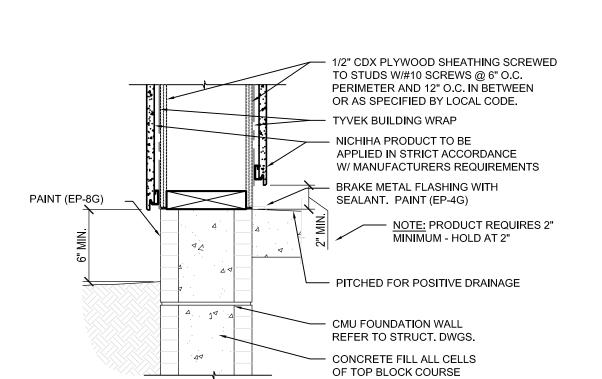

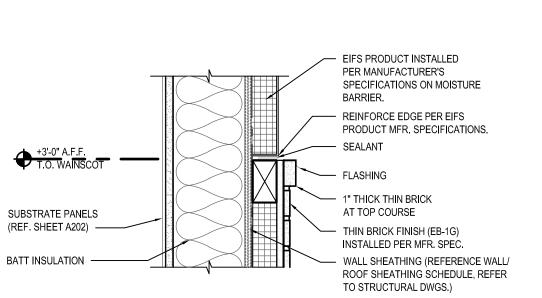

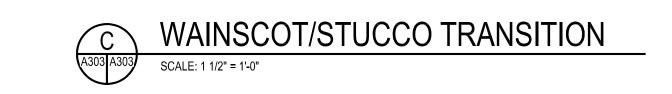

NICHAHA TERMINATION AT GRADE

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04-21-2021 PERMIT SUBMISSION

DESIGNED: DRAWN: J.M.M. S.C.B. CHECKED: SCALE: AS SHOWN 04/21/2021 PROJECT: 2018.0375.05 DRAWING: A303

I hereby certify that these documents were

prepared or approved by me, and that I am

laws of the State of Maryland.

SECTIONS

WALL


duly licensed professional architect under the

License #6140 Expiration Date: 08/21/2022


BURGER

ALTERATIONS


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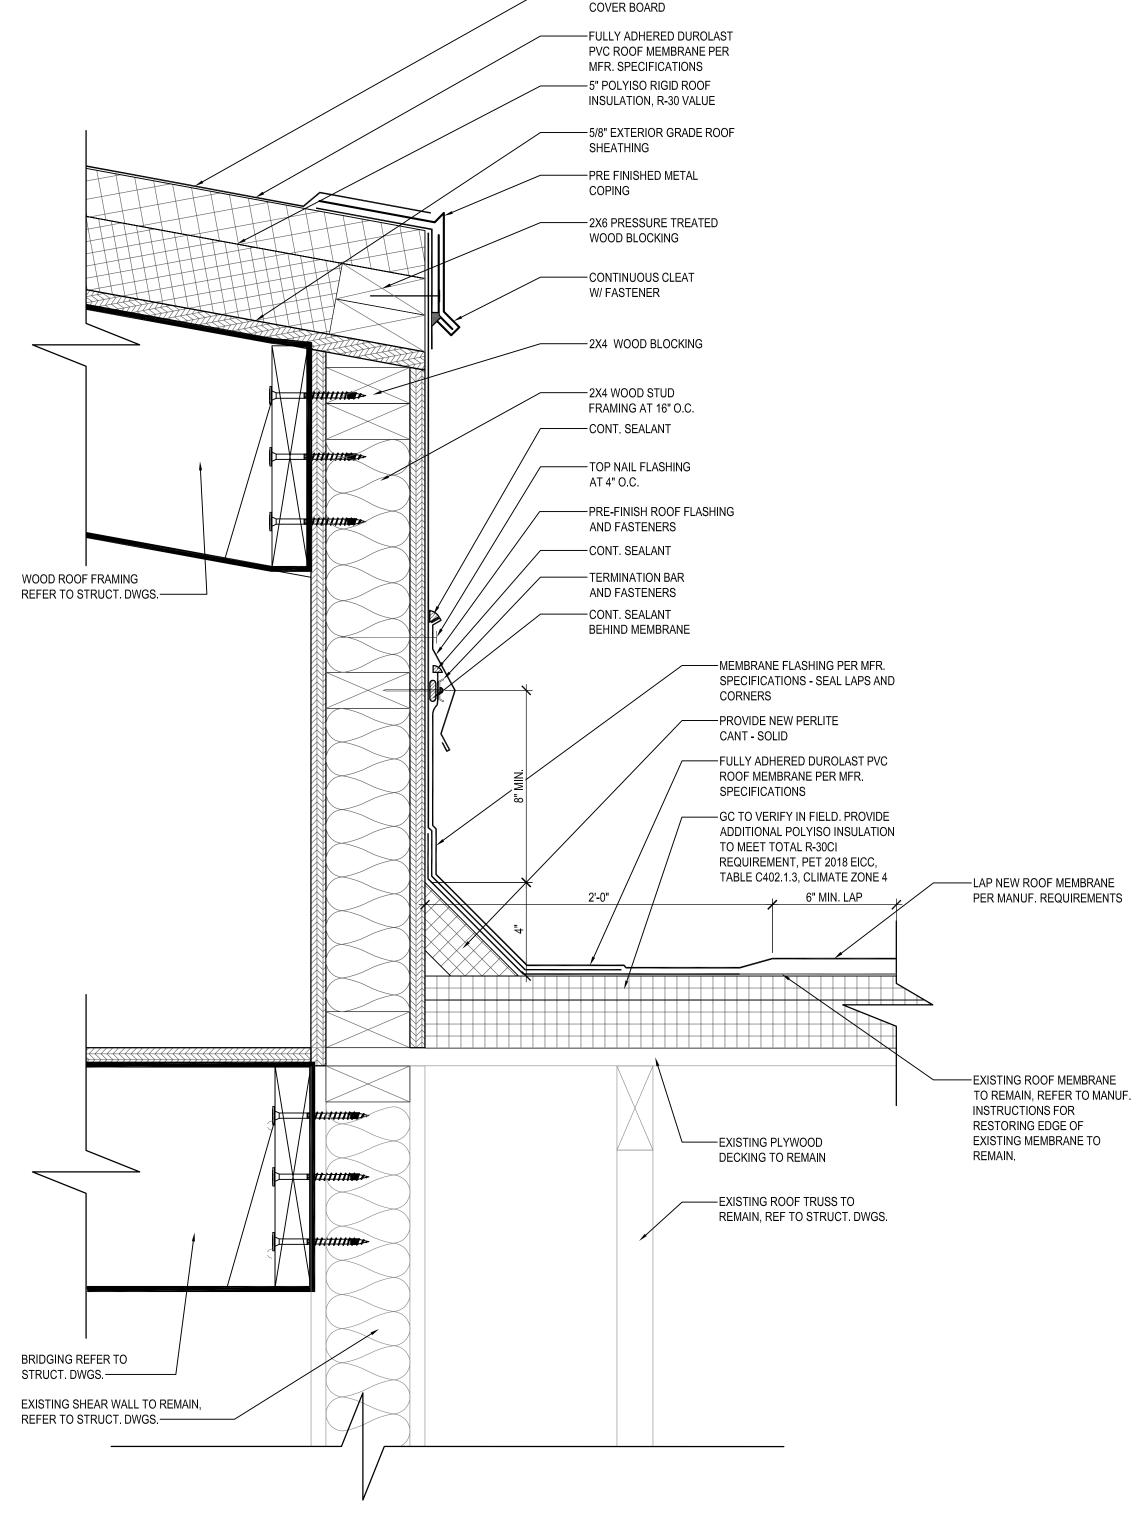


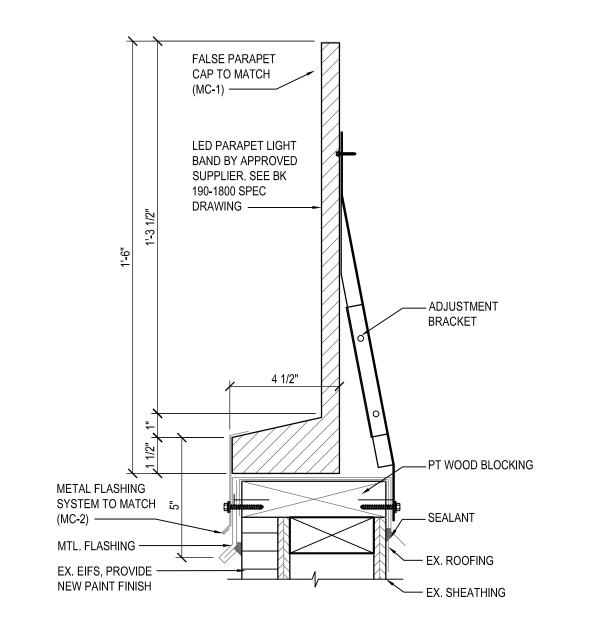



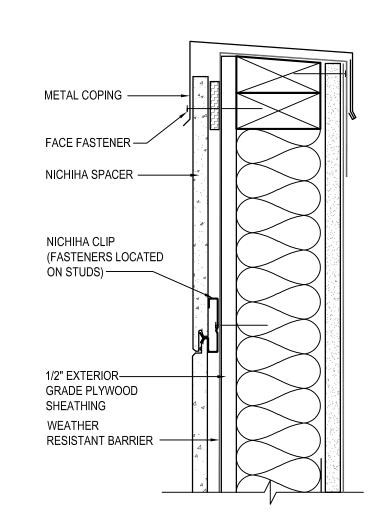




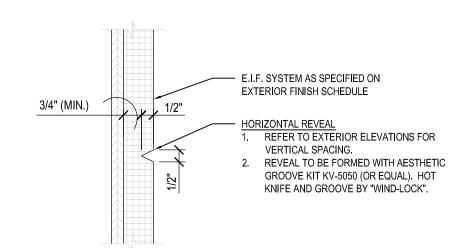

**ROOF DETAIL** 

SCALE: 3" = 1'-0"

-1/2" HIGH DENSITY POLYISO

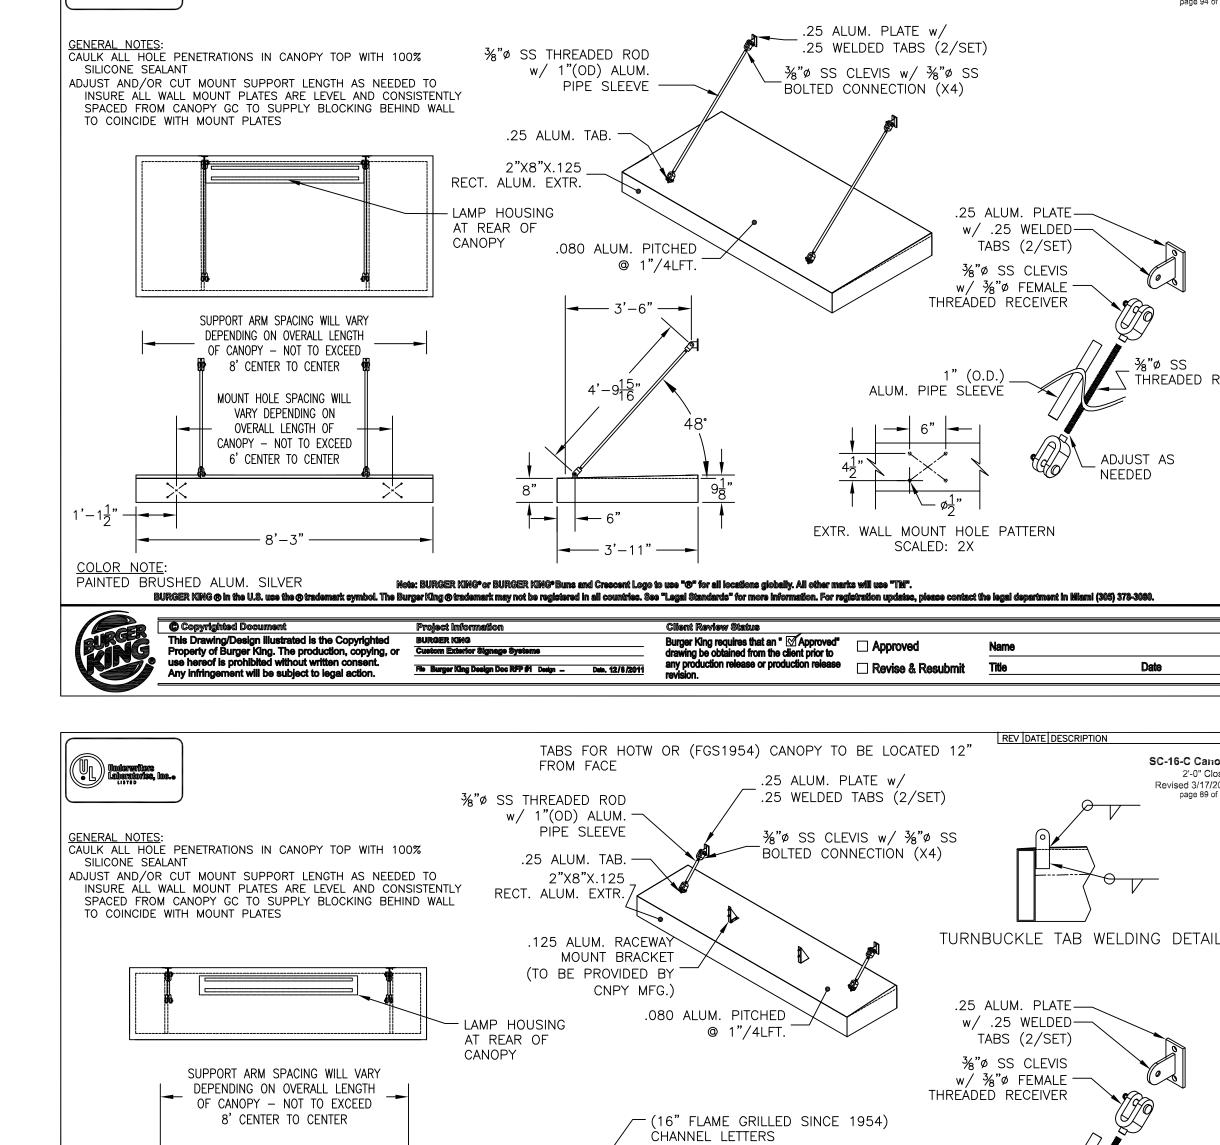

FOR HIGH SNOW AREAS **ONLY** ADD

1½"X1½" ALUM ANGLE FLASHING

GENERAL NOTE: GENERAL CONTRACTOR TO VERIFY SIGNAGE, DINING ROOM WINDOW CANOPY & DRIVE THRU CANOPY WITH OWNER AND BURGER KING, BEFORE ORDER AND INSTALLATION.

MOUNT HOLE SPACING WILL

VARY DEPENDING ON

OVERALL LENGTH OF

CANOPY - NOT TO EXCEED

6' CENTER TO CENTER

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<u>COLOR NOTE</u>: PAINTED BRUSHED ALUM. SILVER

I hereby certify that these documents were prepared or approved by me, and that I am a duly licensed professional architect under the laws of the State of Maryland. icense #6140 Expiration Date: 08/21/2022 BURGER KING SECTIONS

04-21-2021 PERMIT SUBMISSION

REV DATE DESCRIPTION

SC-16-C Canopy

Revised 2/19/2016

THREADED ROD

SC-16-C Canopy

Revised 3/17/2016

\_ %"ø SS \ THREADED ROD

NEEDED

**Date** 

1" (O.D.) ALUM. PIPE SLEEVE

EXTR. WALL MOUNT HOLE PATTERN SCALED: 2X

Burger King requires that an " Approved" Approved drawing be obtained from the client prior to any production release or production release revision.

RUSHED ALUM. SILVER

Note: BURGER KING® or BURGER KING® Burns and Crescent Logo to use "®" for all locations globally. All other marks will use "Tiff".

BURGER KING® in the U.S. use the ® trademark symbol. The Burger King® trademark may not be registered in all countries. See "Legal Standards" for more information. For registration updates, please contact the legal department in kilami (305) 378-3080.

File Burger King Deeign Doc RFP 51 Deeign ... Date. 12/8/2011

2'-0" Closed

ADJUST AS

© WBCM 2020

A304

S.C.B.

AS SHOWN 04/21/2021

2018.0375.05

ALTERATIONS

WALL


DESIGNED: DRAWN: CHECKED:

SCALE:

PROJECT:

DRAWING:

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<u>\_\_2'-6"</u>

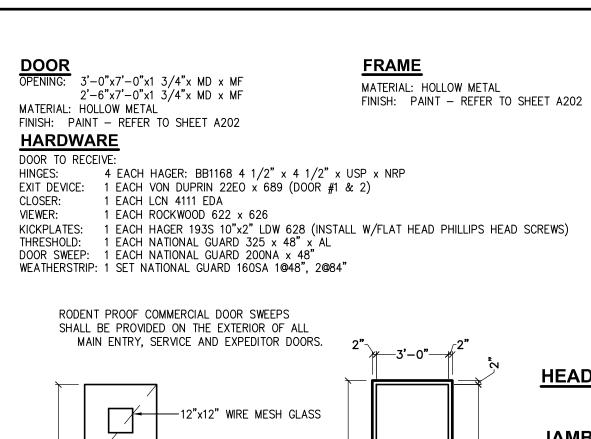5/8" GYP. BOARD W/ PAINT FIN. -

BATT INSULATION ----

FRAMING AT 16" O.C. ——

5/8" EXTERIOR GRADE

PLYWOOD SHEATHING -

RESISTANT AIR/VAPOR

BARRIER, TYPICAL ----

SELF ADHERED WEATHER


NICHIHA CLIP SUPPORT SYSTEM ———

W/ MANUFACTURERS REQUIREMENTS ----

NICHIHA PANEL, PRODUCT TO BE APPLIED IN STRICT ACCORDANCE

2 x 6 WOOD STUD

SCALE: 1/4" = 1'-0"

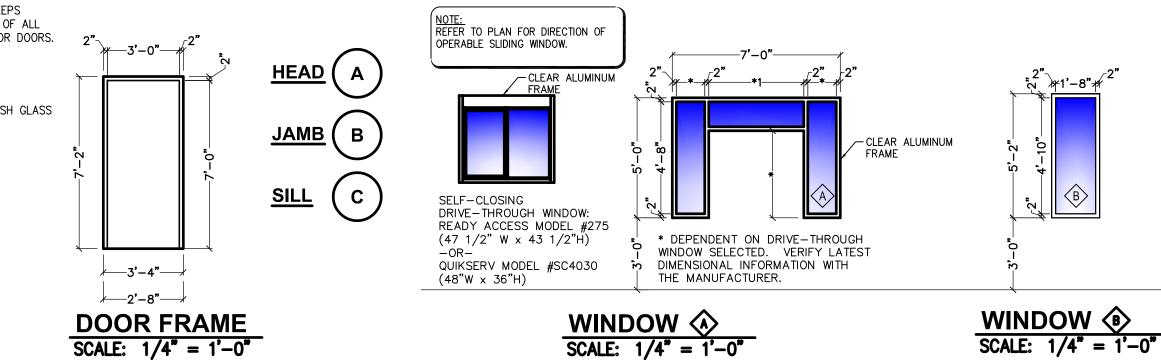

— 2 x 6 WOOD STUD

— 2 x 4 WOOD STUD

FRAMING AT 16" O.C.

FRAMING AT 16" O.C.

- NEW BRICK VENEER WITH ANCHORS

FASTENED THROUGH SHEATHING

TO STUDS (MATCH EXISTING)

- SPACING TO BE 1/8" MAX., TYP.


- NICHIHA OPEN OUTSIDE CORNER,


PAINT FINISH TO MATCH BURGER


- EXPANSION JOINT


AND BACKER ROD


KING STANDARD

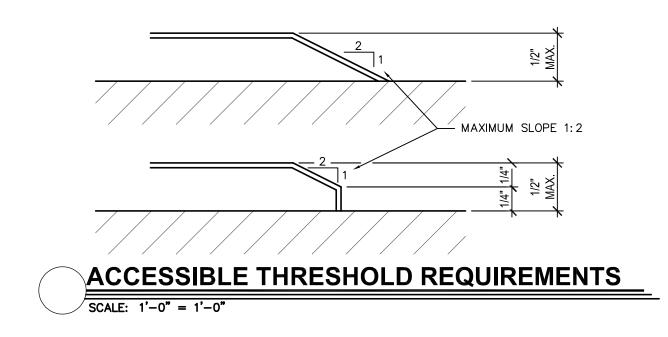


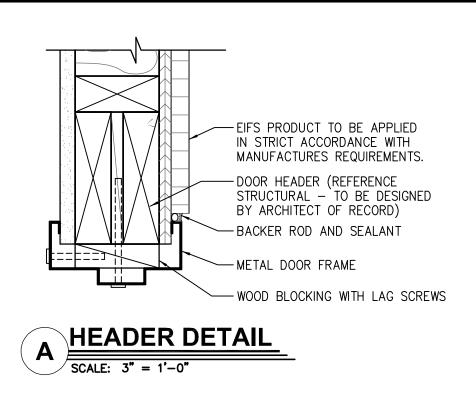


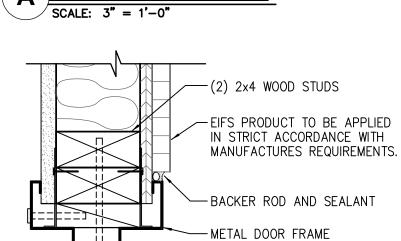


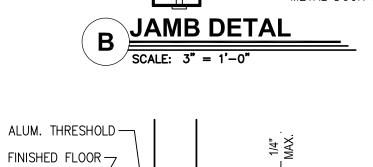

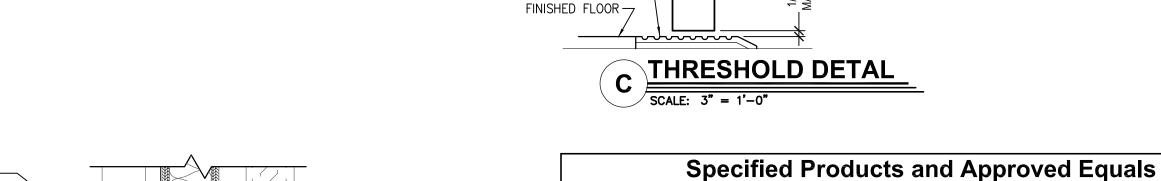

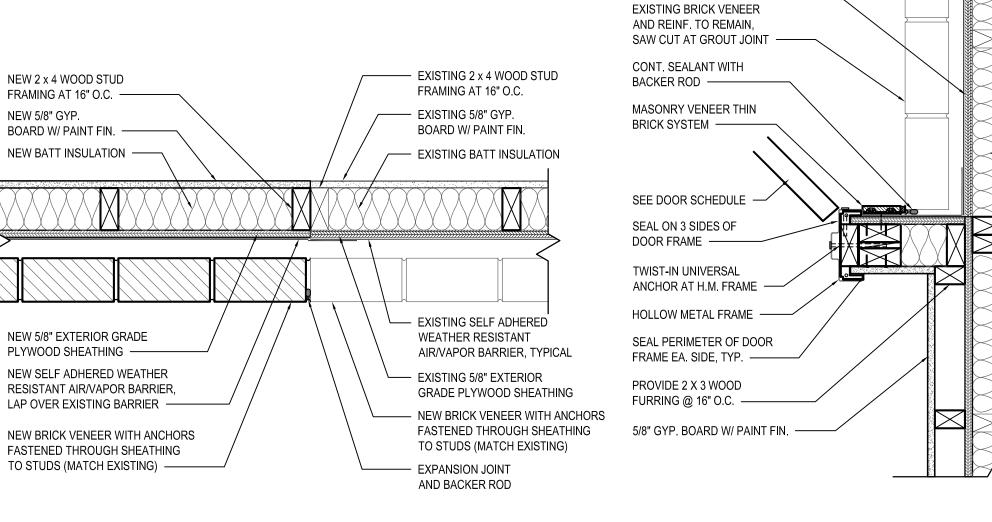

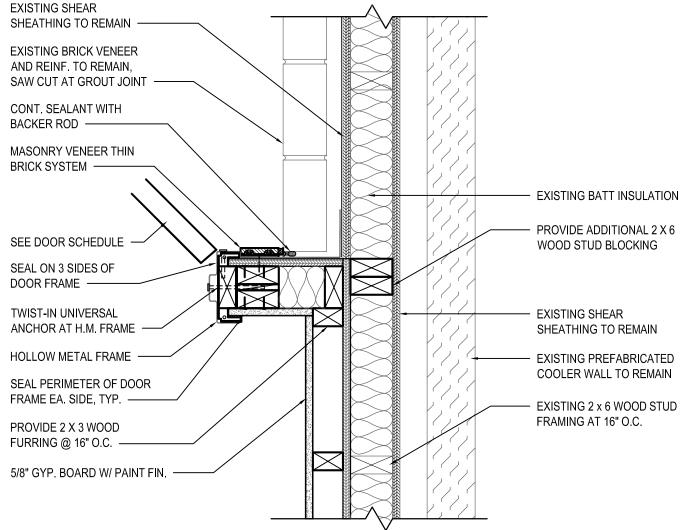

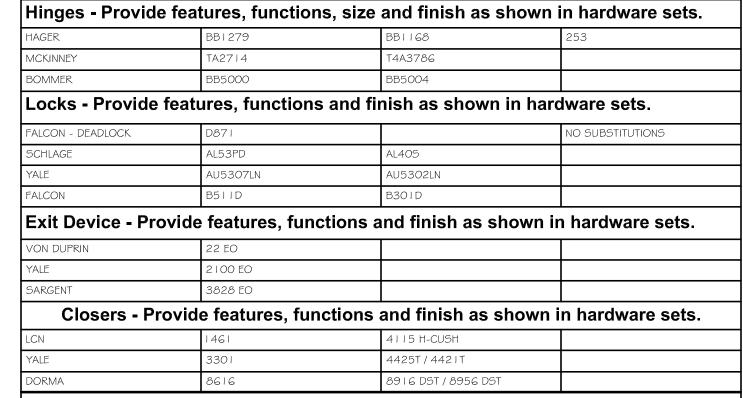

DORMA	8616	8916 DST / 8956 DST	
1	• •	e features, functins, size and finish as show	า in
hardware se			

NATIONAL GUARD	are sets.  THRESHOLD 325A	SWEEP 200NA	WEATHERSTRIP 1605A
РЕМКО	229A	315CN	303A5
ZERO	1675A	39A	99A

HAGER	KICKPLT 1935	PULL PLT H33E	PUSH PLT 305	FL STOP 241F	WALL STOP 236W	VIEWER 1756
ROCKWOOD	K1050 B3E	BF106 X 70C	70C	441CU	409	622
TRIMCO	KO050	1017-3x2 ½ PROJ.	1001-3	1211	1270WV	976U
			<del>-</del>	•		
	hardware se		GWEED	200014	WEATHEDGTDI	P I COSA
Shown in		ts. HRESHOLD 325A	SWEEP	200NA	WEATHERSTRI	P 160SA
	RD TI		SWEEP 315CN		WEATHERSTRI 303AS	P 1605A
NATIONAL GUAR	RD TI	HRESHOLD 325A				P 1605A

CAUTION		A DEDUCTION		
	GRAPHIC S	A REDUCTION SCALES.	,	
	0	0.5	1	
1 1/2"=1	'-0"			

04-21-2021 PERMIT SUBMISSION

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hereby certify that these documents were

prepared or approved by me, and that I am a

duly licensed professional architect under the

License #6140 Expiration Date: 08/21/2022

- BURGER KING

ALTERATIONS

laws of the State of Maryland.

AND DETAILS

DOOR SCHEDULE

DESIGNED: J.M.M.

S.C.B.

AS SHOWN 04/21/2021

2018.0375.05

CHECKED

PROJECT:

DRAWING:

SCALE:

	Thi	s list is intended to assist the contractor in sourcing building mate	rials and products. In many cases, approved Burger King ma	terials and products may be purchased directly from these source	s at a national accounts price. For a complete listing of approved	d manufacturers, see plans and specifications, and visit RSI's eRe	edbook.	
UPDATE: 2-20-2018								
DIVISION 4 - MASONRY	L	DIVISION 9 - FINISHES		DIVISION 15 - MECHANICAL		SIGNS, EQUIPMENT, PLAYGROUNDS AND DÉCOR	I	Ta
PINE HALL BRICK CO. (FACE BRICK) 2701 SHOREFAIR DRIVE, NW WINSTON-SALEM, NC 27105 THERESA BEANE: (800) 334-8689 TBEANE@PINEHALLBRICK.COM	EVOLUTION BRICK (FACE BRICK) 126 OLD HIGHWAY 60 EAST HARDINSBURG, KY 40143 GABE POWERS: (502) 558-4612	FOR FINISH MATERIALS, AND CONTACTS, REFER TO FINIS SECTION OF THE WWW.DES		RINNAI (INSTANT WATER HEATERS) RINNAI NATIONAL ACCOUNT PRICING THROUGH HAINES, JONES, & CADBURY. CONTACT THE BURGER KING CSR AT HJC 800-459-7099 FOR RINNAI TANKLESS WATER HEATER PRICING (MISCELLANEOUS)	EVERPURE, INC (WATER FILTERS) 1040 MUIRFIELD DRIVE HANOVER PARK, IL. 60133 JEANNINE GAINE: 630-240-1298 jeannine.gaine@pentair.com	L.S.I. (MENU BOARDS) 10000 ALLIANCE ROAD CINCINNATI, OH 45242 BRITTANY KOESTER: 513-372-3391 OR 513-315-3725	INTEGRATED CONTROL CORP. (KITCHEN MINDER) 748 PARK AVENUE HUNTINGTON, NY 11743 JOHN PATTI: 631-673-5100 EXT 325	CHARTER HOUSE INC. (DECOR) 4660 136 AVENUE HOLLAND, MI. 49424 BARB ZILM: 800-314-7659 OR 317-774-8880 barbara.zilm@charter-house.com www.gotochi.com
HC MUDDOX BRICK CO. (FACE BRICK) 4875 BRADSHAW ROAD SACRAMENTO, CA 95827 916-859-6320		SUMMITVILLE TILE CO (REPLACEMENT STRATA TILE) 330-223-1511		RHEEM (WATER HEATERS) 101 BELL ROAD MONTGOMERY, AL. 36117 800-621-5622 OR CONTACT HAINES, JONES, & CADBURY (MISCELLANEOUS)	SELECTO SCIENTIFIC, INC (WATER FILTERS) 3980 LAKEFIELD COURT SUWANEE, GA. 30024 EHUD LEVY: 678-475-1445 edlevy@selectoinc.com	FEDERAL HEATH SIGN CO (AWNINGS, CANOPIES AND SIGNS) 12704 DUPONT CIRCLE TAMPA, FL. 33626 FIONA PAUL: 800-284-3284 EXT. 19 fpaul@federalheath.com	DUKE MANUFACTURING (PRODUCT HOLDING UNITS) 2305 NORTH BROADWAY ST. LOUIS MO. 63102 SUE SCIUTO: 800-735-3853 EXT 1260 ssciuto@dukemfg.com	SEATING CONCEPTS (DECOR) 125 CONNELL STREET ROCKDALE, IL. 60436 ZACH DEPYSSLER: 815-483-2244 zdepyssler@seating-concepts.com
DIVISION 5 - METALS  ADDISON STEEL (STRUCTURAL STEEL) ADDISON, IL 256-747-1554		DIVISION 10 - SPECIALTIES  BOBRICK PRODUCTS (RESTROOM ACCESSORIES, TOILET PARTITIONS* AND HARDWARE) CONTACT: HAINES, JONES, & CADBURY (MISCELLANEOUS) *GREEN PRODUCT	KOALA KARE PRODUCTS (BABY CHANGING STATIONS) CONTACT: HAINES, JONES, & CADBURY (MISCELLANEOUS)	A.O. SMITH (WATER HEATERS) 600 E. JOHN CARPENTER FREEWAY, SUITE 200 IRVING, TX. 75062 800-447-1953 972-719-5900	N.C.A. NATIONAL HVAC PRODUCTS, LLC. (AIR CONDITIONING - FULL SERVICE) 4585 140 AVENUE NORTH CLEARWATER, FL. 33762 877-530-0078	CUMMINGS SIGNS, INC (AWNINGS, CANOPIES AND SIGNS) 105 DALTON PLACE WAY KNOXVILLE, TN 37912 AMANDA HICKMAN: 865-862-4416 amanda.hickman@cummingssigns.com	FRYMASTER CORPORATION (FRYERS) 8700 LINE AVE SHREVEPORT, LA 71106 LAURA DODD: 318-865-1711 eqorders@frymaster.com	FCC COMMERCIAL FURNITURE (DECOR) 8452 OLD HWY. 99 NORTH ROSEBURG, OR. 97470 PRESTON O'HARA: 541-464-5284 OR 800-322-7328 EXT 284 preston.ohara@fccfurn.com
		AMERICAN STANDARD (RESTROOM ACCESSORIES) 1 CENTENNIAL AVENUE PISCATAWAY, NJ. 08854 CONTACT HAINES, JONES, & CADBURY (MISCELLANEOUS)	COLUMBIA VORTEX (HAND DRYERS) 825 GARLAND STREET 866-337-7286 EXT. 1136	CARRIER CORPORATION (AIR CONDITIONING) 6304 CARRIER PARKWAY SYRACUSE, NY. 13221 DEBORAH ROY-JONES: 315-432-7941 800-690-1086	LOREN COOK CO (EXHAUST FANS) 2015 E. DALE SPRINGFIELD, MO 65803-4637 KEN DICKSON: 813-966-9200 ken.dickson@tampabay.rr.com	ENTERA SIGNS (AWNINGS, CANOPIES AND SIGNS) 1200 ENTERA DRIVE PANAMA CITY, FL. 32401 850-797-1779	GAYLORD INDUSTRIES (HOODS) 10900 SOUTH AVERY STREET TUALATIN, OR. 97062 JOHN ANDERSON: 971-223-1238 john.anderson@gaylordusa.com	CASABLANCA DESIGN GROUP (DECOR) 811 PICKENS INDUSTRIAL DRIVE MARIETTA, GA 30026 JOHN HARRISON: 770-423-9575 John.Harrison@cdg.com
DIVISION 7 - THERMAL MOISTURE PROTECTION  DURO-LAST ROOFING (FLAT ROOFING) 525 MORLEY DRIVE SAGINAW, MI 48601 LINDY BEUTHIN: 800-432-9331 SAMANTHA PICKELMAN 989-758-1048 OR 989-930-9826	G.A.F. (FLAT ROOF) 1361 ALPS ROAD WAYNE, NJ. 07470 (201) 628-3000 800-766-3411	ZURN INDUSTRIES (PLUMBING FIXTURES) CONTACT: HAINES, JONES, AND CADBURY (MISCELLANEOUS)	WORLD DRYER, CO (HAND DRYERS) CONTACT: HAINES, JONES, AND CADBURY (MISCELLANEOUS)	TRANE (AIR CONDITIONING UNITS, RTU's/SPLIT SYSTEMS CONTROLS) 2884 CORPORATE WAY MIRAMAR, FL. 33025 AL MARTINEZ: 954-499-2289 OR 800-440-9554 bkhvac@trane.com	AMEREX CORPORATION (FIRE PROTECTION SYSTEMS) 7595 GADSDEN HIGHWAY TRUSSVILLE, AL 35173-0081 LISA JONES: 205-655-5760 ljones@amerex-fire.com www.amerex-fire.com	SIGN RESOURCE (AWNINGS, CANOPIES AND SIGNS) 6135 DISTRICT BLVD. MAYWOOD, CA. 90270 RAMON ORTIZ: 323-326-6463 rortiz@signresource.com	LANCER (DRINK DISPENSERS) 6655 LANCER BLVD SAN ANTONIO, TX. 78219 MIKE KRAWETZKE: 817-692-5094 michael.krawetzke@lancercorp.com	FACILITY CONCEPTS, INC (FCI) (DECOR) 7676 ZIONSVILLE ROAD INDIANAPOLIS, IN 46268 KEN WEAVER: 800-915-8890 EXT. 103 kweaver@fcius.com CALVIN DURR: 800-915-8890 EXT 303 cdurr@fcius.com
BERRIDGE ROOFING (METAL ROOF) TYLER HALL SAN ANTONIO, TX. 210-650-7047	TAMKO ROOFING PRODUCTS (FLAT ROOFING) P.O. BOX 1404 JOPLIN, MO. 64802 800-641-4691	SAN JAMAR (RESTROOM ACCESSORIES & SUPPLIES) 555 KOOPMAN LANE ELKHORN, WI. 262-723-6133 www.sanjamar.com OR CONTACT HAINES, JONES, & CADBURY (MISCELLANEOUS)		AMERICAN STANDARD (TOILET, URINAL, FAUCETS) 1 CENTENNIAL AVE. PISCATAWAY, NJ. 08855 800-442-1902 OR CONTACT: HAINES, JONES, & CADBURY (MISCELLANEOUS)		ALLEN INDUSTRIES, INC (AWNINGS, CANOPIES AND SIGNS) 11351 49TH STREET NORTH CLEARWATER, FL 33762 THERESA TRIMMER: 800-677-3075 EXT. 3422 theresa.trimmer@allenindustries.com	NIECO CORPORATION (BROILERS) 7950 CAMERON DRIVE WINDSOR, CA 95492 CHRISTINA NEAT: 707-284-7100 sales@nieco.com	INTERIOR SYSTEMS, INC (DECOR) 241 NORTH BROADWAY, SUITE 600 MILWAUKEE, WI 53202 JIM ZIELINSKI: 414-232-3502 JZielinski@isiamerica.com JASON FREDRICKSON: 414-224-0972 jfredrickson@isiamerica.com
FIRESTONE METAL PRODUCTS (METAL ROOF) 250 WEST 96TH STREET INDIANAPOLIS, IN 46260 YUSUKE KOREEDA: 615-345-9991 koreedayusuke@firestonebp.com	BASF CORPORATION (POLYURETHANE ROOFING SYSTEMS) 1703 CROSS POINT AVE HOUSTON, TX 77054 MOSES M CLARK, JR: 315-263-4665	UNIVERSAL MANUFACTURING (RESTROOM ACCESSORIES) 5366 CRESTVIEW DR. MEMPHIS, TN. 38134 901-458-5881 800-821-1414				LEKTRON, INC (PARAPET LIGHT BANDS) 7450 E. 46th PLACE TULSA, OK. 74145 KEVIN RUBOTTOM 800-634-4059 OR 918-622-4978 EXT 309 krubottom@lektroninc.com	PITCO (FRYERS) 10 FERRY STREET CONCORD, NH. 03301 BONNIE BOLSTER: 603-230-5529 bbolster@pitco.com	COMMERCIAL INTERIOR MANUFACTURERS, (LIMITED DÉCOR ITEMS) 158 HOLLY STREET JASPER, GA. 30143 706-253-4761 STEVE BOUDREAU steve@cimgbiz.com AUSTIN HOLAN austin@cimgbiz.com
QUIKSERV (DRIVE-THRU WINDOWS) 11441 BRITTMOORE PARK DRIVE HOUSTON, TX. 77041 800-388-8307 STEVEN BERT sbert@quikserv.com	MARLITE (DOOR, ALUMINUM FRAMES) 202 HARGER STREET DOVER, NH 44622 800-377-1221 KURT HORSTMANN khorstmann@marlite.com			DIVISION 16 - ELECTRICAL  LSI INDUSTRIES INC. (INTERIOR AND EXTERIOR LIGHTING, SURVEYS AND PHOTOMETRICS) 10000 ALLIANCE ROAD CINCINNATI, OH. 45242 BRITTANY KOESTER: 513-372-3391 OR 513-315-3725	SECURITY LIGHTING SYSTEMS (EXTERIOR SITE AND BUILDING LIGHTING, SURVEYS AND PHOTOMETRICS) 2100 GOLF ROAD, SUITE 460 ROLLING MEADOWS, IL. 60008 ERIC HILLESLAND: 630-636-8493 ehillesland@security lighting.com	FRANKE  (KITCHEN EQUIPMENT, SMALLWARES, HOODS) 800 AVIATION PARKWAY SMYRNA, TN. 37086 CUSTOMER SERVICE: 800-877-5178 fs-bkparts.us@franke.com	TAYLOR ULTIMATE SERVICES, INC (SHAKE MACHINE, FROZEN BEVERAGE MACHINE) 1780 NORTH COMMERCE PKWY WESTON, FL. 33326 TINA SMART: 954-217-9100 tina@taylorus.com	NAUTICAL FURNISHINGS, LLC (LIMITED DÉCOR ITEMS) 60 NW 60TH STREET FT. LAUDERDALE, FL 33309 MICHAEL HOGLUND: 954-771-1100 mhoglund@nauticalfurnishings.com
READY ACCESS (DRIVE THRU WINDOWS & AIR CURTAINS) 1815 ARTHUR DRIVE WEST CHICAGO, IL. 60185 KELLY MCGOLDRICK: 800-621-5045 EXT 113 kelly@ready-access.com	UNIVERSAL MANUFACTURING CO (HOLLOW METAL FRAMES & DOORS, WOOD DOORS, HARDWARE (HINGES, LOCKS, ETC) 5366 CRESTVIEW RD. MEMPHIS, TN. 38134 901-458-5881 OR 800-821-1414			3M SOUND PRODUCTS (DRIVE-THRU SOUND SYSTEM & SATELITE ANTENNA) 3M CENTER BLDG. 223-2N-20 ST. PAUL, MN. 55144-1000 JOE CIAMPI: 704-771-2449 jjciampi@mmm.com	CREE / HERMITAGE LIGHTING NATIONAL ACCOUNTS (INTERIOR AND EXTERIOR LIGHTING, SURVEYS AND PHOTOMETRICS) 3640 TROUSDALE DRIVE NASHVILLE, TN. 37204 STEVE FRIEDMAN: 847-830-1444 OR WYATT CULVER: 615-843-3379 800-264-3383	QUALSERV SOLUTION (KITCHEN EQUIPMENT, SMALLWARES) 7400 SOUTH 28th STREET FORT SMITH, AR. 72908 BECKY DUBOSE: 479-221-1467 bdubose@qualservsolutions.com	PLAY SYSTEMS (DIV. OF SUPERIOR INT. INDUSTRIES, INC) (PLAYGROUND MANUFACTURER) 1050 COLUMBIA DR. CARROLLTON, GA 30717 JUAN CUELLAR: 770-832-6660 EXT. 1517 jcuellar@siibrands.com	ARMSTRONG STRATEGIC ACCOUNTS (CEILING TILE) 2500 COLUMBIA AVENUE LANCASTER, PA. 17604 LOUIS JOHN: 407-697-6768 800-442-4212 ljjohn@armstrongceilings.com OR ARMSTRONG STRATEGIC ACCOUNTS (800) 442-4212
	3M COMMERCIAL CORE DIVISION (WINDOW FILM) 3M CENTER ST. PAUL, MN 704-771-2449 OR 800-328-0033			SECURITY PRODUCTS, INC (REAR DOOR ALARM) 30950 COREAL DRIVE, SUITE B COARSEGOLD, CA. 93614 BOB BARR OR EMILY BEACH: 800-452-5276 orders@security productsinc.com	HM ELECTRONICS, INC (HME) (DRIVE-THRU SOUND SYSTEM) 14110 STOWE DRIVE POWAY, CA. 92064 PAUL KOOSER: 800-848-4468 paulk@hme.com	H & K INTERNATIONAL (KITCHEN EQUIPMENT, SMALLWARES, HOODS) 2200 SKYLINE DR DALLAS, TX 75223 HEATHER VALVERDE: 214-818-3521 heather.valverde@hki.com	SPI INDUSTRIES (PLAYGROUND MANUFACTURER) BOX 100, R.R. #2, JOINT ST. SHALLOW LAKE, ON, NOH 2KO CANADA CYNTHIA MASTERS: 519-935-2174 OR 519-378-4356 cmasters@spiplastics.com www.spiplastics.com	USG INTERIORS (CEILING TILE) CHRIS BENJAMIN: 312-436-5458 cbenjamin@usg.com
				N.C.A. NATIONAL HVAC PRODUCTS, LLC. (MASTER CONTROL SYSTEM) 4585 140 AVENUE NORTH CLEARWATER, FL. 33762 877-530-0078	SUNCOAST ENVIRONMENTAL CONTROLS, INC. (ELECTRICAL SWITCH GEAR) 8655 115th AVENUE NORTH LARGO, FL. 34643 877-544-6679	INTERNATIONAL COLD STORAGE (ICS) (WALK-IN COOLERS / FREEZERS, DRY STORAGE COMPARTMENTS) 215 EAST 13th STREET ANDOVER, KS. 67002 LISA MOORE: 800-835-0001 EXT 4177 lisa.moore@icsco.com	SOFT PLAY, LLC (PLAYGROUND MANUFACTURER, SAFETY SURFACING, NON-CONTAINED PLAY EQUIPMENT) 13620 EAST REESE BLVD. SUITE 300 HUNTERSVILLE, NC. 28078 JIM SWINTEK: 704-948-3448 jim.swintek@softplay.com	MITYLITE (2020 LIGHT CHAIRS AND BARSTOOLS) 1301 WEST NORTH OREM, UT KAREN EDWARDS: 561-213-2810
				HILL PHOENIX POWER SYSTEMS DIVISION (FACTORY INTEGRATED SWITCH GEAR) 8166 INDUSTRIAL BLVD COVINGTON, GA. 30014 PAUL BROWN: 678-699-0129 paul.brown@hillphoenix.com	TRANE CO. (ENERGY MANAGEMENT PANEL) 2884 CORPORATE WAY MIRAMAR, FL. 33025 AL MARTINEZ: 954-499-2289 ammartinez@trane.com	3M FOOD SERVICE BUSINESS (DRIVETHRU COMMUNCATION PRODUCTS, MAINTENANCE PRODUCTS, MATTING AND TRACTION PRODUCTS, MONITOR STRIPS, TAPES AND DISPENSERS, LAMINATING SYSTEMS) 3M CENTER BLDG. 223-2N-20 ST. PAUL, MN. 55144-1000 JOE CIAMPI: 704-771-2449 jjciampi@mmm.com	MOSS RETAIL AND ENVIRONMENTS (GRAPHICS) 2643 WEST CHICAGO AVE CHICAGO, IL 60622 DJ SCANDIFF: 773-435-7600 EXT 617 ROB LORTS: 773-435-7600 EXT 655 rlorts@mossinc.com	TWENTY FOUR 7 GLOBAL SOLUTIONS, INC. (2020 LIGHT AND GARDEN GRILL CHAIRS AN BARSTOOLS) 898 NORTH SEPULVEDA BLVD, SUITE 465 EL SEGUNDO, CA 90245 BARRY WOON: 323-319-2722
						HM ELECTRONICS, INC (HME) (DRIVE-THRU WIRELESS INTERCOMS, DRIVE-THRU SPEED OF SERVICE TIMERS, DIGITAL SURVEILLANCE SYSTEMS) 14110 STOWE DRIVE POWAY, CA. 92064 PAUL KOOSER: 800-848-4468 paulk@hme.com	VGS, INC (GRAPHICS) 1696 MABRY MILL DRIVE, SW NORTH CANTON, OH 44709 GREG MOROZ: 201-528-9680 ORDER EMAIL: BURGERKING@VGS-INC.COM	WAUSAU TILE, INC (EXTERIOR DÉCOR) P.O. BOX 1520 WAUSAU, WI 54402-1520 STEVE THUT: 800-388-8728 EXT 320 sthut@wausautile.com
								MISCELLANEOUS

WHITNEY BAILEY COX & MAGNANI, LLC 300 East Joppa Road Suite 200 Baltimore, MD 21286 410.512.4500 www.wbcm.com	<b>NABCK</b>	Designing Infrastructure for Tomorrow ®
I hereby certify the prepared or appropriate soft the State License #6140 E	oved by me, and ofessional archite of Maryland.  Expiration Date: 0	ents were that I am a ct under the

A701

MISCELLANEOUS

HAINES, JONES, AND CADBURY
(PACKAGE PRICING ON MULTIPLE ITEMS PLUMBING,
TILE, RESTROOM ACCESSORIES, ETC)
310 SW 24TH STREET
BENTONVILLE, AR 72712
BARRY BRYANT:479-899-3555
barry.bryant@hjcinc.com

### STRUCTURAL GENERAL NOTES

### 1. CODE

A. ALL CONSTRUCTION SHALL CONFORM TO 2018 INTERNATIONAL BUILDING CODE, AND HARFORD COUNTY LOCAL AMENDMENTS.

### DESIGN LOADING

A. THE DESIGN DEAD LOAD FOR THE FRAMING IS AS FOLLOWS:

### ROOF DL = 25 PSF

B. THE FOLLOWING LIVE LOADS WERE USED IN DESIGN:

IBC 1603.1.2 - ROOF LIVE LOAD ROOF LIVE LOAD = 30 PSF

IBC 1603.1.3 - ROOF SNOW LOAD

GROUND SNOW LOAD ( $P_G$ ) = 30 PSF FLAT SNOW LOAD ( $P_F$ ) = 21 PSF SNOW EXPOSURE FACTOR ( $C_E$ ) = 1.0 SNOW LOAD IMPORTANCE FACTOR (I) = 1.0 THERMAL FACTOR ( $C_T$ ) = 1.0

IBC 1603.1.4 - WIND LOAD

ULTIMATE DESIGN WIND SPEED  $(V_{ULT})$  = 115 MPH

NOMINAL DESIGN WIND SPEED  $(V_{ASD})$  = 89 MPH

RISK CATEGORY = II

WIND EXPOSURE = C

INTERNAL PRESSURE COEFFICIENT = ±0.18

### 3. GENERAL

- A. THE CONTRACTOR SHALL FIELD CHECK AND VERIFY ALL DIMENSIONS AND ELEVATIONS OF EXISTING WORK PRIOR TO FABRICATION OF ANY NEW MATERIALS.
- B. THE CONTRACTOR IS ADVISED THAT ALL PLANS, DIMENSIONS, AND DETAILS DEPICT FIELD CONDITION AS SHOWN. MINOR VARIATIONS ARE TO BE EXPECTED AND ANY DEVIATIONS FROM THE CONTRACT DOCUMENTS SHALL BE APPROVED BY THE ARCHITECT IN WRITING PRIOR TO PROCEEDING.
- C. IT SHALL BE THE CONTRACTOR'S RESPONSIBILITY TO EXAMINE THE EXISTING BUILDING DURING THE COURSE OF CONSTRUCTION AND IMMEDIATELY ADVISE THE ARCHITECT OF ANY AREAS WHERE THE STRUCTURE EXHIBITS DISTRESS OR FAILURE.
- D. IT IS THE CONTRACTOR'S RESPONSIBILITY TO SATISFY HIMSELF AS TO THE LOCATION OF ANY UTILITIES IN THE IMMEDIATE VICINITY OF CONSTRUCTION SO AS TO PREVENT DAMAGE TO THEM. SHOULD ANY DAMAGE TO SUCH UTILITIES OCCUR THE CONTRACTOR SHALL BE REQUIRED TO REPAIR SUCH DAMAGE AT HIS OWN EXPENSE AND TO THE SATISFACTION OF THE OWNER.
- E. THE CONTRACTOR SHALL PROVIDE ALL SHORING, NEEDLING AND BRACING AS REQUIRED TO SUPPORT THE EXISTING STRUCTURE. THE CONTRACTOR SHALL EXAMINE THE EXISTING STRUCTURE TO DETERMINE THE EXTENT OF NECESSARY SHORING, NEEDLING AND UNDERPINNING. THE CAPACITY AND METHOD USED FOR SHORING AND NEEDLING SHALL BE THE RESPONSIBILITY OF THE CONTRACTOR.
- F. ALL WORK SPECIFIED HEREIN SHALL BE INSPECTED IN ACCORDANCE WITH THE BUILDING CODE AND ALL LOCAL ORDINANCES. THE OWNER OR CONTRACTOR SHALL HIRE AN EXPERIENCED, QUALIFIED INSPECTOR TO PERFORM ALL THE REQUIRED INSPECTION WORK. THE ENGINEER WILL NOT PERFORM THE REQUIRED INSPECTION AS A PART OF THEIR DESIGN SERVICES. THE ENGINEER MAY VISIT THE SITE TO ASCERTAIN GENERAL CONFORMANCE WITH THE CONTRACT DOCUMENTS. SUCH SITE VISITS ARE NOT TO BE CONSTRUED AS MEETING ANY INSPECTION REQUIREMENTS UNLESS THE ENGINEER SPECIFICALLY SO STATES IN WRITING.
- G. ANY REVIEW OF STRUCTURAL ITEM SHOP DRAWINGS BY (THE STRUCTURAL ENGINEER) IS FOR GENERAL CONFORMANCE WITH THE DESIGN CONCEPT AS PRESENTED BY THE CONTRACT DOCUMENTS. NO DETAILED CHECK OF QUANTITIES OR DIMENSIONS WILL BE MADE. SEE WBCM SHOP DRAWING STAMP FOR RESPONSIBILITIES OF EACH PARTY.
- H. SHOP DRAWINGS FOR ALL STRUCTURAL ELEMENTS SHOWN ON THE CONTRACT DOCUMENTS MUST BE SUBMITTED BY THE GENERAL CONTRACTOR. IF A CONTRACTOR OR OWNER FAILS TO SUBMIT THE SHOP DRAWINGS, THE ENGINEER WILL NOT BE RESPONSIBLE FOR THE STRUCTURAL CERTIFICATION OR FOR THE DESIGN OF THE PROJECT.
- I. FOOTINGS ARE DESIGNED FOR AN ASSUMED BEARING CAPACITY OF 2000 PSF.
  CONTRACTOR SHALL VERIFY SOIL PRESSURE IN THE FIELD. IF FOUND TO BE LESS
  THAN THIS VALUE. THE FOOTINGS WILL HAVE TO BE REDESIGNED.

# 4. CAST-IN-PLACE CONCRETE

# 4A. GENERAL CONSTRUCTION

A. ALL CONCRETE WORK SHALL CONFORM TO THE LATEST APPROVED (BY LOCAL GOVERNMENT) EDITIONS OF THE FOLLOWING A.C.I. AND A.S.T.M. DOCUMENTS:

SPECIFICATIONS FOR STRUCTURAL CONCRETE FOR BUILDINGS ACI-301 ACI-302,1R FLOOR AND SLAB CONSTRUCTION BUILDING CODE REQUIREMENTS FOR REINFORCED CONCRETE ACI-214 COMPRESSION TESTS ACI-306 COLD WEATHER ACI-315 DETAILING ACI-347 FORMWORK ACI-305 HOT WEATHER ACI-211 PROPORTIONS OF CONCRETE ACI-304 PLACING CONCRETE

B. ALL FIELD AND LAB TESTING OF CONCRETE SHALL CONFORM TO THE LATEST APPROVED (BY LOCAL GOVERNMENT) EDITIONS OF ASTM:

ACI-ASCE/423 UNBONDED TENDONS

ASTM C94 READY-MIX CONCRETE

ASTM C31 FIELD CYLINDER SPECIMENS ASTM C143 SLUMP TEST ASTM C231 AIR CONTENT (WHEN REQUIRED) ASTM C39 LAB TESTING CYLINDERS ASTM C172 SAMPLING FRESH CONCRETE ASTM C42 HARDENED CORES (WHEN REQUIRED)

- C. ALL CONCRETE, UNLESS NOTED OTHERWISE, SHALL BE STONE AGGREGATE CONCRETE HAVING A MINIMUM COMPRESSIVE STRENGTH OF 4000 PSI AT 28 DAYS. ALL CONCRETE EXPOSED TO WEATHER SHALL HAVE AN AIR ENTRAINMENT OF 5%±1%. NO ADMIXTURES CONTAINING CALCIUM CHLORIDE SHALL BE PERMITTED. MAXIMUM AGGREGATE SIZE FOR CONCRETE SHALL BE 1", AND MAXIMUM SLUMP SHALL BE 4", AND 3" FOR SLABS ON GRADE. ALL CONCRETE, EXCEPT FOOTINGS, SHALL CONTAIN A WATER REDUCING ADMIXTURE.
- D. ALL CONCRETE MIX DESIGNS AND ADMIXTURES SHALL BE APPROVED BY THE ARCHITECT 30 DAYS PRIOR TO INITIATION OF FIRST POUR.

- E. ALL REINFORCING BARS SHALL CONFORM TO ASTM A-615 GRADE 60. WELDED WIRE FABRIC SHALL CONFORM TO ASTM A-185.
- F. CONCRETE EXPOSED TO PUBLIC VIEW SHALL MEET THE REQUIREMENTS FOR
- G. ALL FORMWORK SHALL BE IN ACCORDANCE WITH THE AMERICAN CONCRETE INSTITUTE "FORMWORK FOR CONCRETE", SPECIAL PUBLICATION NO. 4 AND ACI'S "STANDARD RECOMMENDED PRACTICE FOR CONCRETE FORMWORK" (ACI-347, LATEST LOCAL APPROVED EDITION).
- H. ALL LAP SPLICES SHALL BE CLASS "B" (1'-0" MIN.) EXCEPT AS NOTED ON PLANS. BEND OUTSIDE FACE WALL HORIZONTAL REINFORCING 1'-0" AROUND ALL CORNERS OR PROVIDE 4'-0" LONG CORNER BARS TO MATCH HORIZONTAL
- I. PROVIDE CONCRETE PROTECTION FOR REINFORCING BARS AS FOLLOWS:

## FOOTINGS 3"

- WHERE CONTINUOUS BARS ARE CALLED FOR, THEY SHALL BE RUN CONTINUOUSLY AROUND CORNERS AND LAPPED AT NECESSARY SPLICES OR HOOKED AT DISCONTINUOUS ENDS. LAPS SHALL BE NOT LESS THAN THE TYPICAL SPLICE LENGTH UNLESS NOTED.
- K. REINFORCEMENT SHALL BE CONTINUOUS THROUGH ALL CONSTRUCTION JOINTS UNLESS OTHERWISE INDICATED ON THE DRAWINGS. AT VERTICAL CONSTRUCTION JOINTS.

### WOOD FRAMING

### 5A. GENERAL WOOD FRAMING

- A. STRUCTURAL SOLID WOOD JOISTS, BEAMS, COLUMNS AND STUDS SHALL BE SOUTHERN PINE #2 SURFACED DRY AT A MAXIMUM OF 19% MOISTURE CONTENT. ALL FABRICATION, ERECTION, OTHER PROCEDURES, AND MINIMUM UNIT STRESSES SHALL CONFORM TO THE CURRENT "NATIONAL DESIGN SPECIFICATION FOR WOOD CONSTRUCTION".
- B. ALL WOOD FRAMING SHALL BE FABRICATED AND ERECTED IN ACCORDANCE WITH THE AMERICAN INSTITUTE OF TIMBER CONSTRUCTION SPECIFICATION AITC 105 "RECOMMENDED PRACTICE FOR THE ERECTION OF STRUCTURAL TIMBER FRAMING, AITC 106," "CODE OF STANDARD PRACTICE", AND "THE NATIONAL DESIGN SPECIFICATION FOR WOOD CONSTRUCTION", LATEST EDITION, AS PUBLISHED BY THE NATIONAL FOREST PRODUCTS ASSOCIATION.
- C. ALL WOOD PLATES BEARING ON CONCRETE WALL SHALL BE WOLMANIZED PRESSURE TREATED LUMBER AS MANUFACTURED BY KOPPERS COMPANY OR AN APPROVED ALTERNATE.
- D. ANCHOR ALL SILL PLATES TO CONCRETE SLABS OR MASONRY WALLS WITH 5/8"
  DIAMETER ANCHOR BOLTS WITH 15" MIN. EMBEDMENT DEPTH AND 2" HOOK
  SPACED AT MAX. 32" ON CENTER. PROVIDE 2 ANCHOR BOLTS MINIMUM PER PLATE.
- E. ALL LAMINATED VENEER LUMBER (LVL) SHALL BE FABRICATED TO PRODUCE THE FOLLOWING MINIMUM ALLOWABLE STRESSES:

EXTREME FIBER IN BENDING F = 2,900 PSI
MODULUS OF ELASTICITY E = 2,000,000 PSI

### 5B. WOOD WALLS AND COLUMNS

- A. ALL PERIMETER STUD BEARING WALLS AND INTERIOR BEARING WALLS SHALL BE 2X6 @ 16" O/C UNLESS NOTED OTHERWISE. PROVIDE SOLID BRIDGING AT MID HEIGHT OF ALL STUD WALLS TO 9'-0" HIGH UNLESS NOTED OTHERWISE. STUD WALLS OVER 9'-0" SHALL BE PROVIDED WITH 2 ROWS OF SOLID BRIDGING LOCATED AT THE THIRD POINT OF THE STUD HEIGHT UNLESS NOTED OTHERWISE.
- B. PROVIDE DOUBLE STUDS AT ALL CORNERS, SIDES OF ALL OPENINGS, WINDOWS AND DOORS, AND BENEATH ALL WOOD BEAMS AND LINTELS UNLESS NOTED OTHERWISE ON PLANS. DOUBLE STUDS BENEATH WOOD BEAMS AND LINTELS SHALL BE CARRIED THROUGH ANY INTERMEDIATE FLOOR FRAMING TO THE TOP OF FOOTINGS OR MASONRY FOUNDATION WALLS.

# 5C. PLYWOOD

- A. ALL PLYWOOD SHALL MEET THE REQUIREMENTS OF THE PLYWOOD DESIGN SPECIFICATIONS AS PUBLISHED BY THE AMERICAN PLYWOOD ASSOCIATION.
- B. ENTIRE ROOF DECK SHALL BE 5/8"-24/0 PLYWOOD. PROVIDE PLY CLIPS AT CENTERLINE OF PLYWOOD SPAN AT ALL EDGES PARALLEL TO SPAN.
- C. PLYWOOD SHEATHING SHALL BE CONTINUOUS OVER A MINIMUM OF 2 SPANS.
- D. PLYWOOD SHALL BE SECURELY FASTENED 3/8" FROM THE EDGE.
- E. PLYWOOD 1/2" IN THICKNESS AND LESS SHALL BE PROVIDED WITH PLY-CLIPS ALONG EDGES AT MIDSPAN. PLYWOOD 5/8" AND THICKER SHALL EITHER HAVE TONGUE AND GROOVE EDGES OR PLY-CLIPS AT MIDSPAN. FOR 48" SPANS PROVIDE 2 PLY CLIPS AT THIRD JOINTS OR TONGUE AND GROOVE PLYWOOD.
- MINIMUM NAIL SIZE NO. 11 GAGE, 1-3/4" LONG, 7/16" HEAD, DIAMOND POINT, GALVANIZED. ALTERNATE NAILS MAY BE USED IF THEIR DIMENSIONS ARE NOT LESS THAN THE SPECIFIED VALUES.
- G. END JOINTS OF ADJACENT COURSES OF GYPSUM BOARD SHEATHING SHALL NOT OCCUR OVER THE SAME STUD.
- H. WHERE BLOCKING IS REQUIRED BLOCKING SHALL BE THE SAME SIZE AS TYPICAL STUDS AND SHALL BE PROVIDED AT ALL JOINTS THAT ARE PERPENDICULAR TO STUDS
- I. NAILS SHALL BE SPACED NOT LESS THAN 3/8" FROM EDGES AND ENDS OF GYP BOARD SHEATHING.
- J. NAIL SPACING SPECIFIED APPLIES TO ALL STUDS, TOP AND BOTTOM PLATES, AND BLOCKING.

### 6. STRUCTURAL AND MISCELLANEOUS STEEL

### A. GENERAL AND NEW CONSTRUCTION

- 1) ALL STRUCTURAL AND MISCELLANEOUS STEEL SHALL CONFORM TO THE FOURTEENTH EDITION OF THE AISC "SPECIFICATION FOR STRUCTURAL STEEL BUILDINGS" AND ALL ITS SUPPLEMENTS, AND TO THE AISC "CODE OF STANDARD PRACTICE FOR STEEL BUILDINGS AND BRIDGES."
- 2) ALL STRUCTURAL STEEL SHALL BE AS FOLLOWS:

W-SHAPES ASTM A992, FY = 50,000 PSI
MISCELLANEOUS STEEL ASTM A572 GRADE 50, FY = 50,000 PSI
RECTANGULAR/SQUARE HSS ASTM A500 GRADE C, FY = 50,000 PSI

- 3) NO OPENINGS IN BEAMS SHALL BE PERMITTED WITHOUT THE WRITTEN PERMISSION OF THE ENGINEER.
- 4) THE USE OF A GAS-CUTTING TORCH IN THE FIELD FOR CUTTING HOLES OR FOR CORRECTIONS FABRICATION ERRORS WILL NOT BE PERMITTED ON NEW STRUCTURAL FRAMING MEMBERS EXCEPT WITH THE WRITTEN APPROVAL OF THE ARCHITECT FOR EACH SPECIFIC CONDITION.
- 5) FIELD STRUCTURAL STEEL TO BE INSPECTED BY QUALIFIED INSPECTORS APPROVED BY THE STRUCTURAL ENGINEER AND RETAINED BY THE CONTRACTOR. FIELD INSPECTION REPORTS TO BE FILED WITH THE STRUCTURAL ENGINEER WITHIN 5 DAYS OF TIME OF ACTUAL INSPECTION. INSPECTORS MUST BE NOTIFIED OF ALL PHASES OF CONSTRUCTION AND WELDING BY GENERAL CONTRACTOR.
- 6) ALL WELDED CONNECTIONS SHALL BE DONE WITH E70XX ELECTRODES. SHOP AND FIELD WELDS SHALL BE MADE BY APPROVED CERTIFIED WELDERS AND SHALL CONFORM TO THE AMERICAN WELDING SOCIETY CODE FOR BUILDINGS AWS D1.1. WELDS SHALL DEVELOP THE FULL STRENGTH OF MATERIALS BEING WELDED UNLESS OTHERWISE NOTED.
- 7) ALL BUTT WELDS SHALL BE FULL PENETRATION BUTT WELDS IN ACCORDANCE WITH THE STRUCTURAL WELDING CODE (ANSI/AWS D1.1). THESE WELDS SHALL BE MADE ONLY BY OPERATORS QUALIFIED BY PRESCRIBED TESTS IN THE STRUCTURAL WELDING CODE IN BUILDING CONSTRUCTION OF THE AMERICAN WELDING SOCIETY. ACCEPTANCE TO BE SUBJECT TO THE INSPECTION AND REVIEW OF AN INDEPENDENT INSPECTION AGENCY.
- 8) WELDING SEQUENCE AND TECHNIQUE SHALL BE SUCH THAT DISTORTION OF STEEL MEMBERS IS MINIMIZED AND UNDUE DISTORTION IS AVOIDED.

### 7. POST-INSTALLED ANCHORS

### A. ANCHORS IN CONCRETE AND MASONRY

- POST INSTALLED ANCHORS SHALL BE USED ONLY WHERE SPECIFIED ON STRUCTURAL CONTRACT DRAWINGS
- 2) THE INSTALLATION OF POST INSTALLED ANCHORS FOR MISSING OR MISPLACED CAST IN-PLACE ANCHORS SHALL BE APPROVED BY THE ENGINEER OF RECORD
- 3) EXISTING EMBEDDED ITEMS IN THE CONCRETE STRUCTURE (I.E., REINFORCING BARS, CONDUIT, ETC.) SHALL NOT BE CUT UNLESS APPROVED BY THE STRUCTURAL ENGINEER OF RECORD.
- 4) SUBMITTAL OF ALL PROPOSED PRODUCTS, WITH TECHNICAL DATA AND CURRENT ICC-ESR REPORTS IS REQUIRED FOR REVIEW AND APPROVAL BY ENGINEER OF RECORD. ADDITIONAL APPLICATION CALCULATIONS MAY BE REQUIRED BY THE ENGINEER OF RECORD.
- 5) ALL ANCHORS SHALL BE INSTALLED IN STRICT ACCORDANCE WITH MANUFACTURER'S PRINTED INSTALLATION INSTRUCTIONS (MPII) IN CONJUNCTION WITH EDGE DISTANCE, SPACING AND EMBEDMENT DEPTH AS INDICATED ON THE CONTRACT DRAWINGS.
- 6) THE CONTRACTOR SHALL ARRANGE FOR A MANUFACTURER'S FIELD REPRESENTATIVE TO PROVIDE INSTALLATION TRAINING FOR ALL PRODUCTS TO BE USED, PRIOR TO COMMENCEMENT OF WORK. ONLY TRAINED INSTALLERS SHALL PERFORM POST INSTALLED ANCHOR INSTALLATION. A RECORD OF TRAINING SHALL BE KEPT ON SITE AND BE MADE AVAILABLE TO THE ENGINEER OF RECORD AS REQUESTED.
- 7) ADHESIVE ANCHORS INSTALLED IN HORIZONTAL TO VERTICALLY OVERHEAD ORIENTATION TO SUPPORT SUSTAINED TENSION LOADS SHALL BE DONE BY A CERTIFIED ADHESIVE ANCHOR INSTALLER (AAI) AS CERTIFIED THROUGH ACI/CRSI (ACI 318-14 17.8). PROOF OF CURRENT CERTIFICATION SHALL BE SUBMITTED TO THE ENGINEER FOR APPROVAL PRIOR TO COMMENCEMENT OF INSTALLATION.
- 8) ADHESIVE ANCHORS MUST BE INSTALLED IN CONCRETE AGED A MINIMUM OF 21 DAYS (ACI 318-14 17.1.2).
- 9) PROVIDE SPECIAL INSPECTION FOR ALL MECHANICAL AND ADHESIVE ANCHORS PER THE APPLICABLE BUILDING CODE AND PER THE CURRENT ICC-ES REPORT (IBC 2015 TABLE 1705.3 NOTE B).
- 10) SUBSTITUTION REQUESTS, FOR PRODUCTS OTHER THAN THOSE SPECIFIED BELOW, SHALL BE SUBMITTED BY THE CONTRACTOR TO THE ENGINEER OF RECORD ALONG WITH CALCULATIONS THAT ARE PREPARED & SEALED BY A REGISTERED PROFESSIONAL ENGINEER. THE CALCULATIONS SHALL DEMONSTRATE THAT THE SUBSTITUTED PRODUCT IS CAPABLE OF ACHIEVING EQUIVALENT PERFORMANCE VALUES (MINIMUM) OF THE SPECIFIED PRODUCT USING THE APPROPRIATE DESIGN PROCEDURE AND/OR STANDARDS(S) AS REQUIRED BY ACI 318-14 CHAPTER 17.
- 11) THE FOLLOWING MANUFACTURER'S HAVE BEEN PRE-APPROVED FOR SUBMITTAL.
- a. POWERS FASTENERS
- b. HILTI INCc. SIMPSON

- B. CONCRETE ANCHORS
- 1) MECHANICAL ANCHORS SHALL HAVE BEEN TESTED AND QUALIFIED FOR USE IN ACCORDANCE WITH ACI 355.2 AND ICC-ES AC193 FOR CRACKED, UNCRACKED AND SEISMIC CONCRETE RECOGNITION.
- 2) ADHESIVE ANCHORS SHALL HAVE BEEN TESTED AND QUALIFIED FOR USE IN ACCORDANCE WITH ACI 355.4 AND ICC-ES AC308 FOR CRACKED, UNCRACKED AND SEISMIC CONCRETE RECOGNITION.
- 3) CAST-IN-PLACE INSERTS SHALL HAVE BEEN TESTED AND QUALIFIED FOR USE IN ACCORDANCE WITH ICC-ES AC446 FOR CRACKED, UNCRACKED AND SEISMIC CONCRETE RECOGNITION.

### C. MASONRY ANCHORS

- 1) MECHANICAL ANCHORS SHALL HAVE BEEN TESTED AND QUALIFIED FOR USE IN ACCORDANCE WITH ICC-ES AC01 OR AC106.
- 2) ADHESIVE ANCHORS SHALL HAVE BEEN TESTED AND QUALIFIED FOR USE IN ACCORDANCE WITH ICC-ES AC58.

### 8. MASONRY

- A. ALL MASONRY CONSTRUCTION AND MATERIALS USED THEREIN (CONCRETE MASONRY, CLAY MASONRY, MORTAR, GROUT AND STEEL REINFORCEMENT) SHALL CONFORM TO "BUILDING CODE REQUIREMENTS FOR MASONRY STRUCTURES" (ACI 530/ASCE 5/TMS 402) AND "SPECIFICATIONS FOR MASONRY STRUCTURES" (ACI 530.1/ASCE 6/TMS 602) IN ALL RESPECTS. WHERE ANCHORS (INCLUDING ANCHOR BOLTS) ARE INDICATED TO BE GROUTED IN CELLS OF HOLLOW CMU, THE CELL CONTAINING THE ANCHOR (OR ANCHOR BOLT) SHALL BE FULLY GROUTED AND IN ADDITION TO THIS CELL THE CELLS ABOVE, BELOW, TO EACH SIDE, AND THE FOUR CELLS ON EACH 45 DEGREE DIAGONAL ADJACENT TO THE CELL CONTAINING THE ANCHOR/ANCHOR BOLT SHALL BE FULLY GROUTED AND THE EIGHT SURROUNDING CELLS SHALL BE FULLY GROUTED.
- B. UNLESS OTHERWISE NOTED CONCRETE MASONRY UNITS SHALL HAVE A MINIMUM NET AREA COMPRESSIVE STRENGTH OF 2,000 PSI. TYPE "S" PORTLAND CEMENT/LIME MORTAR SHALL BE USED FOR ALL MASONRY.
- C. MASONRY BEARING WALLS SHALL CONSIST OF STANDARD HOLLOW UNITS CONFORMING TO ASTM C 90 UNLESS OTHERWISE NOTED. WHERE SOLID UNITS ARE REQUIRED, PROVIDE UNITS CONFORMING TO ASTM C 145. CONCRETE MASONRY SHALL BE SAMPLED AND TESTED BY THE MASONRY SUPPLIER ACCORDING TO THE REQUIREMENTS OF "BUILDING CODE REQUIREMENTS FOR MASONRY STRUCTURES" (ACI 530/ASCE 5/TMS 402) AND "SPECIFICATIONS FOR MASONRY STRUCTURES" (ACI 530.1/ASCE 6/TMS 602) AND RESULTS SUBMITTED TO THE ENGINEER FOR APPROVAL. USE FULL HEAD JOINTS, FILL COLLAR JOINTS 100% SOLID, BOND PIERS INTO WALLS BY TOOTHING, AND BOND WALLS TO CROSS-WALLS BY TOOTHING.
- D. ALL MORTAR SHALL CONFORM TO THE REQUIREMENTS FOR PROPORTIONS, MIXING, STRENGTH, SAMPLING, TESTING, AND APPLICATION FOR PORTLAND CEMENT/LIME TYPE "S" MORTAR AS DESCRIBED IN ACI 530.
- E. MASONRY CONSTRUCTION IS TO BE INSPECTED BY AN EXPERIENCED, QUALIFIED INSPECTOR APPROVED BY THE STRUCTURAL ENGINEER. INSPECTION IS TO BE PROVIDED IN ACCORDANCE WITH THE ACI/ASCE/TMS CODE AND SPECIFICATION.
- F. ALL SOLID CMU IS TO BE 100% SOLID CMU OR HOLLOW CMU WITH ALL CELLS FILLED 100% WITH GROUT CONFORMING TO ASTM C 476.
- G. LOOSE LINTELS FOR MASONRY WALLS SHALL BE FOR EACH 4" WIDTH OF MASONRY ONE STEEL ANGLE AS FOLLOWS:
  - 0'-0" TO 3'-0" ∠3 1/2" x 3 1/2" x 5/16"
  - 3'-1" TO 5'-0" ∠4" x 3 1/2" x 5/16"
  - 5'-1" TO 6'-6" ∠5" x 3 1/2" x 3/8" 6'-7" TO 8'-0" ∠6" x 3 1/2" x 3/8"
- H. ALL ANGLES SHALL HAVE THEIR SHORT LEG OUTSTANDING AND 6" MINIMUM BEARING LINTELS OVER OPENINGS IN INTERIOR NON-BEARING MASONRY PARTITIONS NOT OTHERWISE SPECIFIED SHALL BE PRECAST LIGHTWEIGHT CONCRETE LINTELS WITH 1 NO. 5 BAR TOP AND BOTTOM FOR EACH 4" WIDTH. ALL MULTIPLE ANGLE LINTELS SHALL BE TACK WELDED TOGETHER AT ENDS AND AT THIRD POINTS. SHORE LINTELS TO PREVENT ROTATION DURING CONSTRUCTION.
- I. LAP ALL VERTICAL REINFORCING 48 BAR DIAMETERS MINIMUM.
- J. ALL EXTERIOR WALLS AND ALL WALLS SUPPORTING LOADS OTHER THAN THEIR OWN WEIGHT SHALL BE CONSTRUCTED OF LOAD BEARING UNITS.
- K. ALL MASONRY WALLS SHALL BE REINFORCED WITH NO. 9 GAGE TRUSS-TYPE HOT DIPPED GALVANIZED JOINT REINFORCEMENT SPACED VERTICALLY AT 16" O/C U.N.O. PROVIDE CORNER AND TEE PIECES AT ALL INTERSECTIONS. LAP ALL JOINT REINFORCEMENT 6" MINIMUM.
- L. PROVIDE 16" MINIMUM DEPTH OF 100% SOLID MASONRY OR HOLLOW BLOCK FILLED SOLID WITH GROUT BELOW ALL LINTELS.
- M. BRACE AND SHORE ALL NEW MASONRY WALLS AS REQUIRED UNTIL ROOF DECKS HAVE BEEN COMPLETELY INSTALLED.
- N. PROVIDE SOLID BLOCK OR FILL WALL SOLID WITH GROUT DIRECTLY BELOW ALL CHANGES IN WALL THICKNESS OR CONSTRUCTION AS REQUIRED TO PROVIDE CONTINUOUS BEARING FOR ALL FACE SHELLS OF BLOCK.
- O. PROVIDE 8" DEEP SOLID BEARING BELOW ALL WOOD JOISTS AND STUDS BEARING ON MASONRY WALLS. SOLID BEARING SHALL BE SOLID BLOCK OR BRICK OR HOLLOW BLOCK FILLED SOLID WITH GROUT.

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Designing Infrastructure for Tomorrow ®

prepared or approved by me, and that I am a duly licensed professional engineer under the laws of the State of Maryland.

License # \_\_\_\_\_ Expiration Date: \_\_/\_/2022

I hereby certify that these documents were

ALTERATIONS - BURGERS OF BALTIMORE, LLC.

DESIGNED: FC

DRAWN: CG

CHECKED: MWS

SCALE: AS NOTED

DATE: 01/18/2021


PROJECT: 2018.0375.05

DRAWING:

S001

02-26-2021 PERMIT SUBMISSION

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	SIZ	ĽΕ	REINFOF	RCEMENT
MARK	DEPTH	WIDTH	LONGITUDINAL	TRANSVERSAL
WF-1	12"	3'-0"	(4) #5 CONT.	#5 @ 24" O/C
WF-2	12"	2'-0"	(3) #5 CONT.	#5 @ 24" O/C

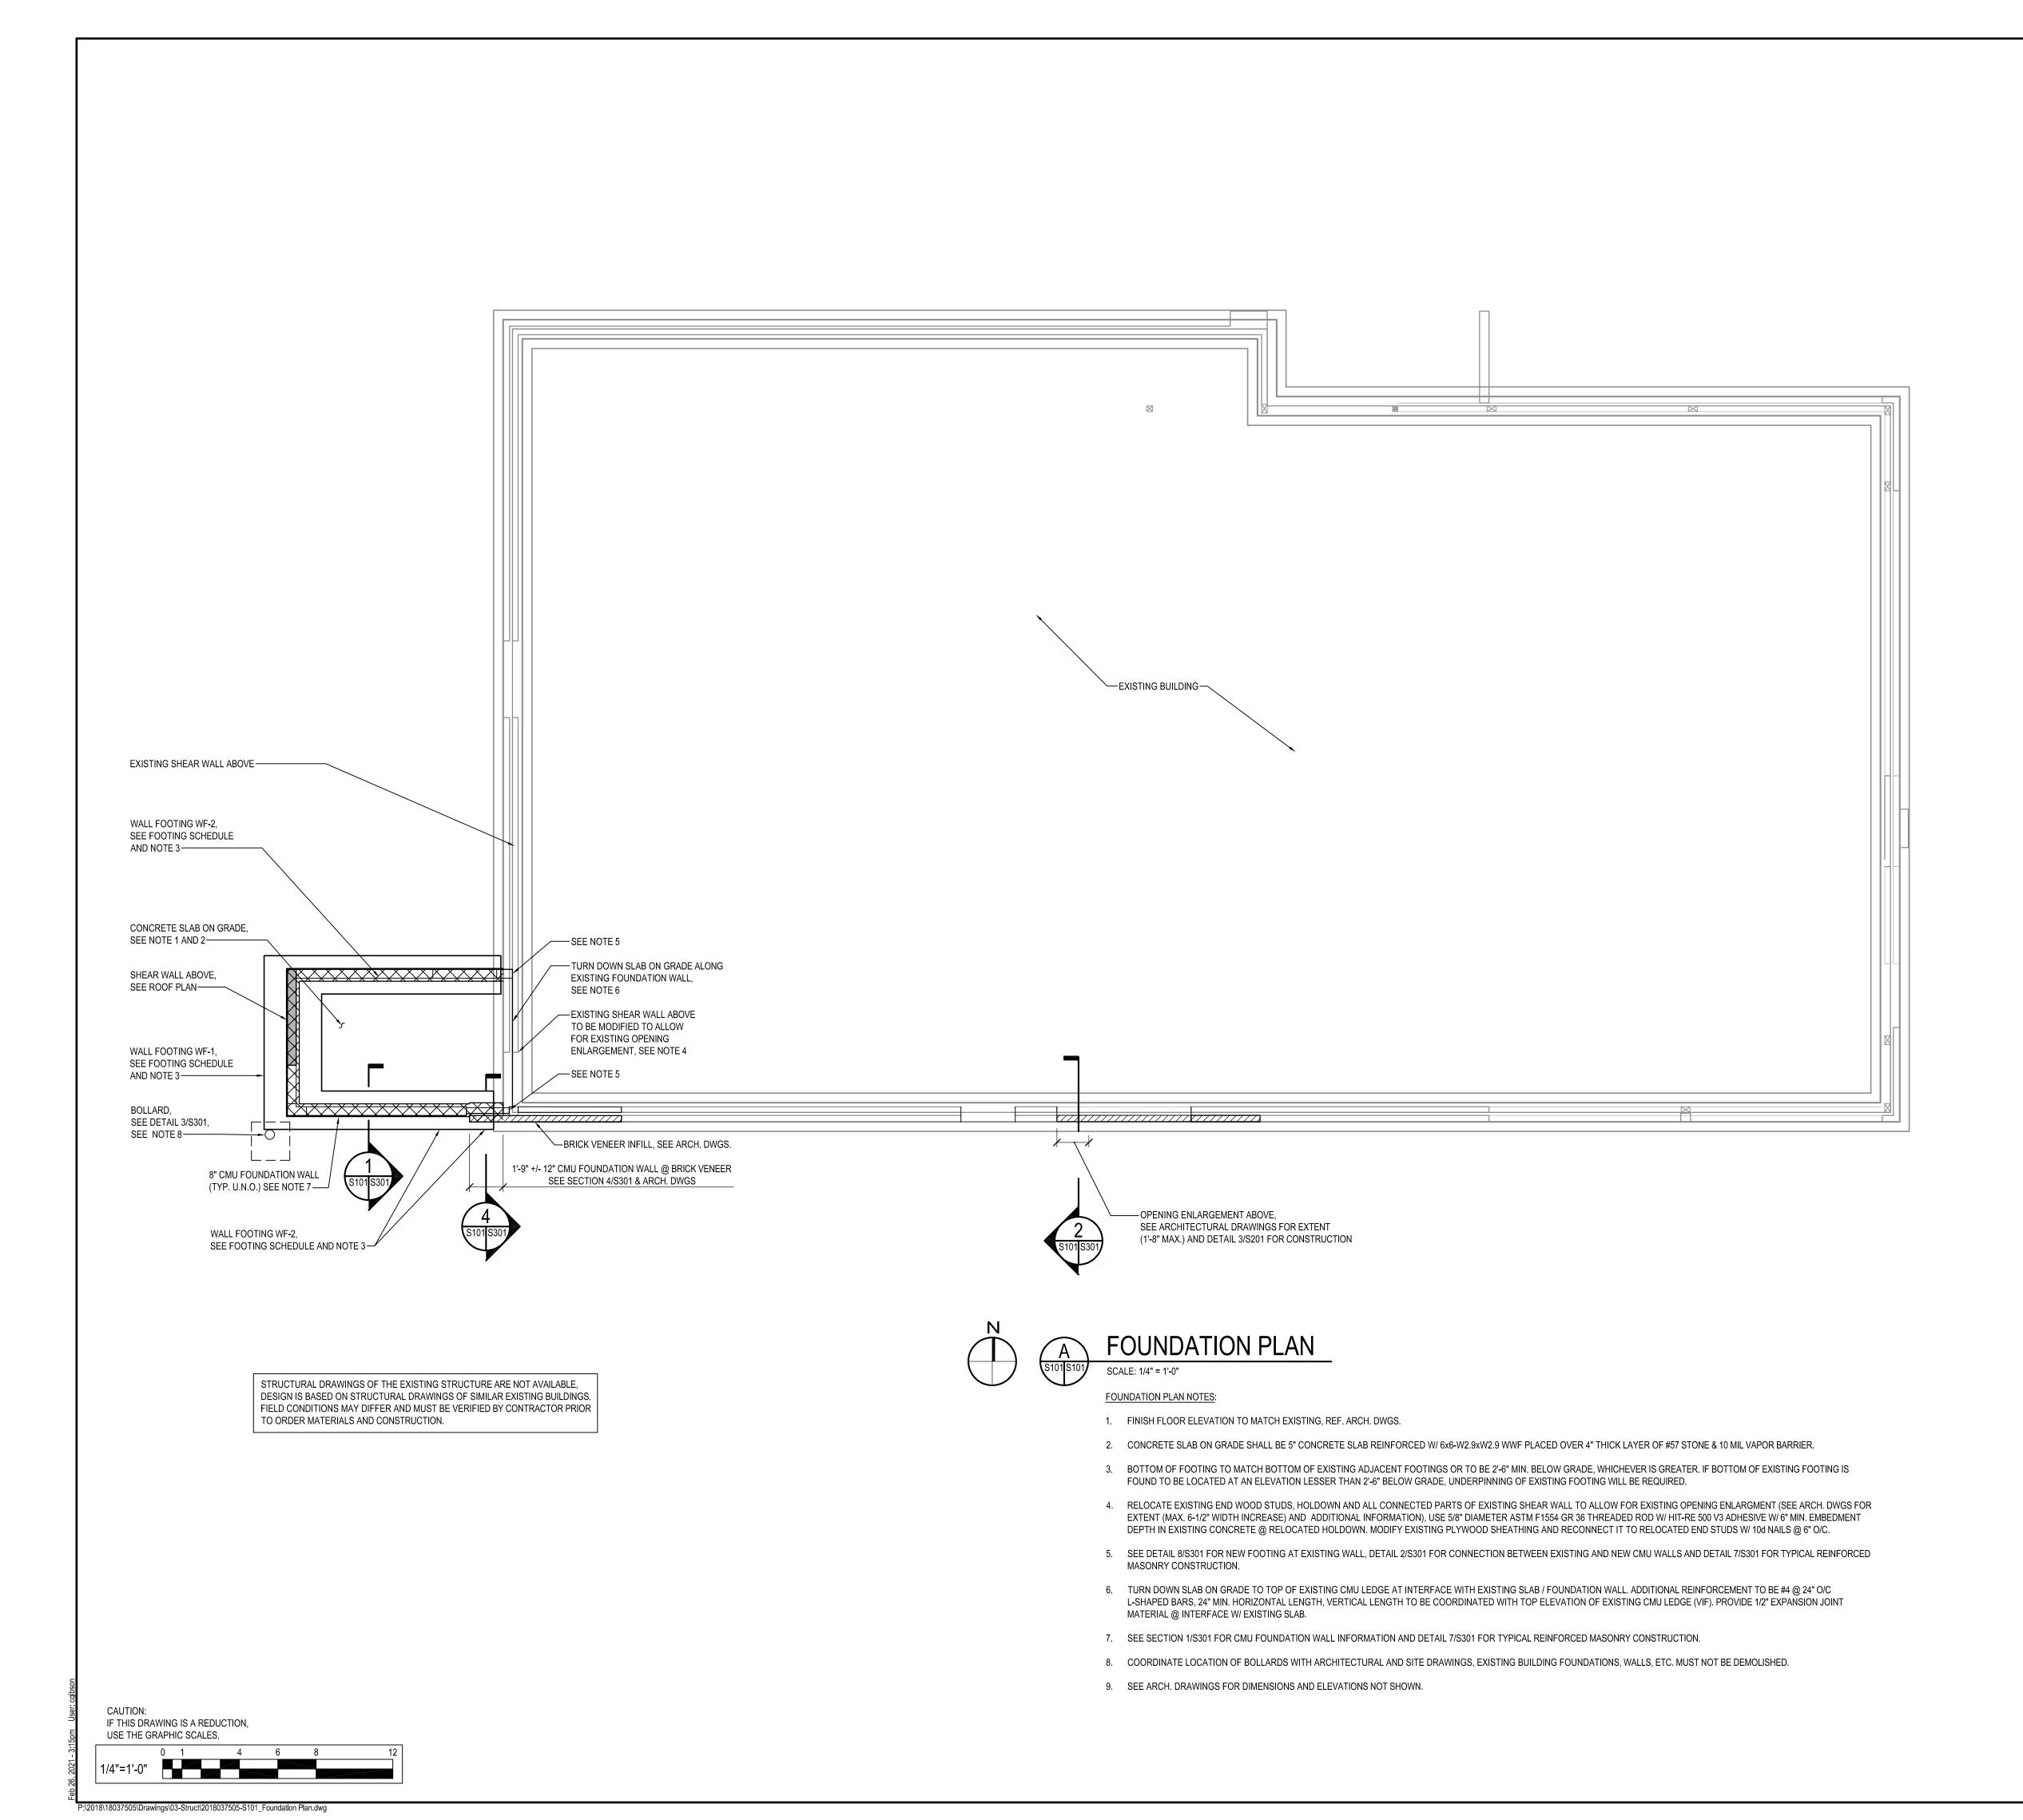DESIGNED: FC DRAWN: CG CHECKED SCALE: PROJECT: 2018.0375.05 DRAWING: 02-26-2021 PERMIT SUBMISSION

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I hereby certify that these documents were

prepared or approved by me, and that I am a

duly licensed professional engineer under the

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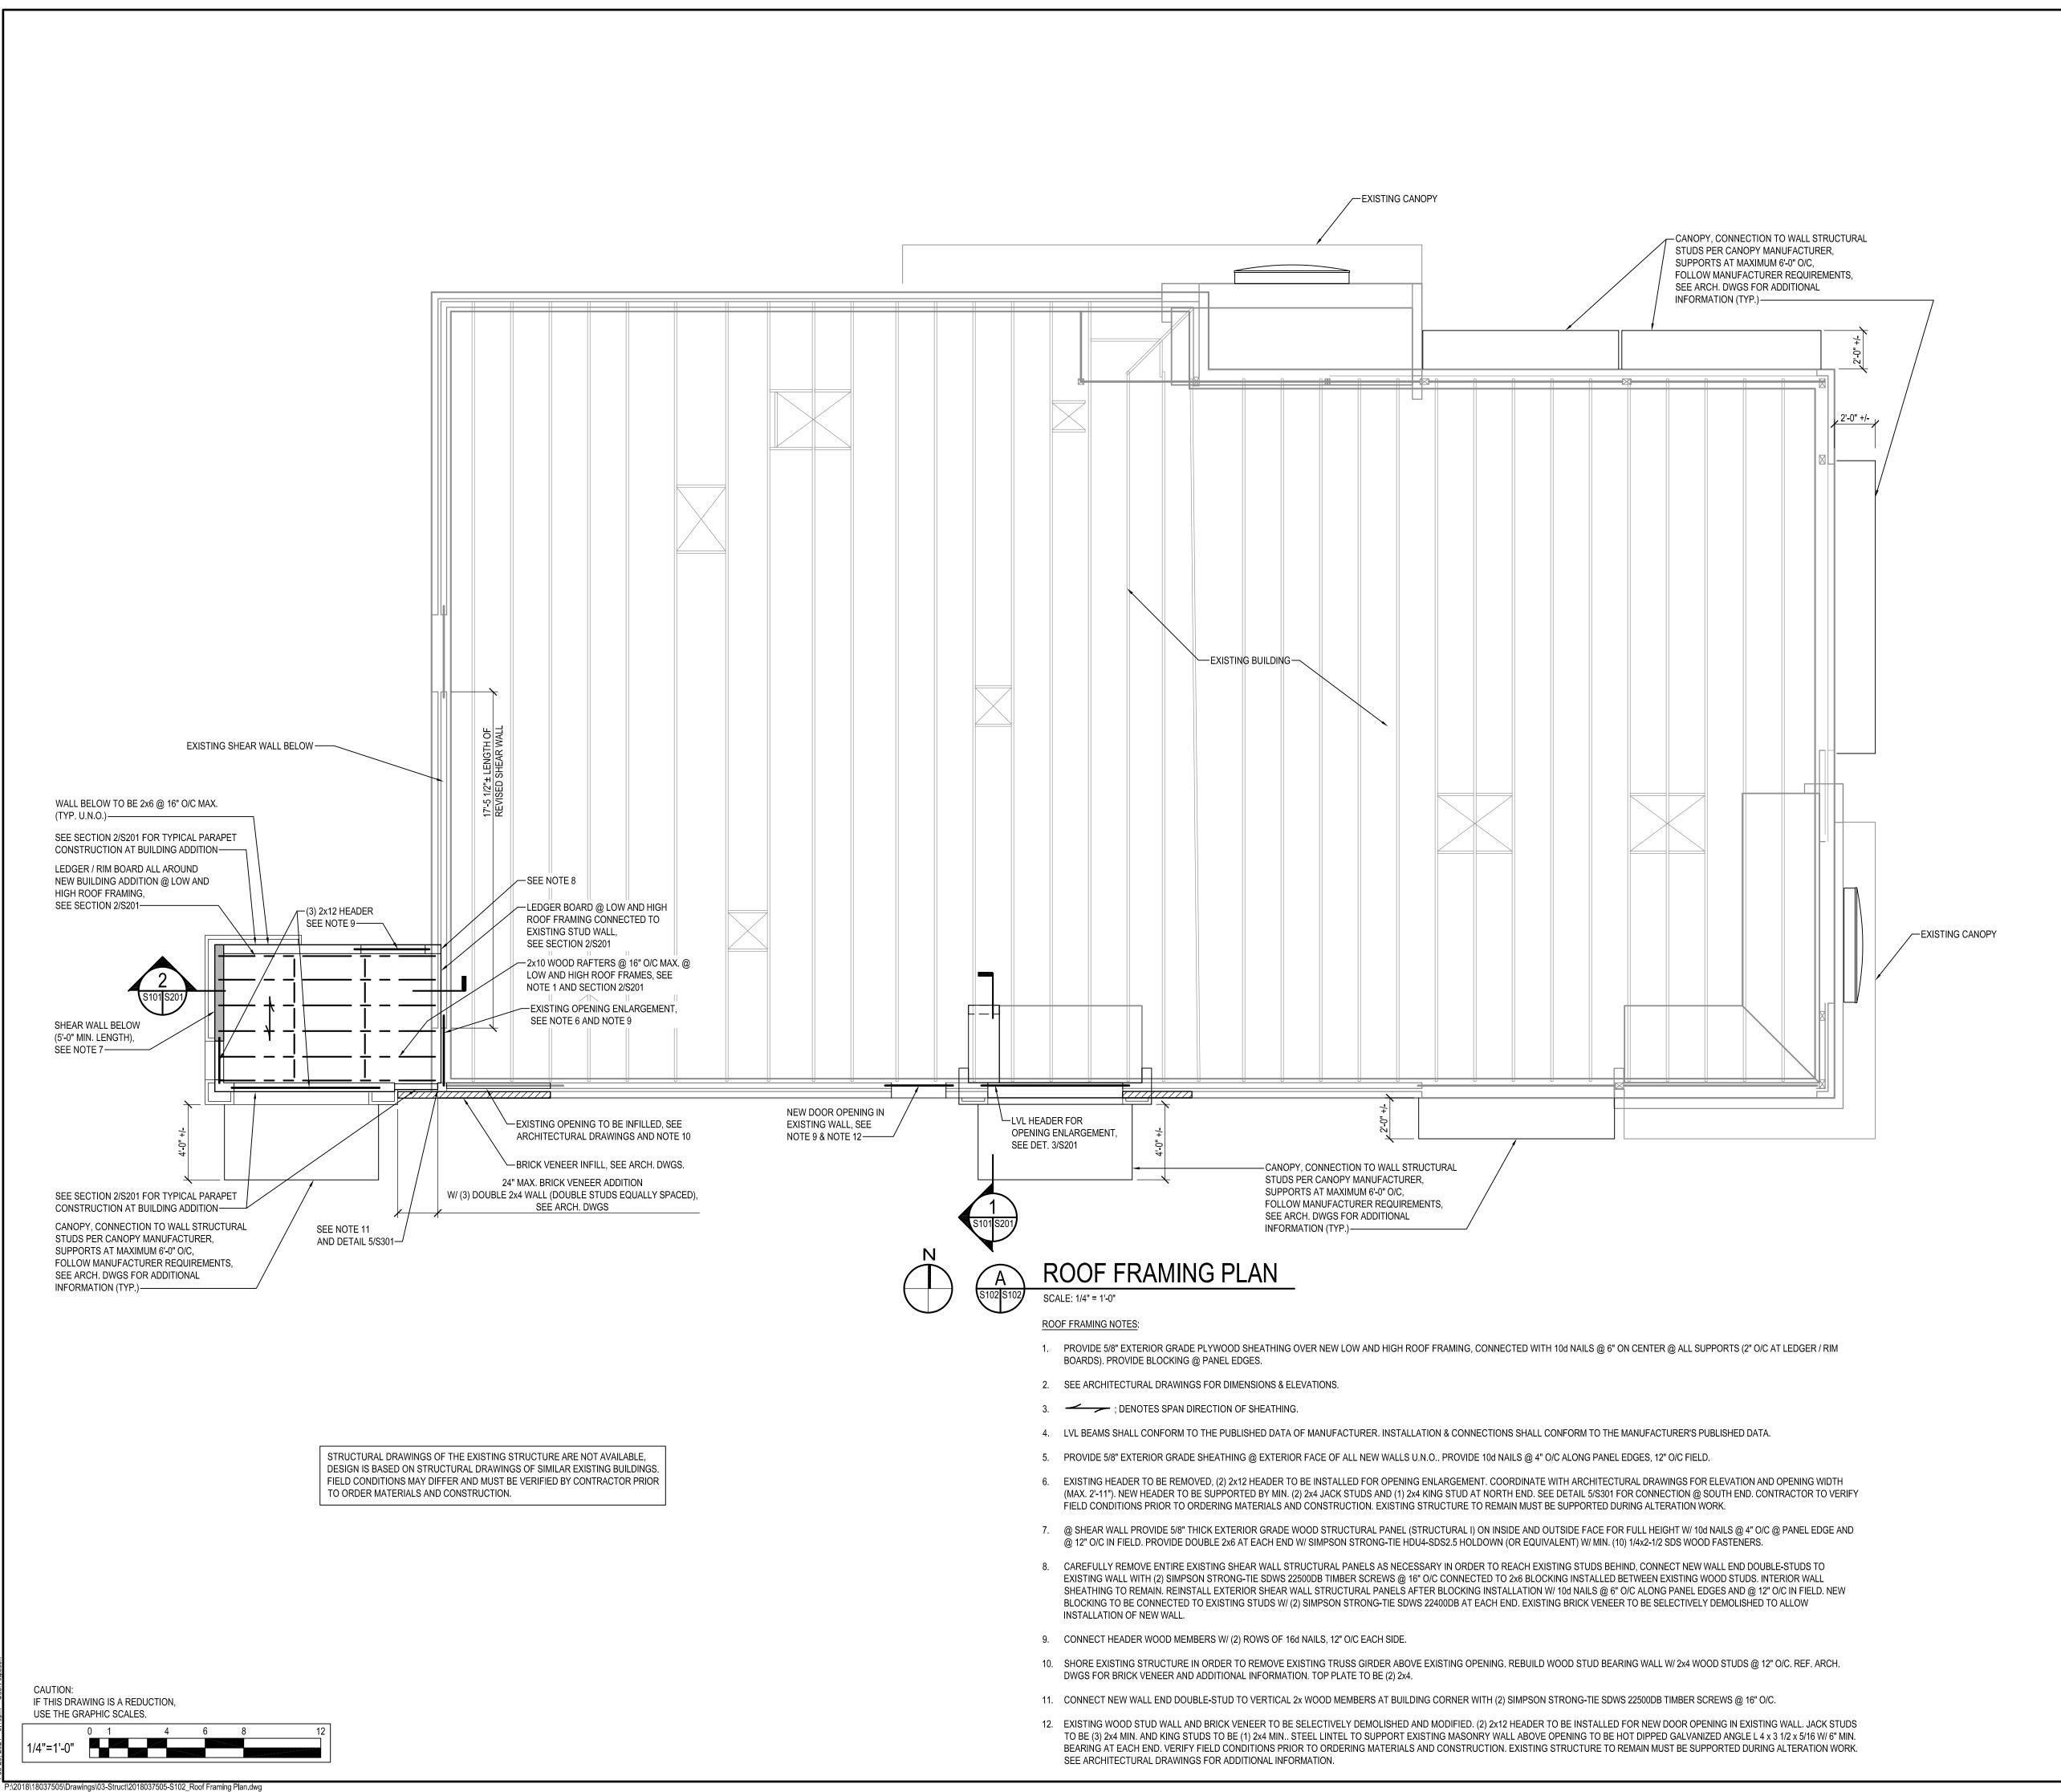
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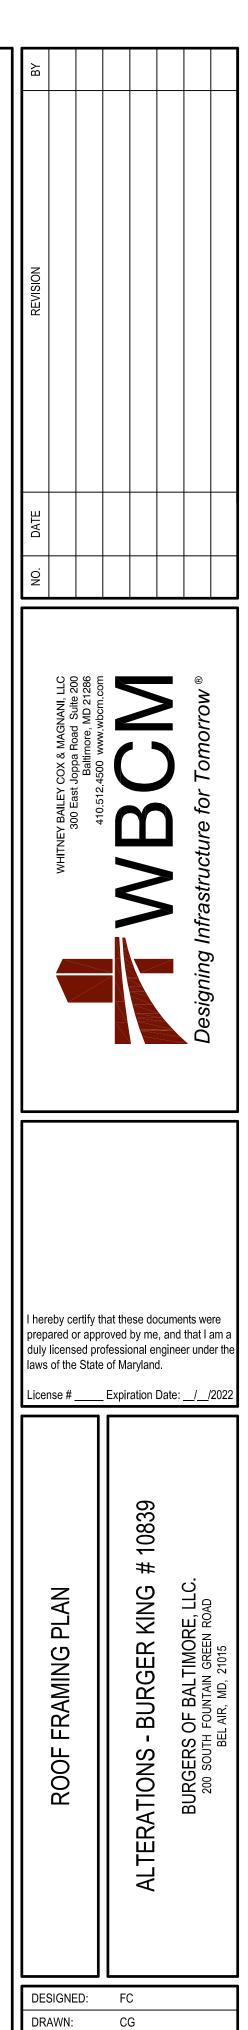
MWS

AS NOTED

01/18/2021


laws of the State of Maryland.







CHECKED: MWS SCALE: AS NOTED 01/18/2021 PROJECT: 2018.0375.05 DRAWING:

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EXISTING WOOD TRUSS

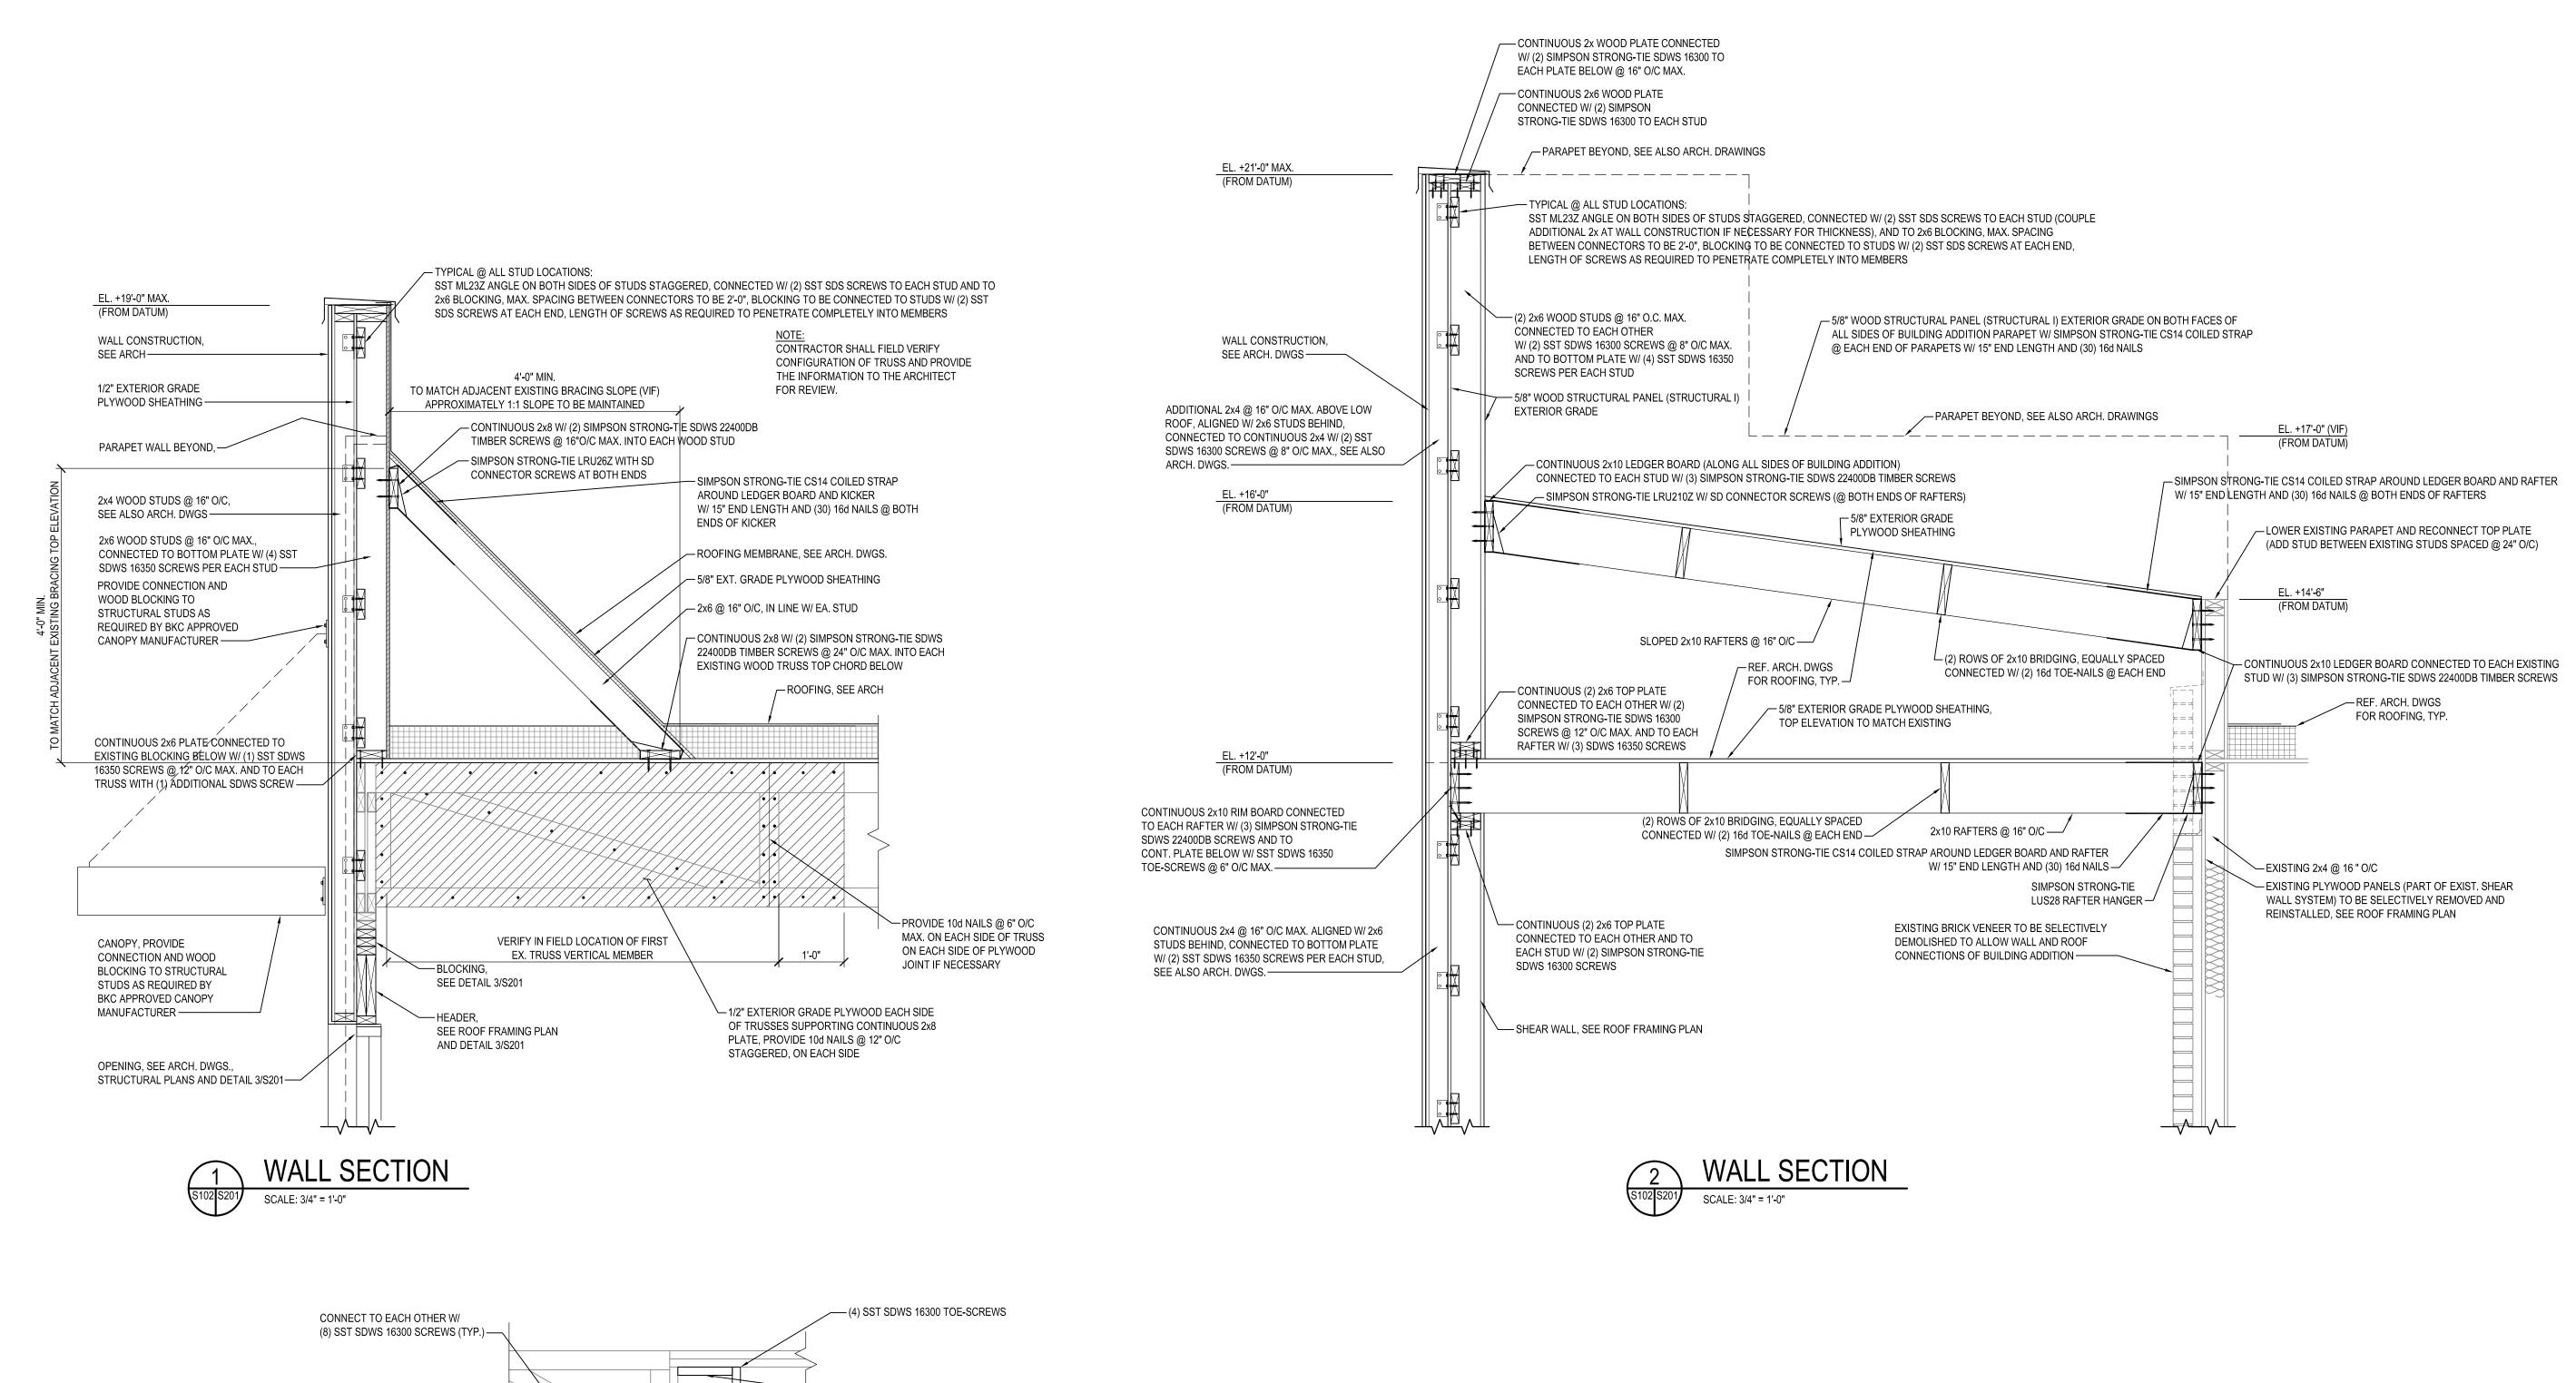- 2x4 CONNECTED TO EACH STUD W/ (4) SST SDWS 16300 TOE-SCREWS
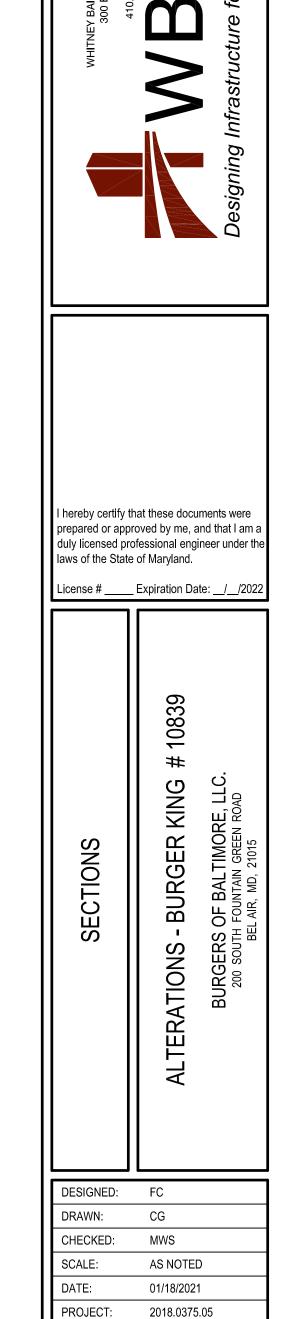
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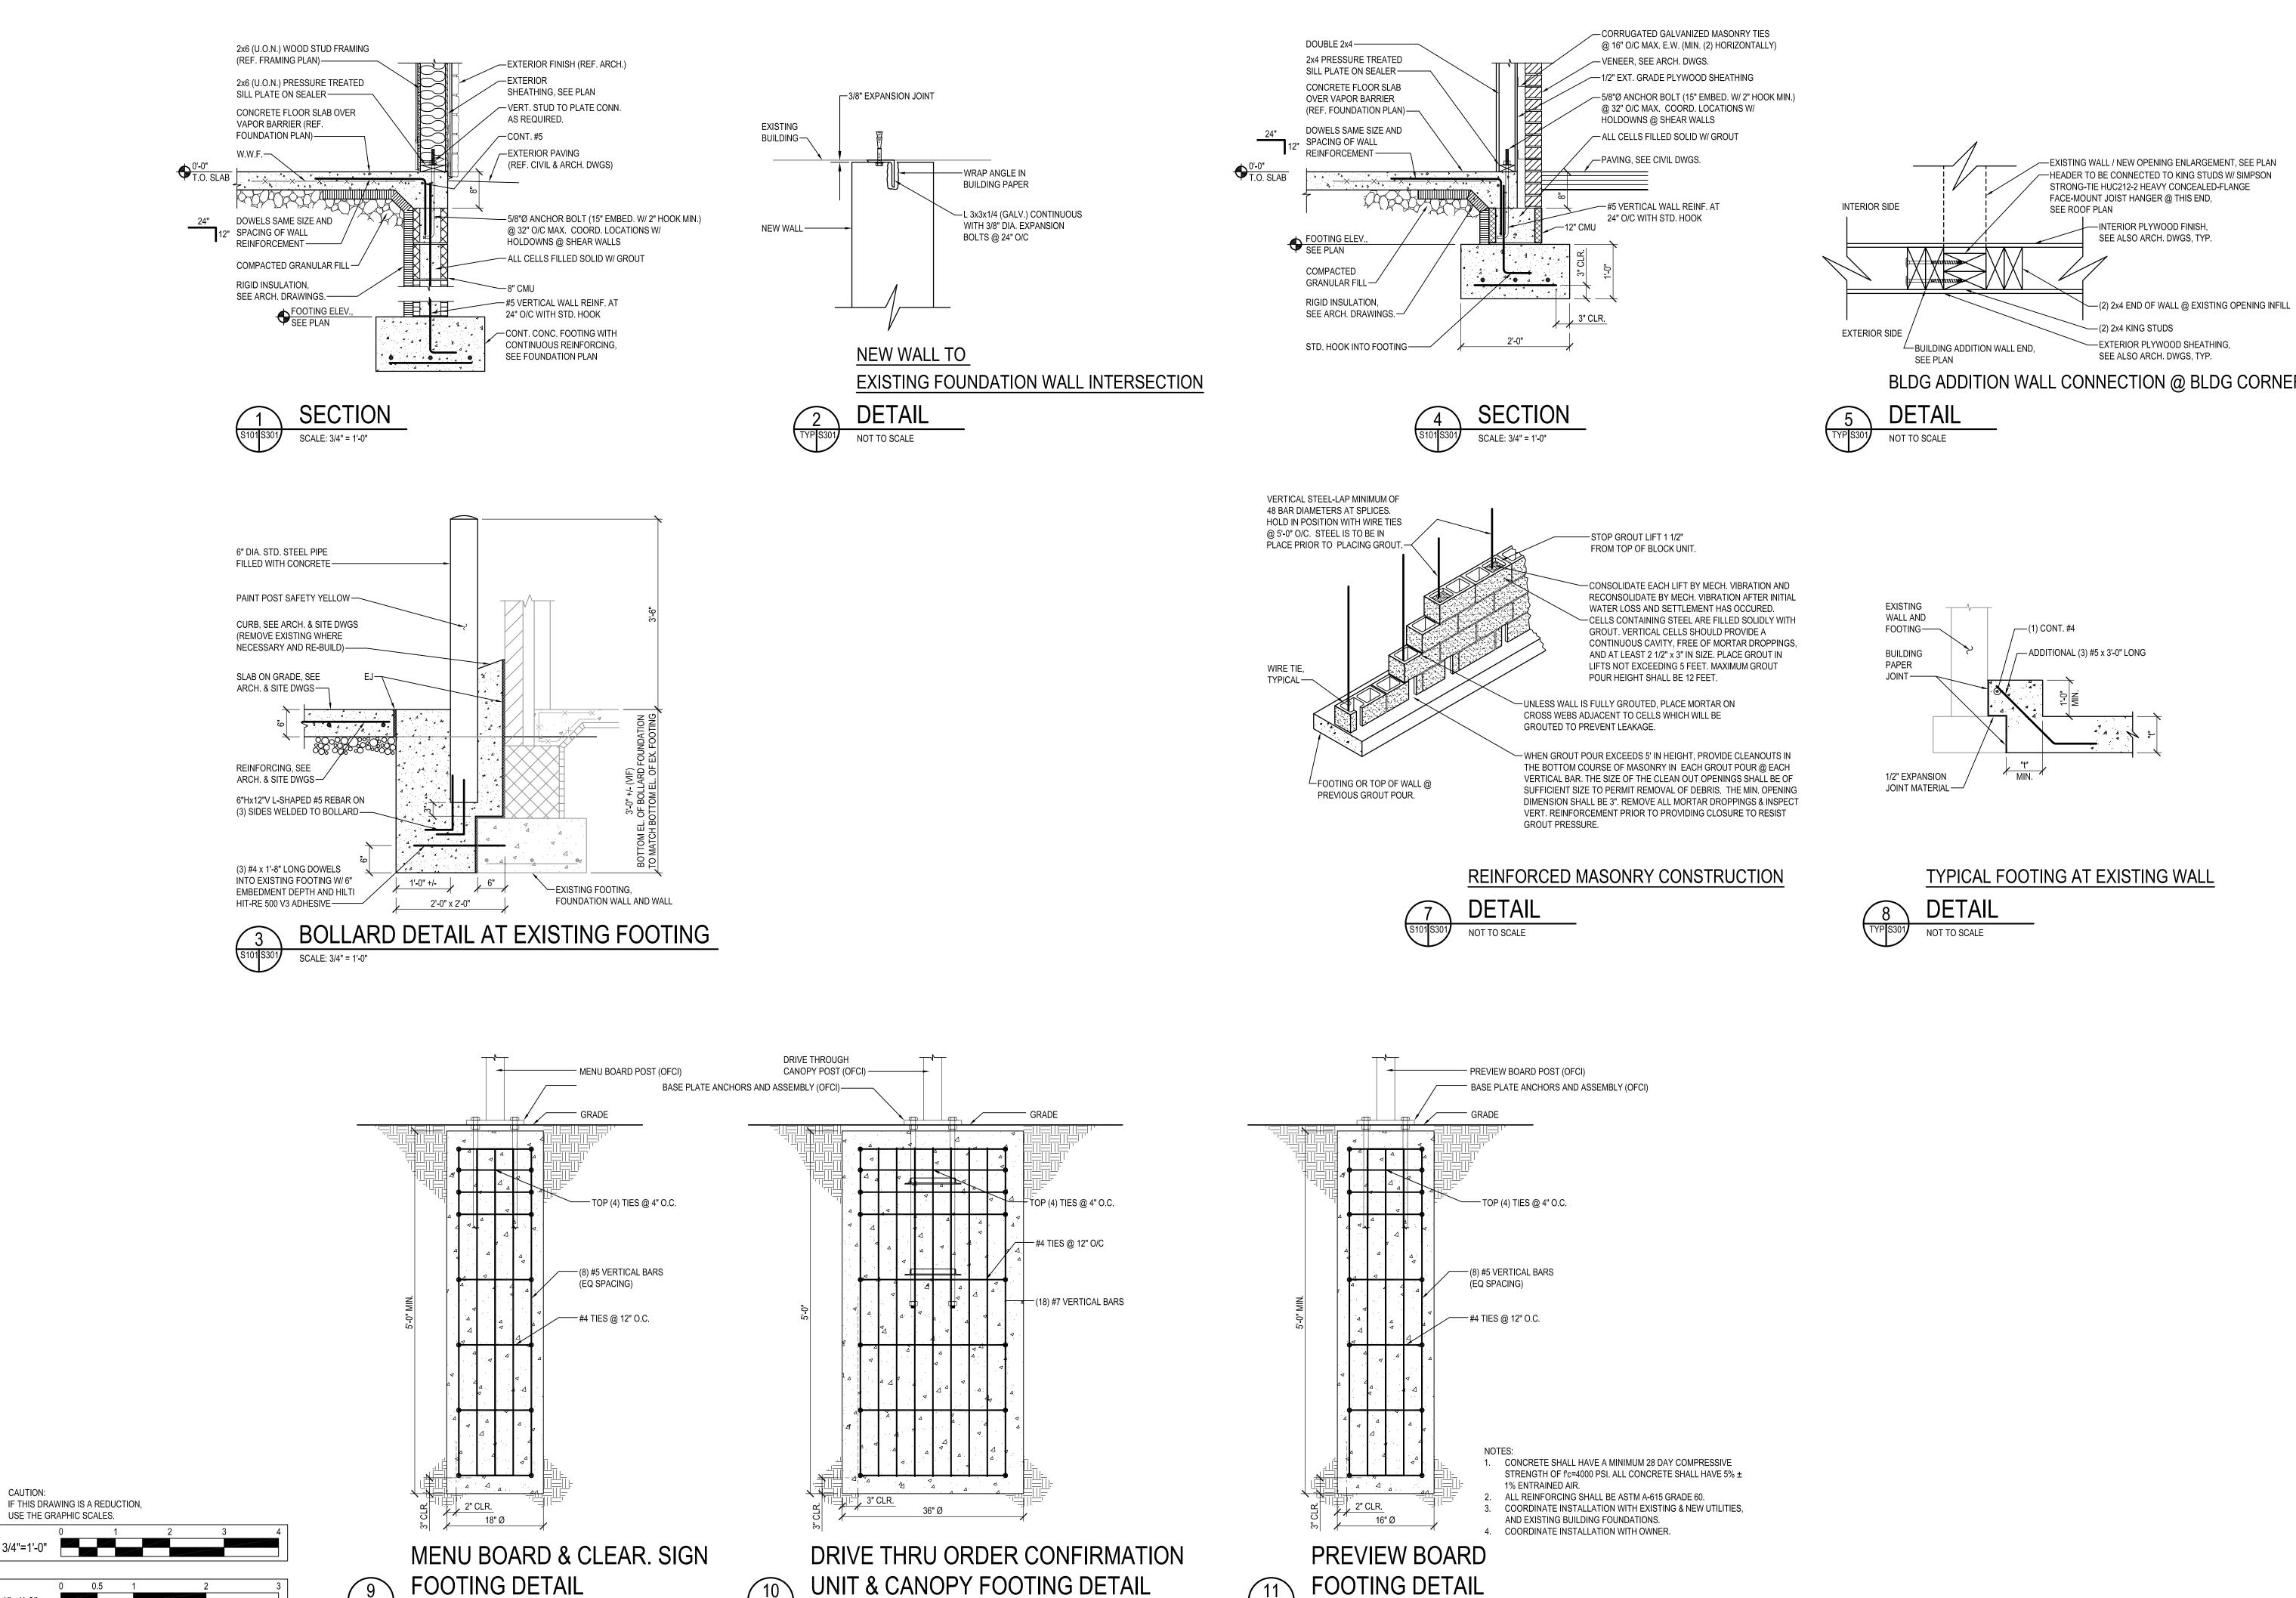
IF THIS DRAWING IS A REDUCTION, USE THE GRAPHIC SCALES.

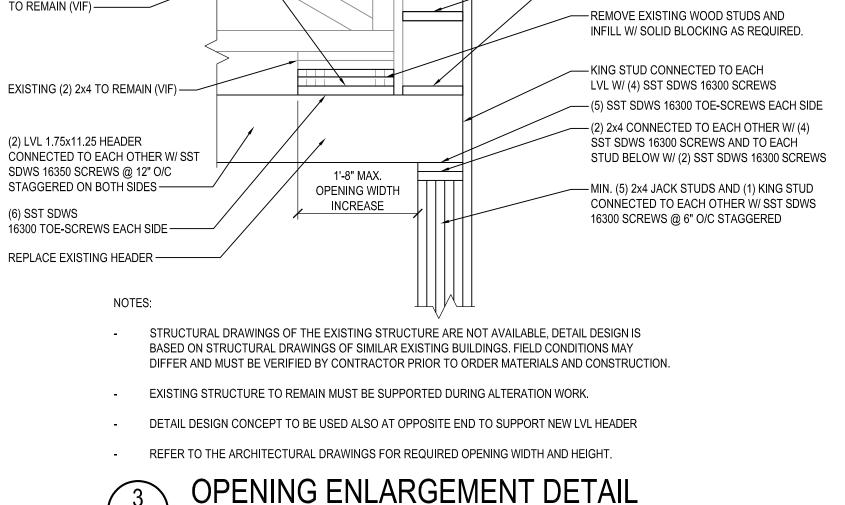CAUTION:

(A) 14/DOM 60

S201

DRAWING:



SCALE: 1" = 1'-0"

CAUTION:

BLDG ADDITION WALL CONNECTION @ BLDG CORNER

TYPICAL FOOTING AT EXISTING WALL

I hereby certify that these documents were prepared or approved by me, and that I am a duly licensed professional engineer under the laws of the State of Maryland.


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ALTERATIONS

DESIGNED:	FC
DRAWN:	CG
CHECKED:	MWS
SCALE:	AS NOTED
DATE:	01/18/2021
PROJECT:	2018.0375.05
DRAWING:	

S301

02-26-2021 PERMIT SUBMISSION



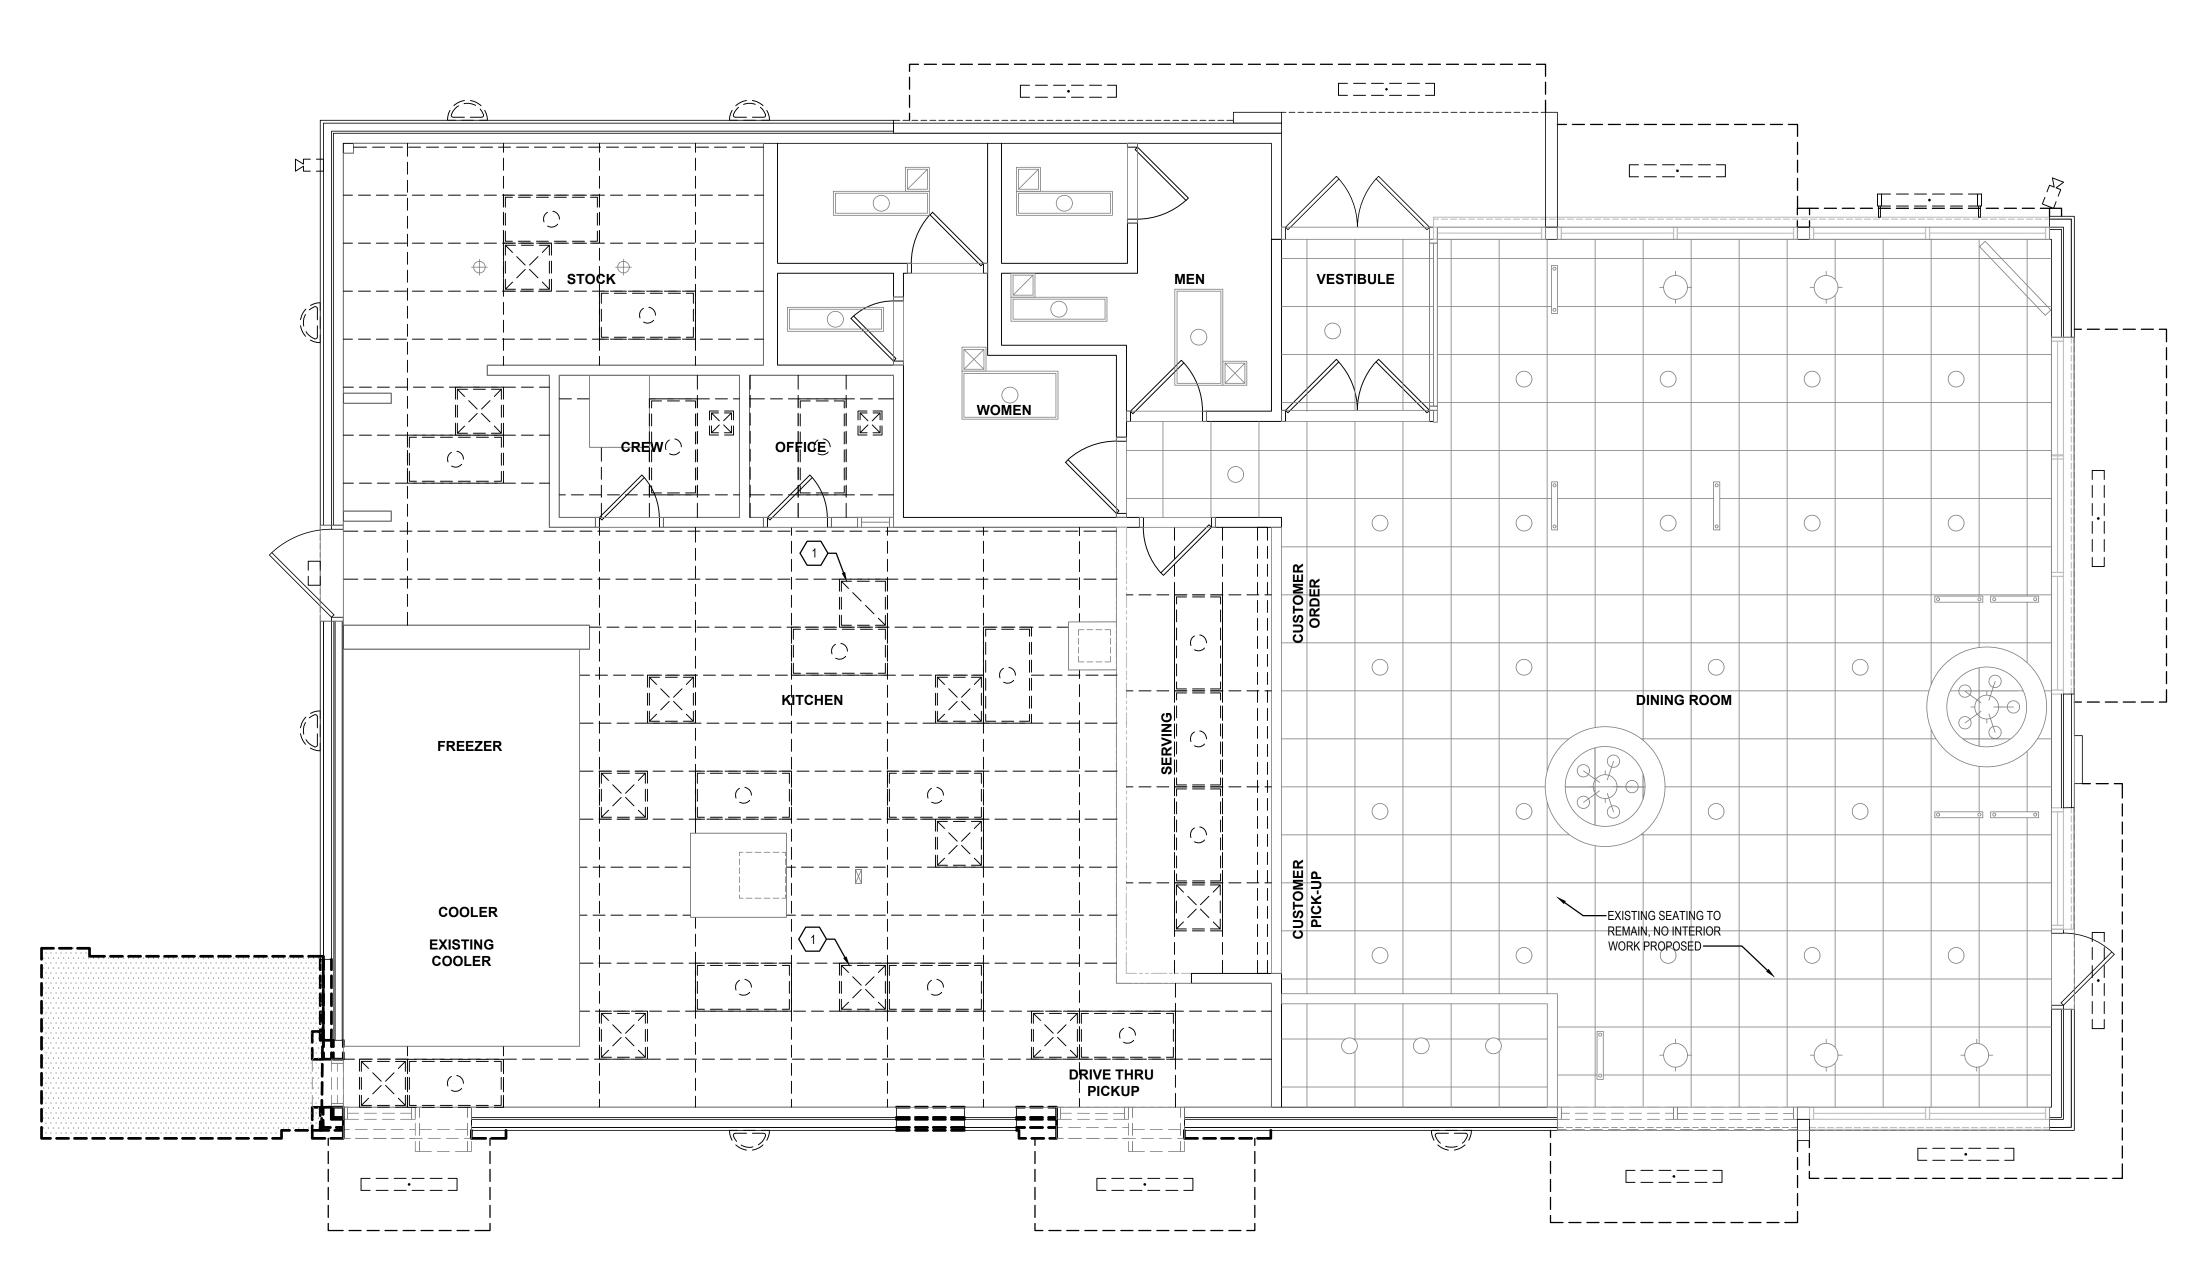


# GENERAL SHEET NOTES

WITH THE OWNER.

. CONTRACTOR TO COORDINATE CONSTRUCTION AND CONTINUED OPERATIONS SCHEDULING

- 2. ALL EQUIPMENT AND WORK TO REMAIN SHALL BE SUITABLY PROTECTED AGAINST DAMAGE.
- CONTRACTOR TO NOTIFY ARCHITECT OF ANY VARIATION OF EXISTING CONDITIONS TO INFORMATION PROVIDED ON THE DRAWINGS. NOTIFY ARCHITECT OF ANY STRUCTURAL DEFICIENCIES FOUND IN THE FIELD.
- 4. USE CARE DURING DEMOLITION WORK TO PREVENT DAMAGE TO EXISTING BUILDING COMPONENTS TO REMAIN.

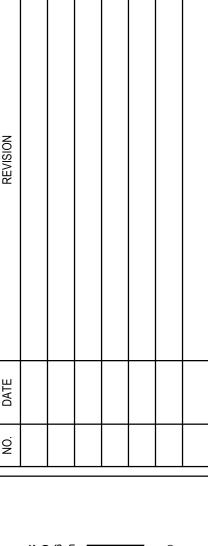

# ○ SHEET KEYNOTES

1. REMOVE EXISTING DIFFUSER, RETAIN ALL DUCTWORK FOR RE-CONNECTION, TYPICAL.

CONSTRUCTION LEGEND

DEMOLISHED.

EXISTING PARTITION TO REMAIN.

EXISTING WINDOW AND FRAME TO REMAIN.

EXISTING DOOR AND FRAME TO REMAIN.

EXISTING PARTITION TO BE DEMOLISHED.


EXISTING WINDOW AND FRAME TO BE

EXISTING DOOR AND FRAME TO BE DEMOLISHED.

2. REMOVE EXISTING RETURN GRILLE, TYPICAL.

**|** | =====



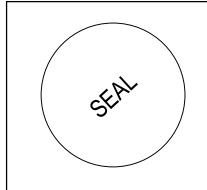

I hereby certify that these documents were prepared or approved by me, and that I am a duly licensed professional architect under the laws of the State of Maryland.

License #6140 Expiration Date: 08/21/2020

AL DEMOLITION
URGER KING # 10839

ALTERATIONS - BURGER KING # 108
BURGERS OF BALTIMORE, LLC.

DESIGNED:	BWE
DRAWN:	EMÆ
CHECKED:	JWA
SCALE:	AS SHOWN
DATE:	04/12/2021
PROJECT:	2018.0375.0


MD101

CAUTION:
IF THIS DRAWING IS A REDUCTION,
USE THE GRAPHIC SCALES.


0 1 4 6 8 1:
1/4"=1'-0"

04-21-2021 BID SET SUBMISSION

P:\2021\21007 - Burger King Fountain Green Road\09-Drawings\CAD Drawings\Mech\21007 - MD101 - Mechanical Demolition.dwg

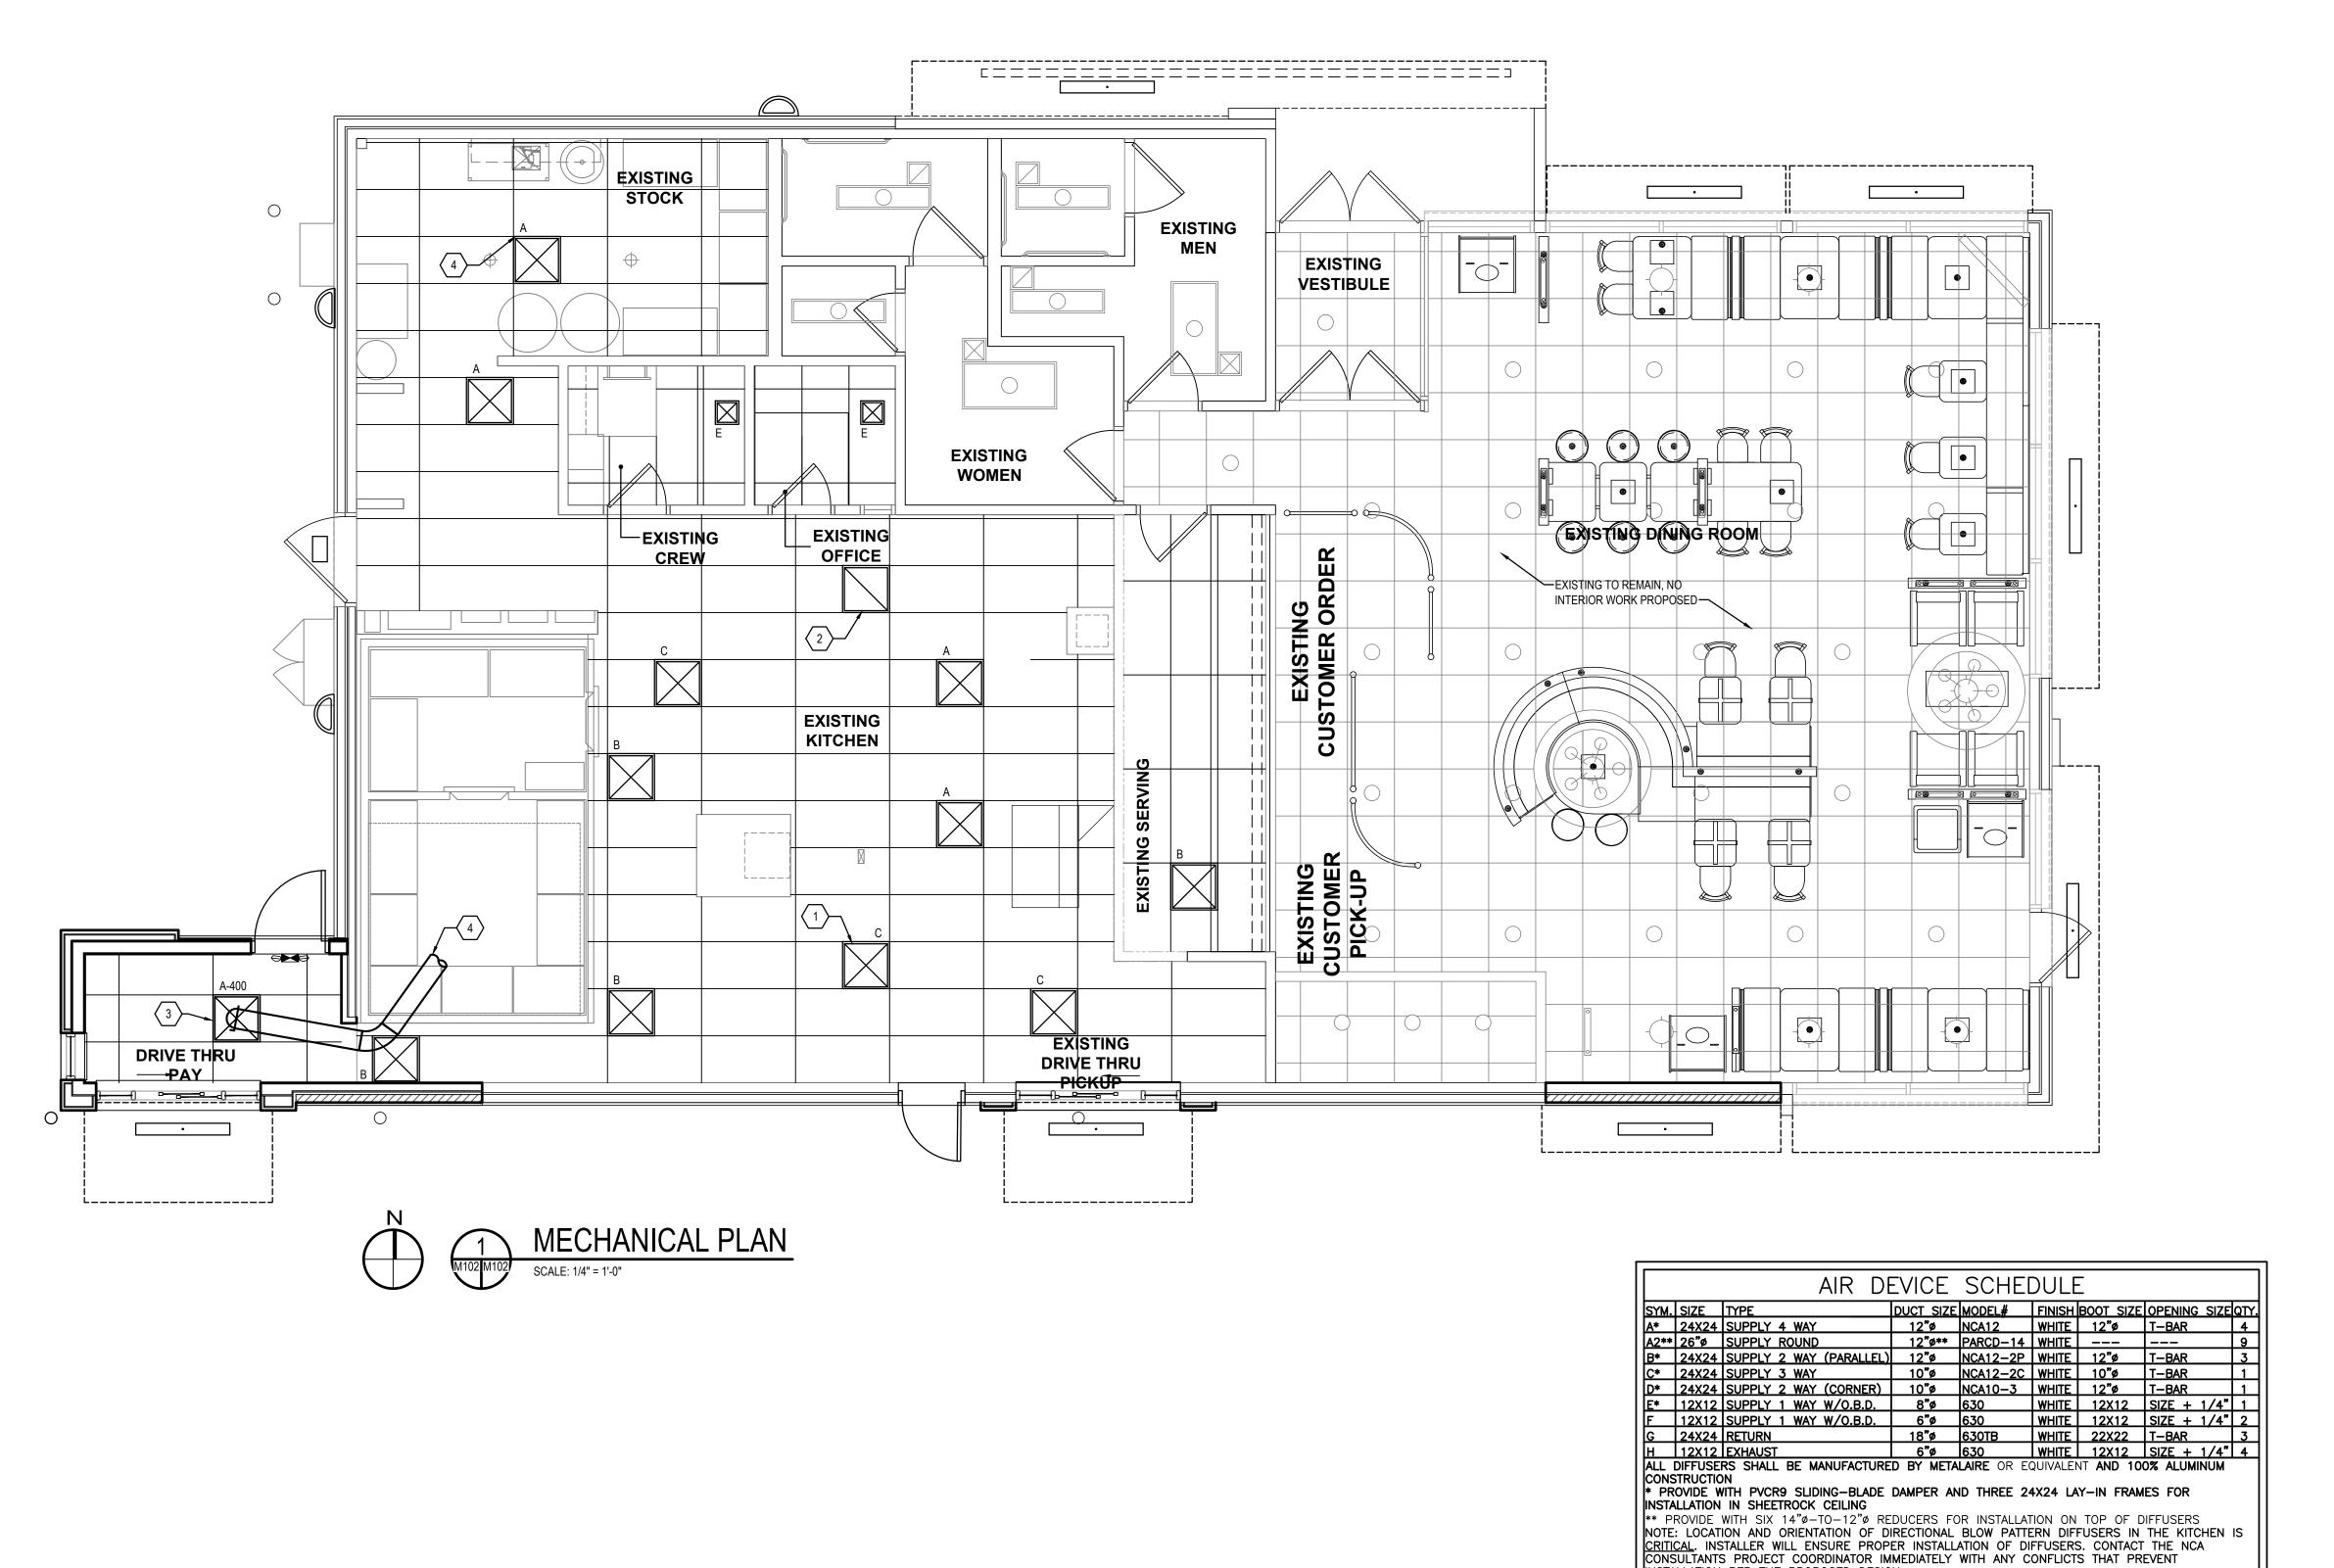

INSTALLATION PER THE PROPOSED DESIGN.

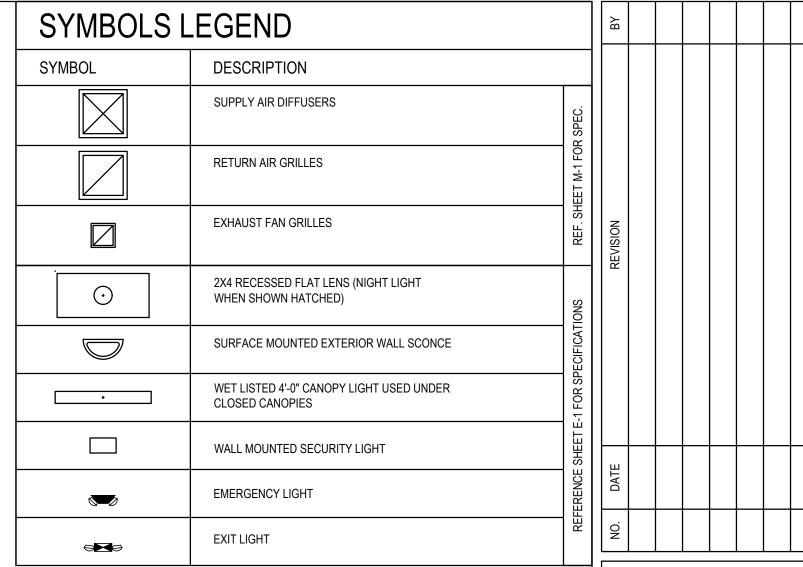

# **GENERAL SHEET NOTES**

 CONTRACTOR SHALL TAKE NOTE OF EXISTING THROW PATTERN OF DIFFUSERS PRIOR TO DEMOLITION AND REPLACEMENT DIFFUSER SHALL MATCH EXISTING PATTERN AND ORIENTATION.



# ○ SHEET KEYNOTES

- 1. PROVIDE NEW DIFFUSER, TYPICAL. MATCH EXISTING AIR DISTRIBUTION PATTERN.
- 2. PROVIDE NEW RETURN GRILLE, TYPICAL.
- 3. PROVIDE NEW DIFFUSER AT LISTED CFM.
- 4. PROVIDE 10"Ø FLEX DUCT TO EXISTING SUPPLY PLENUM BOX IN APPROXIMATELY LOCATION.

I hereby certify that these documents were prepared or approved by me, and that I am a duly licensed professional architect under the laws of the State of Maryland.

License #6140 Expiration Date: 08/21/2020

# 10839

ALTERATIONS - BURGER KING # 108
BURGERS OF BALTIMORE, LLC.
200 SOUTH FOUNTAIN GREEN ROAD

CAUTION:
IF THIS DRAWING IS A REDUCTION,
USE THE GRAPHIC SCALES.

0 1 4 6 8 12
1/4"=1'-0"

04-21-2021 BID SET SUBMISSION

DESIGNED: SWC

DRAWN: LHD

CHECKED: JWA


SCALE: AS SHOWN


DATE: 04/12/2021

PROJECT: 2018.0375.05

DRAWING:


M102

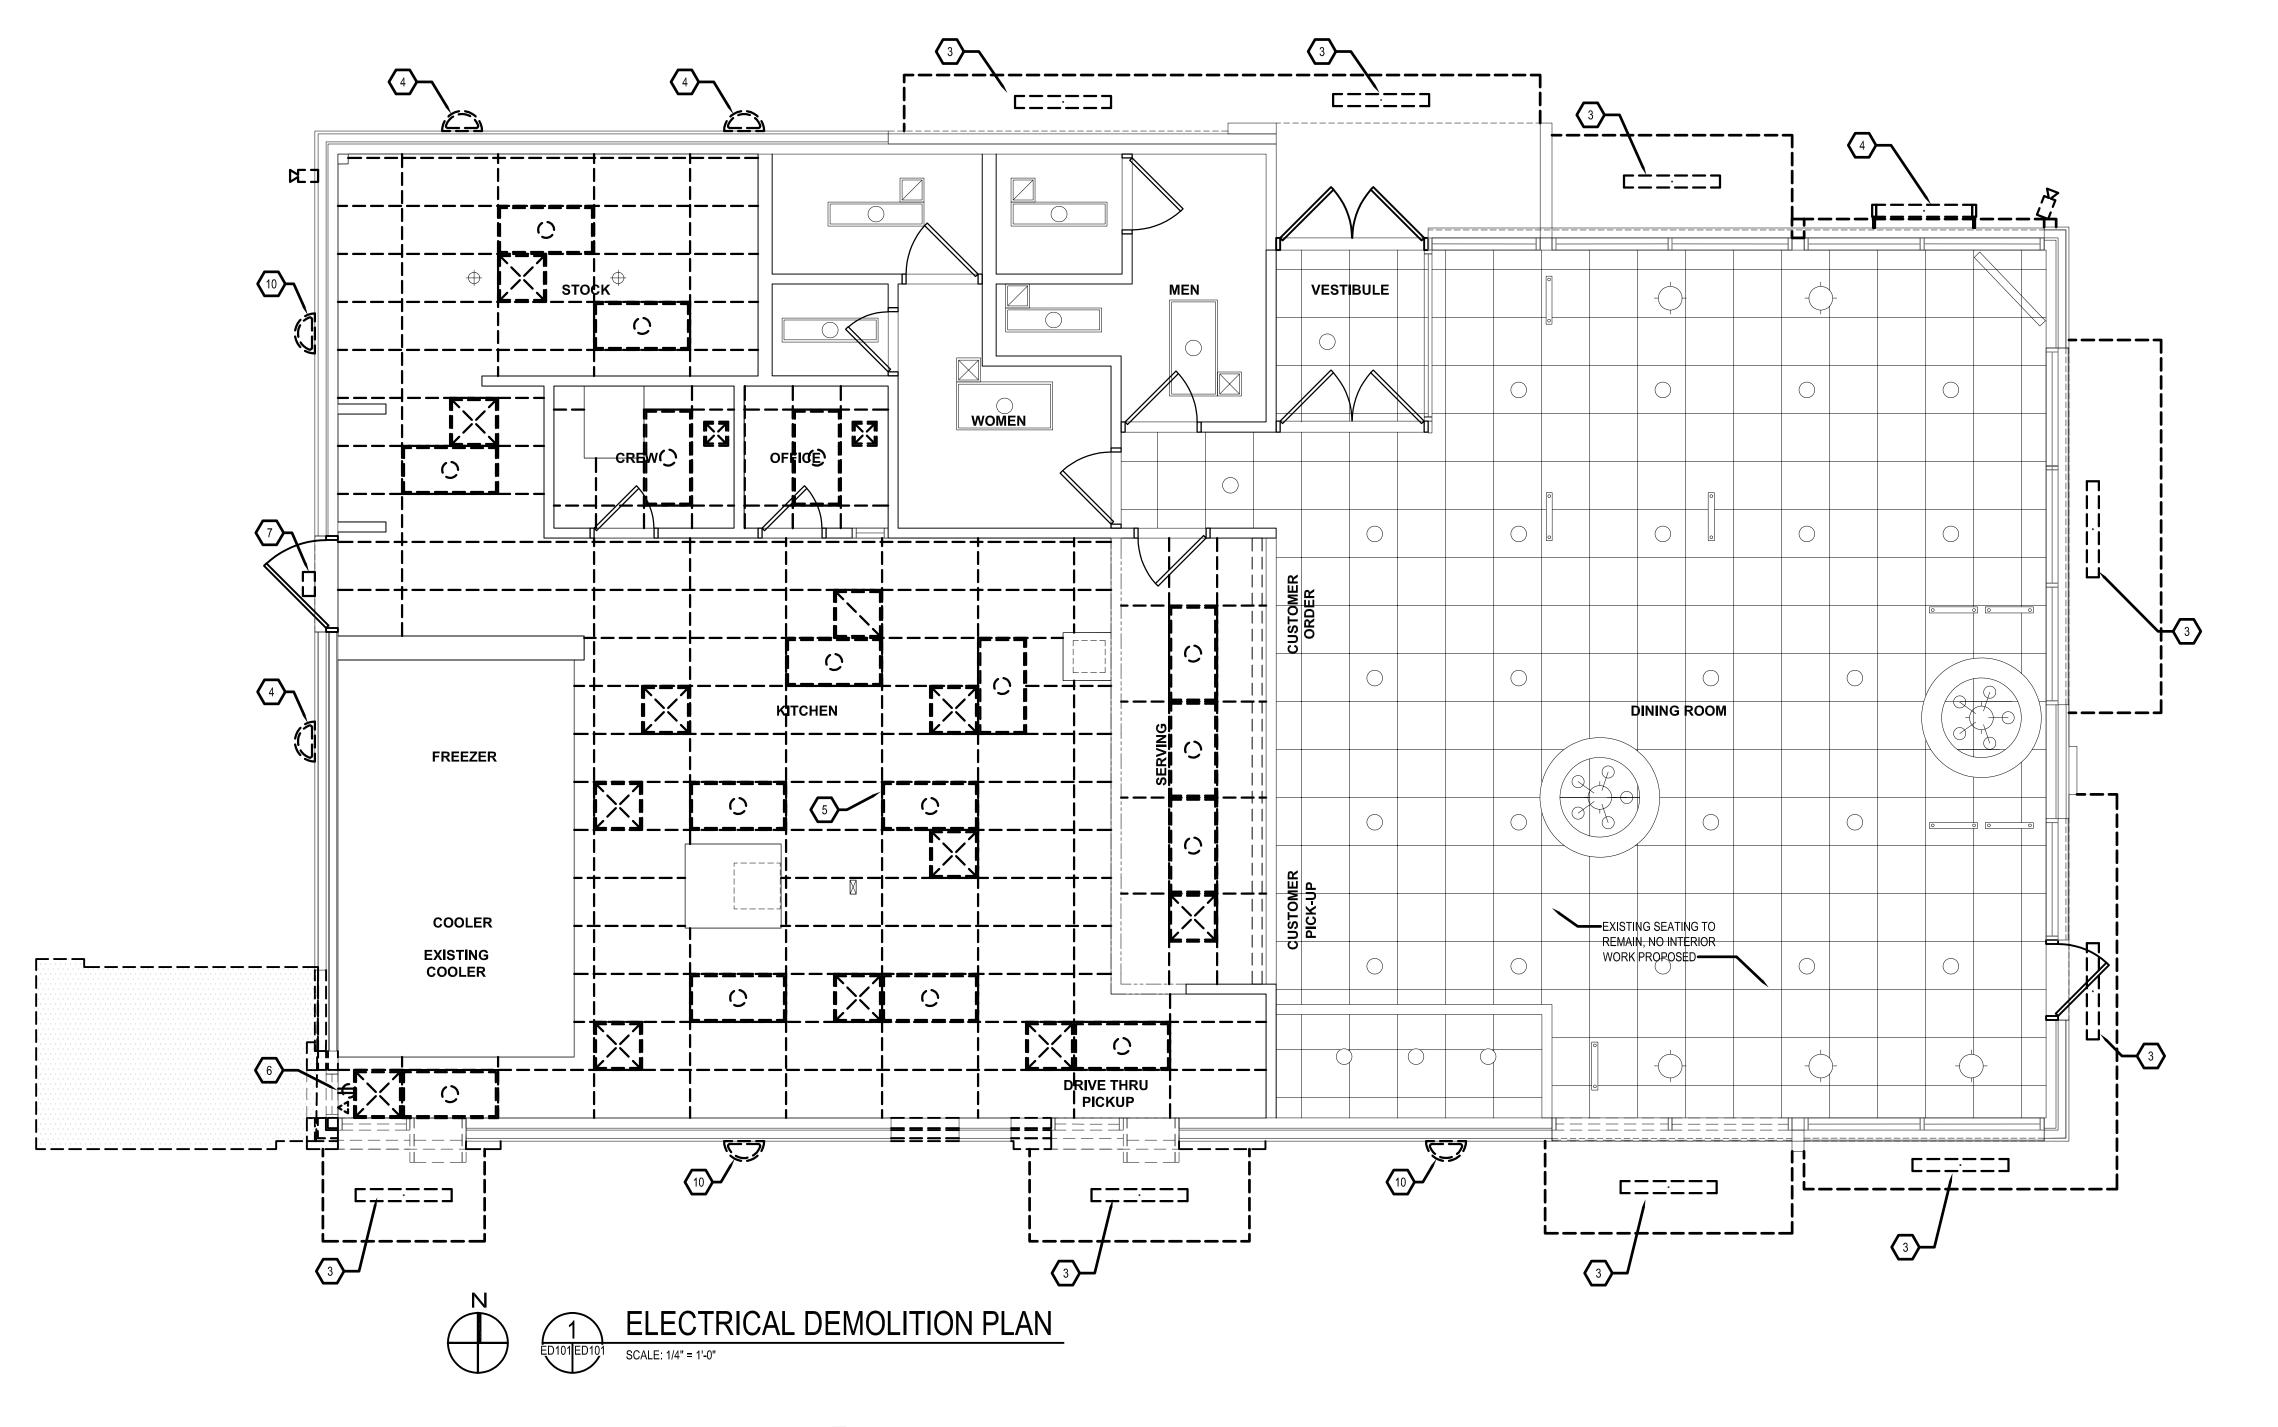


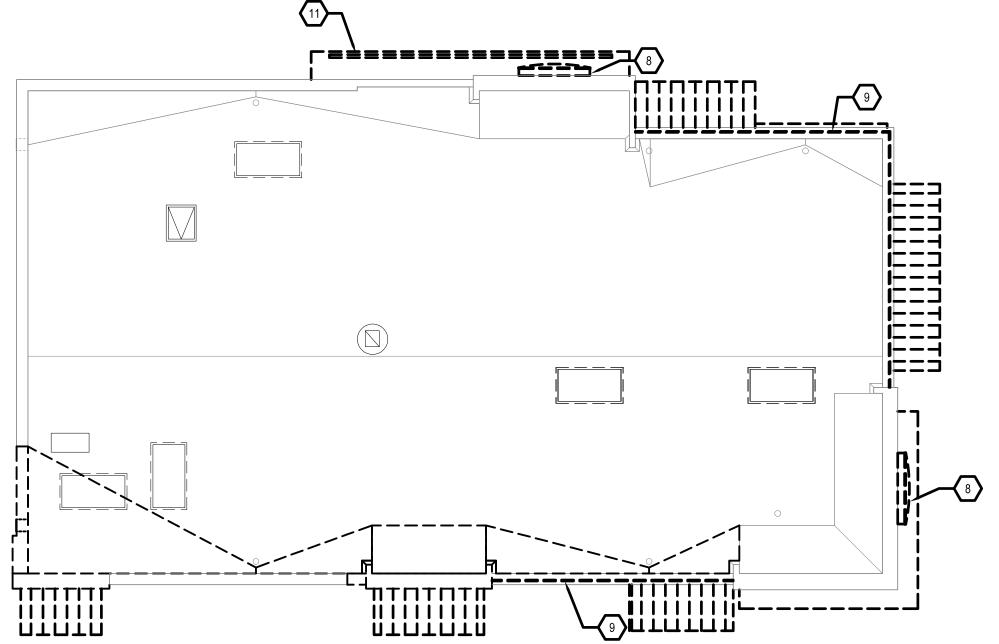

# GENERAL SHEET NOTES

- CONTRACTOR TO COORDINATE CONSTRUCTION AND CONTINUED OPERATIONS SCHEDULING WITH THE OWNER.
- 2. WHERE WORK PASSES THROUGH THE RENOVATED AREA TO SERVE OTHER PORTIONS OF THE BUILDING OR WORK IN THE RENOVATION AREA TO REMAIN, IT SHALL BE SUITABLY RELOCATED AND THE SYSTEM RESTORED TO NORMAL.
- 3. ALL EQUIPMENT AND WORK TO REMAIN SHALL BE SUITABLY PROTECTED AGAINST DAMAGE.
- 4. CONTRACTOR TO NOTIFY ARCHITECT OF ANY VARIATION OF EXISTING CONDITIONS TO INFORMATION PROVIDED ON THE DRAWINGS. NOTIFY ARCHITECT OF ANY STRUCTURAL DEFICIENCIES FOUND IN THE FIELD.
- 5. USE CARE DURING DEMOLITION WORK TO PREVENT DAMAGE TO EXISTING BUILDING COMPONENTS TO REMAIN.
- 6. ALL REMOVED WALL DEVICE PENETRATIONS SHALL BE PATCHED AND PAINTED TO MATCH EXISTING WALL COLOR OR FINISH PER ARCHITECTURAL DIRECTION.

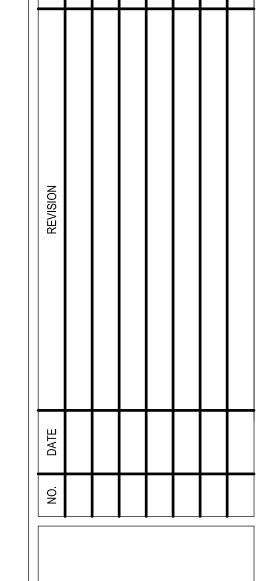

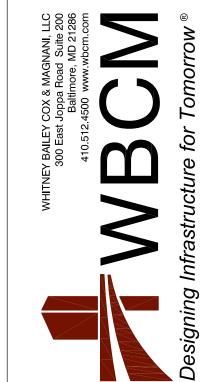

I hereby certify that these documents were prepared or approved by me, and that I am a duly licensed professional architect under the

License #6140 Expiration Date: 08/21/2020

- BURGER KING

**TERATIONS** 

laws of the State of Maryland.

# ○ SHEET KEYNOTES

- 1. REMOVE EXISTING MENU BOARD.
- 2. REMOVE EXISTING ORDER BOARD.
- REMOVE EXISTING CANOPY MOUNTED LIGHT FIXTURE. RETAIN EXISTING WIRING AND CONDUIT FOR RE-CONNECTION TO NEW LIGHT FIXTURES.
- 4. EXISTING WALL MOUNTED LIGHT FIXTURE TO REMAIN. CLEAN AND RE-LAMP FIXTURE WITH LED EQUIVALENT LAMP
- 5. REMOVE EXISTING RECESSED LIGHT FIXTURE, TYPICAL. RETAIN EXISTING WIRING AND CONDUIT FOR RE-CONNECTION TO NEW LIGHT FIXTURES.
- 6. REMOVE EXISTING RECEPTACLE AND DATA OUTLETS.
- 7. EXISTING EMERGENCY LIGHT TO REMAIN.
- 8. REMOVE EXISTING ILLUMINATED SIGNAGE, TYPICAL. RETROFIT WITH LED SOURCE AND RE-INSTALL.
- 9. REMOVE EXISTING LIGHT BAND, TYPICAL. RETAIN EXISTING WIRING AND CONDUIT FOR RE-CONNECTION.
- 10. REMOVE WALL MOUNTED LIGHT FIXTURE AND REPLACE WIT NEW.
- 11. REMOVE EXISTING SIGN LETTERS, RETAIN POWER CONNECTIONS FOR RECONNECTION.

# CONSTRUCTION LEGEND

EXISTING PARTITION TO REMAIN.

EXISTING WINDOW AND FRAME TO REMAIN.

EXISTING DOOR AND FRAME TO REMAIN.

EXISTING PARTITION TO BE DEMOLISHED.

EXISTING WINDOW AND FRAME TO BE DEMOLISHED.

EXISTING DOOR AND FRAME TO BE DEMOLISHED.

CAUTION:
IF THIS DRAWING IS A REDUCTION,
USE THE GRAPHIC SCALES.

0 1 4 6 8

1/4"=1'-0"

04-21-2021 BID SET SUBMISSION

DESIGNED: SWC

DRAWN: LHD

CHECKED: JWA

SCALE: AS SHOWN

DATE: 04/12/2021

PROJECT: 2018.0375.05

DRAWING:

ED101

		Interior_Lighting Finishes_	Sun	plier	Inst	aller	BK	
ltem	Description	Finish		Others		Others		Notes
L1A	Accent Pendant Lighting (center tables)	Supplier: Nautical Furnishings Part #: SP30S-18-60D-927-03 (BK304) Finish: Cast Aluminum w/ Orange Acce Lamp: Edison, LED, 10W 2700K		Х		Х		Contact: 954.771.1100 Rep: Michael Hoglund Install bottom of pendant 6'-6" AFF
L1B	Accent Pendant Lighting (community tables)	Supplier: Nautical Furnishings Part #: BK305 Finish: Antique Bronze w/ Cage Lamp: Edison LED 8W 2700K or Clear Antique Style LED, 6W 2700K		X		х	В	Contact: 954.771.1100 Rep: Michael Hoglund Refer to plans for installation heights
L1C	(placed in	Item: 4" Dia White Recessed Downlight Part #: Juno, SP36671-WHTRM Size: 4" Downlight Trim: White Lamp: 15 Watt, 3000K		Х		х		Contact: 615.843.3379 Rep: Wyatt Culver, Hermitage Light. Email: wyattc@hlg.co
L1D	Black Can Light (used with ceiling tile only)	Item: 4" Dia Black Recessed Downlight Part #: SP36671-BLTRM Size: 4" Downlight Trim: Black		Х		х		Contact: 615.843.3379 Rep: Wyatt Culver, Hermitage Light. Email: wyattc@hlg.co
L1E	White Wallwasher (placed in soffits to	Item: 4" D White Recessed Wallwasher Part #: Juno, SP36671G2 Size: 4" Wallwasher Trim: # 39, White Lamp: 12.5 Watt, 3000K		X		X		Contact: 615.843.3379 Rep: Wyatt Culver, Hermitage Light. Email: wyattc@hlg.co
L1F	Black Wallwasher (used with ceiling tile only)	Item: 4" D Black Recessed Wallwasher Part #: SP36671G2/39C BL RFD44875 Size: 4" Wallwasher Trim: Black Lamp: 12.5 Watt, 3000K		Х		х		Contact: 615.843.3379 Rep: Wyatt Culver, Hermitage Light. Email: wyattc@hlg.co
L1G	Track Lighting (to accent wall shelves in lounge)	Not Applicable						
L1H	Queuing Area Lighting (open truss only)	Not Applicable						
L1I	Accent Trellis Lighting	Item: 2" Dia White Recessed Downlight Part #: Juno, SP34378B-9-F1-SN Size: 2"W x 4-1/8" H Trim: Satin Nickel Lamp: 10 Watt, 3000K		Х		х	G	Contact: 615.843.3379 Rep: Wyatt Culver, Hermitage Light. Email: wyattc@hlg.co Cut Hole Size: 2-5/8" D
L1J	Accent Trellis Lighting (Adjustable)	Item: 2"D White Recessed Wallwasher Part #: Juno, SP34378A-930-F1-SN Size: 2"W x 4-1/8" H Trim: Satin Nickel Lamp: 10 Watt, 3000K		X		х	G1	Contact: 615.843.3379 Rep: Wyatt Culver, Hermitage Light. Email: wyattc@hlg.co Cut Hole Size: 2-5/8" D
L1K	Sconce Light (optional)	Not Applicable						
Specif	ications are fo	available per BK Light Fixture Schedur REFERENCE ONLY and are current fr FCC immediately with any modification	om the	date of	the las	t revisio		architecturals for updated

			BURGER KING 20/20			1
			EXTERIOR LIGH	T FIXTURE SCH & NEW CONSTRU		
11/7/2017			ALL REMODELS	& NEW CONSTRU	TION	
TYPE		VENDOR	CATALOG No.	WATTAGE	COLOR TEMP.	REMARKS
			<u> </u>			RECESSED SOFFIT LIGHT
		CREE	per/pen co II MII	42	5000	RECESSED SOFFII LIGHT
K (NEW		SECURITY	851/852-60-U-WH	42	5000	4
CONST.)		LSI	XSPS S LED SS CW 120 GWT DFL	43	5000	-
		VAOPTO				1. FOR REMODELS ONLY
		CREE SECURITY	PE1/0F3 60 H 34/H	43	5000	2. RECESSED SOFFIT LIGHT
K REMODELS)	8	LSI	851/852-60-U-WH XSPS S LED SS CW 120 GWT DFL	42	5000	Z. RECESSED SOFTI HOTTI
nemodels,		VAOPTO	ASPS S LED 35 CW 120 GWT DFL	43	3000	-
			BS 20W/ED DO 5V 120 E200V	20	F200	1. OPTIONAL CLOSED CANOPY FIXTURE
ļ		CREE SECURITY	RS-30WLED-DO-5V-120-5300K RWSC30LED-WD-PS-MT	30 30	5300	2. PROVIDED BY SIGN SUPPLIER WITH CANOPY
L		LSI	WP35LF3X9U57KM5V	12	5700	1
(DOWN		KONTECH	KON-40-WS	40	5000	1
ONLY)		VAOPTO	VO-WS-DW40D	40	5000	1
ļ		ENERGYWISE	EWKON-40-W5	40	5000	1
		CREE	RS-42WLED-UD-SV-120-5300K	30	5300	1. EXTERIOR WALL FIXTURE
ļ		SECURITY	RWSC30LED-UD-PS-MT	30	5000	2. OPEN CANOPY FIXTURE
L (UP/DOWN)		LSI	WP36LF13X9U57KMSV	12 UP / 12 DOWN	5700	3. PROVIDED BY SIGN SUPPLIER WITH CANOPY
	100	KONTECH	KON-60-WS-DU	60	5000	-
,,,		VAOPTO	VO-WS-DW60UD	60	5000	-
		ENERGYWISE	EWKON-60-WS-DU	60	5000	-
		KONTECH	KON-DVP-182-14-JY	40	5000	1. TO BE USED AT AWNINGS
м		VAOPTO	VO-RP-40DW277-4	40	5000	2. OPTIONAL CLOSED CANOPY FIXTURE
		770110	70-III -10D11277-1	70	3000	3. PROVIDED BY SIGN SUPPLIER WITH AWNING/CANOPY
		CREE	E.WP1X031Z7	27	4000	1. WALL MOUNTED SECURITY LIGHT
ļ		SECURITY	WGH-1LU-M	41	5000	2. BRONZE FINISH
N		LSI	SFCMWBLEDPL150UEBRZ	33	5000	
		VAOPTO	VO-WP-DW-N50	50	5000	
		ENERGYWISE	EWALED-WPDS240	40	5000	
	WAS .	CREE	LFL-A-(3,4,6,8)-DO-UL-BZ-53K-EA	3'-26 / 4'-35 6'-52 / 8'-70	5300	1, CONTINUOUS ARCHON TOWER LIGHTING
0	FIE	SECURITY	HIRAF-HE-LED(96,72, 48,36)DO-120-DB	8.5 / FT.	5200	2. DOWNLIGHT ONLY
	1					3. TO BE PLACED AT TOP OF ARCHON TOWER
	130					4. TO BE BRONZE FINISH
		CREE	LFL-A-(3,4)-UO-UL-BZ-53K	3'-18 / 4'-23	5300	1. CONTINUOUS ARCHON TOWER LIGHTING
Р	100	SECURITY	HIRAF-HE-LED(48,35)UO-120-DB	50	5200	2. UPLIGHT ONLY
•						3. TO BE PLACED ABOVE ARCHON TOWER CANOPY
						4. TO BE BRONZE FINISH
		CREE	OSQ-A-DA AA-X-T-57K-UL-COLOR	166	5700	1. FINISH TO BE BLACK, BRONZE OR SILVER
ļ		SECURITY	VP-L-80NB-180-5K-T4-UNV-RA-COLOR	180	5000	]
POLE		LSI	XLCMFTLEDHOCWUE-COLOR	276	5104	]
ļ		VAOPTO	VO-SL-NW-A56	120	5000	1
		ENERGYWISE	EWEC724M2	209	5000	
	year = =			INFORMATIO		I
	CREE	IAN	HERMITAGE "MASTER CONSOLIDATOR"		SYWISE WARDDICK	KONTECHUSA
STEVE FRIEDMAN		IMI	WYATT CULVER	JENNIFER WADDICK		MIGUEL MARTINEZ
•			615 0/2 2270	877-225-1336		DEE 30E 0704
	847-830-144 friedman@c		615-843-3379 wyatt@hlg.co		25-1336 gywisemail.com	866-236-8701

corr		INFORMATION	MODETT CHIEF A
CREE	HERMITAGE "MASTER CONSOLIDATOR"	ENERGYWISE	<u>KONTECHUSA</u>
STEVE FRIEDMAN	WYATT CULVER	JENNIFER WADDICK	MIGUEL MARTINEZ
847-830-1444	615-843-3379	877-225-1336	866-236-8701
steve.friedman@cree.com	wyatt@hlg.co	jennifer@energywisemail.com	
SECURITY LIGHTING		<u>VaOpto</u>	DAVE VAN DER BEEK
ERIC HILLESLAND		ERIC DE RAMOS	727-919-1816
630-636-8493		702-517-5789	DAVIDV2009@ATT.NET
quotations@securitylighting.com		eric@vaopto.com	
<u>LSI</u>			JIM MILES
CURT GOOD			727-560-7985
404-655-8440			JIM@FLORIDAELECTRONIC.NET
curt.good@lsi-industries.com			

1. NOT ALL LIGHT FIXTURES TYPES SHOWN ON SCHEDULE MAY BE USED ON THIS PROJECT. REFER TO LIGHTING PLAN FOR PROJECT SPECIFIC TYPES AND QUANTITIES.

1. NOT ALL LIGHT FIXTURES TYPES SHOWN ON SCHEDULE MAY BE USED ON THIS PROJECT. REFER TO LIGHTING PLAN FOR PROJECT SPECIFIC TYPES AND QUANTITIES.

			BURGER KING 20/20 GARDI INTERIOR LIGHT FIXTUE			
6/2017			LOW PROFILE TO	NELLIC		
TYPE		VENDOR	LOW PROFILE TE	WATTAGE	COLOR TEMP	REMARKS
TIFE	· ·	NAUTICAL	BK304 & SP30S-18-60D-927-03	10	2700	SHAKER PENDANT LAMP
A	<u></u>	NAUTICAL	LED EDISON STYLE 10 WATT	10	2700	SID MALIA I CIAD/MAT CAMAII
^			ELD EDIOGNATIVE 20 WATE			
	1	NAUTICAL	BK305 & LED 8W EDISON INCANDESCENT	6	2700K	BRONZE CAGE PENDANT LIGHT
В			LED CLEAR ANTIQUE STYLE 6 WATT			
	$\Box$					
	4	NAUTICAL	BK305 & LED 8W EDISON INCANDESCENT	6	2700K	BRONZE CAGE WALL SCONCE LIGHT
B1			LED CLEAR ANTIQUE STYLE 6 WATT			
	$\Theta$					
		JUNO	SP36671-WHTRM	15	3000	1. 4" DIAMETER, WHITE, RECESSED DOWN LI
C4w	The state of the s	CREE	CR4-575L-27K-12-E26	9.5	2700	2. TO BE USED WITH GWB CEILING
		ENERGYWISE	EWMLEDDL4IN	11	2700	
		SECURITY	LB4A 6L 30K 9 WH / IBXQL	9	3000	
C4b		JUNO	SP36671-BLTRM		<del>                                     </del>	1. 4" DIAMETER, BLACK, RECESSED DOWN LIG TO BE USED WITH ACOUSTICAL CEILING TILE:
		CREE	CR4-575L-27K-12-E26-MODBLK	9.5	2700	
D.4		JUNO	SP36671G2 / 39 WWH	12.5	3000	1. 4" DIAMETER, WHITE, RECESSED DOWN LI WALL WASHER
D4w		SECURITY	LBE4A 6L 30K 9 WH / IBXQL	9	3000	2. TO BE USED WITH GWB CEILING
		HINO	SD267462 / 200 N. DEDA4675	43.5	2000	1. 4" DIAMETER, BLACK, RECESSED DOWN LIK
D4b		JUNO	SP36671G2 / 39C BL RFD44875	12.5	3000	WALL WASHER
1740						2. TO BE USED WITH ACOUSTICAL CEILING TI
		JUNO	R600L3KNBZ	10	2700	TRACK LIGHT
E		35110	HOODENNAME	10	2700	†
						1
	Oth	JUNO	SP34378B-9-F1-SSN	10	3000	2" DIAMETER DOWN LIGHT, SATIN NICKEL FII
G		ZANIBONI	D2LUNA20930A3CSNP0BK0P	9	3000	
G1		JUNO	SP34378A-930-F1-SN	10	3000	2" DIAMETER WALL WASHER, SATIN NICKEL
		ZANIBONI	D2LUN2O0930A3C5NP0BK0D	9	3000	7
		CREE	CL-E-TFA04A-24R-40N	42	4000	1. TO BE USED IN KITCHEN
	-	SECURITY	LJT24-40-MLG-FSA-12-EU-C388	45	4000	2. 2x4 RECESSED
I		LSI	SFP24 LED 50 UE DIM 40	50	4000	
		VAOPTO	VO-PL-2NW4-50	60	4100	
		ENERGYWISE	EWMLFP24EP4841	48	4100	
	1040	CREE	CL-E-TR14L2404U	42	3500	1. FOR REMODELS ONLY
		SECURITY	LJT14-35LWG-FSA12-EDU-C388	27	3500	2. TO BE USED IN RESTROOMS
J		LSI	SFP14 LED 40 UE DIM 35 FK14	40	3500	3. 1×4 RECESSED
		VAOPTO	VO-PL-1XWW4-50	50	3000	4
		ENERGYWISE	EWMLFP14EP3535	35	3500	4 TO DE LIGED IN DI ANGO SILVIO
		CREE	CL-E-TFA03A-22R-40N	32	3500	1. TO BE USED IN PLAYGROUND
PG		SECURITY	LJT22-35MLG-PSA12 EU	35	3500 3500	2. 2x2 RECESSED
		LSI VAOPTO	SFP22 LED 30 UE DIM 35 FK22 VO-PL-2XWW2-36	30 36	3500 3000	1
		ENERGYWISE	EWMLFP22EP3535	36	3500	1
		CREE	EM22RWH	11	1	EMERGENCY LIGHT
		SECURITY	CU2	1	3000	
EM	期 333	LSI	LTEMWH	(2) 1 LED		
	-033)	VAOPTO	VO-EM	2	5000	1
		ENERGYWISE	EWCU2	1	3000	EVET I FRAFFSMERION LLOS CO
		CREE	EXDMBRWH	11	1	EXIT / EMERGENCY LIGHT
EMX	EVIT	SECURITY LSI	CCRRC  LPRXRUWBWHLD11R	(2) 1 LED	1	-
FIAIV	EXIT	VAOPTO	LPRXRUWBWHLD11R  VO-EMX-R1	(2) 1 LED	5000	1
		ENERGYWISE	EWCCR	4	3000	-
		CREE	W\$4-50L-57K-10V-FD	55	5300	TO BE USED IN WALK IN BOX ONLY
		SECURITY	LXEM4-50ML-RFA-EU	53	5000	]
WIB		LSI	EG34SLEDHOCWUE	52	5300	
		VAOPTO	VO-TF-14W	32	5000	
		ENERGYWISE	EWMLED-LSV2XT8USE4806	36	1	i

	CONTACT INFORM	ATION	
<u>CREE</u>	HERMITAGE "MASTER CONSOLIDATOR"	<u>ENERGYWISE</u>	JUNO / ACUITY BRANDS
STEVE FRIEDMAN	WYATT CULVER	JENNIFER WADDICK	BRETT D KINZLER
847-830-1444	615-843-3379	877-225-1336	o 847-813-8350 m 847-312-1578
steve.friedman@cree.com	wyatt@hlg.co	jennifer@energywisemail.com	brett.kinzler@acuitybrands.com
SECURITY LIGHTING	NAUTICAL FURNISHINGS	<u>VaOpto</u>	ZANIBONI LIGHTING
ERIC HILLESLAND	MICHAEL HOGLUND	ERIC DE RAMOS	JENNIFER MORRIS
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quotations@securitylighting.com	mhoglund@nauticalfurnishings.com	eric@vaopto.com	southeastusa@zanibonilighting.com
<u>LSI</u>			
CURT GOOD			
404-655-8440			
curt.good@lsi-industries.com			

NOTES
1. NOT ALL LIGHT FIXTURES TYPES SHOWN ON SCHEDULE MAY BE USED ON THIS PROJECT. REFER TO LIGHTING PLAN FOR PROJECT SPECIFIC TYPES AND QUANTITIES.
2. PENDANT FIXTURES "A" MUST BE CENTERED OVER TABLE TOPS. COORDINATE WITH DÉCOR DRAWINGS.
3. EXCEPT FOR DROPPED CEILING OPTION, ALL LIGHT FIXTURES IN DINING ROOM AREA & RESTROOM CORRIDOR ARE TO BE SUPPORTED FROM EXPOSED ROOF TRUSSES.
4. CONTRACTOR TO NOTIFY LIGHTING SUPPLIER OF THE FOLLOWING: FIXTURE TYPES "C" AND "D" WILL BE REQUIRED TO BE LENS AT THE LOCATIONS OVER THE SERVICE

AREA AND OVER THE SELF-SERVE DRINK AREA. FIXTURE TYPE "I" WILL REQUIRE A LENS OR TUBE GUARD AT THOSE LOCATIONS.

ВУ				
REVISION				
DATE				
NO.				





I hereby certify that these documents were prepared or approved by me, and that I am a duly licensed professional architect under the laws of the State of Maryland.

License #6140 Expiration Date: 08/21/2020

LIGHTING FIXTURE SCHEDULE
ERATIONS - BURGER KING # 10839

DESIGNED:	SWC	
DRAWN:	LHD	
CHECKED:	JWA	
SCALE:	AS SHOWN	
DATE:	04/12/2021	
PROJECT:	2018.0375.05	

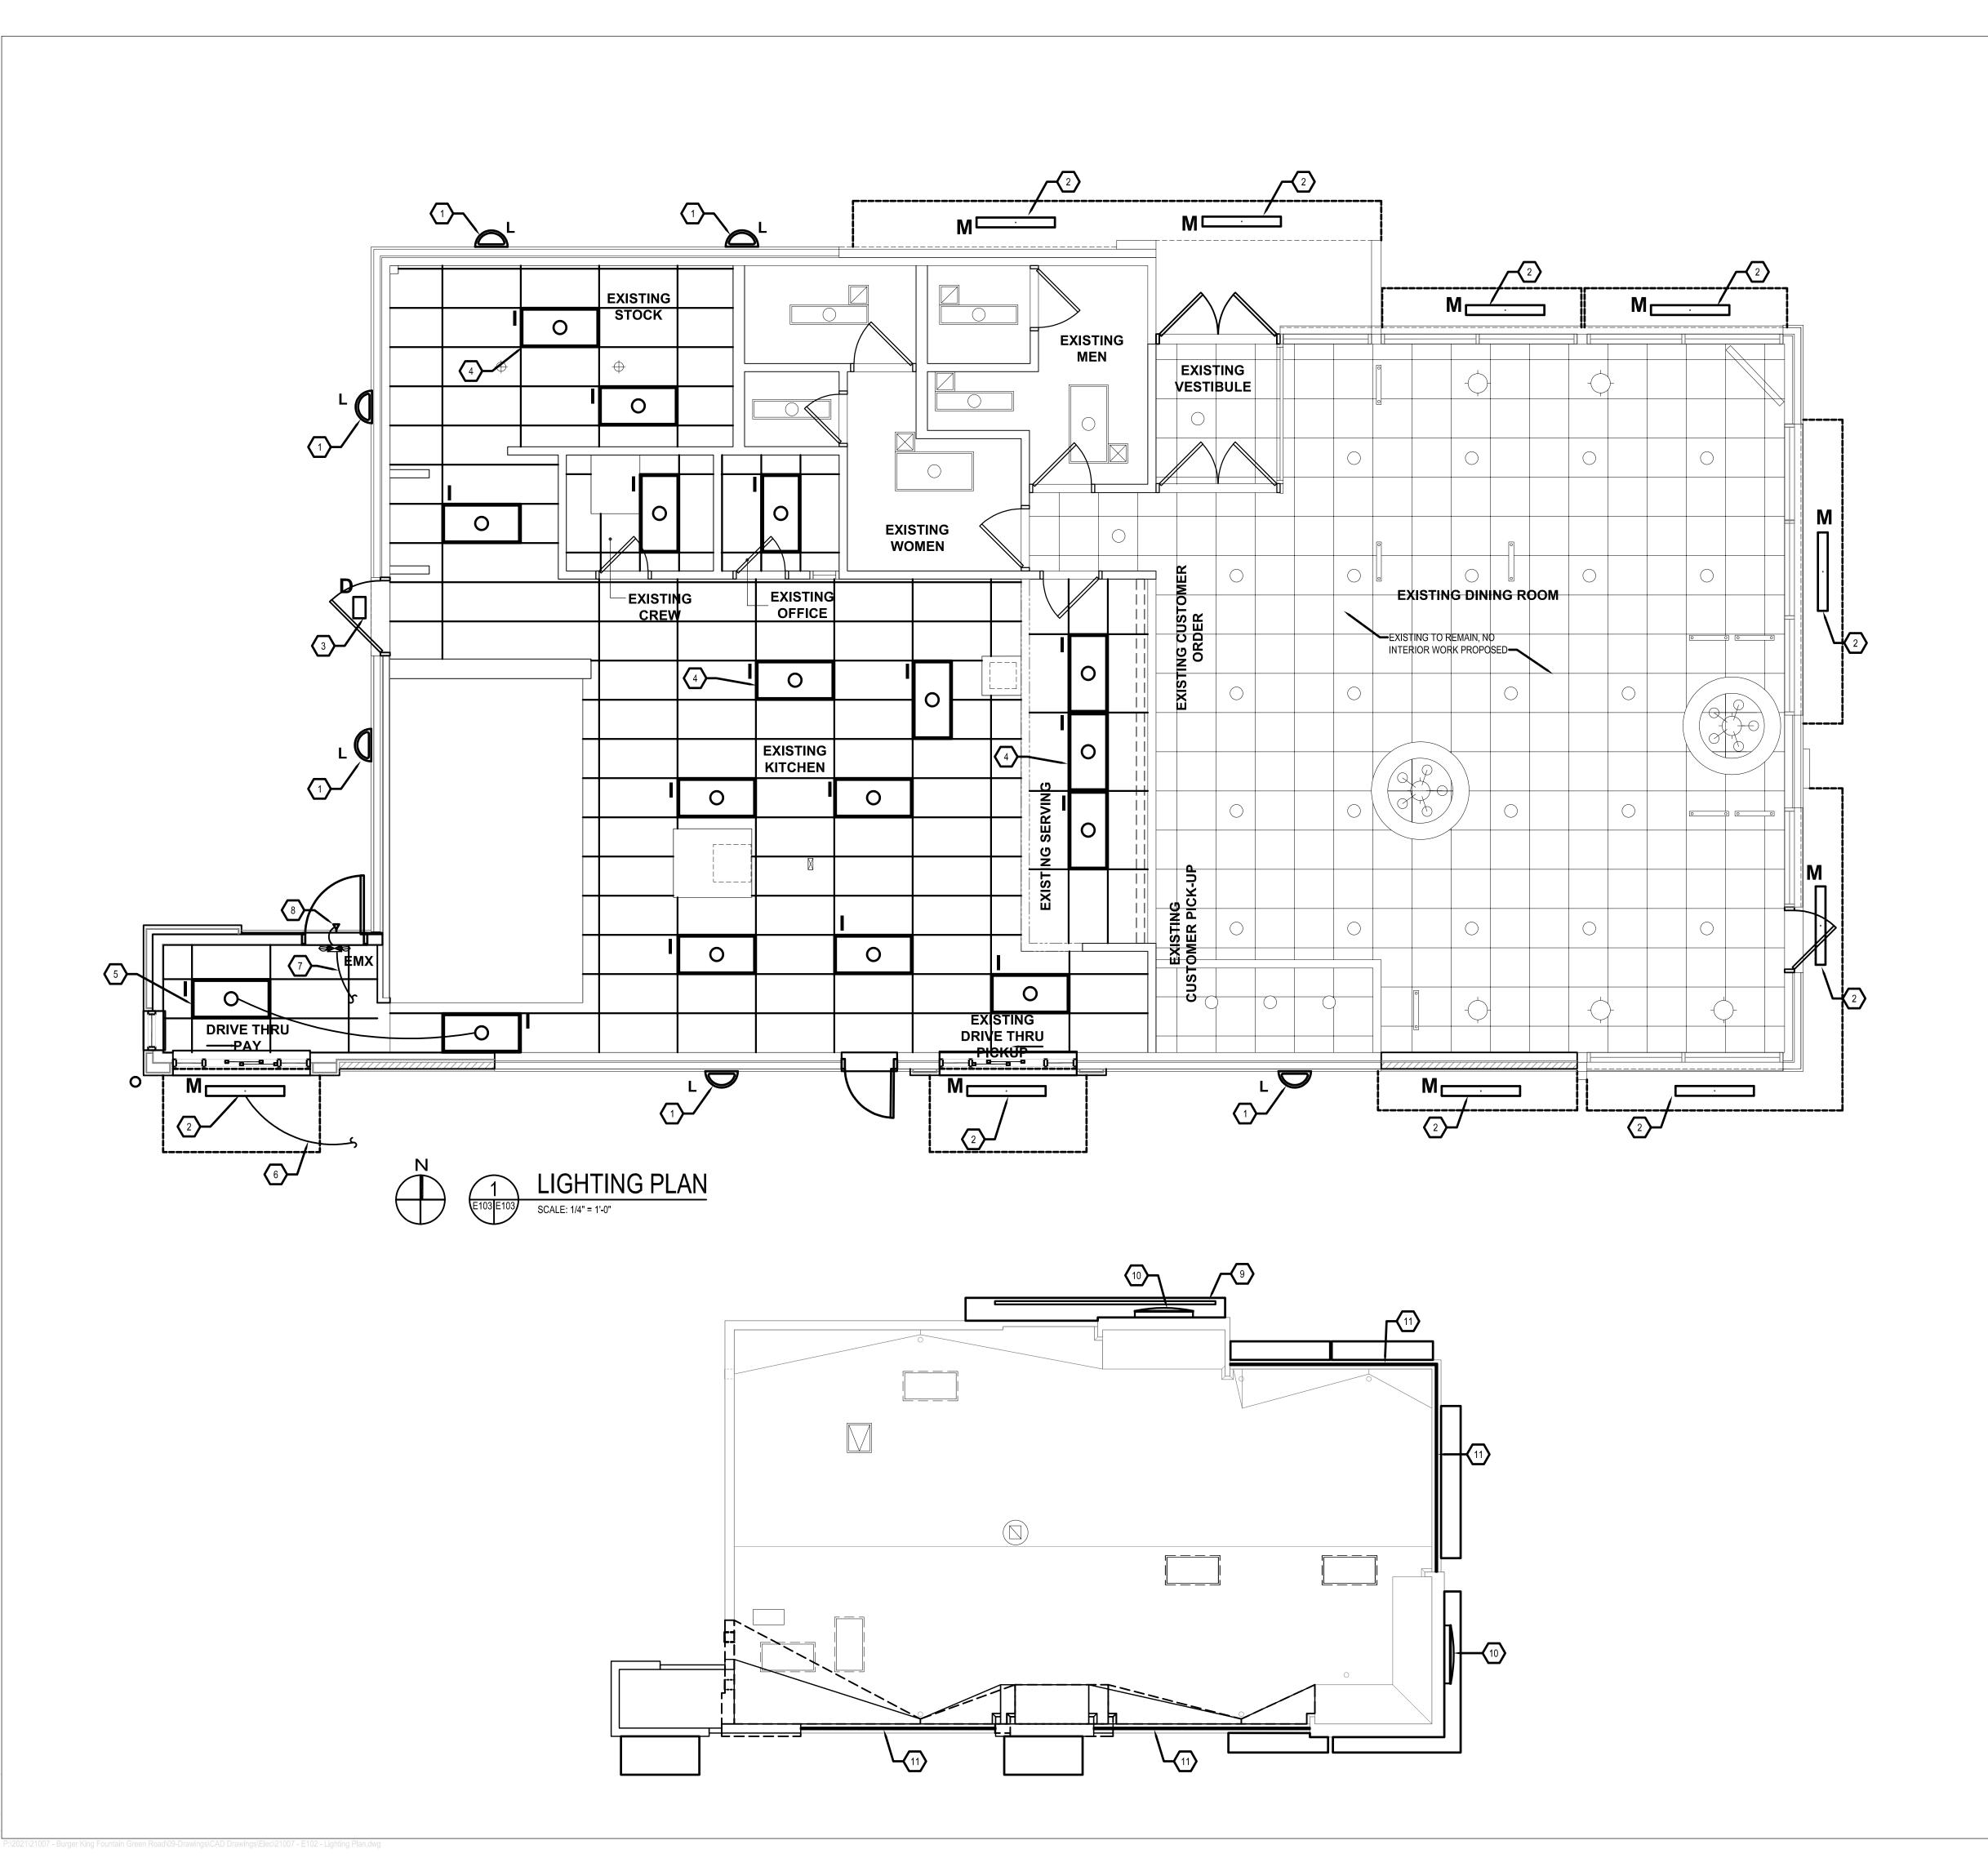

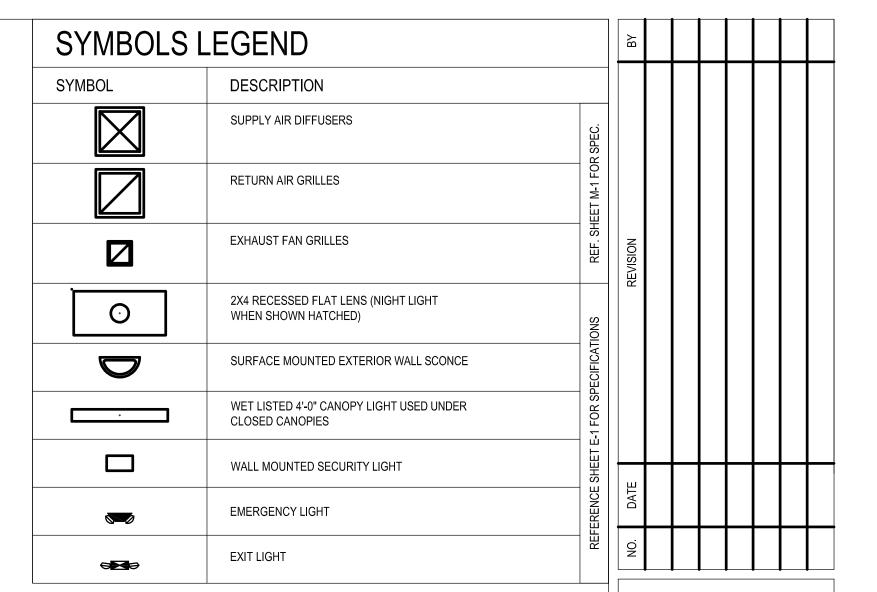

# GENERAL SHEET NOTES

- 1. REFER TO SHEET E-1.1 FOR LIGHT FIXTURE SPECIFICATIONS
- 2. SEE ARCHITECTURAL REFLECTED CEILING PLAN FOR EXACT LOCATION AND MOUNTING HEIGHTS OF LIGHT FIXTURES. COORDINATE FIXTURE LOCATIONS WITH DECOR DRAWINGS.
- 3. ALL WORK AND MATERIALS SHALL BE BY THE ELECTRICAL CONTRACTOR UNLESS NOTED
- 4. MC CABLE ONLY PERMITTED FOR LIGHT WHIPS. ALL OTHER TO BE E.M.T CONDUIT IN CEILING AND WALLS - RIGID CONDUIT UNDER SLAB.
- 5. PROVIDE JUNCTION BOXES AT LIGHT FIXTURES PER MANUFACTURERS REQUIREMENTS. (TYPICAL FOR ALL LIGHTING FIXTURES)
- 6. WHERE TRUSSES ARE EXPOSED, RUN ALL ELECTRICAL CONDUITS ABOVE THE BOTTOM CHORD



# ○ SHEET KEYNOTES

- 1. NEW WALL MOUNTED FIXTURE TYPICAL. RECONNECT TO EXISTING CIRCUIT.
- 2. MOUNT FIXTURE IN CANOPY, RE-CONNECT TO EXISTING CIRCUIT. EXTEND EXISTING LIGHTING CIRCUIT TO ACCOMMODATE NEW CANOPY LIGHT LOCATION.
- 3. EXISTING EMERGENCY LIGHT FIXTURE TO REMAIN.
- 4. NEW RECESSED LIGHT FIXTURE IN NEW CEILING, TYPICAL. RE-CONNECT TO EXISTING LIGHTING
- 5. EXTEND 2#12+#12GW IN 3/4" CONDUIT TO NEAREST ADJACENT FIXTURE (CONTROLLED WITH KITCHEN LIGHTING) AND MAKE ALL CONNECTIONS.
- 6. EXTEND 2#12+#12GW IN 3/4" CONDUIT TO NEAREST ADJACENT CANOPY FIXTURE (CONTROLLED WITH EXISTING CANOPY LIGHTING) AND MAKE ALL CONNECTIONS. ROUTE ALL WIRING INSIDE
- 7. CONNECT TO LIGHTING CIRCUIT IN SAME AREA AHEAD OF SWITCH LEG WITH 2#12+#12GW IN 3/4" CONDUIT.
- 8. REMOTE HEAD FOR EMERGENCY LIGHTING, PROVIDE INDOOR UNIT WITH SUFFICIENT BATTERY CAPACITY TO ACCOMMODATE REMOTE HEAD LOAD. CONNECT WITH 2#12+#12GW IN 3/4"
- 9. INSTALL NEW ILLUMINATED SIGNAGE ON NEW CANOPY, RECONNECT TO EXISTING CIRCUIT.

CAUTION: IF THIS DRAWING IS A REDUCTION, USE THE GRAPHIC SCALES.

- 10. RE-INSTALL EXISTING SIGNAGE, RECONNECT TO EXISTING CIRCUIT.
- 11. INSTALL NEW LIGHT BAND, RECONNECT TO EXISTING CIRCUIT.

I hereby certify that these documents were prepared or approved by me, and that I am a duly licensed professional architect under the

License #6140 Expiration Date: 08/21/2020

laws of the State of Maryland.


**BURGER KING** 


220:0:125:	0110
DRAWN:	LHD
CHECKED:	JWA
SCALE:	AS SHOWN
DATE:	04/12/2021
PROJECT:	2018.0375.05
DRAWING:	


DESIGNED: SWC

E102

04-21-2021 BID SET SUBMISSION

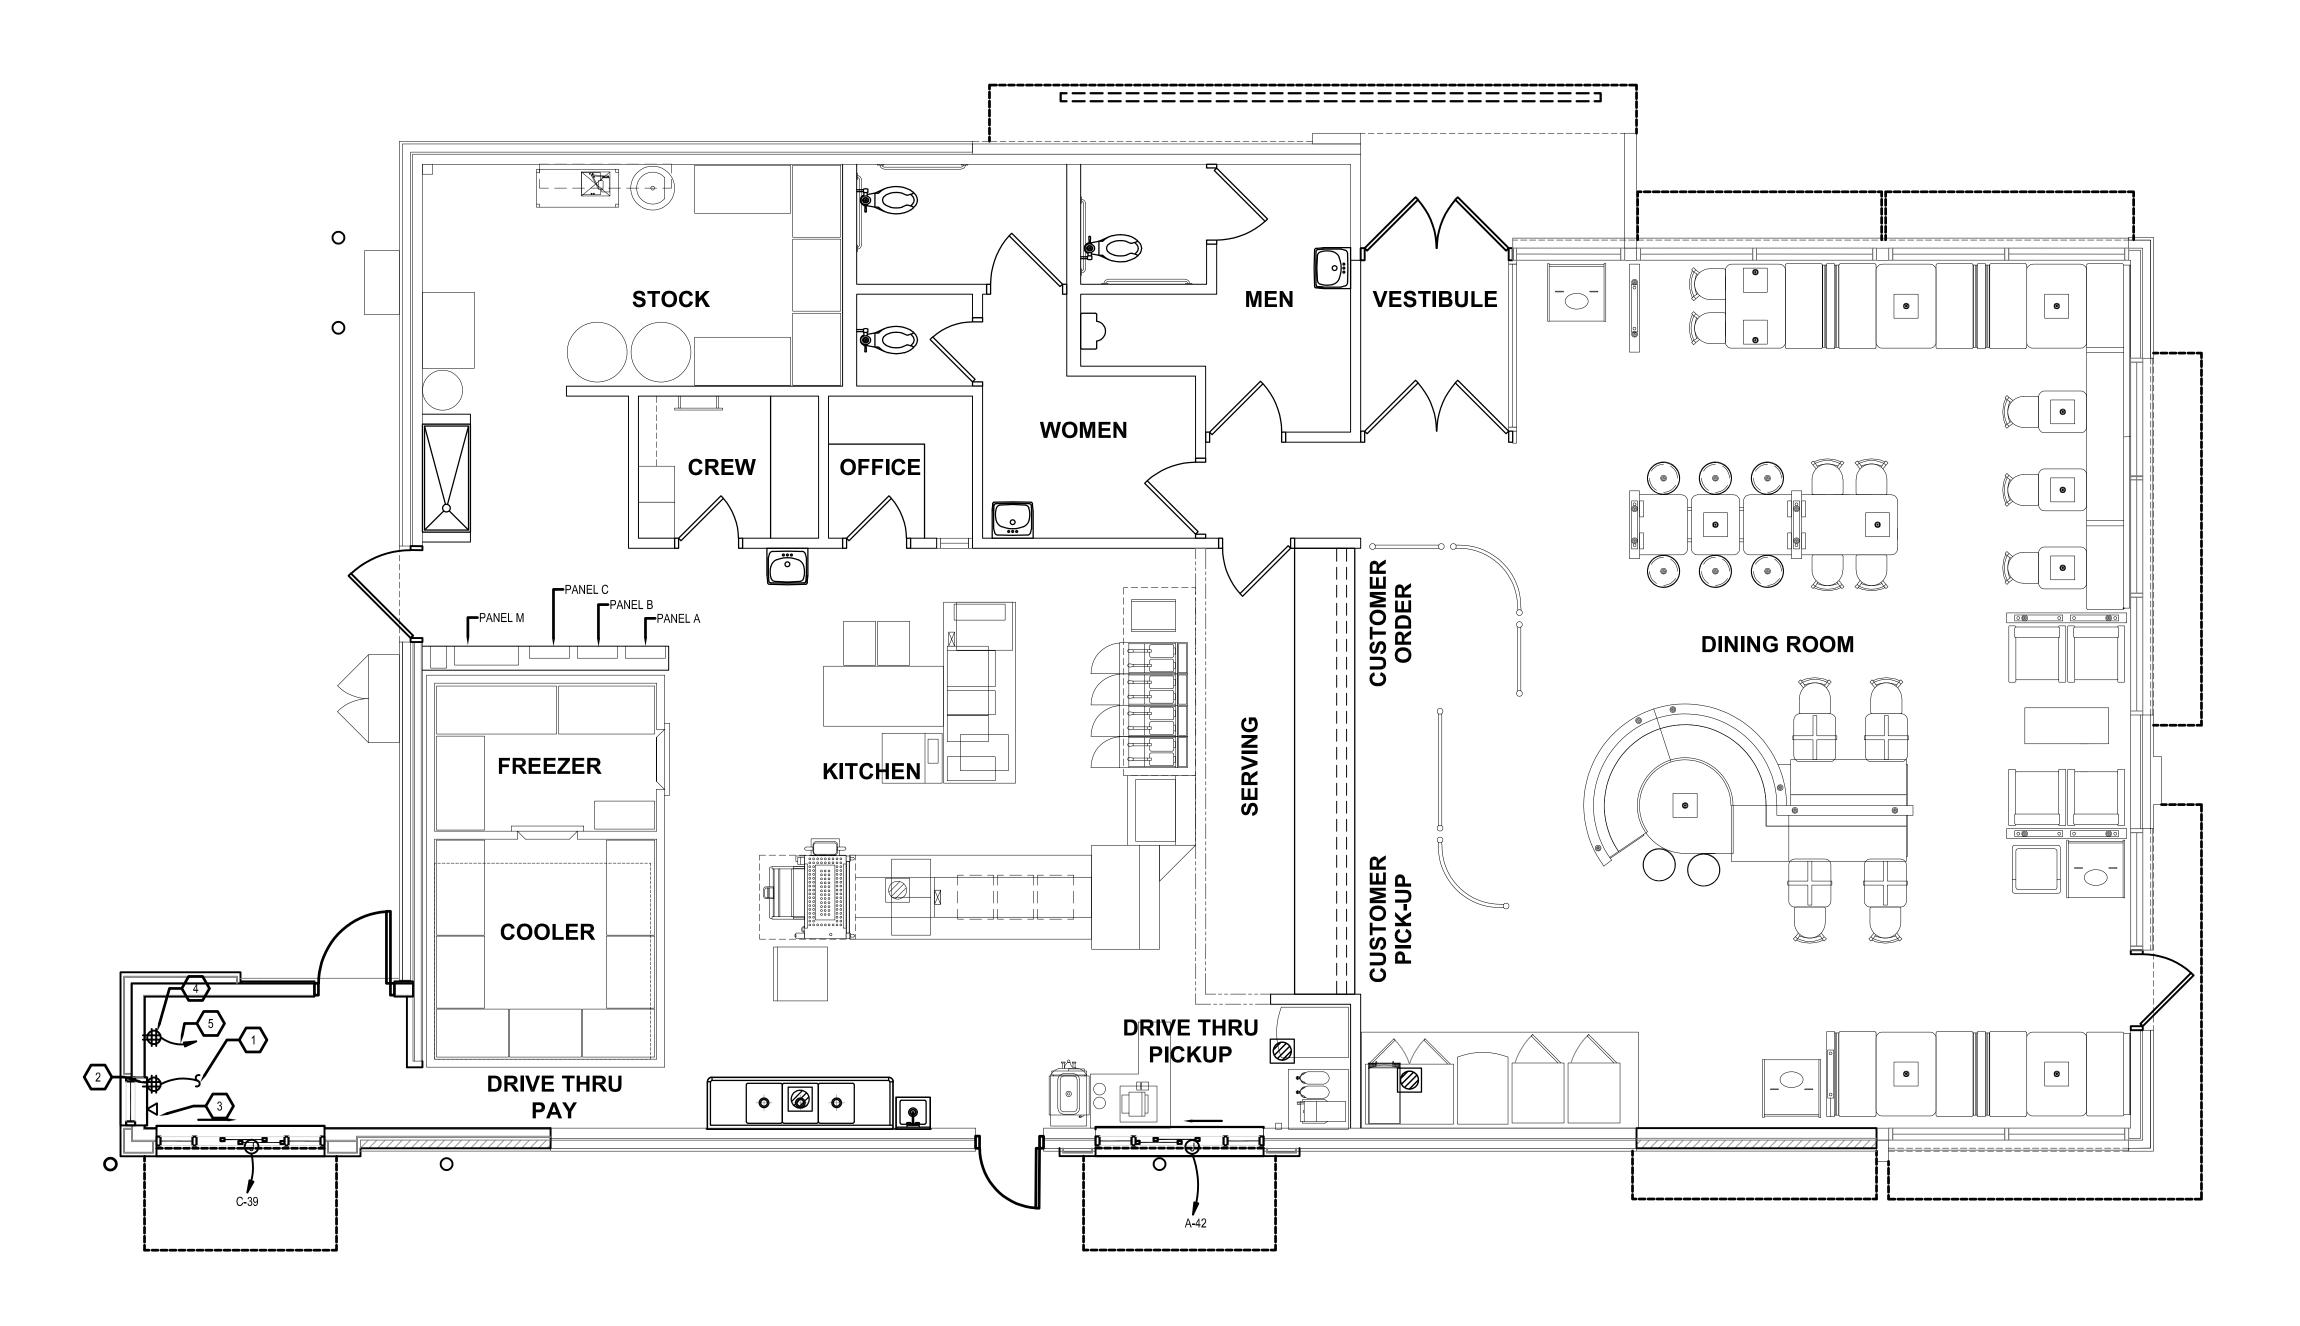

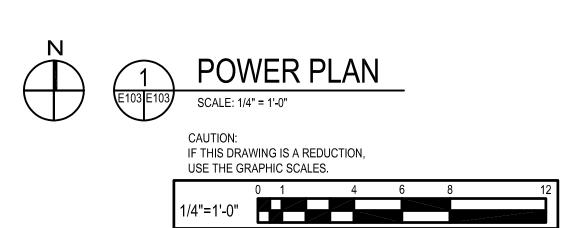


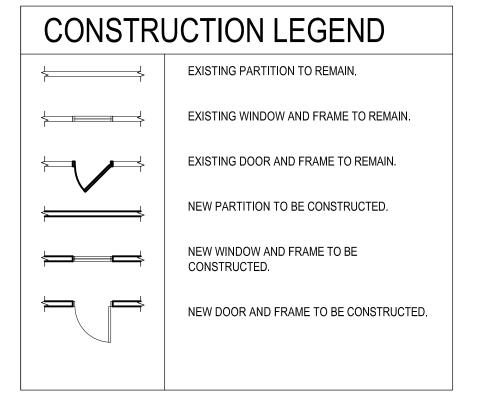

# ○ SHEET KEYNOTES

- 2#12+#12GW IN 3/4" CONDUIT, EXTEND AND CONNECT TO EXISTING RECEPTACLE CIRCUIT PREVIOUSLY SERVING DRIVE THRU WINDOW RECEPTACLE.
- 2. DOUBLE DUPLEX RECEPTACLE (WHITE) WITH STAINLESS STEEL COVER PLATE, 2P., 3W., 20A., 125V. NEMA 5-20R CONFIGURATION. MOUNT AT 18" ABOVE FINISHED FLOOR UNLESS OTHERWISE NOTED.
- 3. DATA OUTLET, SINGLE GANG BACK BOX WITH 3/4" CONDUIT WITH BUSHED ENDS TO ACCESSIBLE CEILING.
- 4. DOUBLE DUPLEX RECEPTACLE (WHITE) WITH STAINLESS STEEL COVER PLATE, 2P., 3W., 20A., 125V. NEMA 5-20R CONFIGURATION. MOUNT AT 72" ABOVE FINISHED FLOOR.
- 5. 2#12+#12GW IN 3/4" CONDUIT BACK TO PANEL A. PROVIDE 1P-20A CB IN EXISTING SPACE AND MAKE ALL CONNECTIONS. PANEL A IS A SIEMENS TYPE S1 PANEL BOARD.

ВУ				
REVISION				
DATE				
NO.				

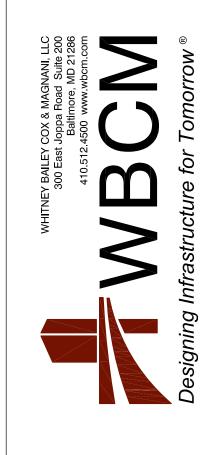

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License #6140 Expiration Date: 08/21/2020

POWER PLAN

LTERATIONS - BURGER KING
BURGERS OF BALTIMORE, LLC.
200 SOUTH FOUNTAIN GREEN ROAD

DESIGNED:	SWC	
DRAWN:	LHD	
CHECKED:	JWA	
SCALE:	AS SHOWN	
DATE:	04/12/2021	
PROJECT:	2018.0375.05	
	•	


E103


04-21-2021 BID SET SUBMISSION

		(EXISTING) 208Y/120V,3ø,4W	NE	W CIRC	UITS	SHOW	N BOLE	)				OUNTING CATION			)		
250	AMP	ERE BUS	125 A MLO							100% RATE	) NE	UTRAL	BUS			22,0	00 A.I.C
CONN KVA	СКТ	DESCRIPTION	BR P	EAKER AMPS	NO	CIRCU	JIT WIR	NG C	СКТ	DESCRIPTION	⊢	EAKER AMPS	NO	CIRCU	JIT WIRI	ING C	CON
IVA					INO	OIZL	GIND							SIZL	GIND		
		EXISTING CIRCUIT	1	20	-	-	-	-	2	EXISTING CIRCUIT	1	20	-	-	-	-	
	3	EXISTING CIRCUIT	1	20	-	-	-	-	4	EXISTING CIRCUIT	1	20	-	-	-	-	╢
	5	EXISTING CIRCUIT	1	20	-	-	-	-	6	EXISTING CIRCUIT	1	20	-	-	-	-	╢
	<u> </u>	EXISTING CIRCUIT	1	20	-	-	-	-	8	EXISTING CIRCUIT	1	30	-	-	-	-	
		EXISTING CIRCUIT	1	20	-	-	-	-	10	-	1	-	-	-	-	-	
	_	EXISTING CIRCUIT	1	20	-	-	-	-	12	-	1	-	-	-	-	-	
	⊢—	EXISTING CIRCUIT	1	20	-	-	-	-	14	EXISTING CIRCUIT	1	20	-	-	-		
	15	EXISTING CIRCUIT	1	20	-	-	-	-	16	EXISTING CIRCUIT	1	20	-	-	-	-	
	17	EXISTING CIRCUIT	2	30	-	-	-	-	18	EXISTING CIRCUIT	2	20	-	-	-	-	Щ
	19	-	-	-	-	-	-	-	20	EXISTING CIRCUIT	-	-	-	-	-	-	
	21	EXISTING CIRCUIT	2	30	-	-	-	-	22	EXISTING CIRCUIT	2	20	-	-	-	-	┸
	23	-	-	-	-	-	-	-	24	EXISTING CIRCUIT	-	-	-	1	-	-	
	25	EXISTING CIRCUIT	2	30	1	-	-	-	26	EXISTING CIRCUIT	1	20	1	-	-	-	
	27	-	-	-	-	-	-	-	28	EXISTING CIRCUIT	1	20	-	-	-	-	
	29	EXISTING CIRCUIT	2	30	-	-	-	-	30	EXISTING CIRCUIT	2	30	-	-	-	-	
	31	-	-	-	-	-	-	-	32	EXISTING CIRCUIT	-	-	-	-	-	_	
	33	EXISTING CIRCUIT	2	20	-	-	-	-	34	-	1	20	-	-	-	-	
	35	-	-	-	-	_	-	-	36	EXISTING CIRCUIT	3	30	-	-	-	_	
	37	EXISTING CIRCUIT	1	20	-	_	-	-	38	-	-	-	-	-	-	_	
	39	EXISTING CIRCUIT	1	20	-	-	-	-	40	DRIVETHRU RECEPTACLE	1	20	2	12	12	3/4	
	41	EXISTING CIRCUIT	1	20	-		-		42	AIR CURTAIN	1	15	2	12	12	3/4	
TOTAL	CON	NECTED LOAD		0.0	KVA					KVA PER PHASE:	Α	0.0	В	0.0	С	0.0	

		08Y/120V,3ø,4W ERE BUS		125 A MLO						LOCATION: KITCHEN  100% RATED NEUTRAL BUS 22.0					22,00	0 A.I.	
CONN			BRE	EAKER		CIRCI	JIT WIRI	ING			BR	EAKER		CIRCL	UIT WIRING CO		
KVA	СКТ	DESCRIPTION	P	AMPS	NO	SIZE	GND	С	СКТ	DESCRIPTION	P		NO	SIZE	GND	С	ΚV
	1	EXISTING CIRCUIT	1	20	-	-	-	-	2	EXISTING CIRCUIT	1	20	-	-	-	-	
	3	EXISTING CIRCUIT	1	20	-	-	-	-	4	EXISTING CIRCUIT	1	20	-	-	-	-	
	5	EXISTING CIRCUIT	1	20	-	-	-	-	6	EXISTING CIRCUIT	1	20	-	-	-	-	
	7	EXISTING CIRCUIT	1	20	ı	-	-	1	8	EXISTING CIRCUIT	1	20	-	ı	-	-	
	9	EXISTING CIRCUIT	1	20	-	-	-	1	10	EXISTING CIRCUIT	1	20	-	1	-	-	
	11	EXISTING CIRCUIT	1	20	-	-	-	ı	12	EXISTING CIRCUIT	1	20	-	1	-	-	
	13	EXISTING CIRCUIT	1	20	-	-	-	1	14	EXISTING CIRCUIT	2	20	-	1	-	-	
	15	EXISTING CIRCUIT	1	20	1	-	-	ı	16	-	-	-	-	1	1	-	
	17	EXISTING CIRCUIT	1	20	-	-	-	ı	18	EXISTING CIRCUIT	1	20	-	ı	-	-	
	19	EXISTING CIRCUIT	1	20	-	-	-	1	20	EXISTING CIRCUIT	2	20	-	ı	-	-	
	21	EXISTING CIRCUIT	1	20	1	-	-	1	22	-	-	-	-	1	-	-	
	23	EXISTING CIRCUIT	1	20	-	-	-	ı	24	EXISTING CIRCUIT	1	20	-	ı	-	-	
	25	EXISTING CIRCUIT	1	20	1	-	-	1	26	EXISTING CIRCUIT	1	20	-	1	1	-	
	27	EXISTING CIRCUIT	3	30	-	-	-	ı	28	EXISTING CIRCUIT	2	20	-	ı	-	-	
	29	-	-	-	1	-	-	1	30	-	-	-	-	1	-	-	
	31	-	-	-	-	-	-	ı	32	EXISTING CIRCUIT	2	20	-	1	-	-	
	33	EXISTING CIRCUIT	2	30	-	-	-	1	34	-	-	-	-	1	-	-	
	35	-	-	-	-	-	-	-	36	EXISTING CIRCUIT	2	20	-	-	-	-	
	37	EXISTING CIRCUIT	2	40	-	-	-	-	38	-	-	-	-	-	-	-	
	39	-	-	-	-	-	-	-	40	EXISTING CIRCUIT	2	40	-	1	-	-	
	41	EXISTING CIRCUIT	1	20	-	-	-	-	42	-	-	-	-	-	-	-	

		(EXISTING) 208Y/120V,3ø,4W									LO	OUNTING CATION	: KIT	CHEN	)			
250	250 AMPERE BUS 125 A MLO									100% RATED NEUTRAL BUS 22,000 A						00 A.I.C.		
CONN			BRI	EAKER		CIRCL	JIT WIR	ING			BR	EAKER		CIRCL	JIT WIRI	IT WIRING CON		
KVA	СКТ	DESCRIPTION	Р	AMPS	NO	SIZE	GND	С	СКТ	DESCRIPTION	Р	AMPS	NO	SIZE	GND	С	KVA	
	1	SHAKE MACHINE	3	20	-	-	-	-	2	REC: STOCK ROOM	1	20	-	-	-	-		
	3	-	-	-	-	-	-	-	4	CARBONATORS	1	20	-	-	-	-		
	5	-	-	-	-	1	-	-	6	REC: STOCK ROOM	1	20	-	-	-	-		
	7	FREEZER COND	3	20	-	-	-	-	8	SMOOTHIE MACHINE	1	20	-	-	-	-		
	9	-	-	-	-	-	-	-	10	EXISTING CIRCUIT	1	20	-	-	-	-		
	11	-	-	-	-	-	-	-	12	EXISTING CIRCUIT	1	20	-	-	-	-		
	13	COOLER COND	2	20	-	-	-	-	14	EXISTING CIRCUIT	1	20	-	-	-	-		
	15	-	-	-	-	-	-	-	16	EXISTING CIRCUIT	1	20	-	-	-	-		
	17	COOLER FAN & LTG	1	20	-	-	-	-	18	EXISTING CIRCUIT	1	20	-	-	-	-		
	19	REC: TWIST LOCK	2	20	-	-	-	-	20	EXISTING CIRCUIT	2	30	-	-	-	-		
	21	-	-	-	-	-	-	-	22	-	-	-	-	-	-	-		
	23	REC:	2	20	-	-	-	-	24	EXISTING CIRCUIT	1	20	-	-	-	-		
	25	-	-	-	-	-	-	-	26	EXISTING CIRCUIT	3	30	-	-	-	-	<u> </u>	
	27	REC:	2	20	-	-	-	-	28	-	-	-	-	-	-	-		
	29	-	-	-	-	-	-	-	30	-	-	-	-	-	-	-	<u> </u>	
	31	SPEAKER POST 1	1	20	2	12	12	1"	32	EXISTING CIRCUIT	2	30	-	-	-	-	<u> </u>	
	33	SPEAKER POST 2	1	20	2	12	12	1"	34	-	-	-	-	-	-	-	<u> </u>	
		ODMB 1	1	20	2	12	12	1"	36	EXISTING CIRCUIT	3	20	-	-	-	-	<u> </u>	
	37	ODMB 2	1	20	2	12	12	1"	38	-	-	-	-	-	-	-		
	⊢—	CAMERA POWER SUPPLY	1	20	2	12	12	1"	40	_	-	-	-	-	-	-	<u> </u>	
	41	AIR CURTAIN	1	20	2	12	12	3/4"	42	EXISTING CIRCUIT	1	-	-	-	-	-		
TOTAL	CON	NECTED LOAD		0.0	KVA					KVA PER PHASE:	Α	0.0	В	0.0	С	0.0		

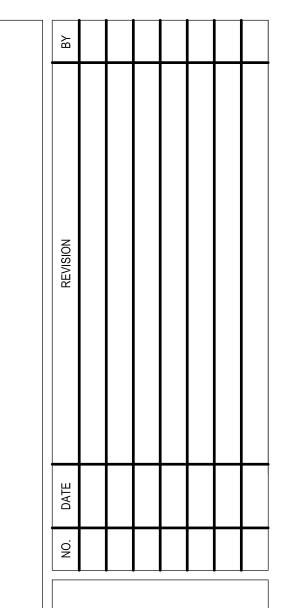

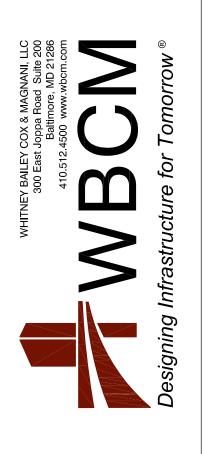



I hereby certify that these documents were prepared or approved by me, and that I am a duly licensed professional architect under the laws of the State of Maryland.

License #6140 Expiration Date: 08/21/2020

ALTERATIONS - BURGER KING

DESIGNED:	SWC
DRAWN:	LHD
CHECKED:	JWA
SCALE:	AS SHOWN
DATE:	04/12/2021
PROJECT:	2018.0375.05

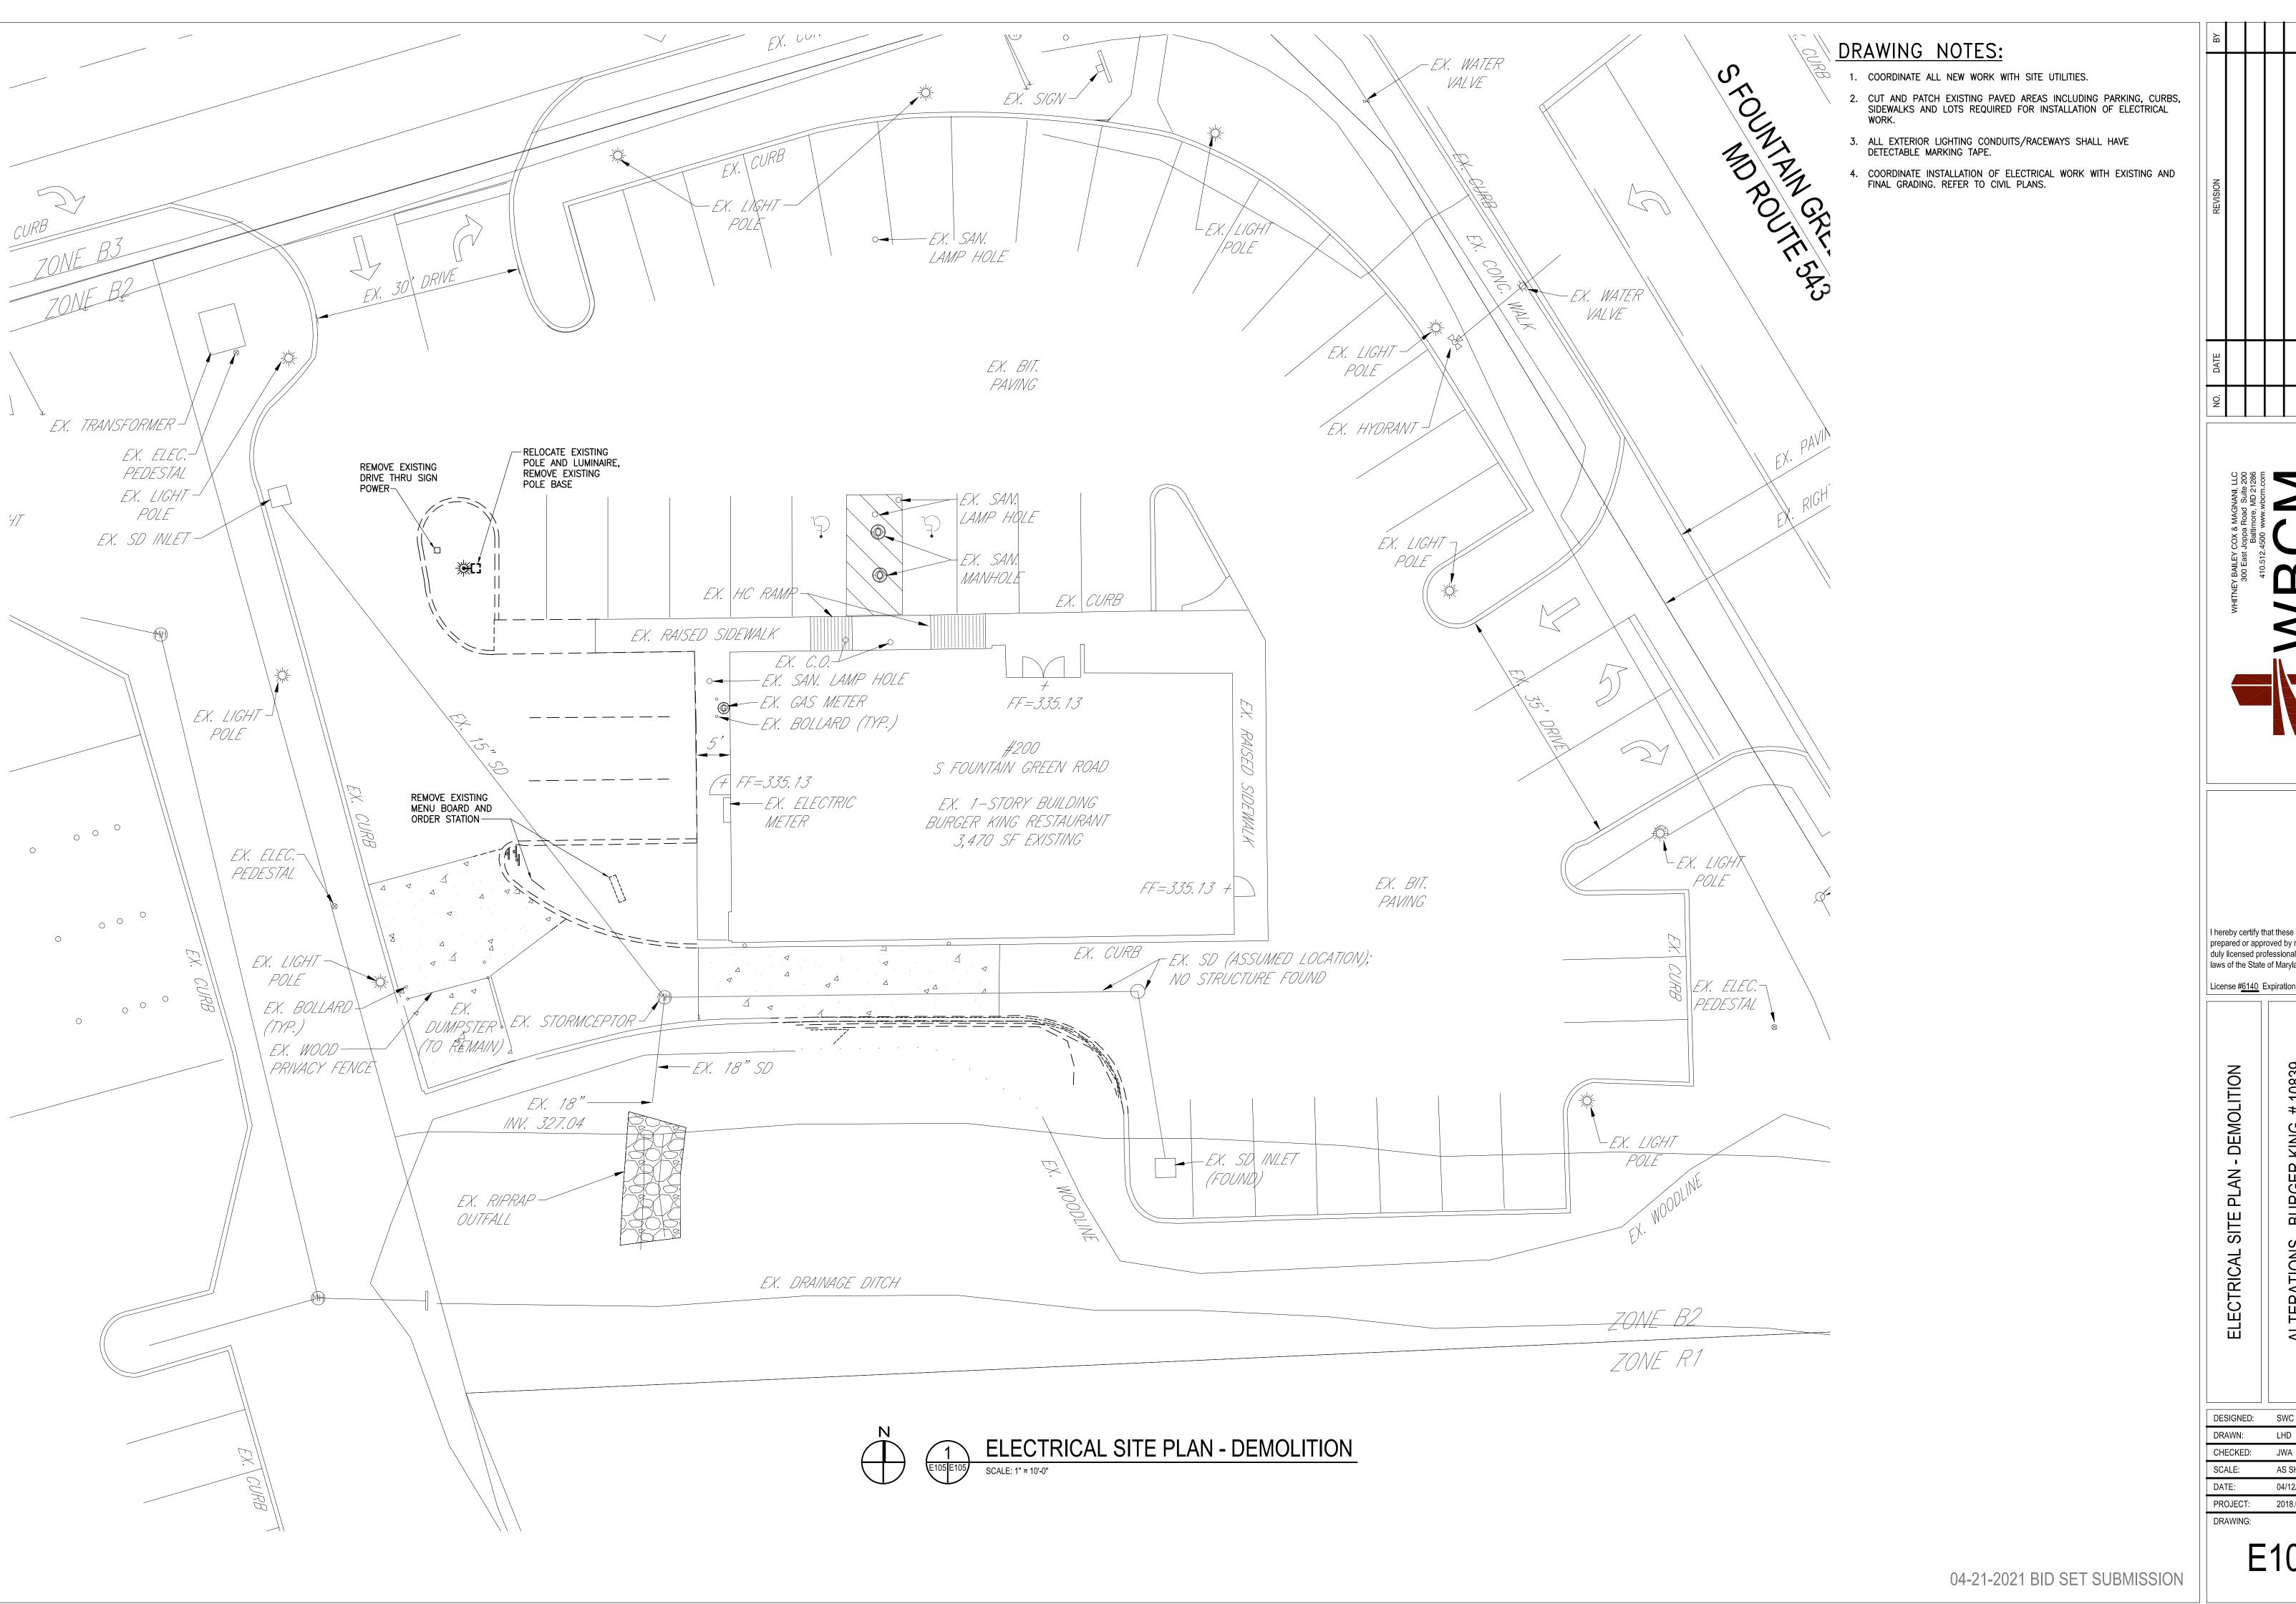

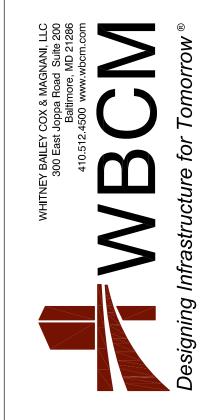


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License #6140 Expiration Date: 08/21/2020

ALTERATIONS - BURGER KING


DESIGNED:	SVVC
DRAWN:	LHD
CHECKED:	JWA
SCALE:	AS SHOWN
DATE:	04/12/2021
PROJECT:	2018.0375.05
DDAWING	

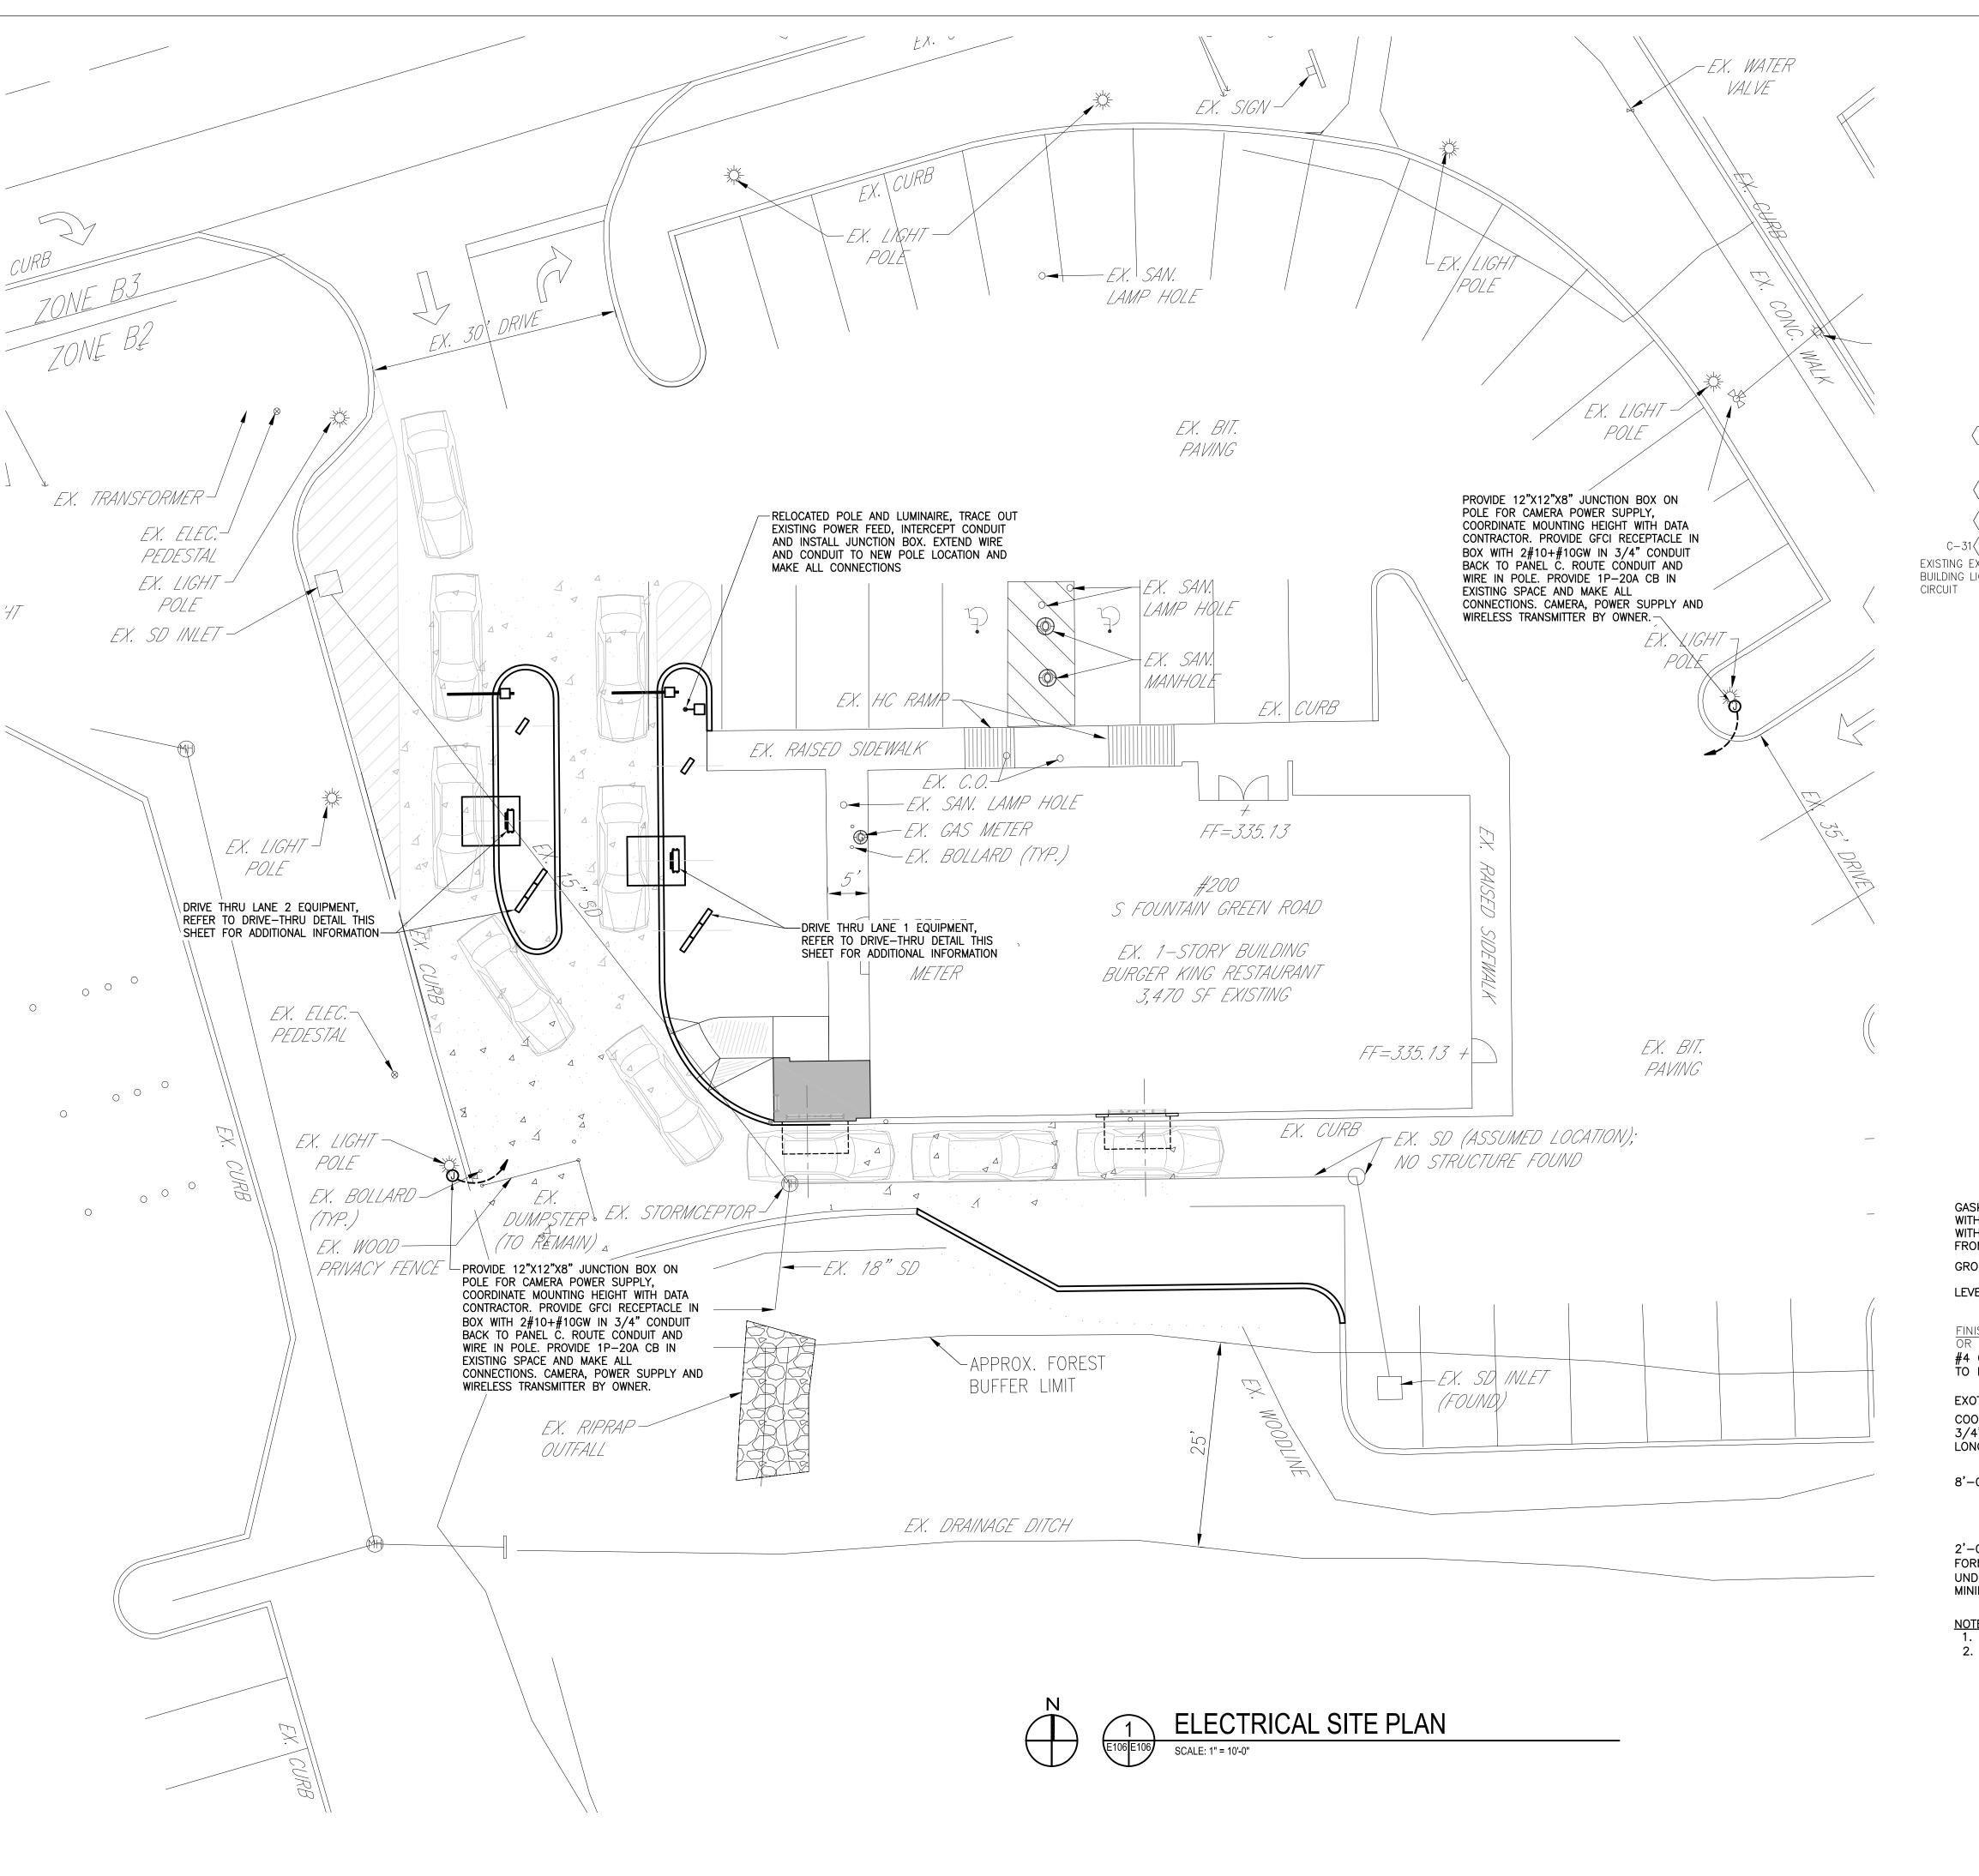

# **DRAWING NOTES:**

- 1. COORDINATE ALL NEW WORK WITH SITE UTILITIES.
- 2. CUT AND PATCH EXISTING PAVED AREAS INCLUDING PARKING, CURBS, SIDEWALKS AND LOTS REQUIRED FOR INSTALLATION OF ELECTRICAL WORK
- 3. ALL EXTERIOR LIGHTING CONDUITS/RACEWAYS SHALL HAVE DETECTABLE MARKING TAPE.
- 4. COORDINATE INSTALLATION OF ELECTRICAL WORK WITH EXISTING AND FINAL GRADING. REFER TO CIVIL PLANS.

LANE 2 DRIVE-THRU EQUIPMENT

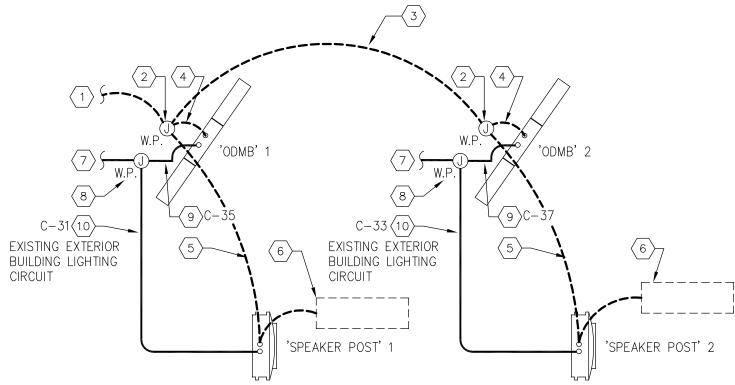

# **KEYED NOTES - DRIVE THRU:**

DATA


LANE 1 DRIVE-THRU EQUIPMENT

1. 2" UNDERGROUND DATA CONDUIT FROM DRIVE—THRU. ROUTE CONDUIT UP IN NEW DRIVETHRU WALL AND INTO

- ACCESSIBLE CEILING SPACE.

  2. WATERPROOF JUNCTION DATA BOX LOCATED BEHIND
- 3. 2" UNDERGROUND DATA CONDUIT TO LANE 2. 4. 3/4" PVC SWEPT INTO 'ODMB' FOOTER.
- 5. 3/4" PVC SWEPT INTO 'SPEAKER POST'.
  6. 1/2" PVC SWEPT INTO 'SPEAKER POST' FROM UNDER
- CONCRETE LOOP.
- ELECTRICAL

  7. 1" UNDERGROUND POWER CONDUIT TO DEDICATED CIRCUIT.
  REFER TO PANEL SCHEDULE. ROUTE CONDUIT UP IN NEW
  DRIVETHRU WALL AND INTO ACCESSIBLE CEILING SPACE.
- 8. WATERPROOF JUNCTION POWER BOX LOCATED BEHIND
- 9. 1/2" CONDUIT SWEPT INTO 'ODMB' FOOTER FOR DEDICATED POWER. REFER TO PANEL SCHEDULE.
- 10. 3/4" CONDUIT SWEPT INTO 'SPEAKER POST' FOOTER FOR DEDICATED POWER. REFER TO PANEL SCHEDULE.
  2#12+#12GW IN 1" CONDUIT, CONNECT TO EXISTING EXTERIOR BUILDING MOUNTED LIGHTING CIRCUIT.

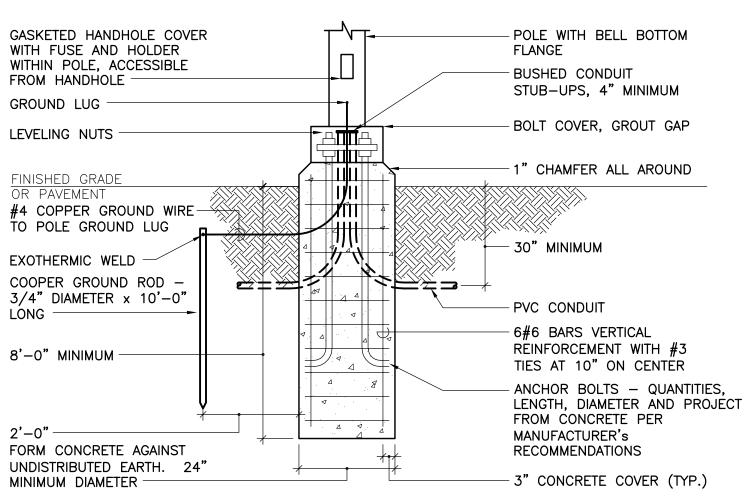

NOTES:


1. ALL REINFORCING STEEL TO BE ASTM A615, GRADE 60 EXCEPT TIES, TIES SHALL BE GRADE 40.

2. PROVIDE 1-1/4" CONDUIT MINIMUM TO EACH POLE FOR NORMAL POWER WIRING.

POLE BASE AND FOUNDATION
SCALE: NONE



NO. DATE REVISION

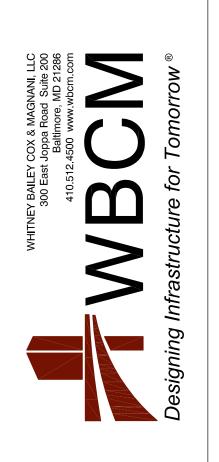

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License #6140 Expiration Date: 08/21/2020

ALTERATIONS - BURGER KING # 10839

BURGERS OF BALTIMORE, LLC.
200 SOUTH FOUNTAIN GREEN ROAD

DESIGNED:	SWC	
DRAWN:	LHD	
CHECKED:	JWA	
SCALE:	AS SHOWN	
DATE:	04/12/2021	
PROJECT:	2018.0375.05	
DRAWING:		