

BURGER KING

BURGER KING 1440 NAPPANEE ST. ELKHART, IN 46514

GENERAL SIGNAGE NOTES

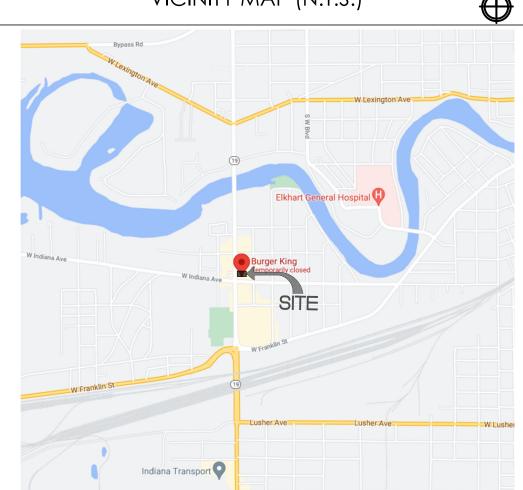
SIGN INSTALLER RESPONSIBILITIES:

- PROVIDE ALL DRAWINGS NECESSARY FOR SIGN PERMITS. APPLY FOR, OBTAIN, AND PAY FOR ALL REQUIRED SIGN PERMITS.
- COORDINATE EXCAVATION OF SIGN FOUNDATIONS WITH G.C. SET ANCHOR BOLTS OR BASE PLATES AS REQUIRED.
- COMPLETE SIGN INSTALLATION. REMOVE EXCESS DEBRIS, ROUGH GRADE AREA FOR LANDSCAPING.

GENERAL CONTRACTOR RESPONSIBILITIES:

- COORDINATE EXCAVATION OF SIGN FOUNDATIONS WITH SIGN SUPPLIER. PROVIDE POWER TO ALL SIGN LOCATIONS AS REQUIRED.
- MAKE FINAL ELECTRICAL CONNECTIONS TO EACH SIGN.

VICINITY MAP (N.T.S.)



AERIAL MAP (N.T.S.)

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PROJECT LOCATION:	OWNER:	ARCHITECT/ ENGINEER:
BURGER KING 1440 NAPPANEE ST. ELKHART, IN 46514	TODD WILLIAMS TRIA CO. 34600 FREEDOM RD FARMINGTON HILLS, MI 48335 ToddW@TriaCo.net 248.535.2300	TECHNICAL GROUP, INC. 27300 HAGGERTY RD. SUITE F FARMINGTON HILLS, MI 4833 P: 248.426.8000
EQUIPMENT:	DECOR:	SITE SURVEY:
FRANKE FOODSERVICE SYSTEMS AMERICAS, INC 800 AVIATION PARKWAY SMYRNA, TN 37167 STEPHANIE RIVERO PROJECT MANAGER STEPHANIE.RIVERO@ FRANKE.COM 615.462.4588	FCC COMMERCIAL FURNITURE 8452 OLD HWY 99 N ROSEBURG, OR 97470 P:800.322.7328 WWW.FCCFURN.COM	JONES PETRIE RAFINSKI CORI 300 NIBCO PARKWAY SUITE 250 ELKHART, IN 46516 P: 574.293.7762 MIKEL CURRIER mcurrier@jpr1source.com P: 574.232.4388

LOCAL AUTHORITIES

BUILDING DIVISION	HEALTH DEPARTMENT
CITY OF ELKHART 229 S 2ND ST., ELKHART, IN 46516 P: (574) 294-5474	ELKHART COUNTY HEALTH DEPARTMEN (ENVIRONMENTAL HEALTH) 608 OAKLAND AVE. ELKHART, IN 46516 PHONE: (574) 523-2283

THE CITY DOES MAINTAIN AN EROSION CONTROL ORDINANCE FOR CONSTRUCTION SITES. IT IS EXPECTED THAT RESPONSIBLE CONSTRUCTION TECHNIQUES WILL BE USED AND PUBLIC INFRASTRUCTURE WILL BE PROTECTED AT ALL TIMES.

IT IS THE RESPONSIBILITY OF THE CONTRACTOR WHO PERFORMS THE WORK TO ACQUIRE ALL NECESSARY PERMITS FOR WORK
WITHIN THE PUBLIC RIGHT-OF-WAY. BONDING REQUIREMENTS MAY BE APPLICABLE. CONTACT ELKHART PUBLIC WORKS AND
utilities for information and applications concerning permits.

NOTICE TO BIDDERS

THE "GENERAL CONTRACTOR," ITS "SUBCONTRACTORS," AND "VENDORS" SHALL REVIEW THE PROPOSED SITE FOR BIDDING PURPOSES AND TO FAMILIARIZE THEMSELVES WITH THE EXISTING CONDITIONS OF THE SITE AND PROPOSED SPACE. ANY DISCREPANCIES BETWEEN THE CONSTRUCTION DOCUMENTS (DRAWINGS) AND EXISTING CONDITIONS SHALL BE SUBMITTED IN WRITING TO THE "ARCHITECT" AND OWNER BY THE "GENERAL CONTRACTOR" FOR CLARIFICATION. BY FAILURE TO CLARIFY DISCREPANCIES, GC SHALL BEAR RISK AND COST, AT NO CHARGE TO OWNER TO RECTIFY. GC AND VENDOR TO CHECK DRAWINGS AND CALL/EMAIL ARCHITECT IN REGARDS TO MOST RECENT DRAWINGS BEFORE ORDERING, MANUFACTURING, AND GOING TO SITE.

CTURING, AN	ID GOING TO SITE.			Indiana ener	RGY CONSERVATION CODE	Ξ
			OCCUPANCY TYPE:	A-2; ASSEMBLY	(non-sprinkled)	
	PROJECT DA	\TA	CONSTRUCTION TYPE:	V-B; WOOD FR	RAME	
OCATION:	OWNER:	ARCHITECT/ ENGINEER:	PROPOSED OCCUPANO	CY LOAD CALCU	JLATIONS:	
NG PANEE ST.	TODD WILLIAMS TRIA CO.	TECHNICAL GROUP, INC. 27300 HAGGERTY RD. SUITE F2	TOTAL AREA OF BUILDIN	lG:	3,130 SF	

TOTAL AREA OF BUILDING:	3,130 SF

PROPOSED SEAT COUNT: 40
NUMBER OF EMPLOYEES (INCLUDING OWNERS AND MANAGERS): 6

PROJECT SCOPE:

APPLICABLE CODES:

RESTROOM PLUMBING FIXTURES

FROM 2014 IBC , TABLE 2902.1 BUILDING OCCUPANCY CALCULATION (FROM TABLE 1004.1.1):

CODE INFORMATION

GROUND-UP BURGER KING BUILD

2012 INDIANA PLUMBING CODE

2014 INDIANA MECHANICAL CODE

2009 NATIONAL ELECTRIC CODE OF INDIANA

2014 INDIANA BUILDING CODE

2014 INDIANA FIRE CODE

ICC ANSI 117.1-2009

SHEET INDEX

SHEET #

CIVIL

C-1

C-2

C-3

SL-1

STRUCTURAL S-1

S-1.1

S-2

S-3

ARCHITECTURAL

A-2.2

A-3

A-3.1

A-4

A-4.1

A-9

A-10

A-11

EQ-1

M-1

M-3

M-4

M-5

M-6

M-7

M-8

P-1

P-1.1

P-2

E-1

E-2

E-3

MPE

SHEET TITLE

COVER SHEET

ada standards

DEMO SITE PLAN

SITE DETAILS

SITE ELECTRICAL GRADING PLAN

PROPOSED SITE PLAN

DRAINAGE AREA MAP

SOIL EROSION SITE PLAN LANDSCAPE PLAN

SITE LIGHTING (BY OTHERS)

ROOF FRAMING PLANS AND DETAILS

STRUCTURAL NOTES AND DETAILS

PROPOSED EXTERIOR ELEVATIONS PROPOSED EXTERIOR ELEVATIONS

PROPOSED RESTROOM ELEVATIONS AND DETAILS

FOUNDATION PLAN

FOUNDATION DETAILS

PROPOSED FLOOR PLAN MISCELLANEOUS DETAILS

EXTERIOR FINISH SCEHDULE

REFLECTED CEILING PLAN

ROOF PLAN AND DETAILS WALL SECTIONS AND DETAILS

REFLECTED CEILING DETAILS

WALL SECTIONS AND DETAILS WALL SECTIONS AND DETAILS

WALL SECTIONS AND DETAILS

EQUIPMENT PLAN

DOOR AND WINDOW SCHEDULE

MANUFACTURERS AND SUPPLIERS

H.V.A.C PLA N AND SCHEDULES ROOF H.V.A.C AND DETAILS

BROILER-OVEN HOOD DRAWINGS

BROILER - OVEN HOOD DRAWINGS

BROILER - OVEN HOOD DRAWINGS

GAYLORD FRYER HOOD DRAWINGS

GAYLORD FRYER HOOD DRAWINGS

METAL - FAB DUCT INSTALLATION

WASTE & GAS PLAN AND RISERS

ELECTRICAL PANELS AND RISERS

MASTER CONTRACTOR PANEL

LIGHTING PLAN

TECHNOLOGY PLAN

POWER PLAN

SANITARY AND GREASY WASTE PLAN & RISER

SANITARY AND GREASY WASTE PLAN & RISER

FRYER HOOD DRAWINGS FRYER HOOD DRAWINGS FRYER HOOD DRAWINGS


BUILDING SECTIONS

TRASH ENCLOSURE DETAILS

TOPO & BOUNDARY BY OTHERS

MAXIMUM OCCUPAI NUMBERS) = 62 50% MALE AND 50% I	•		CUP. CALCULATION OF CH	R SEAT COU	NT
31/75 = .41 =1 WC EA	ACH RESTRO	om. (tabl	E 2902.1)		
31/200 = .16 = 1 LAV	EACH REST	ROOM. (TAI	BLE 2902.1)		
REQUIRED			PROVIDED		
	MEN	WOMEN		MEN	WOME
W.C. (1:75)	1	1	W.C.	1	1
URINAL*	-	_	URINAL	-	-
LAVATORY (1:200)	1	1	LAVATORY	1	1


Checkeq: 2 02.17.2022 AS 3 06.29.2022 AG 4 07.25.2022 AB 5 08.25.2022 JB 18 18 18 18 18 18 18 18 18 18 18 18 18	Date 02.17.2022 06.29.2022 07.25.2022 08.25.2022	2022
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	PROJECT BURGER KING 1440 NAPPANEE ST, ELKHART, IN 46514	SHEET TITLE COVER SHEET
		LE THIS PRINT. USE MENSIONS ONLY.
	TG-2	21668
,	SHEET	4

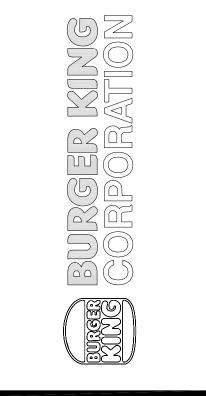

ADAAG/ANSI REQUIREMENTS

1. SIGNAGE MUST BE PROVIDED AT THE DRIVE UP MENU/ORDER INTERCOM INDICATING PICTURE MENUS AVAILABLE UPON REQUEST AT THE PICK-UP WINDOW. 2. PROVIDE PICTURE MENUS AT THE WINDOW AND ORDER COUNTER.

ACCESSIBLE PARKING |

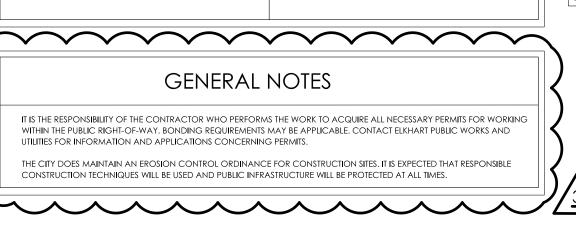1. ALL ACCESSIBLE PARKING SPACES MUST BE WITHIN THE SHORTEST ACCESSIBLE ROUTE TO AN ACCESSIBLE ENTRANCE (36" WIDE MINIMUM AND UNOBSTRUCTED BY CURBS, VEHICLE Overhangs, protruding objects or any other barriers) Adaag 208.3 | Diagram 3.6 2. PARKING MUST INCLUDE A VAN ACCESSIBLE PARKING SPACE WITH AN 8' WIDE MINIMUM ACCESS AISLE PROVIDED OR AN 11' WIDE PARKING SPACE WITH A 5' WIDE ACCESS AISLE. ADAAG 208.2.4, 502.2 | DIAGRAM 3.6

3. MUST PROVIDE A VERTICAL "VAN ACCESSIBLE" SIGN. ADAAG 502.2 | DIAGRAM 3.2 4. ALL VAN SPACES AND THEIR ACCESS AISLES MUST HAVE 98" OF VERTICAL CLEARANCE. ADAAG 502.5 | DIAGRAM 3.5

5. A SECOND VAN ACCESSIBLE PARKING SPACE MUST BE PROVIDED FOR LOTS WITH 26-50 TOTAL PARKING SPACES. ADAAG 208.2 6. EVERY ACCESSIBLE PARKING SPACE MUST BE AT LEAST 8' WIDE WITH THEIR ACCESSIBLE AISLES

AT LEAST 5' WIDE. ADDGA 208.2, 502.3.1 | DIAGRAMS 3.4, 3.5 7. ALL ACCESSIBLE PARKING SPACES MUST HAVE AN AVERAGE SLOPE OF 2% OR LESS IN ANY DIRECTION. ADAAG 502.4

8. ALL ACCESS AISLES MUST HAVE AN AVERAGE SLOPE OF 2% OR LESS IN ANY DIRECTION. ADAAG 502.4

9.ALL ACCESS AISLES MUST BE FREE OF ENCROACHING RAMPS OR CURB RAMPS. ADAAG 502.4 10. ALL ACCESSIBLE PARKING SPACES MUST BE FREE OF ENCROACHING RAMOS OR CURB RAMPS. ADAAG 502.4

11. ALL ACCESSIBLE PARKING SPACES MUST HAVE AN INTERNATIONAL SYMBOL OF ACCESSIBILITY (ISA) VERTICAL SIGNAGE. ADAAG 502.6 10. EVERY VERTICAL SIGN WITH THE ISA MUST BE POSTED 60" MEASURED FROM THE PARKING SURFACE TO THE BOTTOM OF THE SIGN AT EACH SPACE. ADAAG 502.6 | DIAGRAM 3.4

12. STRIPES MUST BE PAINTED ON EACH ACCESS AISLE TO DISCOURAGE PARKING IN THAT SPACE ADAAG 502.3.3 | DIAGRAM 3.5 13. A CURB OR TIRE STOP MUST BE PROVIDED AT EACH PARKING SPACE TO AVOID NARROWING A REQUIRED ACCESSIBLE ROUTE. ADAAG 403.5.1 | DIAGRAM 3.4

EXTERIOR ACCESSIBLE ROUTES |

1. ALL CROSSWALKS MUST BE DESIGNATED WITH PAINTED STRIPES OR DIFFERENT SURFACE MATERIAL. ADAAG 502.3

2.ACCESSIBLE ROUTES ARE REQUIRED TO BE FREE OF ABRUPT CHANGES IN LEVEL GREATER THAN 1/4" IN HEIGHT. ADAAG 206.2.1, 206.2.2, 403.4, 303. ANSI 302.1 3. ACCESSIBLE ROUTES ARE REQUIRED TO TO BE FREE OF GAPS GREATER THAN 1/2" WIDE. ADAAG 206.2.1, 206.2.2, 403.2, 302.3. ANSI 303.2

4. ALL ACCESSIBLE ROUTES MUST HAVE RUNNING SLOPES OF 5% OR LESS 5.ALL ACCESSIBLE PATHS TO BE AN AVERAGE SLOPE OF 2% OR LESS IN ANY DIRECTION. ADDGA 206.2.1/206.2.2 ANSI 403.3

6. ALL PEDESTRIAN PATHS ARE REQUIRED TO BE FREE OF OBJECTS PROTRUDING MORE THAN 4" (12" IF POST MOUNTED SUCH AS SIGNAGE) HORIZONTALLY, BETWEEN 17" AND 80" HIGH. ADAAG 307.2. ANSI 307.2, 307.3 | DIAGRAM 2.3 7. 80" HIGH MINIMUM HEAD CLEARANCE IS REQUIRED ALONG ALL PEDESTRIAN PATHS. ADAAG 307.4 ANSI 307.4 | DIAGRAM 2.4

8. THE EDGE BETWEEN ALL PEDESTRIAN PATHS AND VEHICULAR WAYS MUST BE IDENTIFIED BY A CHANGE IN LEVEL (CURBS) OR TRUNCATED DOME DETECTABLE WARNINGS. | DIAGRAM 2.1

. THE PUBLIC PAY PHONE MUST BE ON AN ACCESSIBLE ROUTE WITH A 30" BY 48" MINIMUM CLEAR FLOOR SPACE. ADAAG 704.2.1 2. AT LEAST ONE PHONE AT THIS LOCATION MUST CONTAIN A VOLUME CONTROL AND MUST BE

MARKED BY THE VOLUME CONTROL SYMBOL. ADAAG 704.3, 703.7.2.3 3. THE HIGHEST OPERABLE PART OF THE LOWEST PHONE MUST 48" OR LESS AFF. ADDGA 305 4. THE HANDSET CORD MUST BE AT LEAST 29" IN LENGTH. ADAAG 704.2.4

ACCESSIBLE CURB RAMPS | . SMOOTH TRANSITION BETWEEN THE ROAD AND EVERY CURB RAMP IS REQUIRED. ADAAG 406.2

ANSI 405.9.2 2. THE SLOPE OF EVERY ADJOINING GUTTER OR ROAD SURFACE MUST BE 5% OR LESS. ADAAG

3. EVERY CURB RAMP MUST A MINIMUM OF 36" WIDE. ADAAG 406.1 | DIAGRAM 3.8 4. EVERY CURB RAMP FRONT TO BACK MUST SLOPE 8.3% OR LESS. ADAAG 406.1,405.2 DIAGRAM 3.13

5. ALL CURB RAMP FLARES MUST SLOPE 10% OR LESS. ADAAG 406.3 | DIAGRAM 3.14 6. DETECTABLE WARNING (TRUNCATED DOMES) MUST BE PROVIDED AT EVERY CURB RAMP. 7. DETECTABLE WARNINGS ON CURB RAMPS MUST CONTRAST VISUALLY WITH THE ADJOINING SURFACES. ADAAG 705.1 ANSI 406.14

8. LEVEL LANDINGS (2% OR LESS SLOPE IN ANY DIRECTION) 36 INCHES DEEP MINIMUM BY 36" WIDE MUST BE AT THE TOP OF EACH CURB RAMP. ADAAG 406.4 | DIAGRAM 3.13

RAMPS |

 EVERY PORTION OF ROUTE MUST HAVE HANDRAILS ON BOTH SIDES WITH SLOPES GREATER THAN 5% AND A RISE OF MORE THAN 6". ADAAG 405.8, 505 2. ALL PORTIONS OF ANY ACCESSIBLE RAMPS MUST HAVE RUNNING SLOPES OF 8.3% OR LESS. ADAAG 405.2

3. ALL CROSS SLOPES MUST BE 2% OR LESS. ADAAG 405.3 4. THE CLEAR WIDTH OF EVERY RAMPED SECTION MUST BE AT LEAST 36". ADAAG 405.5

DIAGRAM 3.9 5. THERE MUST BE A 5' LONG LANDING PROVIDED AT THE TOP AND BOTTOM OF EACH RAMPED SECTION. ADAAG 405.7 | DIAGRAM 3.9

6. ALL LANDINGS MUST BE AT LEAST AS WIDE AS THE RAMPED SECTION LEADING TO THEM. ADAAG 405.7 I DIAGRAM 3.9

7. AN INTERMEDIATE LANDING OF AT LEAST 5' IN LENGTH MUST BE PROVIDED WHEREVER THE RISE IS MORE THAN 30". ADAAG 405.6, 405.7 | DIAGRAM 3.9 8. ALL LANDINGS WHERE A CHANGE IN DIRECTION OCCURS MUST BE AT LEAT 60" DEEP BY 60"

WIDE. ADAAG 405.7 | DIAGRAM 3.10 9. ALL LANDINGS MUST BE SLOPED 2% OR LESS. ADAAG 405.7.1, 302 10. A 12" MINIMUM EXTENDED GROUND SURFACE OR 4" HIGH EDGE PROTECTION MUST BE PROVIDED ALONG EACH SIDE OF EVERY RAMP SECTION. ADAAG 405.9 11. ALL HANDRAILS MUST BE LOCATED 34"-38" AFF AND MUST BE 1-1/4" TO 1-1/2" IN DIAMETER.

ADAAG 405.8, 505 | DIAGRAM 3.12 12. EACH HANDRAIL MUST HAVE A 12" MINIMUM HORIZONTAL EXTENSION AT THE TOP AND BOTTOM OF EACH RAMP SECTION. ADAAG 405.8, 505 | DIAGRAM 3.12

. PUBLIC SIDEWALK OR RIGHT OF WAY TO ENTRY DOORS MUST HAVE A 36" WIDE MINIMUM UNOBSTRUCTED ACCESSIBLE ROUTE. ADAAG 206.4 | DIAGRAM 3.11 2.ENTRY DOOR IS REQUIRED TO HAVE ISA DECAL AND IF IT IS NOT ACCESSIBLE IT MUST HAVE DIRECTIONAL SIGNAGE INDICATING THE CLOSEST ACCESSIBLE ENTRANCE. ADAAG 216.6, 703.5 ANSI 703.2.9

3. ALL OPENING HARDWARE IS TO BE OPERATED WITH A CLOSED FIST. ADAAG 404.2.7 ANSI 404.2.6 | DIAGRAM 2.3 4. THE OPERABLE PORTION OF ALL PUBLIC USE DOOR HARDWARE MUST BE LOCATED BETWEEN 34"

AND 48" AFF. ADAAG 404.2.7 5. DOOR CLOSING SPEED IS TO BE 5 SECONDS OR MORE FROM 90 DEGREES TO 12 DEGREES FROM THE LATCH FOR ALL LEAVES OF THIS DOORWAY. ADAAG 404.2.8.1 ANSI 404.2.7.1

6. THE CLEAR WIDTH OF AT LEAST ONE SINGLE LEAF MUST BE 32" MINIMUM. ADAAG 404.2.3, 404.2.3 | FIGURE 404.2.4 7. THRESHOLD HEIGHT HEIGHT MAY NOT EXCEED 1/2" MAXIMUM. ADAAG 404.2.5 ANSI 404.2.4 8. ENTRY THRESHOLDS MUST NOT HAVE ABRUPT PORTIONS THAT ARE 1/4" HIGH MAXIMUM.

ADAAG 404.2.5 ANSI 404.2.4 9. THE ENTRY THRESHOLD MUST HAVE A 1:2 MAXIMUM BEVEL FOR ANY PORTION THAT IS MORE THAN 1/4" HIGH. ADAAG 404.2.5. ANSI 303.3

10. THERE MUST BE A 10" HIGH SMOOTH PANEL OR KICK PLATE LOCATED ON THE BASE OF THE RUSH SIDE OF ALL LEAVES OF THE DOORWAY. ADAAG 404.2.10 11. REQUIRED MANEUVERING SPACE IS REQUIRED ON EACH SIDE OF THE DOOR SLOPED 2% OR

LESS IN ALL DIRECTIONS. ADAAG 404.2.4 ANSI 404.2.3.5

. THERE MUST BE A 60" LONG BY 60" WIDE MINIMUM TURNING SPACE AT EVERY TURN IN THE AISLE PATH OR IF THE PATH IS AT LEAST 42" WIDE, THE DEPTH OF THE TURN MUST BE AT LEAST 48". ADAAG 304.3,403.5.2 | DIAGRAM 4.10 2. THE NARROWEST CLEAR WIDTH BETWEEN THE BARRIERS MUST BE A MINIMUM OF 36". 403.5.1

3. QUEUING AISLE SEPARATION BARRIERS MUST HAVE DETECTABLE ELEMENTS. ADAAG 307.2 | DIAGRAM 4.9

ADAAG/ANSI REQUIREMENTS

THE HEIGHT OF THE ACCESSIBLE ORDER COUNTER SHALL NOT EXCEED 34" MAXIMUM. ADAAG 902.3. (PREFERRED 33 1/2") ANSI 904.4.2 | DIAGRAM 4.13 2. THE WIDTH OF THE ACCESSIBLE ORDER COUNTER SHALL NOT BE LESS THAN 36" MINIMUM.

ADAAG 902.3 ANSI 904.3 | DIAGRAM 4.13 3. THE HEIGHT OF THE ACCESSIBLE PICK-UP COUNTER SHALL NOT EXCEED 34" MAXIMUM. ADAAG 902.3 ANSI 904.4.2 | DIAGRAM 4.13

4. THE WIDTH OF THE ACCESSIBLE PICK-UP COUNTER SHALL NOT BE LESS THAN 36" MINIMUM. ADAAG 902.3 ANSI 904.3 | DIARGRAM 4.13

5. THE CREDIT CARD READER SHALL BE IN REACH OR ON A CORD LONG ENOUGH TO REACH THE LAP OF A CUSTOMER WHO USES A WHEELCHAIR. ADAAG 308 ANSI 902.3 6. THE SIGNATURE PAD WRITING SURFACE IS REQUIRED TO BE 34" AFF MAXIMUM OR ON A CORD LONG ENOUGH TO REACH THE LAP OF A CUSTOMER WHOSE USES A WHEELCHAIR. ADAAG 902.4

SELF SERVICE CONDIMENTS AND DRINKS COUNTER |

. IT IS REQUIRED TO HAVE AT LEAST ONE OF EACH CONTAINER, UTENSIL OR CONDIMENT LOCATED WITHIN 48" MAXIMUM AFF OR 46" MAXIMUM AFF FOR DEPTHS FROM 10" TO 24". ADAAG 308 | DIAGRAM 4.12, DIAGRAM 4.12

ANSI 308 2. IT IS REQUIRED TO HAVE AT LEAST ONE OF EACH TYPE OF DRINK DISPENSER LOCATED WITHIN 48" MAXIMUM AFF OR 46"MAXIMUM AFF FOR DEPTHS FROM 10" TO 24". ADAAG 308 ANSI 308 | DIAGRAM 4.12, DIAGRAM 4.12

3. THE TOP OF EACH SELF SERVICE COUNTER OR TRAY SLIDE IS NOT TO EXCEED 34" MAXIMUM AFF. ADAAG 902.3. (PREFERRED 33 1/2") ANSI 904.5.2 | DIAGRAM 4.13 4. THE CONTROL OF EVERY DISPENSER IS REQUIRED TO BE OPERABLE WITH A CLOSED FIST OR FLAIL HAND. ADAAG 309.4 ANSI 309.4 | DIAGRAM 2.3

INTERIOR ACCESSIBLE SEATING AND TABLES

. 5% OF THE SEATING POSITIONS IN EACH AREA MUST BE ACCESSIBLE. ADAAG 226.1 2. IT IS REQUIRED TO HAVE A 36" WIDE MINIMUM ACCESSIBLE ROUTE SERVING EVERY ACCESSIBLE SEATING LOCATION. ADAAG 403 ANSI 403

3. THE HEIGHT OF THE TABLE TOP IS REQUIRED TO BE BETWEEN 28" AND 34" MAXIMUM AT EVERY ACCESSIBLE SEATING POSITION. ADAAG 902.3 ANSI 902.3 | DIAGRAM 2.2 4. KNEE CLEARANCE OF 27" HIGH BY 30" WIDE BY 17" DEEP IS TO BE PROVIDED AT EVERY

ACCESSIBLE SEATING POSITION. ADAAG 902.2 ANSI 902.2 | DIAGRAM 2.2 5. THE DINING AREA MUST HAVE AN AUDIBLE PUBLIC ALARM AND A VISUAL FIRE ALARM. ADAAG

EXTERIOR ACCESSIBLE SEATING AND TABLES

. 5% OF THE SEATING POSITIONS IN EACH AREA MUST BE ACCESSIBLE. ADAAG 226.1 2. IT IS REQUIRED TO HAVE A 36" WIDE MINIMUM ACCESSIBLE ROUTE SERVING EVERY ACCESSIBLE SEATING LOCATION. ADAAG 403 ANSI 403 3. THE HEIGHT OF THE TABLE TOP IS REQUIRED TO BE BETWEEN 28" AND 34" MAXIMUM AT EVERY ACCESSIBLE SEATING POSITION. ADAAG 902.3 ANSI 902.3 | DIAGRAM 2.2

ACCESSIBLE SEATING POSITION. ADAAG 902.2 ANSI 902.2 | DIAGRAM 2.2 5. THE DINING AREA MUST HAVE AN AUDIBLE PUBLIC ALARM AND A VISUAL FIRE ALARM. ADAAG

4. KNEE CLEARANCE OF 27" HIGH BY 30" WIDE BY 17" DEEP IS TO BE PROVIDED AT EVERY

INTERIOR ACCESSIBLE ROUTES AND ELEMENTS

. THERE MUST BE A 36" WIDE ACCESSIBLE ROUTE CONNECTING THE ACCESSIBLE ENTRY/ENTRANCES WITH ALL ACCESSIBLE SPACES AND ELEMENTS WITHIN THE FACILITY INCLUDING SERVING AND CONDIMENT COUNTERS, DINING AREAS, RESTROOMS AND PLAYGROUNDS IF AVAILABLE. ADAAG 206.2.4, 402

206.2.4, 302.1, ANSI 302.1 3. ACCESSIBLE ROUTES ARE REQUIRED TO BE FREE OF ABRUPT CHANGES IN LEVEL GREATER THAN 1/4" IN HEIGHT. ADAAG 206.2.4, 403.4, 303, ANSI 303.2,

2.ALL ACCESSIBLE ROUTES ARE REQUIRED TO BE STABLE, FIRM AND SLIP RESISTANT. ADAAG

4. ACCESSIBLE ROUTES ARE REQUIRED TO BE FREE OF GAPS GREATER THAN 1/2" WIDE. ADAAG 206.2.4, 403.2, 302.3, ANSI 302.3. 5. ACCESSIBLE ROUTES ARE TO HAVE RUNNING SLOPES 5% OR LESS. ADAAG 206.2.4, 403.3, ANSI

6. ACCESSIBLE ROUTES ARE TO HAVE CROSS SLOPES 2% OR LESS. ADAAG 206.2.4, 403.3 ANSI

INTERIOR STAIRS

. ANY STAIRS PART OF MEANS OF EGRESS MUST HAVE RISERS THAT ARE 4" MINIMUM TO 7" HIGH MAXIMUM. ADAAG 210

2. ALL STAIR TREADS MUST BE 11" MINIMUM IN DEPTH. ADAAG 504.02 3. ALL RISERS MUST BE CLOSED. 504.3

4. ALL NOSING MUST BE FREE OF PROTRUSIONS AND MUST BE EITHER FLUSH, SMOOTH OR BEVELED. ADAAG 504.5 5. HANDRAILS MUST BE PROVIDED ON BOTH SIDES OF THE STAIRS AND MUST BE LOCATED 34" TO 38" AFF AND HAVE A CLEARANCE OF 1-1/2" MINIMUM FROM THE VERTICAL SURFCE. ADAAG

6. ALL HANDRAIS MUST HAVE 12" MINIMUM OF EXTENSIONS AT BOTH THE TOP AND THE BOTTOM OF THE STAIRWAY. ADAAG 505.1

PROTRUDING OBJECTS |

ALL PEDESTRIAN PATHS ARE TO BE FREE OF OBJECTS PROTRUDING MORE THAN 4" (12" IF POST MOUNTED SUCH AS SIGNAGE) HORIZONTALLY, BETWEEN 27" AND 80" HIGH. ADAAG 307.2 ANSI 307.3 | DIAGRAM 2.4 2. IT IS REQUIRED TO HAVE 80" MINIMUM HEAD CLEARANCE ALONG ALL PEDESTRIAN PATHS. ADAAG 307.4 ANSI 307.4 | DIAGRAM 2.4

. THERE MUST BE AT LEAST ONE ACCESSIBLE ENTRANCE AND ONE EXESSIBLE EXIT TO THE SOFT CONTAINED PLAY STRUCTURE (CAN BE THE SAME). ADAAG 1008.2.4.1 2. IF THERE ARE 4 OR MORE ENTRANCES TO THE SOFT CONTAINED PLAY STRUCTURE THERE MUST BE AT LEAST 2 ENTRANCES THAT ARE ACCESSIBLE. ADAAG 206.2.17.2,1008.2.4

3. THERE MUST BE A 60" MINIMUM WIDTH ACCESSIBLE ROUTE FROM THE ENTRY OF THE PLAY AREA TO EACH REQUIRED ENTRY AND EXIT OF THE SOFT CONTAINED PLAY STRUCTURE. ADAAG 1008.2.4 4. AN 80" HIGH MINIMUM HEAD CLEARANCE MUST BE PROVIDED ALONG ALL ACCESSIBLE ROUTES WITHIN THE PLAY AREA. ADAAG 1008.2

5. ALL ACCESSIBLE ROUTES MUST HAVE COMPLIANT LEVEL CHANGE AND EDGE TRANSITION CONDITIONS. 403.4, 405.2

6. THERE MUST BE A 60" DIAMETER OR T-TURN SPACE PROVIDED AT EACH ACCESSIBLE ENTRY TO THE SIFT CONTAINED PLAY STRUCTURE. ADAAG 1008.2.4.1, 304.3 | DIAGRAM 4.8 7. A TRANSFER PLATFORM MUST BE PROVIDED AT EACH ACCESSIBLE ENTRY AND EXIT OF THE SOFT CONTAINED PLAY STRUCTURE AND MUST BE AT LEAST 14" DEEP AND 24" WIDE AND LOCATED BETWEEN 11" AND 18" AFF. ADAAG 1008.2.2, 1008.3.1.1, 1008.3.1.2

8. THERE MUST BE A 30"X48" CLEAR FLOOR SPACE CENTERED (ALONG THE LONG SIDE) OF EACH TRANSFER PLATFORM. ADAAG 1008.3.1.3 9. AT LEAST ONE MEANS OF SUPPORT (HANDRAIL OR GRIPPING SURFACE) MUST BE PROVIDED AT

EVERY TRANSFER PLATFORM. ADAAG 1008.3.1.4, 1008.3.2.3 10. ALL ACCESSIBLE ROUTES MUST HAVE A SLOPE OF 1:16 (6.2%) MAXIMUM. ADAAG 1008.2.5.1 1. THE MANUFACTURER MUST PROVIDE PROOF OF ADA COMPLIANCE FOR ALL TRADITIONAL NON-CONTAINED COMPOSITE STRUCTURES AND ANY FREE-STANDING PLAY EQUIPMENT. ADAAG 240.2

GAMES/KIOSK/VENDING | . ALL SELF SERVICE KIOSKS, VENDING MACHINES OR FREE STANDING GAME UNITS MUST BE ON AN ACCESSIBLE ROUTE WITH A 30"X48" MINIMUM CLEAR FLOOR SPACE. ADAAG 305.3 2. ALL CONTROLS AND OPERATING ELEMENTS MUST BE LOCATED WITHIN 48 " MAXIMUM AFF OR 46" MAXIMUM AFF FOR DEPTH FROM 10" TO 24". ADAAG 308 3. ALL CONTROLS OR OPERATING ELEMENTS MUST BE OPERABLE WITH A CLOSED FIST OR FLAIL

HAND WITH 5LBS OR LESS OF FORCE. ADAAG 309.4 | DIAGRAM 2.3

ADAAG/ANSI REQUIREMENTS

. A SIGN MUST BE LOCATED OUT OF THE SWING OF ANY DOOR AT THE LATCH SIDE OF THE RESTROOM DOOR. ADAAG 703.4.2 ANSI 703.3.11 | DIAGRAM 4.6 2. THE RESTROOM SIGN MUST HAVE TACTILE CHARACTERS THAT ARE RAISED AT LEAST 1/32% . ADAAG 703.2.1 ANSI 703.2.4, 703.2.9 | DIAGRAM 4.6

3. THE RESTROOM SIGN MUST HAVE TACTILE CHARACTERS WITH HEIGHT BETWEEN 5/8" AND 2" ADAAG 703.2.5 ANSI 703.2.4 TABLE 703.2.4 | DIAGRAM 4.6

4. THE RESTROOM SIGN WILL HAVE THE LOWEST TACTILE CHARACTER 48" MIN. AND THE BASELINE OF THE HIGHEST TACTILE CHARACTER 60" MAX. ADAAG 703.4.1 ANSI 703.3.10 | DIAGRAM 4.6 5. THE RESTROOM SIGN MUST HAVE BRAILLE. ADAAG 703.3 ANSI 703.3, 703.4 | DIAGRAM 4.6 6. THE RESTROOM SIGN MUST BE NON GLARE AND THE CHARACTERS MUST CONTRAST WITH THE BACKGROUND. ADAAG 703.5.1 ANSI 703.5.3 | DIAGRAM 4.6

7. THE FLOOR SURFACES IN THE RESTROOM CANNOT BE SLOPED GREATER THAN 2% IN ALL DIRECTIONS WITH NO ABRUPT CHANGE IN LEVEL GREATER THAN $\frac{1}{4}$ " HIGH AND NO GAPS GREATER THAN ½" WIDE. ADAAG 206.2.4, 302.3, 303, 403.2, 403.3, 403.4, ANSI 302.2, 303.3, 403.3 8. THERE MUST BE A 60" DIAMETER OR A T-TURN TURNING SPACE PROVIDED IN THE RESTROOM. ADAAG 304.3 | DIAGRAM 4.8

9. THERE MUST BE AN AUDIBLE AND VISUAL PUBLIC ALARM. ADAAG 702

. ALL OPENING HARDWARE CAN BE OPERATED WITH A CLOSED FIST OR A FLAIL HAND AND MUST BE LOCATED BETWEEN 34" AND 48" AFF. ADAAG 404.2.7 ANSI 404.2.6 | DIAGRAM 2.5 2. OPENING FORCE FOR ALL ACCESSIBLE INTERIOR AND EXTERIOR DOORS WILL NOT EXCEED 5 LBI ADAAG 404.2.9 ANSI 404.2.8

3. DOOR CLOSING SPEED WILL BE 5 SECONDS OR MORE FROM 90 DEGREES TO 12 DEGREES FROM THE LATCH FOR ALL LEAVES OF THIS DOORWAY. ADAAG 404.2.8.1 ANSI 404.2.7.1 4. THE CLEAR WIDTH OF THE DOOR MUST BE A MINIMUM OF 32". ADAAG 404.2.3 | 404.2.4 5. THRESHOLDS FOR DOORS WILL NOT HAVE AN OVERALL HEIGHT GREATER THAN $\frac{1}{2}$ " MAX, OR

HAVE ABRUPT PORTIONS THAT ARE $\frac{1}{4}$ " HIGH MAX. THE THRESHOLD MAY HAVE A 1:2 MAX BEVEL FOR ANY PORTION THAT IS GREATER THAN ½" HIGH. ADAAG 404.2.5 ANSI 404.2.4 6. DOORS MUST HAVE A 10" HIGH SMOOTH SURFACE OR KICK PLATE LOCATED ON THE BASE OF THE PUSH SIDE OF ALL LEAVES OF THE DOORWAY. ADAAG 404.2.10 7. ALL DOORS MUST HAVE PULL AND PUSH SIDE MANEUVERING SPACES THAT COMPLY WITH

FIGURE 404.2.4 8. THE REQUIRED MANEUVERING SPACES ON EACH SIDE OF THE DOOR MAY BE SLOPED 2% OR LESS IN ALL DIRECTIONS. ADAAG 404.2.4 ANSI 303.2

MEN'S LAVATORY . THE TOP OF THE ACCESSIBLE LAVATORY MUST BE BETWEEN 28" TO 34" HIGH. ADAAG 213.3.4, 606.2, 606.3 | DIAGRAM 4.3 2. THERE MUST BE A 27" HIGH BY 30" WIDE BY 8" DEEP MINIMUM KNEE CLEARANCE UNDER THE

LAVATORY ALONG WITH A 9" HIGH BY 30" WIDE BY 17" DEEP MINIMUM TOE CLEARANCE. ADAAG 213.3.4, 305.4, 306, 606.2 | DIAGRAM 4.3 3. ALL ACCESSIBLE LAVATORY PIPES MUST BE INSULATED OR OTHERWISE PROTECTED FROM

CONTACT. ADAAG 213.3.4, 606.5 ANSI 606.6 4. THE FAUCET HARDWARE AT THE ACCESSIBLE LAVATORY MUST BE AUTOMATIC OR OPERABLE WITH A CLOSED FIST OR FLAIL HAND. ADAAG 213.3.4, 606.4 ANSI 606.4 | DIAGRAM 2.3 5. A MIRROR MUST BE PROVIDED THAT HAS A BOTTOM REFLECTING EDGE LOCATED A MAXIMUM OF 40" HIGH.

. IF THERE IS A CUSTOMER USE LIGHT SWITCH, IT MUST BE MAXIMUM 48" IN AN ACCESSIBLE LOCATION. ADAAG 205.1, 308, 309.3 2. THERE MUST BE AT LEAST ONE TYPE OF EACH DISPENSER ON AN ACCESSIBLE ROUTE WITH A 30"X48" MINIMUM CLEAR FLOOR SPACE AND MUST BE MOUNTED WITH CONTROLS 48" MAXIMUM

AFF. ADAAG 305.3, 308 3. THE DIAPER CHANGING STATION MUST BE ON AN ACCESSIBLE ROUTE WITH AN ACCESSIBLE CLEAR FLOOR SPACE. ADAAG 305, 902.1, 902.2 ANSI 308 4. THE DIAPER CHANGING PULL DOWN HANDLE AND ALL OTHER OPERABLE CONTROLS MUST BE LOCATED AT A MAXIMUM OF 48" HIGH AND THE SURFACE MUST BE A MAXIMUM OF 28"TO34" HIGH

WHEN OPENED. 305, 902.1, 902.3 5. THE KNEE CLEARANCE FOR THE DIAPER CHANGING STATION (WHEN OPEN) MUST PROVIDE FOR 27". 306, 902.1, 902.2

6. ACCESSIBLE DISPENSERS MUST BE OPERABLE WITHOUT PINCHING, GRASPING OR TWISTING OF THE WRIST AND REQUIRE 5 LBF OR LESS TO OPERATE. ADAAG 205, 309.4 ANSI 309.4

MEN'S TOILET |

ADAAG 604.8.2.2

MINIMUM FROM THE REAR WALL. ADAAG 604.8.2.3

. THERE MUST ACCESSIBLE TOILET SEAT LOCATED 17" TO 19" AFF AND CENTERED 16" TO 18" FROM SIDEWALL. ADAAG 604.4, 604.2 | DIAGRAM 4.7 2. THE TOILET FLUSH CONTROL MUST BE AUTOMATIC OR LOCATED ON THE OPEN SIDE OF THE

TOILET. ADAAG 604.6 | DIAGRAM 4.7 3. A HORIZONTAL REAR WALL GRAB BAR MUST BE PROVIDED THAT IS 1 ½" TO ½" IN DIAMETER. 36" LONG MIN, EXTENDING 12" MIN FROM THE TOILET CENTERLINE TOWARDS THE NEAR SIDE WALL, CENTERED 33" TO 36" ABOVE THE FLOOR TO THE TOP OF THE GRIPPING SURFACE AND WITH NO OBSTRUCTIONS WITHIN 12" ABOVE OR 1 ½" BELOW THE BAR. ADAAG 604.5.2, 609 ANSI 604.1,

604.5.2, 609 | DIAGRAM 4.1 4. THE URINALS FLUSH CONTROL MUST BE AUTOMATIC OR 48" HIGH MAX AND BE OPERABLE WITH NO MORE THAN 5LBF OF PRESSURE. ADAAG 605.4 ANSI 604.6 | DIAGRAM 4.4 5.GRAB BARS AT THE SIDE SHALL BE AT LEAST 42" LONG POSITIONED NO MORE THAN 12" FROM THE REAR WALL. GRAB BARS AT THE BACK SHALL BE NOT LESS THAN 36" LONG. VERTICAL GRAB BARS TO BE 18" IN LENGTH AND 39-41" AFF AND 39-41" FROM REAR WALL (IBC 1607.7 & ANSI 604.8.4.1) (ICC/ANSI A117.1-2003 FIG. 604.5.1) ANSI 604.5.1, 609.4 | DIAGRAM 4.1

6. THE CENTERLINE OF THE TOILET COVER DISPENSER MUST BE LOCATED 7" TO 9" FROM THE FRONT OF THE CLOSET AND AT LEAST 1-1/2" BELOW THE SIDE WALL GRAB BAR OR AT LEAST 12" ABOVE THE GRAB BAR. IT ALSO MUST BE LOCATED 15" TO 48" MAXIMUM ABOVE THE FLOOR. ADAAG 604.7, 609.3 | DIAGRAM 4.7 7. IF THE ACCESSIBLE WATER CLOSET IS IN A COMPARTMENT, IT MUST HAVE AT LEAST 60" MINIMUM

CLEARANCE MEASURED PERPENDICULAR FROM THE SIDE WALL PROVIDED. ADAAG 604.3 | DIAGRAM 4.7 8. WATER CLOSET MUST ALSO HAVE 56 MINIMUM CLEARANCE MEASURED FROM THE REAR WALL AND HAVE A WIDTH OF A MINIMUM OF 60". ADAAG 604.8.1.1 | DIAGRAM 4.7

9. IF THE WATER CLOSET IS WALL-HUNG, THE DEPTH OF THE COMPARTMENT MUST BE A MINIMUM OF 56". ADAAG 604.8.1.1 10. IF THE WATER CLOSET IS FLOOR-MOUNTED, THE COMPARTMENT MUST HAVE A DEPTH OF AT LEAST 59". ADAAG 604.8.1.1 | DIAGRAM 4.2

1. THE COMPARTMENT MUST PROVIDE AT LEAST 6" DEEP MINIMUM SPACE AT THE FRONT OF THE COMPARTMENT AND ONE OTHER SIDE. ADAAG 604.8.1.1 | DIAGRAM 4.8 12. IF THE TOILET COMPARTMENT IS SELF-CLOSING, PROVIDE A CLEAR OPENING WIDTH OF AT

LEAST 32" AND WITHIN 4" OF THE COMPARTMENT CORNER DIAGONALLY OPPOSITE THE TOILET. ADAAG 604.8.1.2 | DIAGRAM 4.7 13. ALL ACCESSIBLE TOILET COMPARTMENT DOOR HARDWARE MUST BE CENTERED BETWEEN 34" AND 48" AFF. ADAAG 404.2.7 | DIAGRAM 2.3

14. IF THE ACCESSIBLE COMPARTMENT DOOR IS OUT-SWINGING, THE EXTERIOR MANEUVERING SPACES MUST BE COMPLIANT WITH FIGURE 404.2.4 ADAAG 604.8.1.2 | FIGURE 404.2.4 15. ALL ACCESSIBLE COMPARTMENT DOOR HARDWARE MUST BE OPERABLE WITH A FIST OR FLAIL HAND. ADAAG 604.8.1.2, 404.2.7 | DIAGRAM 2.3

16. THE INSIDE AND OUTSIDE OF THE ACCESSIBLE COMPARTMENT DOOR MUST BE EQUIPPED WITHA LOOP OR U-SHAPED HANDLE. ADAAG 604.8.1.2 17. AT LEAST ONE OF EACH HOOK AND DISPENSER IN THE ACACESSIBLE COMPARTMENT MUST BE AT 48" MAXIMUM AFF. ADAAG 213.3.7, 603.4, 604.8.3, 308

18. COMPARTMENT DOOR OPENINGS SHALL BE 4 INCHES (100MM) MAXIMUM FROM THE FRONT PARTITION. WHERE LOCATED IN THE FRONT PARTITION, THE DOOR OPENING SHALL BE 4 INCHES MAXIMUM FROM THE SIDE WALL OR PARTITION FARTHEST FROM THE WATER CLOSET. | DIAGRAM

THE LIP OF ONE URINAL MUST BE AT A MAXIMUM OF 17" HIGH. ADAAG 605.2 | DIAGRAM 4.4 2. THE CLEAR FLOOR SPACES AT THAT SAME URINAL MUST BE 30" WIDE (30" WIDE MINIMUM IF IN AN ALCOVE OVER 24" DEEP). ADAAG 605.3 | DIAGRAM 4.4 3. THE LIP OF THE URINAL MUST EXTEND AT LEAT 13-1/2" FROM THE REAR WALL. ADAAG 605.2

DIAGRAM 4.4 4. THE URINAL'S FLUSH CONTROL MUST BE AUTOMATIC OR AT A MAXIMUM OF 48" HIGH AND OPERABLE WITH NO MORE THAN 5LBS OF PRESSURE. ADAAG 605.4 | DIAGRAM 4.4

MEN'S AMBULATORY COMPARTMENT . IF THERE ARE 6 OR MORE TOILET COMPARTMENTS AND URINALS COMBINED AN AMBULATORY COMPARTMENT MUST BE PROVIDED THAT IS 35" TO 37" WIDE AND AT LEAST 60" LONG. ADAAG 213.3.1, 604.8.2.1 2. THE COMPARTMENT DOOR MUST PROVIDE AT LEAST 32" OF CLEAR OPENING WIDTH AND

3. ALL HARDWARE MUST BE OPERABLE WITH A CLOSED FIST AND MUST BE CENTERED BETWEEN 34" AND 48" AFF. ADAAG 404.2.7 4. THE TOILET MUST BE CENTERED 17-19" FROM THE SIDE WALL. ADAAG 604.2 5. THERE MUST BE 2 HORIZONTAL SIDEWALL GRAB BARS PROVIDED IN THE AMBULATORY COMPARTMENT THAT ARE 1-1/4" TO 1-1/2" IN DIAMETER, 42" LONG MINIMUM, EXTENDING 54"

ADAAG/ANSI REQUIREMENTS

WOMEN'S OR 2ND SINGLE USER RESTROOM

I. A SIGN MUST BE LOCATED OUT OF THE SWING OF ANY DOOR AT THE LATCH SIDE OF THE RESTROOM DOOR. ADAAG 703.4.2 ANSI 703.3.11 | DIAGRAM 4.6 2. THE RESTROOM SIGN MUST HAVE TACTILE CHARACTERS THAT ARE RAISED AT LEAST $\frac{1}{32}$ ". ADAAG 703.2.1 ANSI 703.2.4, 703.2.9 | DIAGRAM 4.6

3. THE RESTROOM SIGN MUST HAVE TACTILE CHARACTERS WITH HEIGHT BETWEEN $\frac{5}{2}$ " AND 2" ADAAG 703.2.5 ANSI 703.2.4 TABLE 703.2.4 | DIAGRAM 4.6

4. THE RESTROOM SIGN WILL HAVE THE LOWEST TACTILE CHARACTER 48" MIN. AND THE BASELINE OF THE HIGHEST TACTILE CHARACTER 60" MAX. ADAAG 703.4.1 ANSI 703.3.10 | DIAGRAM 4.6 5. THE RESTROOM SIGN MUST HAVE BRAILLE. ADAAG 703.3 ANSI 703.3, 703.4 | DIAGRAM 4.6 6. THE RESTROOM SIGN MUST BE NON GLARE AND THE CHARACTERS MUST CONTRAST WITH THE BACKGROUND. ADAAG 703.5.1 ANSI 703.5.3 | DIAGRAM 4.6

7. THE FLOOR SURFACES IN THE RESTROOM CANNOT BE SLOPED GREATER THAN 2% IN ALL DIRECTIONS WITH NO ABRUPT CHANGE IN LEVEL GREATER THAN $\frac{1}{4}$ " HIGH AND NO GAPS GREATER THAN ½" WIDE. ADAAG 206.2.4, 302.3, 303, 403.2, 403.3, 403.4, ANSI 302.2, 303.3,

8. THERE MUST BE A 60" DIAMETER OR A T-TURN TURNING SPACE PROVIDED IN THE RESTROOM. ADAAG 304.3 | DIAGRAM 4.8 9. THERE MUST BE AN AUDIBLE AND VISUAL PUBLIC ALARM. ADAAG 702

WOMEN'S ENTRY DOOR . ALL OPENING HARDWARE CAN BE OPERATED WITH A CLOSED FIST OR A FLAIL HAND AND MUST BE LOCATED BETWEEN 34" AND 48" AFF. ADAAG 404.2.7 ANSI 404.2.6 | DIAGRAM 2.5 2. OPENING FORCE FOR ALL ACCESSIBLE INTERIOR AND EXTERIOR DOORS WILL NOT EXCEED 5 LBF. ADAAG 404.2.9 ANSI 404.2.8

3. DOOR CLOSING SPEED WILL BE 5 SECONDS OR MORE FROM 90 DEGREES TO 12 DEGREES FROM THE LATCH FOR ALL LEAVES OF THIS DOORWAY. ADAAG 404.2.8.1 ANSI 404.2.7.1 4. THE CLEAR WIDTH OF THE DOOR MUST BE A MINIMUM OF 32". ADAAG 404.2.3, 404.2.3 | FIGURE 404.2.4

5. THRESHOLDS FOR DOORS WILL NOT HAVE AN OVERALL HEIGHT GREATER THAN ½" MAX. OR HAVE ABRUPT PORTIONS THAT ARE $\frac{1}{4}$ " HIGH MAX. THE THRESHOLD MAY HAVE A 1:2 MAX BEVEL FOR ANY PORTION THAT IS GREATER THAN $\frac{1}{4}$ " HIGH. ADAAG 404.2.5 ANSI 404.2.4 6. DOORS MUST HAVE A 10" HIGH SMOOTH SURFACE OR KICK PLATE LOCATED ON THE BASE OF THE PUSH SIDE OF ALL LEAVES OF THE DOORWAY. ADAAG 404.2.10 7. ALL DOORS MUST HAVE PULL AND PUSH SIDE MANEUVERING SPACES THAT COMPLY WITH

FIGURE 404.2.4 8. THE REQUIRED MANEUVERING SPACES ON EACH SIDE OF THE DOOR MAY BE SLOPED 2% OR LESS IN ALL DIRECTIONS. ADAAG 404.2.4 ANSI 303.2

WOMEN'S LAVATORY |

. THE TOP OF THE ACCESSIBLE LAVATORY MUST BE BETWEEN 28" TO 34" HIGH. ADAAG 213.3.4, 606.2, 606.3 | DIAGRAM 4.3 2. THERE MUST BE A 27" HIGH BY 30" WIDE BY 8" DEEP MINIMUM KNEE CLEARANCE UNDER THE LAVATORY ALONG WITH A 9" HIGH BY 30" WIDE BY 17" DEEP MINIMUM TOE CLEARANCE. ADAAG 213.3.4, 305.4, 306, 606.2 | DIAGRAM 4.3

3. ALL ACCESSIBLE LAVATORY PIPES MUST BE INSULATED OR OTHERWISE PROTECTED FROM CONTACT. ADAAG 213.3.4, 606.5 ANSI 606.6

4. THE FAUCET HARDWARE AT THE ACCESSIBLE LAVATORY MUST BE AUTOMATIC OR OPERABLE WITH A CLOSED FIST OR FLAIL HAND. ADAAG 213.3.4, 606.4 ANSI 606.4 | DIAGRAM 2.5 5. A MIRROR MUST BE PROVIDED THAT HAS A BOTTOM REFLECTING EDGE LOCATED A MAXIMUM OF 40" HIGH.

DISPENSERS/ACCESSORIES

. IF THERE IS A CUSTOM USE LIGHT SWITCH, IT MUST BE MAXIMUM 48" IN AN ACCESSIBLE LOCATION. ADAAG 205.1, 308, 309.3

2. THERE MUST BE AT LEAST ONE TYPE OF EACH DISPENSER ON AN ACCESSIBLE ROUTE WITH A 30"X48" MINIMUM CLEAR FLOOR SPACE AND MUST BE MOUNTED WITH CONTROLS 48" MAXIMUM AFF. ADAAG 305.3, 308

3. THE DIAPER CHANGING STATION MUST BE ON AN ACCESSIBLE ROUTE WITH AN ACCESSIBLE CLEAR FLOOR SPACE, ADAAG 305, 902.1, 902.2 ANSI 308 4. THE DIAPER CHANGING PULL DOWN HANDLE AND ALL OTHER OPERABLE CONTROLS MUST BE LOCATED AT A MAXIMUM OF 48" HIGH AND THE SURFACE MUST BE A MAXIMUM OF 28"TO34"

5. THE KNEE CLEARANCE FOR THE DIAPER CHANGING STATION (WHEN OPEN) MUST PROVIDE FOR 27". 306, 902.1, 902.2 6. ACCESSIBLE DISPENSERS MUST BE OPERABLE WITHOUT PINCHING, GRASPING OR TWISTING OF

THE WRIST AND REQUIRE 5 LBF OR LESS TO OPERATE. ADAAG 205, 309.4 ANSI 309.4

HIGH WHEN OPENED. 305, 902.1, 902.3

THERE MUST ACCESSIBLE TOILET SEAT LOCATED 17" TO 19" AFF AND CENTERED 16" TO 18" FROM SIDEWALL. ADAAG 604.4, 604.2 | DIAGRAM 4.7 2. THE TOILET FLUSH CONTROL MUST BE AUTOMATIC OR LOCATED ON THE OPEN SIDE OF THE

TOILET. ADAAG 604.6 | DIAGRAM 4.7 3. A HORIZONTAL REAR WALL GRAB BAR MUST BE PROVIDED THAT IS 1 $\frac{1}{4}$ " TO $\frac{1}{6}$ " IN DIAMETER, 36" LONG MIN, EXTENDING 12" MIN FROM THE TOILET CENTERLINE TOWARDS THE NEAR SIDE WALL, CENTERED 33" TO 36" ABOVE THE FLOOR TO THE TOP OF THE GRIPPING SURFACE AND WITH NO OBSTRUCTIONS WITHIN 12" ABOVE OR $1\frac{1}{2}$ " BELOW THE BAR. ADAAG 604.5.2, 609 ANSI 604.1, 604.5.2, 609 | DIAGRAM 4.1

4. THE URINALS FLUSH CONTROL MUST BE AUTOMATIC OR 48" HIGH MAX AND BE OPERABLE WITH NO MORE THAN 5LBF OF PRESSURE. ADAAG 605.4 ANSI 604.6 | DIAGRAM 4.4 5. GRAB BARS AT THE SIDE SHALL BE AT LEAST 42" LONG POSITIONED NO MORE THAN 12" FROM THE REAR WALL. GRAB BARS AT THE BACK SHALL BE NOT LESS THAN 36" LONG. VERTICAL GRAB BARS TO BE 18" IN LENGTH AND 39-41" AFF AND 39-41" FROM REAR WALL (IBC 1607.7 & ANSI 604.8.4.1) (ICC/ANSI A117.1-2003 FIG. 604.5.1) ANSI 604.5.1, 609.4 | DIAGRAM 4.1 6. THE CENTERLINE OF THE TOILET DISPENSER MUST BE LOCATED 7" TO 9" FROM THE FRONT OF THE CLOSET AND AT LEAST 1-1/2" BELOW THE SIDE WALL GRAB BAR OR AT LEAST 12" ABOVE THE GRAB BAR. IT ALSO MUST BE LOCATED 15" TO 48" MAXIMUM ABOVE THE FLOOR. ADAAG 604.7, 609.3

7. IF THE ACCESSIBLE WATER CLOSET IS IN A COMPARTMENT, IT MUST HAVE AT LEAST 60" MINIMUM CLEARANCE MEASURED PERPENDICULAR FROM THE SIDE WALL PROVIDED. ADAAG 604.3 DIAGRAM 4.7

8. WATER CLOSET MUST ALSO HAVE 56 MINIMUM CLEARANCE MEASURED FROM THE REAR WALL AND HAVE A WIDTH OF A MINIMUM OF 60". ADAAG 604.8.1.1 | DIAGRAM 4.6 9. IF THE WATER CLOSET IS WALL-HUNG, THE DEPTH OF THE COMPARTMENT MUST BE A MINIMUM OF 56". ADAAG 604.8.1.1 | DIAGRAM 4.7 10. IF THE WATER CLOSET IS FLOOR-MOUNTED, THE COMPARTMENT MUST HAVE A DEPTH OF AT

LEAST 59". ADAAG 604.8.1.1 | DIAGRAM 4.7 11. THE COMPARTMENT MUST PROVIDE AT LEAST 6" DEEP MINIMUM SPACE AT THE FRONT OF THE COMPARTMENT AND ONE OTHER SIDE. ADAAG 604.8.1.1 | DIAGRAM 4.7 12. IF THE TOILET COMPARTMENT IS SELF-CLOSING, PROVIDE A CLEAR OPENING WIDTH OF AT LEAST 32" AND WITHIN 4" OF THE COMPARTMENT CORNER DIAGONALLY OPPOSITE THE TOILET.

13. ALL ACCESSIBLE TOILET COMPARTMENT DOOR HARDWARE MUST BE CENTERED BETWEEN 34" AND 48" AFF. ADAAG 404.2.7 | DIAGRAM 4.7 14. IF THE ACCESSIBLE COMPARTMENT DOOR IS OUT-SWINGING, THE EXTERIOR MANEUVERING SPACES MUST BE COMPLIANT WITH FIGURE 404.2.4 ADAAG 604.8.1.2 | FIGURE 404.2.4 15. ALL ACCESSIBLE COMPARTMENT DOOR HARDWARE MUST BE OPERABLE WITH A FIST OR FLAIL

16. THE INSIDE AND OUTSIDE OF THE ACCESSIBLE COMPARTMENT DOOR MUST BE EQUIPPED WITHA LOOP OR U-SHAPED HANDLE. ADAAG 604.8.1.2 17. AT LEAST ONE OF EACH HOOK AND DISPENSER IN THE ACACESSIBLE COMPARTMENT MUST BE

AT 48" MAXIMUM AFF. ADAAG 213.3.7, 603.4, 604.8.3, 308

HAND. ADAAG 604.8.1.2, 404.2.7 | DIAGRAM 2.3

ADAAG 604.8.1.2 | DIAGRAM 4.7

WOMEN'S AMBULATORY COMPARTMENT 1. IF THERE ARE 6 OR MORE TOILET COMPARTMENTS AND URINALS COMBINED AN AMBULATORY COMPARTMENT MUST BE PROVIDED THAT IS 35" TO 37" WIDE AND AT LEAST 60" LONG. ADAAG 213.3.1, 604.8.2.1

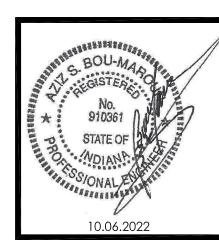
2. THE COMPARTMENT DOOR MUST PROVIDE AT LEAST 32" OF CLEAR OPENING WIDTH AND ADAAG 604.8.2.2 3. ALL HARDWARE MUST BE OPERABLE WITH A CLOSED FIST AND MUST BE CENTERED BETWEEN 34" AND 48" AFF. ADAAG 404.2.7

4. THE TOILET MUST BE CENTERED 17-19" FROM THE SIDE WALL. ADAAG 604.2 5. THERE MUST BE 2 HORIZONTAL SIDEWALL GRAB BARS PROVIDED IN THE AMBULATORY COMPARTMENT THAT ARE 1-1/4" TO 1-1/2" IN DIAMETER, 42" LONG MINIMUM, EXTENDING 54" MINIMUM FROM THE REAR WALL. ADAAG 604.8.2.3

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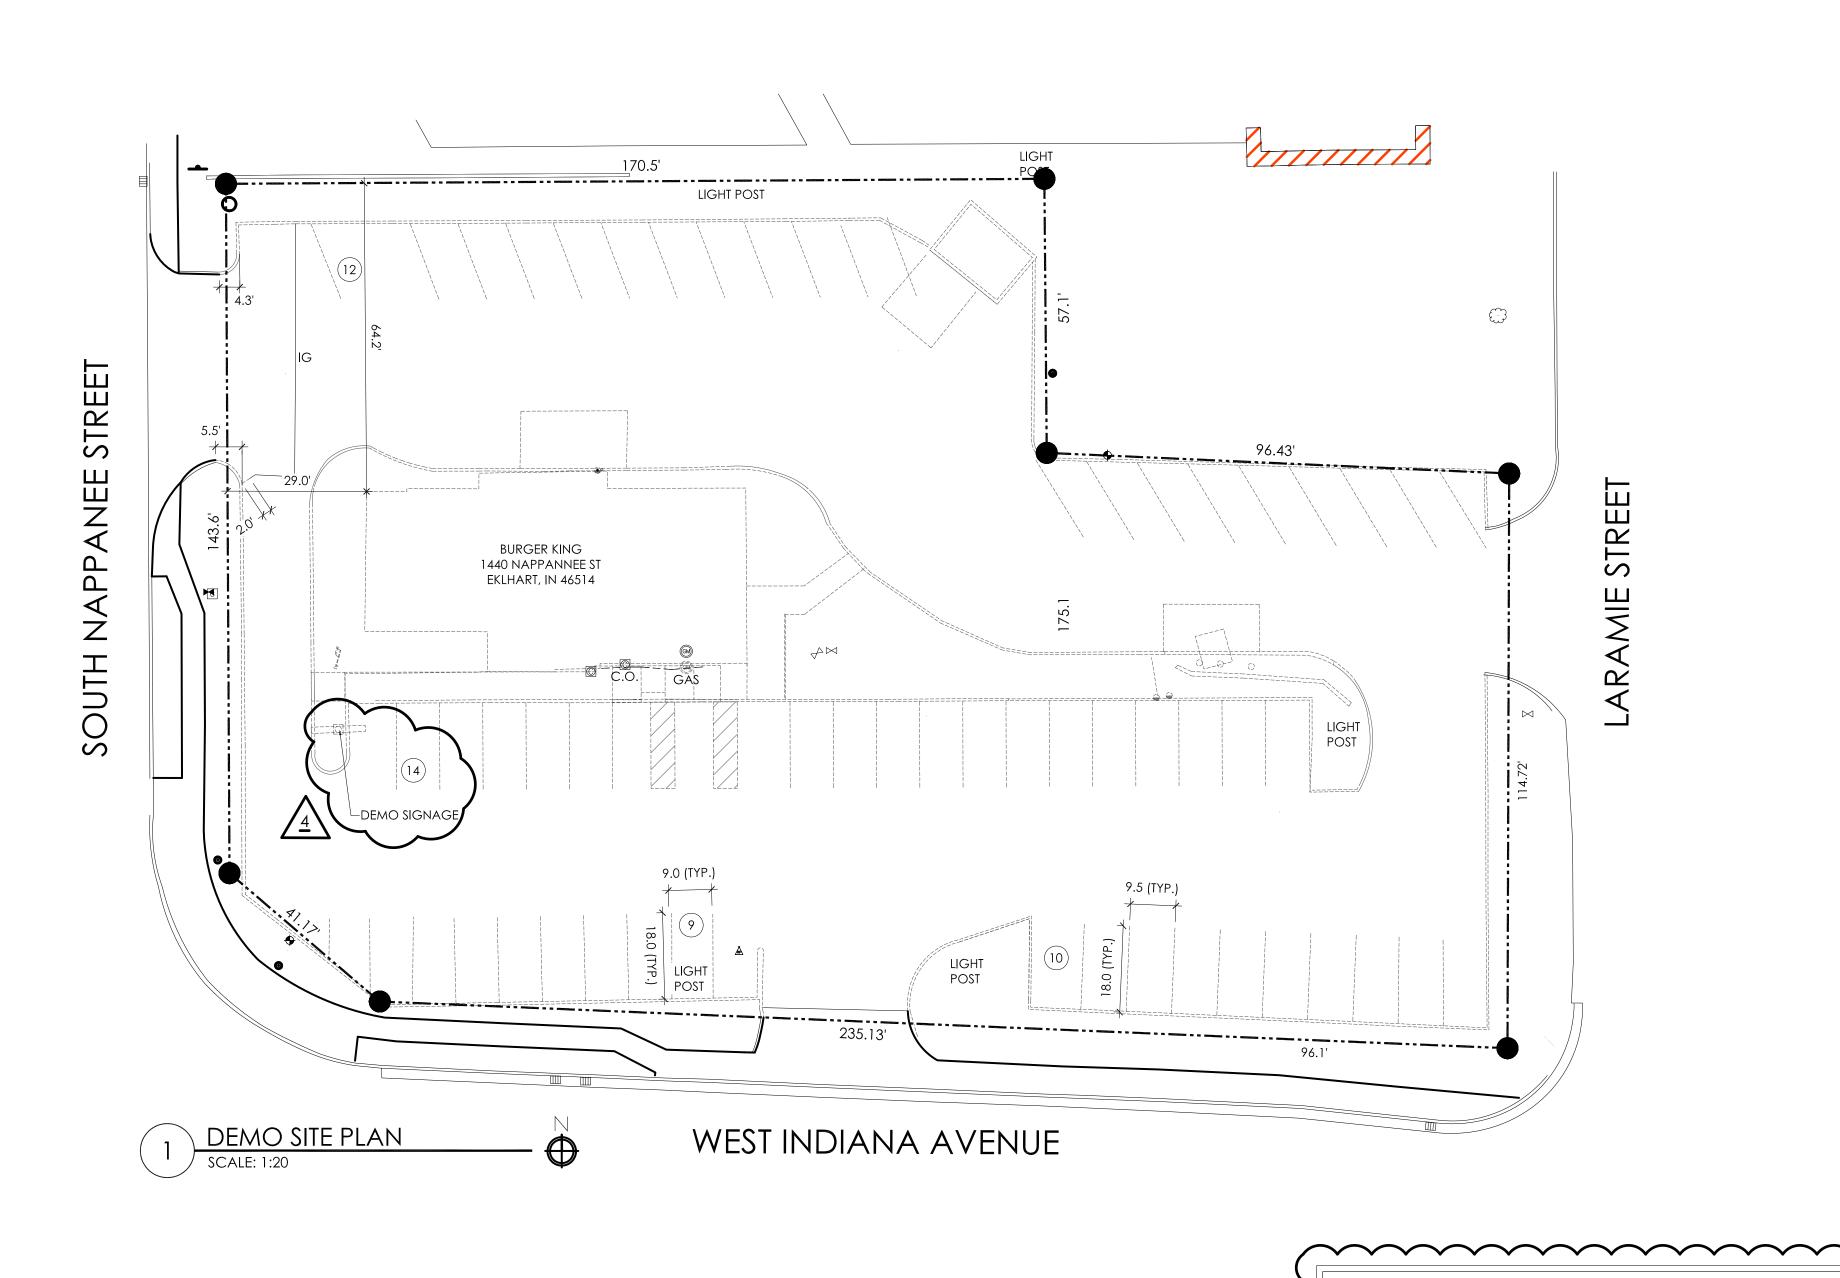


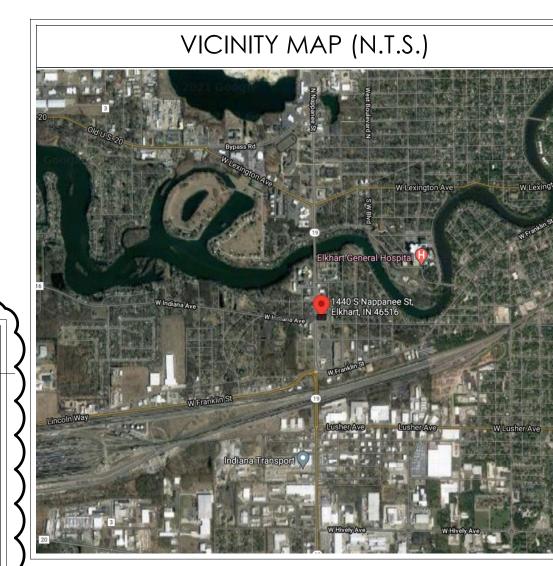


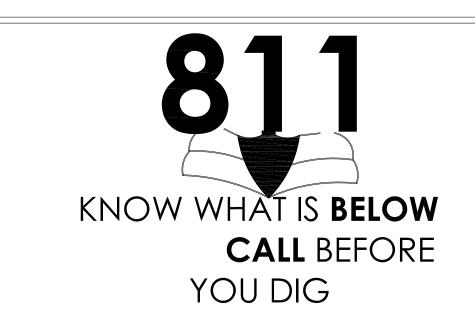


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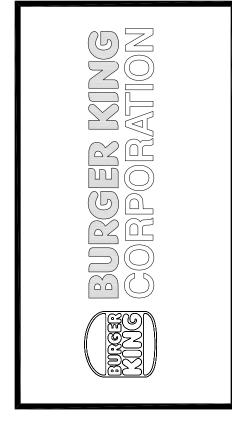










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GENERAL SIGNAGE NOTES

SIGN INSTALLER RESPONSIBILITIES:

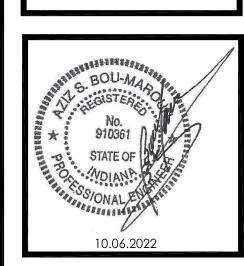PROVIDE ALL DRAWINGS NECESSARY FOR SIGN PERMITS.

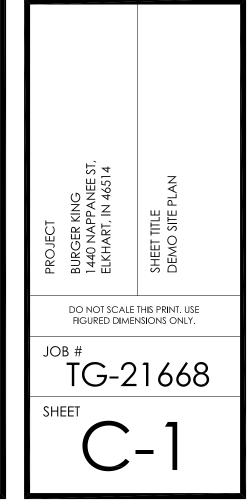APPLY FOR, OBTAIN, AND PAY FOR ALL REQUIRED SIGN PERMITS. COORDINATE EXCAVATION OF SIGN FOUNDATIONS WITH G.C. SET ANCHOR BOLTS OR BASE PLATES AS REQUIRED.

COMPLETE SIGN INSTALLATION. REMOVE EXCESS DEBRIS, ROUGH GRADE AREA FOR LANDSCAPING.

GENERAL CONTRACTOR RESPONSIBILITIES:

1. COORDINATE EXCAVATION OF SIGN FOUNDATIONS WITH SIGN SUPPLIER.

2. PROVIDE POWER TO ALL SIGN LOCATIONS AS REQUIRED.

MAKE FINAL ELECTRICAL CONNECTIONS TO EACH SIGN.

DEMO SCOPE OF WORK

DEMO EXISTING BUILDING INCLUDING SLAB AND FOUNDATION.

DEMO CONC. THROUGHOUT. (CURB CUTS TO ROADS TO REMAIN.)

DEMO OCU, MENU BOARD, AND PREVIEW BOARD AND FOUNDATIONS.

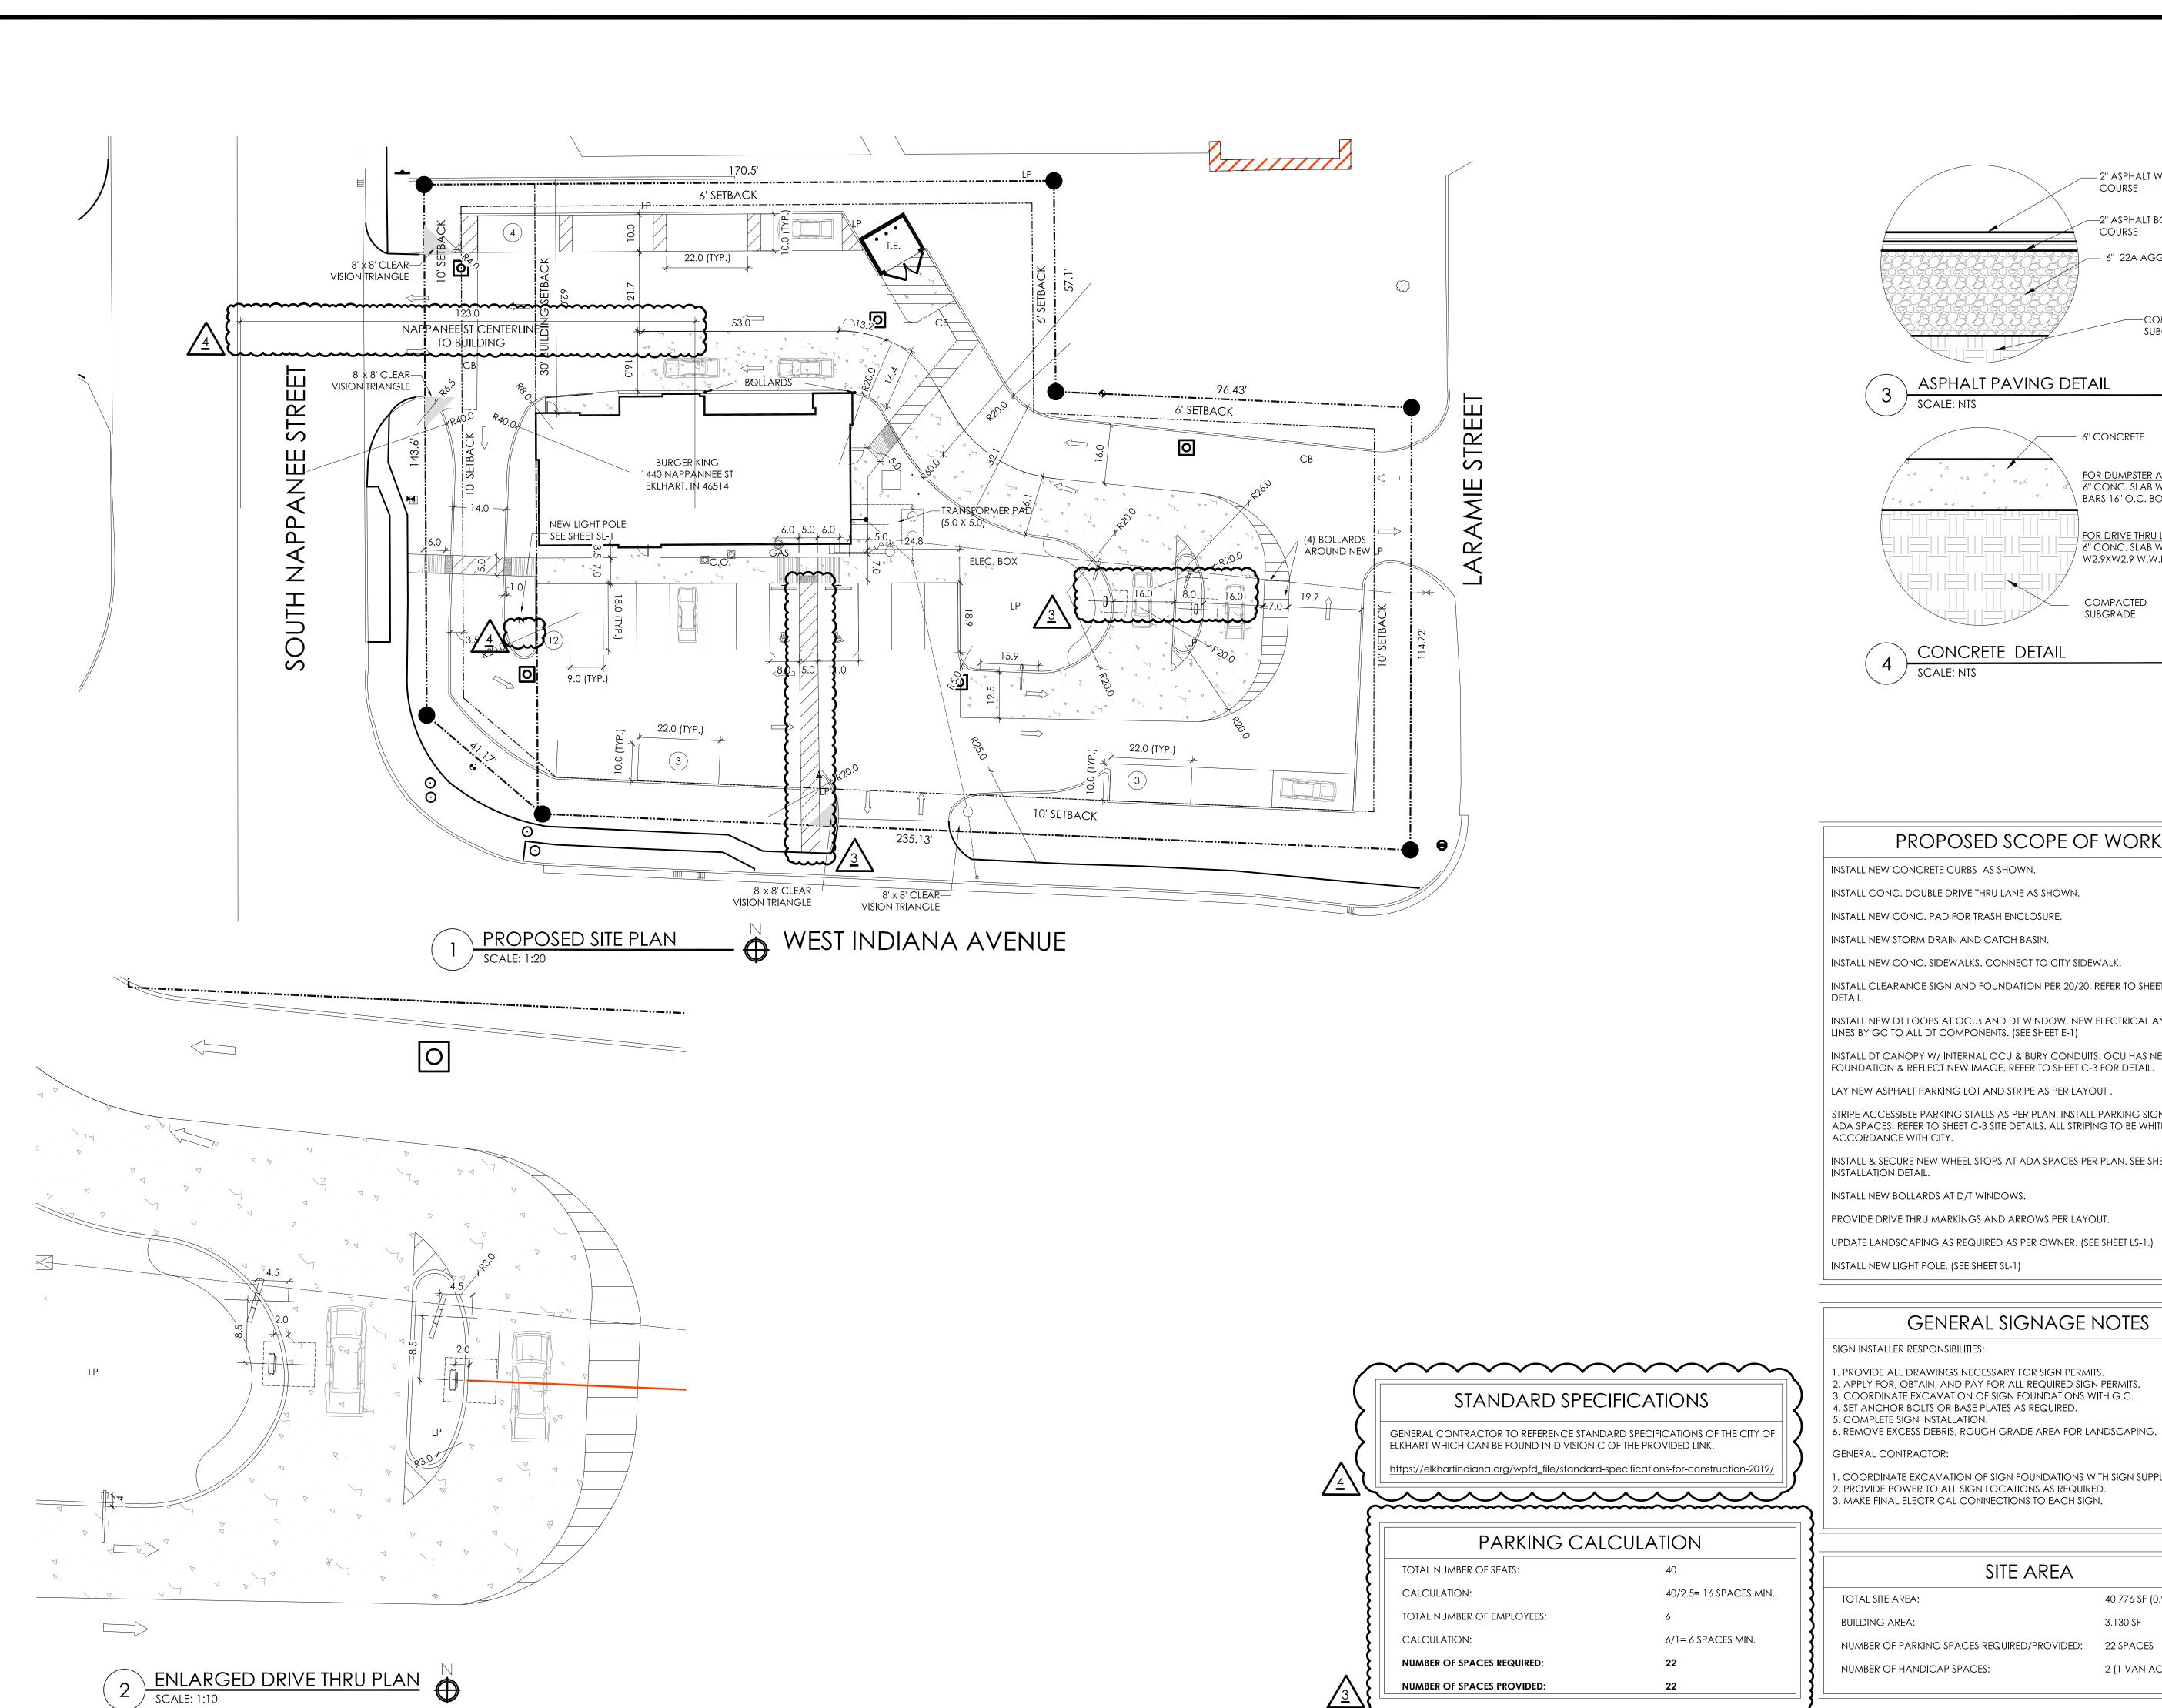
DEMO CURBS THROUGHOUT

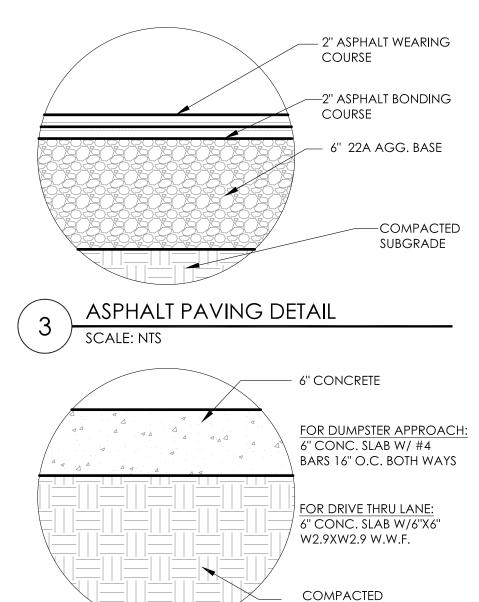
DEMO SIDEWALK.

DEMO ADA RAMP AT BUILDING ENTRANCE. MILL ASPHALT PARKING LOT TO SUBGRADE.

STANDARD SPECIFICATIONS GENERAL CONTRACTOR TO REFERENCE STANDARD SPECIFICATIONS OF THE CITY OF

ELKHART WHICH CAN BE FOUND IN DIVISION C OF THE PROVIDED LINK. https://elkhartindiana.org/wpfd_file/standard-specifications-for-construction-2019/





SUBGRADE

PROPOSED SCOPE OF WORK

INSTALL NEW CONCRETE CURBS AS SHOWN.

INSTALL CONC. DOUBLE DRIVE THRU LANE AS SHOWN.

INSTALL NEW CONC. PAD FOR TRASH ENCLOSURE.

INSTALL CLEARANCE SIGN AND FOUNDATION PER 20/20, REFER TO SHEET C-3 FOR

INSTALL NEW DT LOOPS AT OCUS AND DT WINDOW. NEW ELECTRICAL AND DATA

LINES BY GC TO ALL DT COMPONENTS. (SEE SHEET E-1)

INSTALL DT CANOPY W/ INTERNAL OCU & BURY CONDUITS. OCU HAS NEW FOUNDATION & REFLECT NEW IMAGE, REFER TO SHEET C-3 FOR DETAIL.

LAY NEW ASPHALT PARKING LOT AND STRIPE AS PER LAYOUT.

STRIPE ACCESSIBLE PARKING STALLS AS PER PLAN. INSTALL PARKING SIGNAGE FOR ADA SPACES. REFER TO SHEET C-3 SITE DETAILS. ALL STRIPING TO BE WHITE IN

INSTALL & SECURE NEW WHEEL STOPS AT ADA SPACES PER PLAN. SEE SHEET C-3 FOR

INSTALL NEW BOLLARDS AT D/T WINDOWS.

PROVIDE DRIVE THRU MARKINGS AND ARROWS PER LAYOUT.

UPDATE LANDSCAPING AS REQUIRED AS PER OWNER. (SEE SHEET LS-1.)

INSTALL NEW LIGHT POLE. (SEE SHEET SL-1)

GENERAL SIGNAGE NOTES

I. PROVIDE ALL DRAWINGS NECESSARY FOR SIGN PERMITS.

2. APPLY FOR, OBTAIN, AND PAY FOR ALL REQUIRED SIGN PERMITS. 3. COORDINATE EXCAVATION OF SIGN FOUNDATIONS WITH G.C.

4. SET ANCHOR BOLTS OR BASE PLATES AS REQUIRED.

5. COMPLETE SIGN INSTALLATION.

1. COORDINATE EXCAVATION OF SIGN FOUNDATIONS WITH SIGN SUPPLIER. 2. PROVIDE POWER TO ALL SIGN LOCATIONS AS REQUIRED. 3. MAKE FINAL ELECTRICAL CONNECTIONS TO EACH SIGN.

SITE AREA

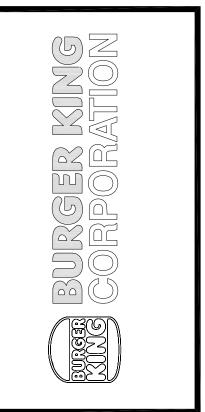
40,776 SF (0.94 ACRES)

3,130 SF

NUMBER OF PARKING SPACES REQUIRED/PROVIDED: 22 SPACES

2 (1 VAN ACCESSIBLE)

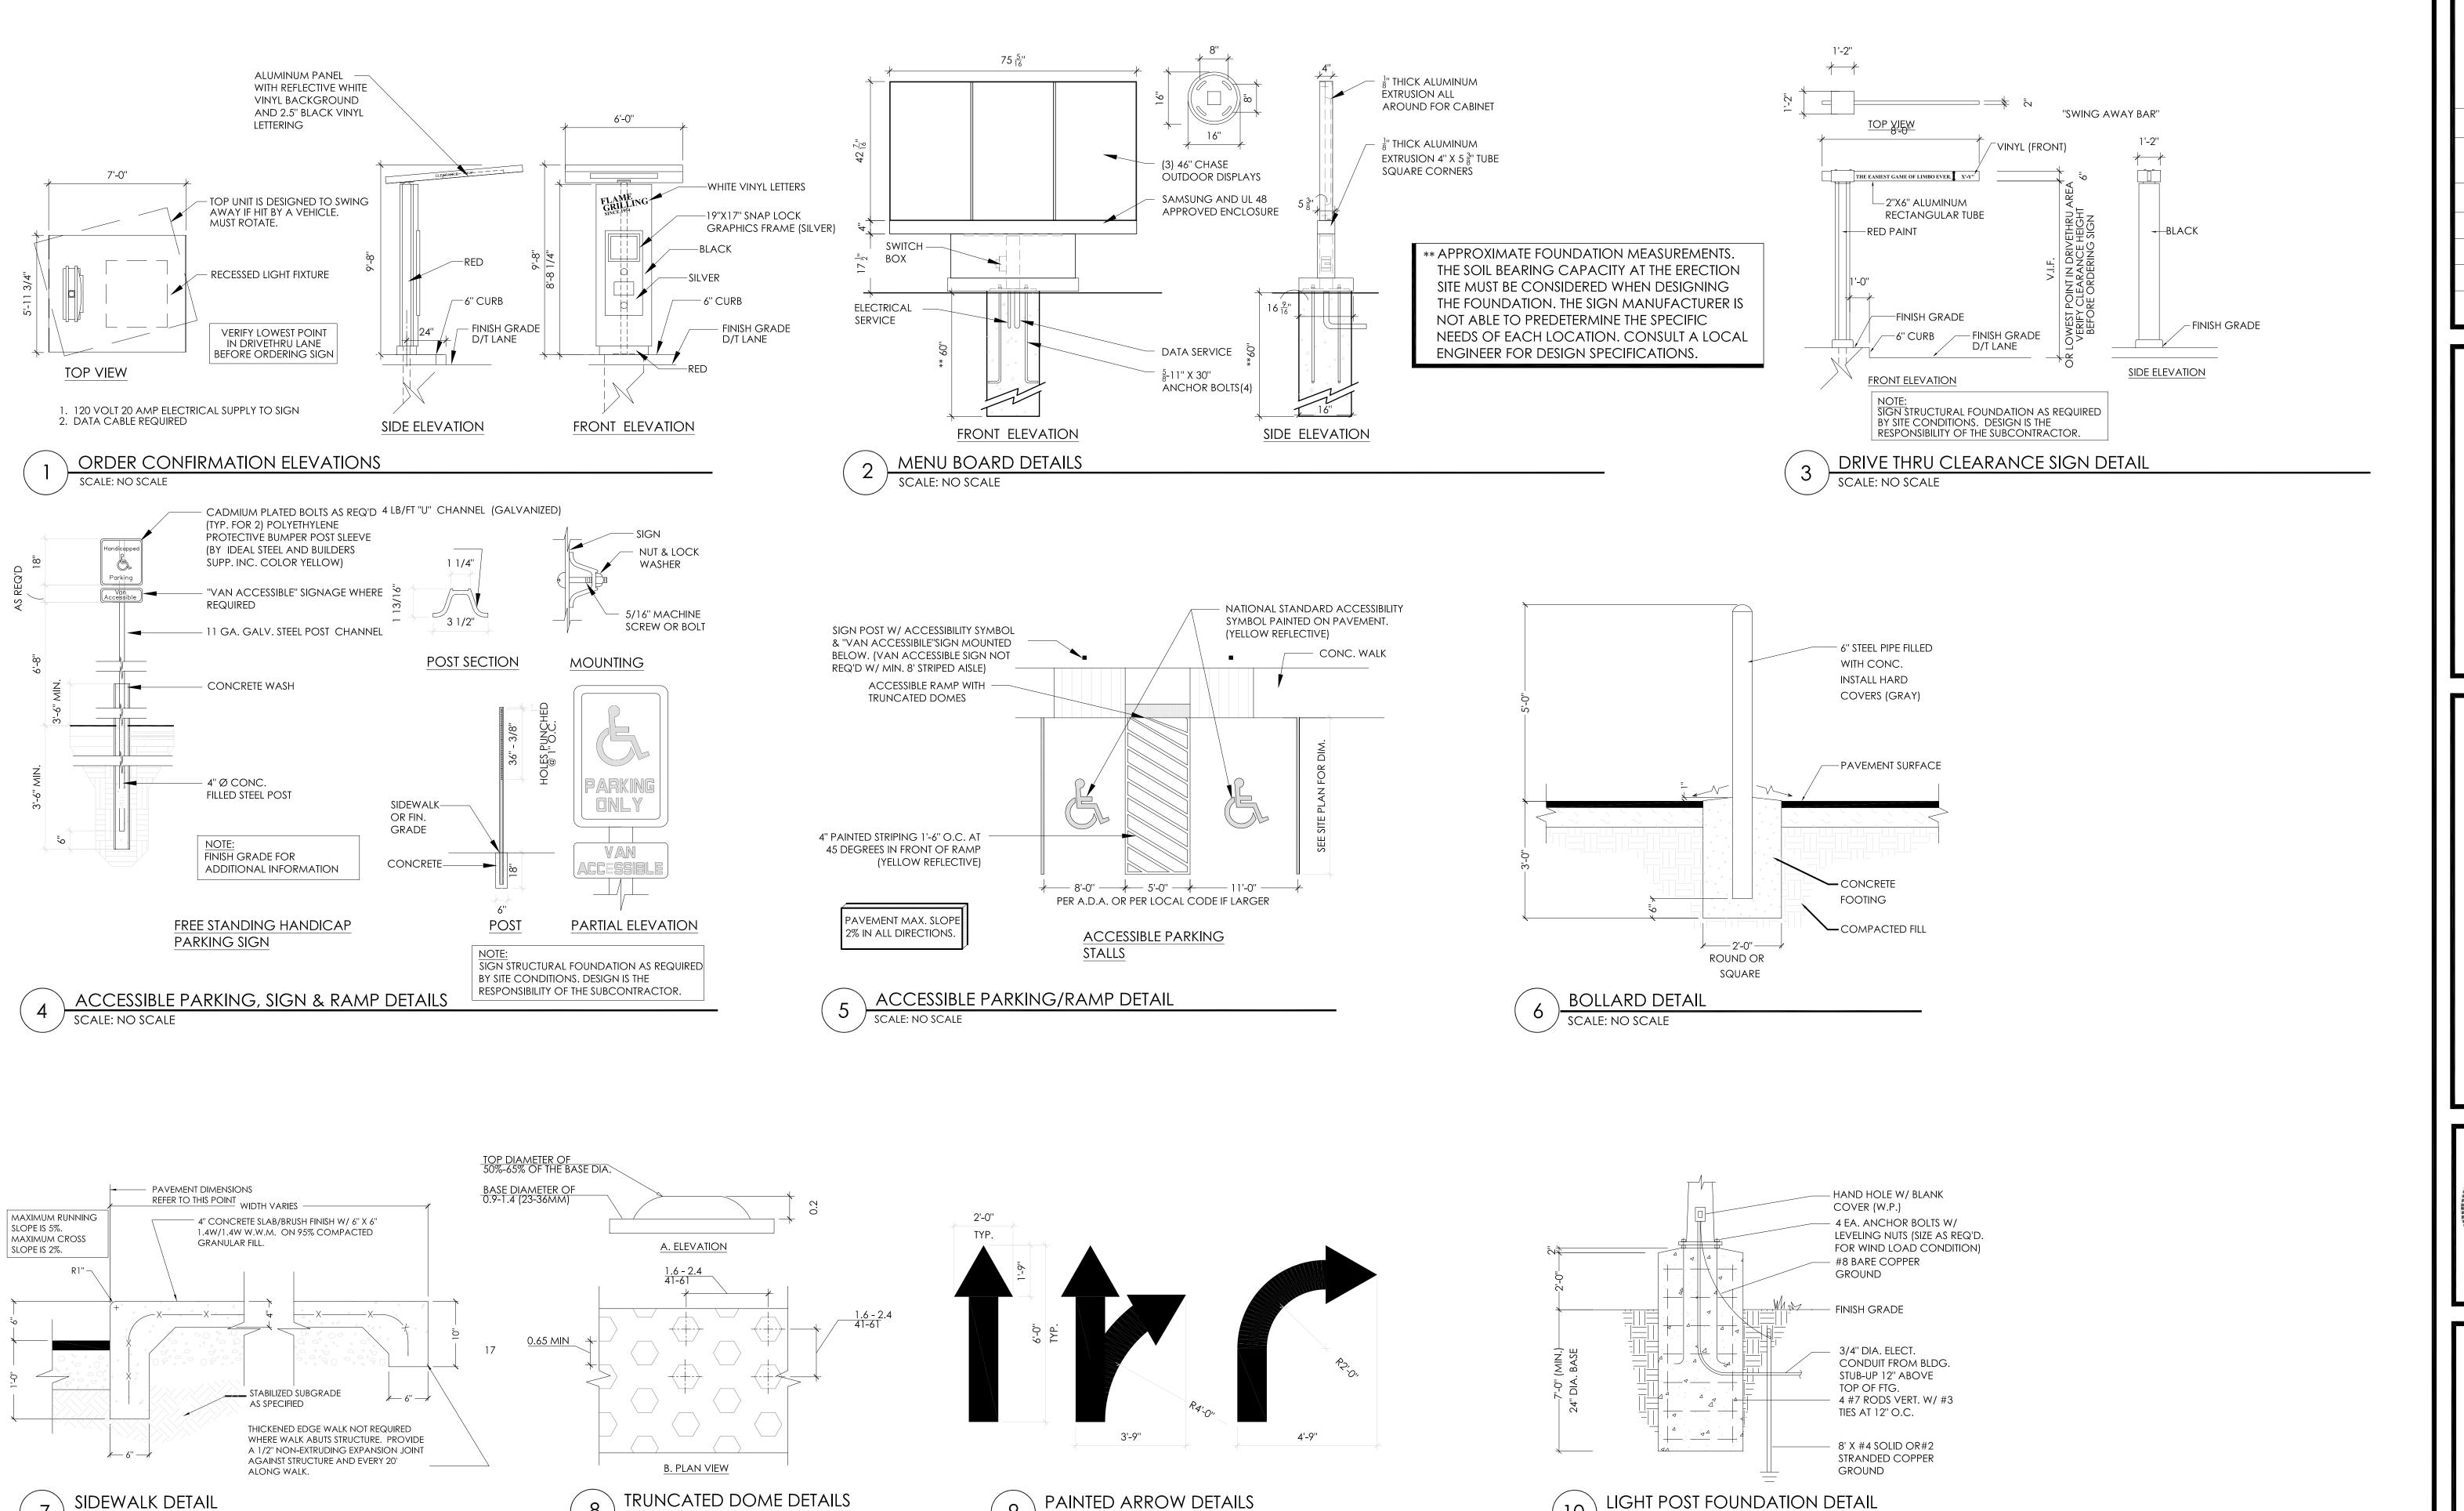
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PROJECT	BURGER KING 1440 NAPPANEE ST, ELKHART, IN 46514	SHEET TITLE PROPOSED SITE PLAN
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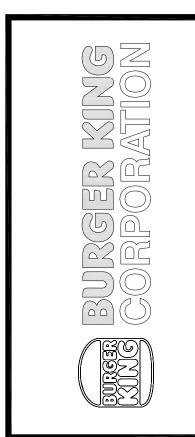
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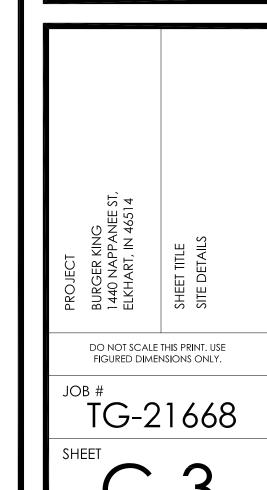
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No. Date BEEN PREPARED, WITHOUT PRIOR WRITTEN AUTHORIZATION











STANDARD SPECIFICATIONS

GENERAL CONTRACTOR TO REFERENCE STANDARD SPECIFICATIONS OF THE CITY OF

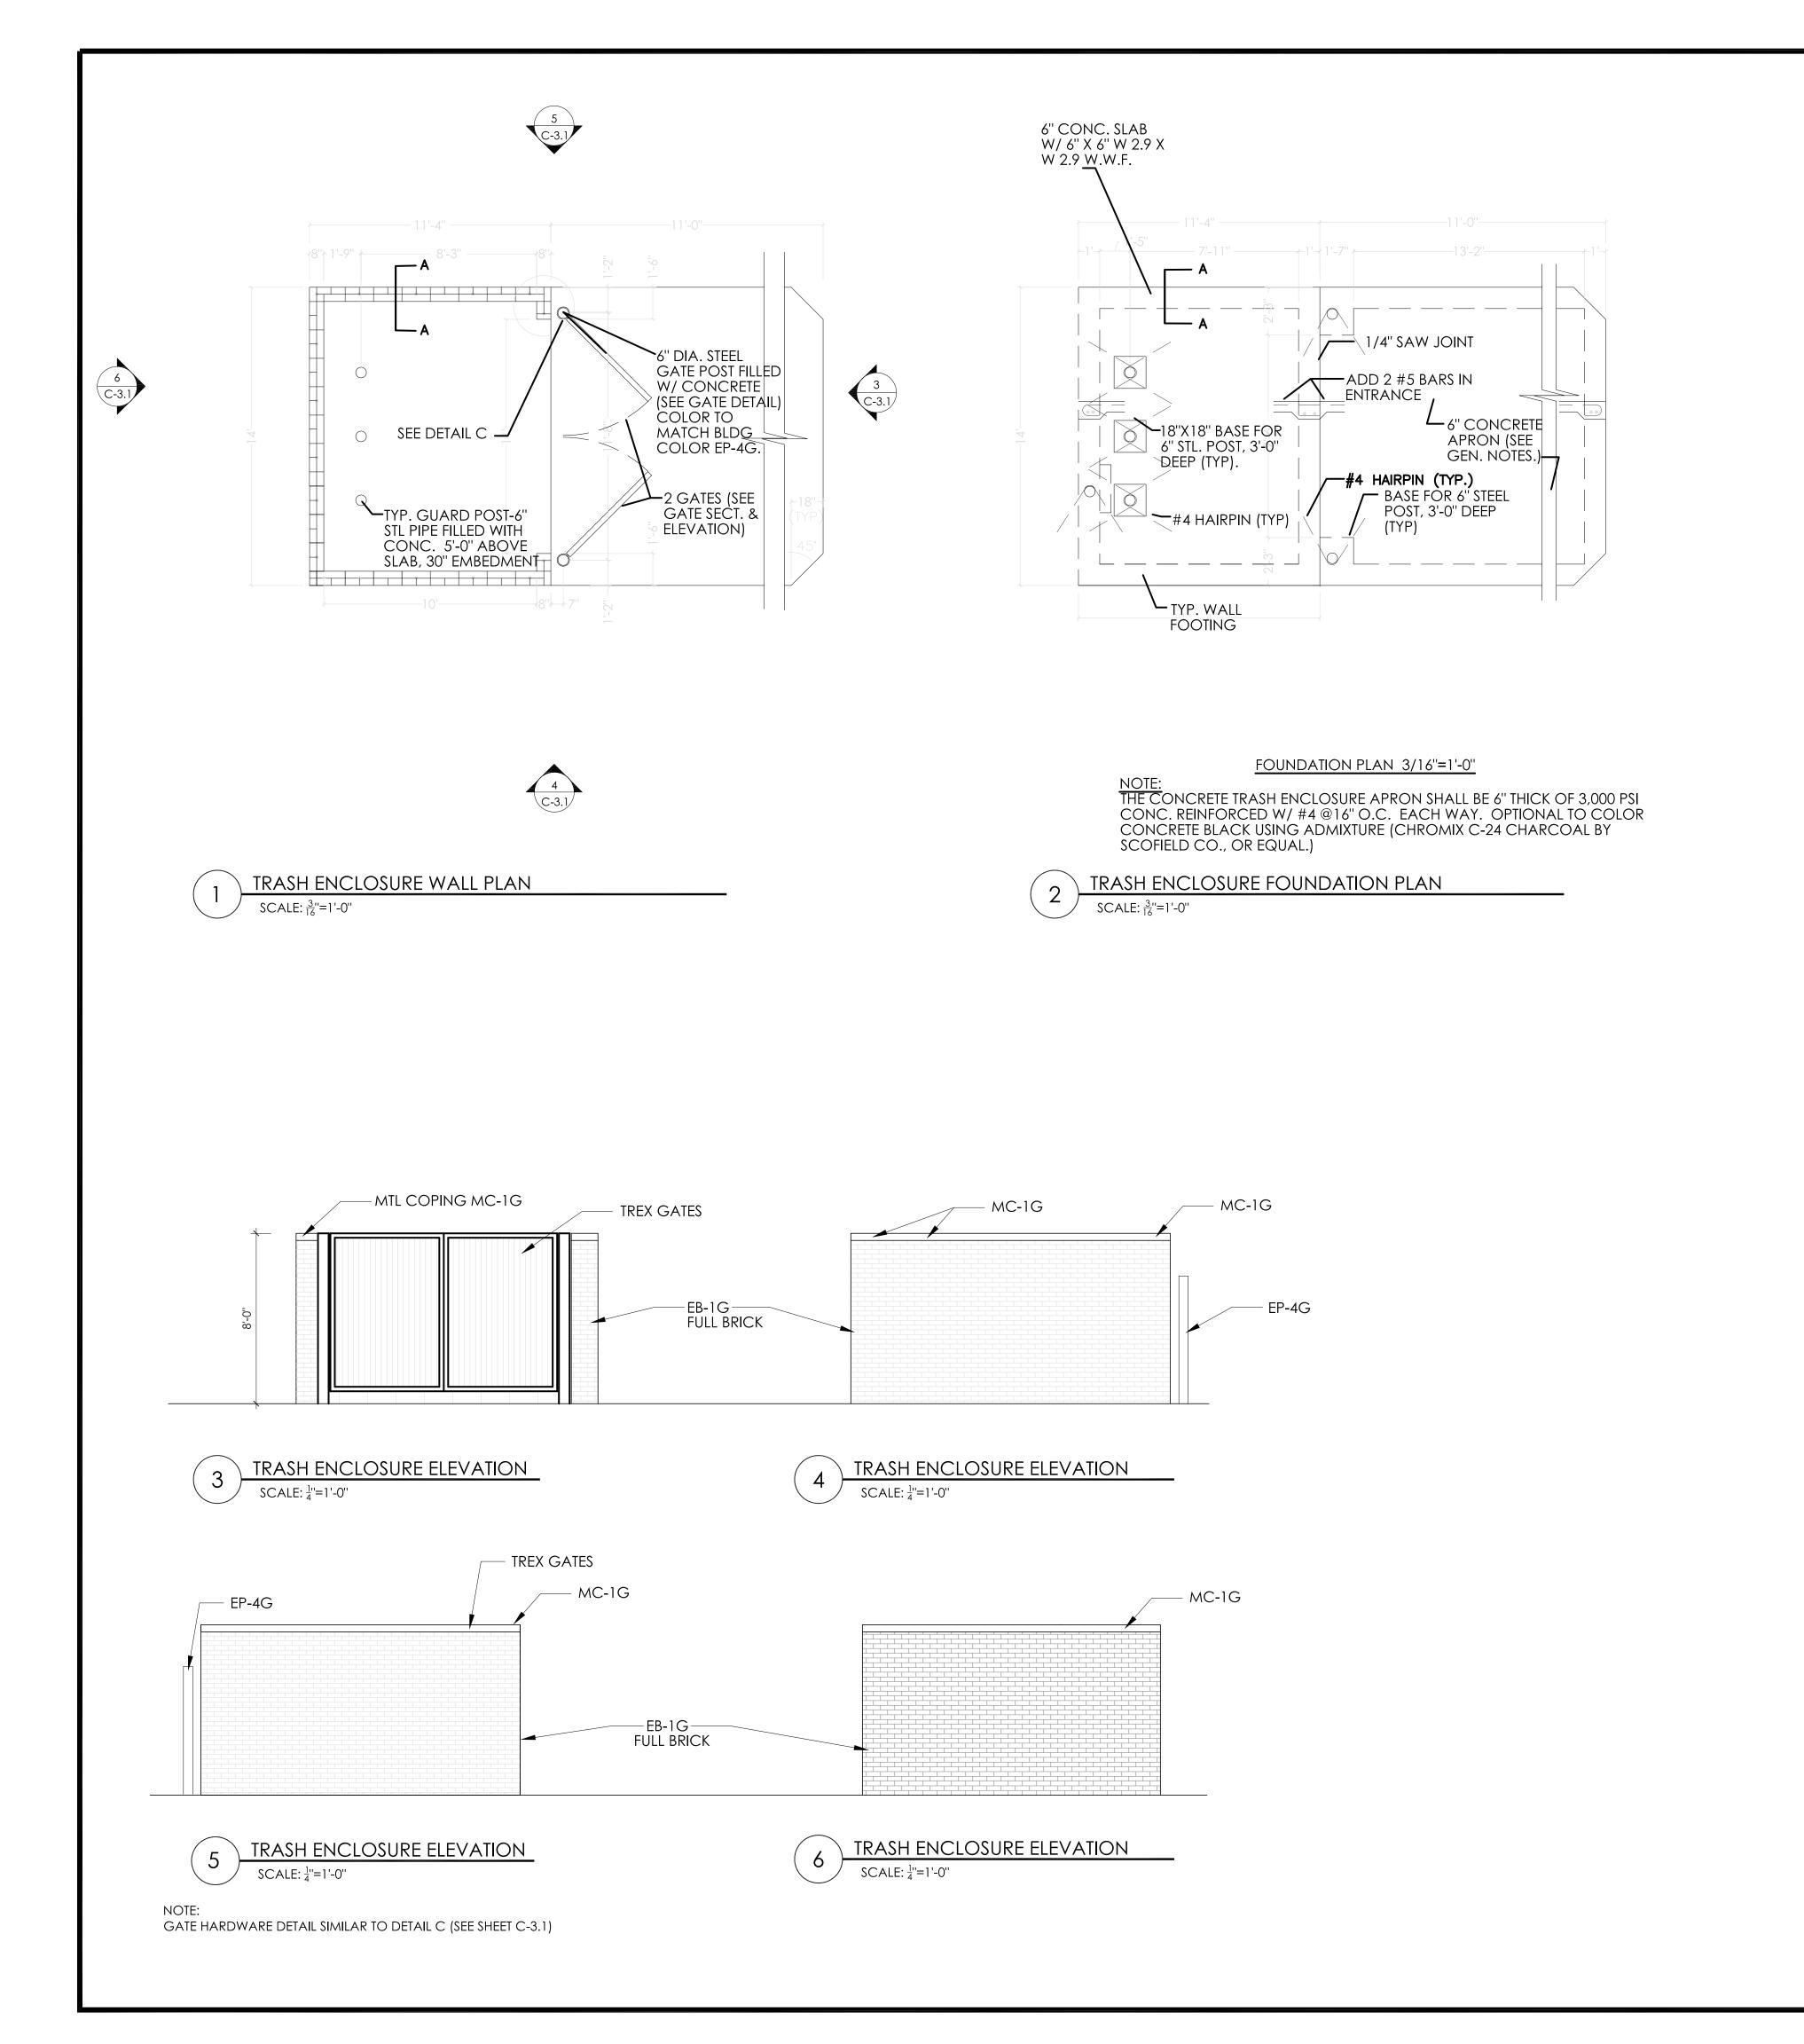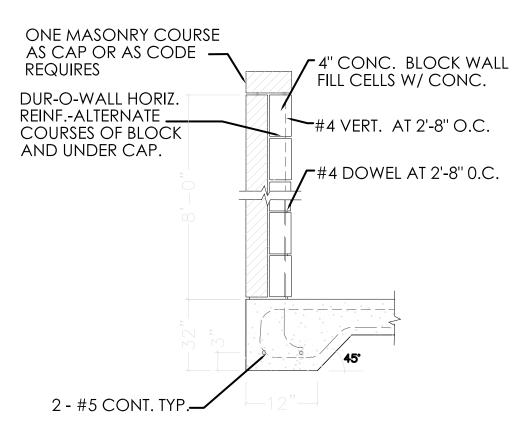
ELKHART WHICH CAN BE FOUND IN DIVISION C OF THE PROVIDED LINK.






NOTES:

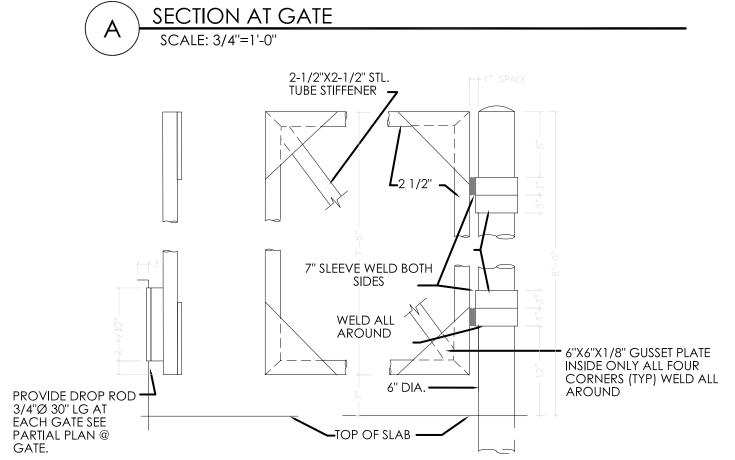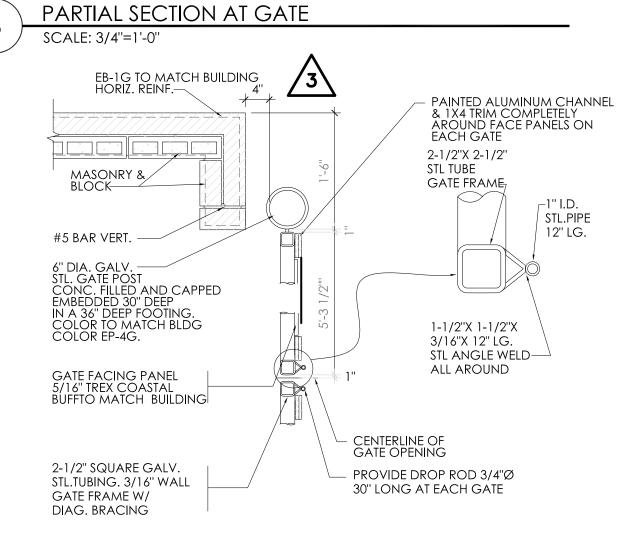- MASONRY VENEER TO MATCH BUILDING EB-1 (OR EB-1A IF USED) AND PAINT EP-4G ON 4" CONC. BLOCK WALL. SEE SECTION "A-A" FOR DETAILS.
- 2. 6" CONC. SLAB W/6"X6" W2.9XW2.9 W.W.F. 3. TYP. WALL FTG. 12" X 12" CONT. W/2#5 BOT. REINF.
- 4. 6" CONC. APRON W/#4 BARS 16" O.C. BOTH WAYS.
- 5. FOR SLAB FINISHED GRADES, SEE GRADING PLAN.
 6. ALL STEEL & ALUMINUM FINISHES ARE TO BE PAINTED TO MATCH BUILDING COLOR EP-4G.
- 7. ALL PANELS FOR GATES ARE TO BE THRU-BOLTED TO TUBE FRAME WITH 3/8" GALV. BOLTS AND HARDWARE.





C GATE HARDWARE DETAIL
SCALE: NO SCALE

STANDARD SPECIFICATIONS

GENERAL CONTRACTOR TO REFERENCE STANDARD SPECIFICATIONS OF THE CITY OF ELKHART WHICH CAN BE FOUND IN DIVISION C OF THE PROVIDED LINK.

https://elkhartindiana.org/wpfd_file/standard-specifications-for-construction-2019/

Notes	STATE BUILDING AND ENGINEERING REVIE	TECHNICAL REVIEW COMMENTS	TECHNICAL REVIEW MEETING REVISIONS	TECHNICAL REVIEW MEETING REVISIONS	INDOT SUBMITTAL	all rights reserved. No part of these drawings or specifications maybe copied, reproduced or used in connection with any work, other then the specific project for which the have been prepared, without prior written authorization from the architect.
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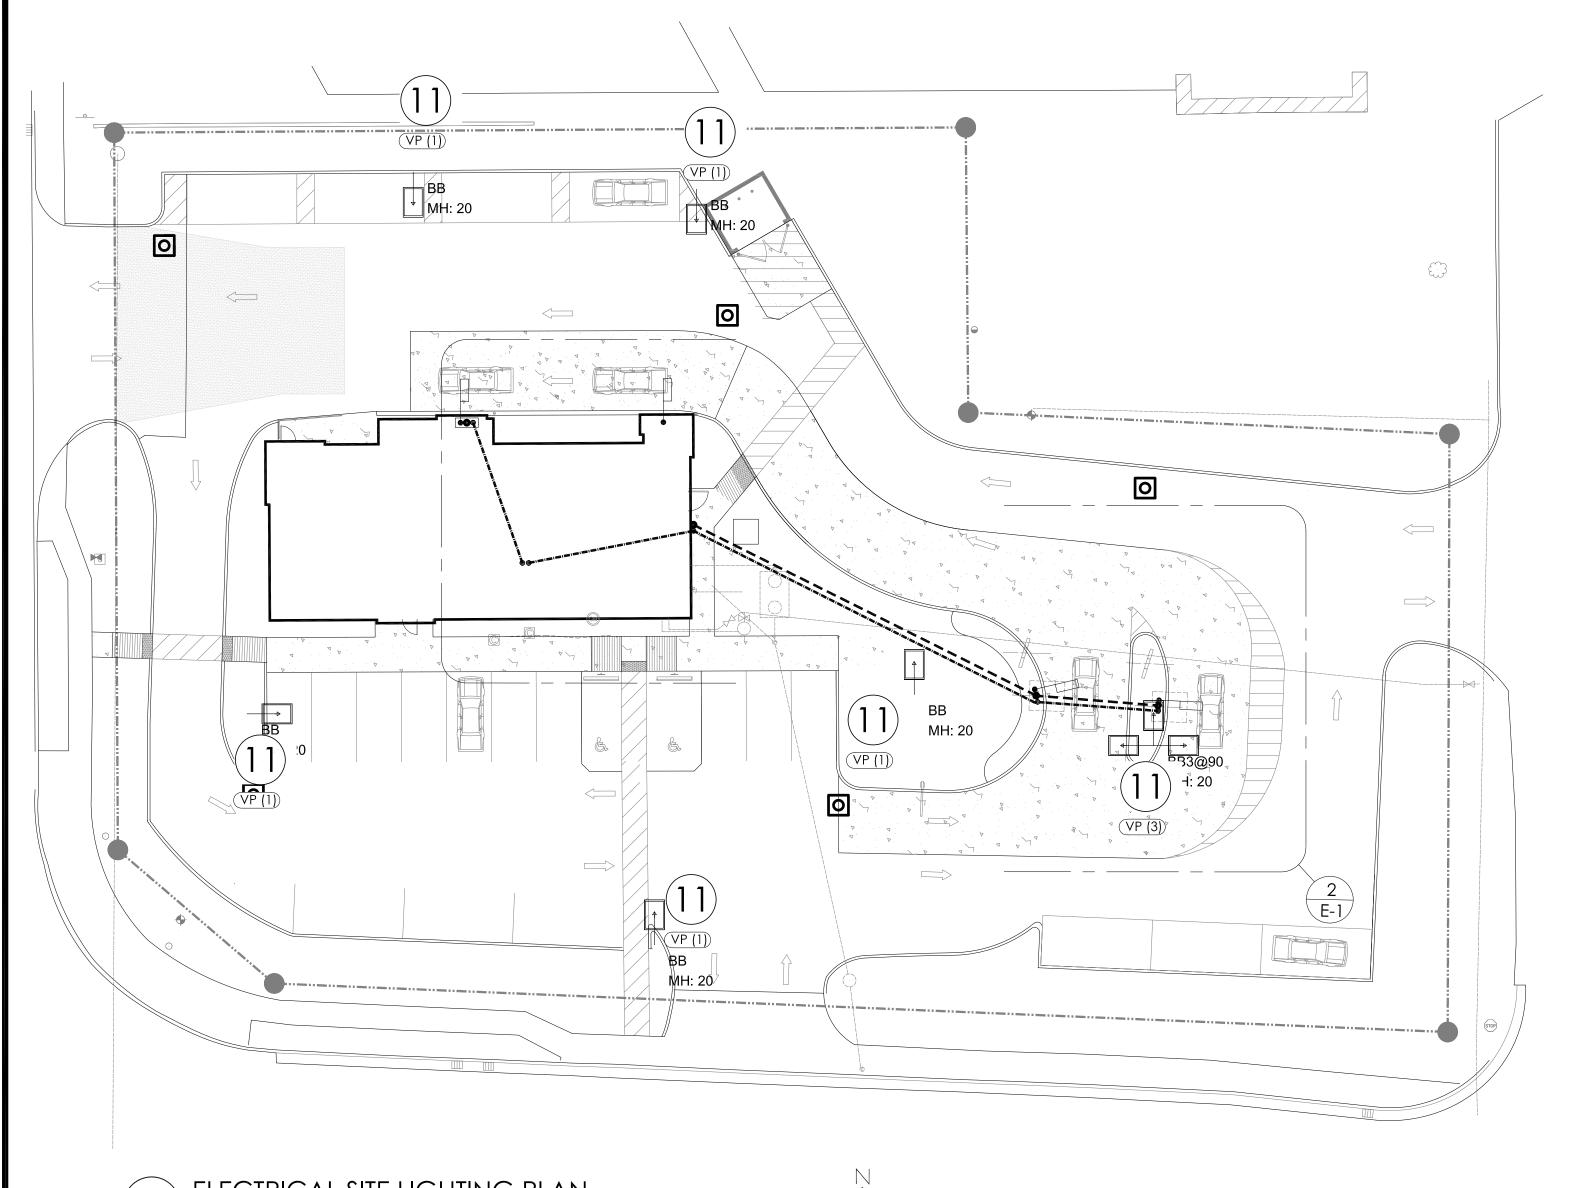




PROJECT BURGER KING 1440 NAPPANEE ST, ELKHART, IN 46514	SHEET TITLE	DUMPSTER ENCLOSURE DETAILS	
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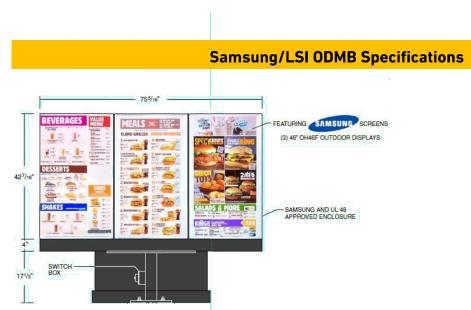
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C-3.



2" POWER 2" DATA/AUDIO POINTS ABOVE (CEILING IN OFFICE 2" CONDUIT POWER TO MENU BOARD -2"C WI (G) CATG CABLES TO MENU BOARD $\frac{1}{2}$ CONDUIT (LOOP ONLY) (6) ∠ 2" CONDUIT (POWER) 2" CONDUIT (DATA / AUDIO) CONDUIT "B" STUBBED UP 6" AT REAR WALL (SUITABLE LOCATION) 1/2" CONDUIT (LOOP ONLY)

ELECTRICAL SITE PLAN



		Spe	cifications & Mea	asurements			
	Diamanal Cina		TV	46"			
	Diagonal Size		Screen	45.0" /116.8cm			
	Туре			120Hz E-LED BLU			
	Resolution			1920 x 1080 (16:9)			
Display	Brightness (Ty	p.)		2,500			
	Contrast Ratio	(Тур	.)	5000:1			
	Viewing Angle	(H/V)	178/178			
	Response Time	e (G-1	to-G)	6ms			
	Operation Hou	r		24/7			
			RGB	N/A			
	1		Video	HDMI 1.4 (2), HDBa	seT (LAN Common)		
Campasticito	Input		HDCP	HDCP 2.2			
Connectivity			USB	USB 2.0 (1)			
	Output		Audio	Stereo Mini Jack			
	External Contr	ol		RS232C (In/Out), RJ45 (In/Out), HDBas			
	Туре			Internal			
	Power Supply			AC100-240V~(+/-1	0%),50/60Hz		
			Max [W / H]	468			
Power Type	Power		Typical [W / H]	440			
	Consumption		Sleep Mode	<0.5W			
			Off Mode	<0.5W			
	Pre-sell (1 x 1)						
Dimensions	Menu Board (1	x 3)		75.3" x 4" x 42.4"			
\\/ = ! = ! = !	Pre-sell (1 x 1)						
Weight	Menu Board (1	x 3)					

STANDARD SPECIFICATIONS

GENERAL CONTRACTOR TO REFERENCE STANDARD SPECIFICATIONS OF THE CITY OF ELKHART WHICH CAN BE FOUND IN DIVISION C OF THE PROVIDED LINK.

CONNECTIONS

- 1. DEDICATED 120V SINGLE PHASE CONSTANT POWER TO OCU.
- 2. 120V SINGLE PHASE POWER FOR CANOPY LIGHTS, MENUBOARD, OCU.
- 3. DATA AND SPEAKER CABLES CONNECT TO POS RACK IN OFFICE (PULL WITHOUT CONNECTORS).
- 4. AUDIO CABLES FOR SPEAKERS CONNECT TO MAIN UNIT AT THE DRIVE-THRU
- 5. PRIMARY DETECTOR LOOP WIRE CONNECTS.

2'C WI (2) CATG to OCU

B"x8'xG"

J-BOX

ELECTRICAL & DATA WIRING DETAIL

30° ROTATION ANGLE SHOULD BE CONSIDERED OPTIMAL. ANGLES BETWEEN

THE PREFERRED LAYOUT AND MINIMUM LAYOUT ARE ACCEPTABLE AS LONG

I) THE DISTANCE FROM THE CENTERLINE OF THE SUPPORT POLES OF THE MENU

(2) THE DISTANCE FROM THE CENTERLINE OF THE ORDER CONFIRMATION UNIT AND THE CENTERLINE OF THE MENU BOARD IS REDUCED BY 3" FOR EVERY 5

BOARD AND TO THE FACE OF CURB ARE REDUCED BY 4" FOR EVERY 5

2" CONDUIT/ (8) CATG -

DEGREES OF ROTATION, AND:

DEGREES OF ROTATION.

MENU BOARD 2" CONDUIT FOR OCU POWER

B"x8'xG"

- 2" CONDUIT TO BUILDING

- 6. SECONDARY DETECTOR LOOP CONNECTS TO POS THROUGH TIMING
- 7. OUT DOOR MENU BOARD REQUIRES A DEDICATED 20 AMP BREAKER.
- 8. CONNECT THE ENCLOSURE'S GFCI TO POWER FEED. THE DUPLEX OUTLET FOR PLUGGING IN THE SICOM-PROVIDED POWER STRIP IS PRE-WIRED TO THE GFCI.
- 9. CAT5/CAT6 CABLE TO BE RAN FROM BACK OFFICE NETWORK SWITCH TO OUTDOOR MENU BOARD PEDESTAL.
- 10. STATIC LAN IP ADDRESS IN THE POS VLAN ASSIGNED FOR EACH SCREEN AS
- 11. ALL EXTERIOR LIGHTS (INCLUDING EXTERIOR BUILDING LIGHTS, POLE LIGHTS AND LIGHTBAND) TO BE CONNECTED TO PHOTOCELL, RE-USE EXISTING CIRCUITS AND INSTALL BREAKER LOCKS.

VENDORS	_
VLINDONS	

SICOM MEDIA PLAYER

MICHAEL SCHWARTZ (BKSALES@SICOM.COM) 1-800-547-4266 EXT 5.

OUTDOOR DIGITAL MENU BOARD (ODMB)

- SAMSUNG/LSI

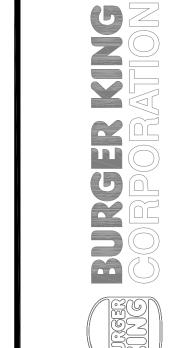
- SARA GROFCSIK (S.GROFCSIK@SEA.SAMSUNG.COM)
- STEPHANYA FLORES (\$1.FLORES@PARTNER.SEA.SAMSUNG.COM)
- JOE INGERMAN (JOSEPH.INGERMAN@IGE.COM)

847-941-8838

<u>INSTALLATION</u>

KEVIN TOWNSEND (KEVIN.TOWNSEND@LSI-INDUSTRIES.COM) 330-494-1941

IF A ODMB IS PURCHASED WITH AN INTEGRATED OCU, PLEASE COORDINATE WITH YOUR SIGNAGE VENDOR FOR THEM TO PROVIDE A OCU COVER PLATE FOR THE OCU CANOPY.



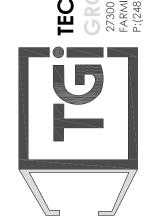
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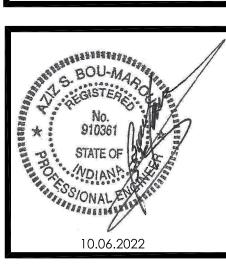
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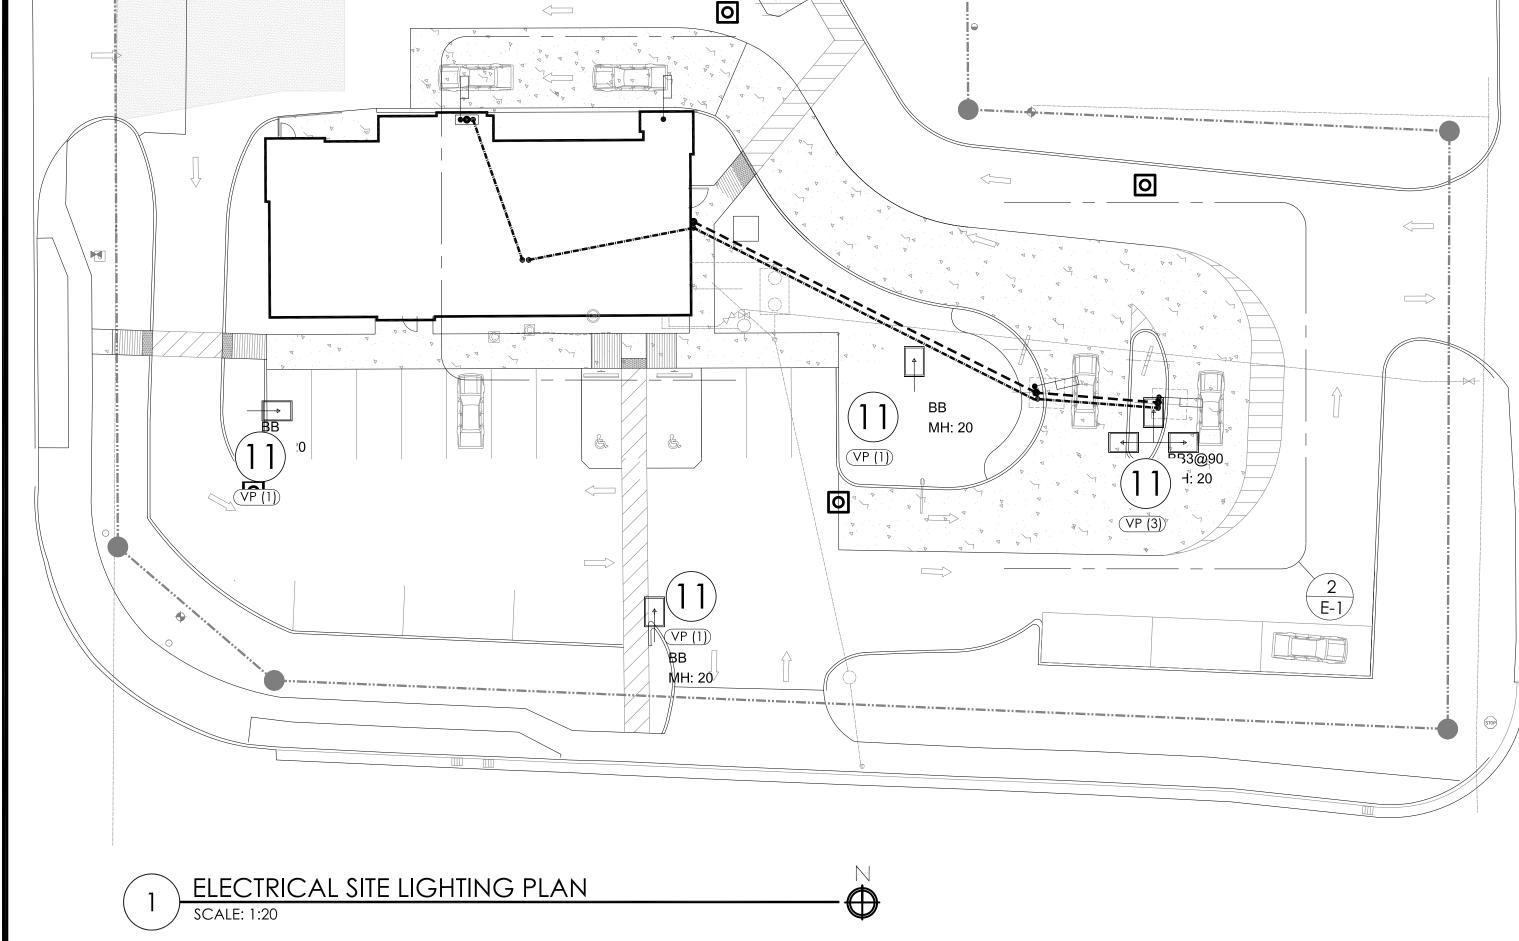






PROJECT	BURGER KING 1440 NAPPANEE ST, ELKHART, IN 46514	SHEET TITLE SITE ELECTRICAL

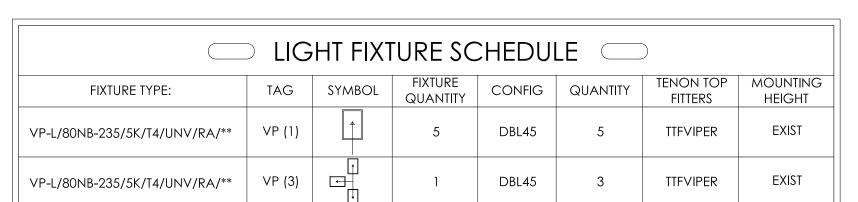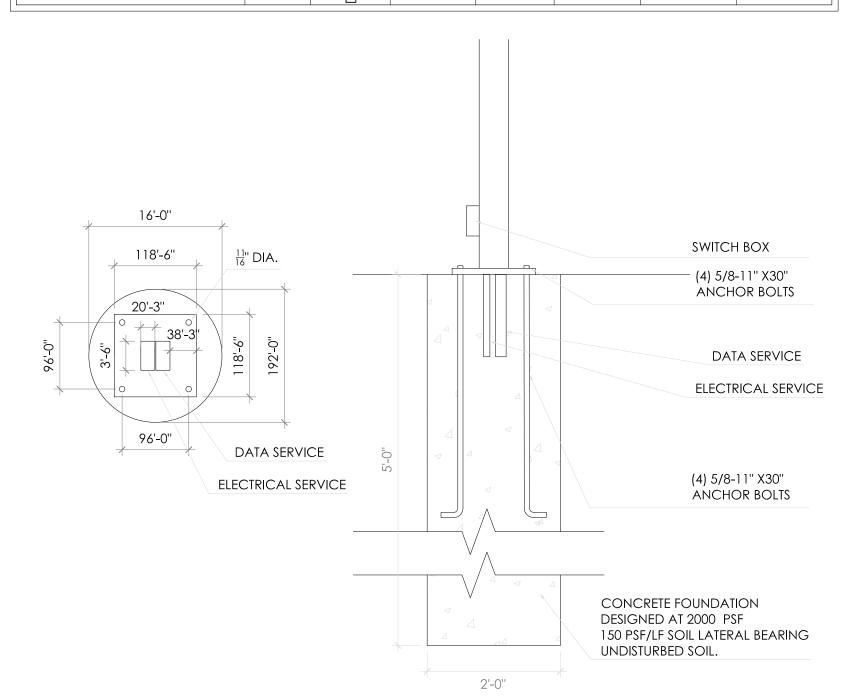DO NOT SCALE THIS PRINT. USE FIGURED DIMENSIONS ONLY.

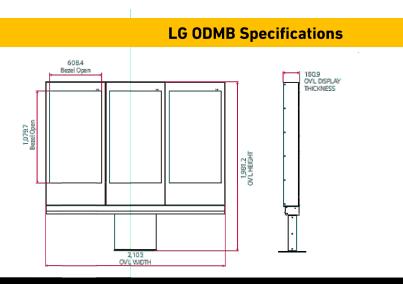
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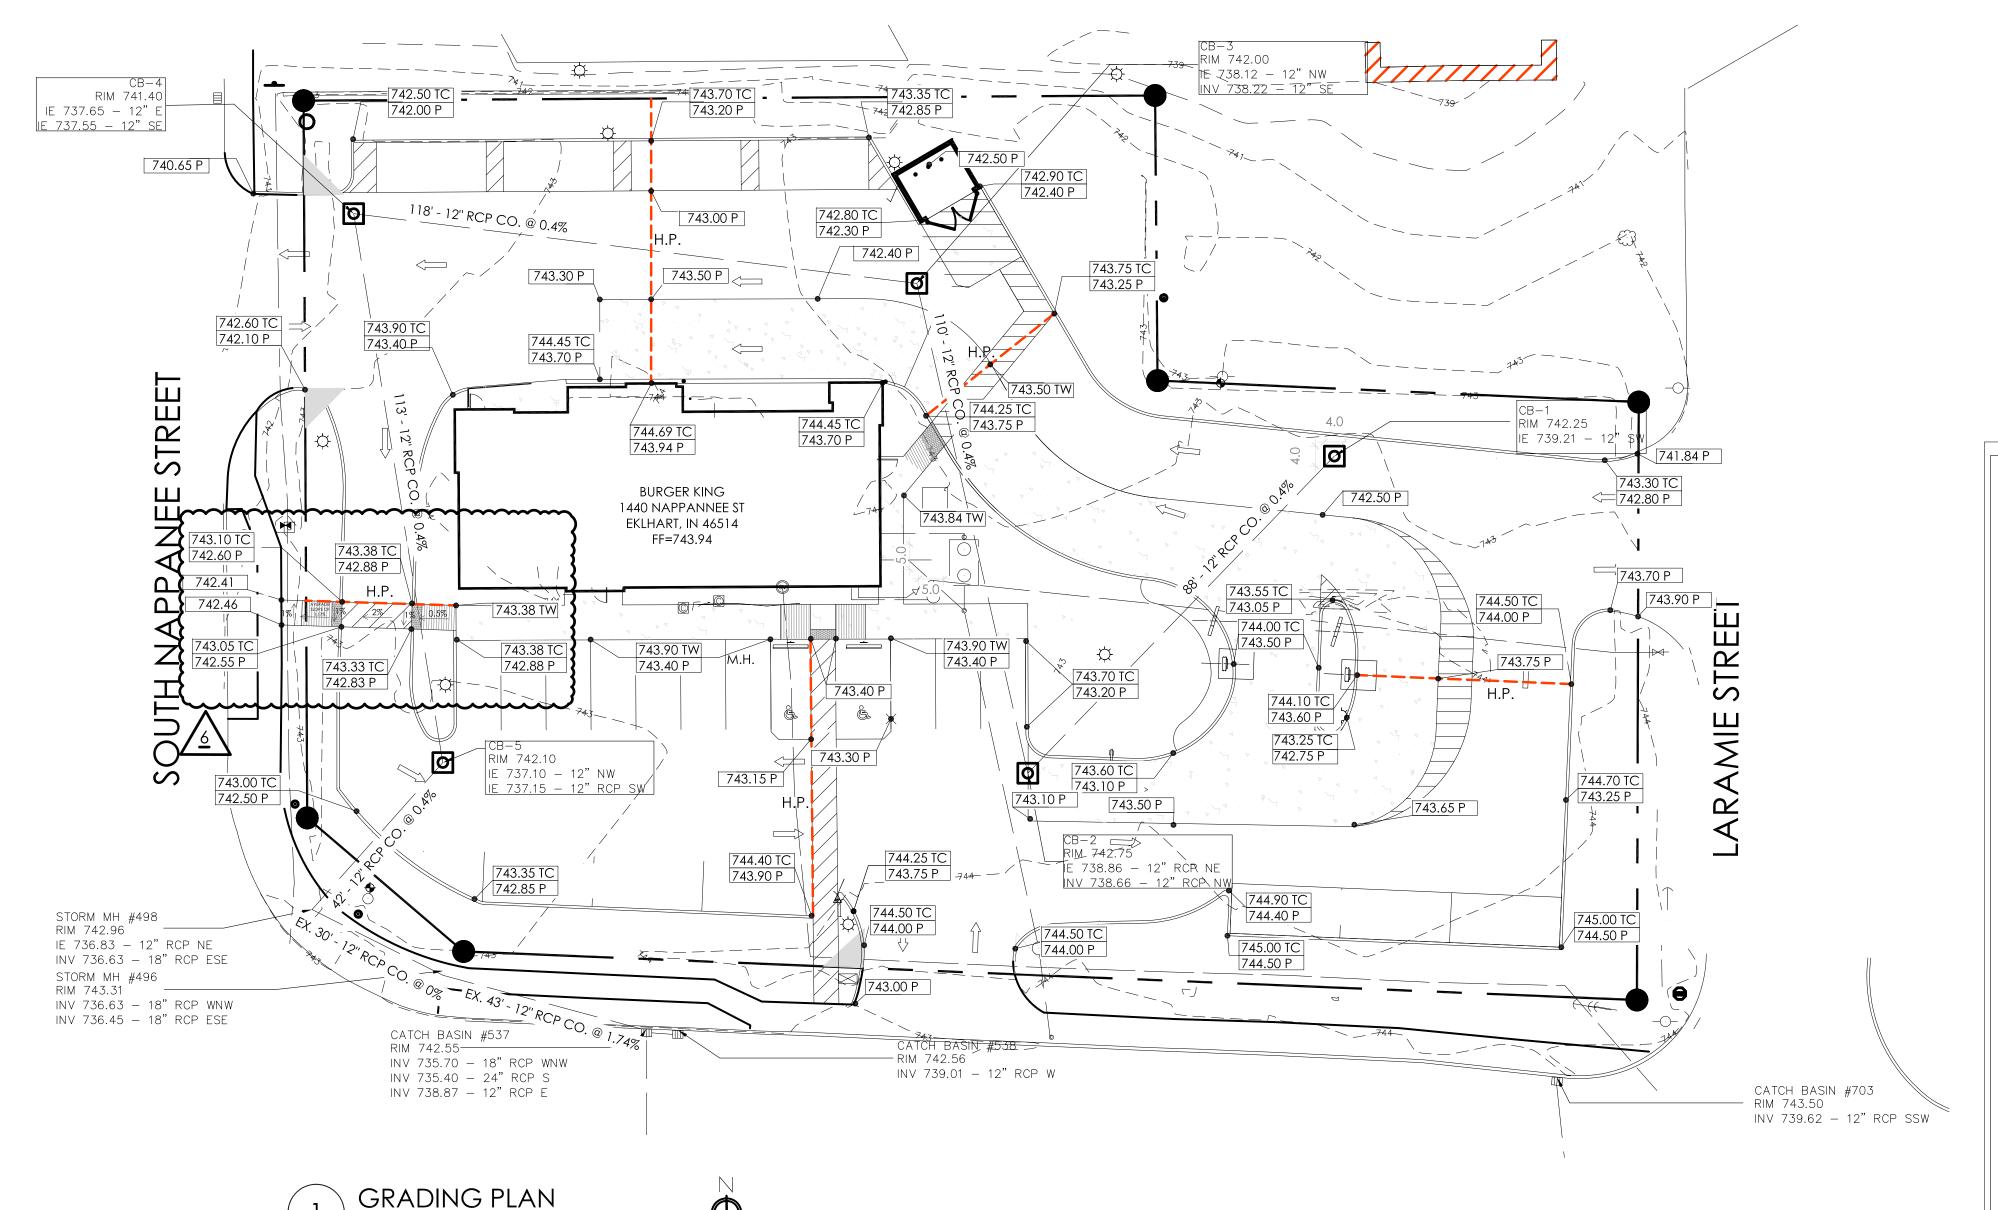




MENU BOARD BASE PLATE/ FOUNDATION DETAIL



		Sp	ecifications & Measure	ments	
	Screen Size			49"	
	Panel Technolog	gy		IPS	
	Aspect Ratio			16:9	
	Native Resolution	on		1,920 x 1,080 (FHD), M+ (WRGB)	
	Brightness*			3,000-nit	
	Viewing Angle *	H x V)		178 x 178	
Panel	Response Time			8 ms (G to G BW, Typ.)	
	Surface Treatme	ent		Hard Coating (2H), Anti-reflection Treatment of the Front Polarizer (Haze 3% (Typ.)), QWP	
	QWP Polarizer			Yes	
	Life Time			50,000 Hrs.	
	Operation Hour	S		24 Hrs.	
	Orientation			Portrait Only	
	Input			HDMI, DP, DVI-D, Audio I, USB 3.0	
Connectivity	Output			DP, External Speaker Out	
	External Contro	l		RS232C In/out, RJ45 In	
	Front Glass			6.8 mm (AR, Tempered & Laminated glass)	
	Bezel Color			Black	
illysical	Bezel Width			103.0 mm (T), 262.0 mm (B), 46.5 mm (L/R)	
Specification	Pre-sell Dimens	ion		27.6" x 7.1" x 78"	
	Menu-Board Di	mensio	n	106.4" x 7.1" x 78"	
	Pre-sell Weight			220 lbs.	
	Menu Board We	eight		528 lbs.	
	Power Supply			100-240v-, 50/60Hz	
	Power Type			Built-in Power	
Power	Power Consum	ation	Typ./Max	290 W / 440W	
	Power Consump	ווטוו	Smart Energy Saving	145 W	



OTES

- 1. THE INFORMATION DEPICTED ON THESE CONSTRUCTION DOCUMENTS IS AS ACCURATE AS POSSIBLE WITH REGARD TO THE INFORMATION PROVIDED BY THE SURVEYOR. THE CONTRACTOR IS RESPONSIBLE FOR FIELD VERIFYING ALL EXISTING GRADES PRIOR TO CONSTRUCTION. NOTIFY THE OWNER'S REPRESENTATIVE AND THE ENGINEER OF RECORD IMMEDIATELY OF ANY DISCREPANCY FOUND BETWEEN THE FIELD CONDITIONS AND THESE PLANS.
- 2. ALL PROPOSED SPOT ELEVATIONS AND CONTOURS SHOWN ON THE PLAN ARE PROPOSED FINISHED GRADES. FINISHED GRADE ADJACENT TO THE BUILDING SHALL BE 6" MINIMUM BELOW THE FINISHED FLOOR ELEVATION OF THE BUILDING INCLUDING ANY TOPSOIL, MULCH, AND/OR SOD. THE GENERAL CONTRACTOR SHALL ADJUST SUB GRADE ELEVATIONS ACCORDINGLY TO ENSURE POSITIVE DRAINAGE AWAY FROM THE BUILDING. SEE THE BUILDING PLANS FOR FURTHER DETAILS. GENERAL CONTRACTOR SHALL ALSO ADJUST SUB GRADE ELEVATION IN ALL LANDSCAPED ISLANDS TO ACCOUNT FOR TOPSOIL AND MULCH. SEE LANDSCAPE PLANS FOR FURTHER DETAIL.
- 3. WALKS AND SIDEWALKS SHALL HAVE A CONTINUOUS COMMON SURFACE NOT INTERRUPTED BY STEPS OR BY ABRUPT CHANGES IN LEVEL EXCEEDING ½" AND SHALL BE A MINIMUM OF 48" IN WIDTH.
- 4. WALKING SURFACE CROSS SLOPES SHALL NOT EXCEED 2%.5. WALKS, SIDEWALKS AND PEDESTRIAN WAYS SHALL BE FREE OF GRATING WHENEVER POSSIBLE. FOR

OF AT LEAST EVERY 400 FEET.

- GRATINGS LOCATED IN THE SURFACE OF ANY OF THESE AREAS, GRID OPENINGS IN THE GRATINGS SHALL BE LIMITED TO ½" IN THE DIRECTION OF TRAFFIC FLOW.

 6. ON ACCESSIBLE ROUTES, WHEN THE SLOP IN THE DIRECTION OF TRAVEL OR ANY WALK EXCEEDS 1V:20H, IT
- 6. ON ACCESSIBLE ROUTES, WHEN THE SLOP IN THE DIRECTION OF TRAVEL OR ANY WALK EXCEEDS 19:20H, IT SHALL COMPLY WITH THE PROVISIONS OF A PEDESTRIAN RAMP.
- PER ADA STANDARDS FOR ACCESSIBLE DESIGN 4.5.2: ON ACCESSIBLE ROUTES, CHANGES IN ELEVATION UP
 TO ¾" ARE ALLOWED. CHANGES GREATER THAN 1V:2H AND CHANGES GREATER THAN ¾" MUST BE BEVELED.
 ALL WALKS WITH CONTINUOUS SLOPE SHALL HAVE LEVEL AREAS AT LEAST 5 FEET IN LENGTH AT INTERVALS
- ASPHALT ELEVATION ADJACENT TO CATCH BASINS TO BE ¼" ABOVE RIM ELEVATION SHOWN FOR CATCH BASIN (TYPICAL).
- 10. INSTALL ALL NECESSARY EROSION CONTROL MEASURES PRIOR TO THE START OF ANY GRADING ACTIVITIES.
 REFER TO THE EROSION CONTROL PLAN FOR DETAILS AND PROCEDURES.

 11. NO GRADING ACTIVITIES SHALL BE PERFORMED OFF-SITE WITHOUT THE EXPRESSED WRITTEN CONSENT OF
- THE ADJACENT PROPERTY OWNER AND/OR JURISDICTION.

 12. EXISTING GRADES SHALL BE MATCHED WITH THE LEGAL BOUNDARY UNLESS OTHER PROVISIONS HAVE BEEN
- MADE.

 13. SOILS USED FOR STRUCTURAL FILL SHALL BE CLEAN AND FREE OF ORGANIC MATERIAL.

15. SPOT ELEVATIONS SHOWN FOR CURB AND GUTTER ARE TOP OF CURB AND EDGE OF PAVEMENT. WHERE

- 14. CONTRACTOR TO ADJUST AND/OR RECONSTRUCT TO GRADE ALL UTILITY STRUCTURES TO MEET PROPOSED GRADES.
- PROPOSED CURB MEETS EXISTING CURB CONTRACTOR SHALL MATCH EXISTING ELEVATIONS.

 16. CONTRACTOR SHALL PROCURE AND CONFORM TO ALL CONSTRUCTION PERMITS REQUIRED.
- 17. CONTRACTOR SHALL PROVIDE ALL BONDS AND INSURANCE REQUIRED BY PUBLIC AND/OR PRIVATE AGENCIES HAVING JURISDICTION.18. THE CONTRACTOR SHALL PERFORM ALL WORK NECESSARY TO COMPLETE THE PROJECT IN ACCORDANCE
- WITH THE APPROVED CONSTRUCTION DRAWINGS INCLUDING INCIDENTALS AS MAY BE NECESSARY TO MEET APPLICABLE AGENCY REQUIREMENTS AND PROVIDE A COMPLETED PROJECT.

 19. ANY INSPECTION BY THE CITY, COUNTY OR OTHER AGENCIES SHALL NOT, IN ANY WAY, RELIEVE THE
- CONTRACTOR FROM ANY OBLIGATION TO PERFORM THE WORK IN STRICT COMPLIANCE WITH THE APPLICABLE CODES AND AGENCY REQUIREMENTS.
- 20. RECORD DRAWINGS. THE CONTRACTOR SHALL MAINTAIN ONE COMPLETE SET OF APPROVED DRAWINGS ON THE CONSTRUCTION SITE AT ALL TIMES WHEREON HE WILL RECORD ANY APPROVED DEVIATIONS IN CONSTRUCTION FROM THE APPROVED DRAWINGS. THESE FIELD RECORD DRAWINGS SHALL BE KEPT UP TO DATE AT ALL TIMES AND SHALL BE AVAILABLE FOR INSPECTION BE THE CITY UPON REQUEST.

21. THE LOCATION AND DESCRIPTIONS OF EXISTING UTILITIES SHOWN ON THE DRAWINGS ARE COMPLIED FROM

- THE PROVIDED ALTA SURVEY. CONTRACTOR SHALL FIELD VERIFY SIZE'S LOCATIONS OF ALL EXISTING UTILITIES PRIOR TO CONSTRUCTION.

 2. ALL EXISTING UTILITIES SHALL BE MAINTAINED IN PLACE BY THE CONTRACTOR UNLESS OTHERWISE SHOWN
- 22. ALL EXISTING UTILITIES SHALL BE MAINTAINED IN PLACE BY THE CONTRACTOR UNLESS OTHERWISE SHOWN OR DIRECTED. CONTRACTOR TO LEAVE EXISTING UTILITIES/FACILITIES IN AN EQUAL OR
- BETTER-THAN-ORIGINAL CONDITION.

 23. CONTRACTOR TO REVIEW SOILS REPORT AND CONFIRM TO ALL RECOMMENDATIONS LISTED IN IT.
- 24. THE CONTRACTOR SHALL BE RESPONSIBLE FOR MANAGING CONSTRUCTION ACTIVITIES TO ENSURE THAT PUBLIC STREETS AND RIGHT-OF-WAYS ARE KEPT CLEAN OF MUD, DUST OR DEBRIS. DUST ABATEMENT SHALL
- BE MAINTAINED BE ADEQUATE WATERING OF THE SITE BY THE CONTRACTOR.

 25. IMMEDIATELY FOLLOWING FINE GRADING OPERATIONS, COMPACT SUB GRADE TO 95% OF THE MAXIMUM DRY DENSITY PER AASHTO-180 TEST METHOD (MODIFIED PROCTOR). SUB GRADE MUST BE INSPECTED AND APPROVED BY A SOIL ENGINEERING PRIOR TO PLACING EMBANKMENTS OR BASE ROCK.
- 26. UNLESS OTHERWISE SHOWN ON DRAWINGS, STRAIGHT GRADES SHALL BE RUN BETWEEN ALL FINISH GRADE ELEVATIONS AND/OR FINISH CONTOUR LINES SHOWN. FINISH PAVEMENT GRADES AT TRANSITION TO EXISTING PAVEMENT GRADES OR BE FEATHERED PAST JOINTS WITH EXISTING PAVEMENT AS REQUIRED TO PROVIDE A SMOOTH, FREE DRAINING SURFACE.
- 27. ALL EXISTING OR CONSTRUCTED MANHOLES, CLEANOUTS, MONUMENTS, GAS VALVES, WATER VALVES AND SIMILAR STRUCTURES SHALL BE ADJUSTED TO MATCH FINISH GRADE OF THE PAVEMENT, SIDEWALK,
- LANDSCAPED AREA OR MEDIAN STRIP WHEREIN THEY LIE.

 28. ALL PLANTER AREAS SHALL BE BACKFILLED WITH APPROVED TOPSOIL MINIMUM 8" THICK. STRIPPING MATERIAL SHALL NOT BE USED FOR PLANTER BACKFILL.
- 29. CONTRACTOR SHALL HYDROUS ALL EXPOSED SLOPES AND DISTURBED AREAS WHICH ARE NOT SCHEDULED TO BE LANDSCAPED.
- 30. UNLESS OTHERWISE SHOWN OR INDICATED ON THE DRAWINGS, 6" NOMINAL CURB EXPOSURE USED FOR
- DESIGN OF ALL PARKING LOT AND STREET GRADES.

 31. SIDEWALKS AND DRIVEWAYS SHALL BE CONSTRUCTED TO THE FULL THICKNESS SHOWN.
- 32. CONTRACTOR SHALL COORDINATE AND PAY ALL COSTS (IF ANY) ASSOCIATED WITH RECONNECTING TO EXISTING WATER, SANITARY SEWER AND STORM SEWER FACILITIES.33. SANITARY AND STORM SEWER PIPES AND APPEARANCES SHALL BE TESTED FOR LEAKAGE. LEAKAGE TEST
- SHALL INCLUDE AN AIR TEST, ALL MANHOLES SHALL BE VACUUM TESTED FOLLOWING COMPLETION OF PAVING OR FINAL SURFACE.

 34. PRIOR TO MANDREL TESTING AND/OR TV INSPECTION, FLUSH AND CLEAN ALL PIPES AND REMOVE ALL
- FOREIGN MATERIAL FROM MAINLINES AND MANHOLES.

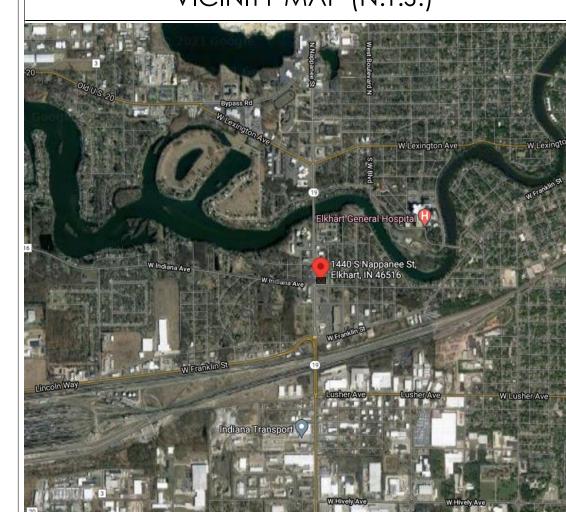
 35. CONTRACTOR SHALL CONDUCT DEFLECTION TEST (MANDREL TEST) OF ALL SANITARY AND STORM SYSTEM
- 36. PRIOR TO FINAL GRADE AND PAVING, CONTRACTOR SHALL CONDUCT A COLOR TV ACCEPTANCE INSPECTION OF ALL SANITARY AND STORM SYSTEM PIPES. THE TV INSPECTION SHALL BE CONDUCTED BY AN APPROVED TECHNICAL SERVICES WHICH IS EQUIPPED TO MAKE AUDIO-VISUAL RECORDINGS OF THE TV INSPECTIONS ON DVD. THE DVD AND WRITTEN REPORT SHALL BE DELIVERED TO THE OWNER.

STANDARD SPECIFICATIONS

GENERAL CONTRACTOR TO REFERENCE STANDARD SPECIFICATIONS OF THE CITY OF ELKHART WHICH CAN BE FOUND IN DIVISION C OF THE PROVIDED LINK.

https://elkhartindiana.org/wpfd_file/standard-specifications-for-construction-2019

VICINITY MAP (N.T.S.)





SITE AREA

TOTAL SITE AREA:

BUILDING AREA:

40,776 SF (0.94 ACRES)

3,130 SF

NUMBER OF PARKING SPACES REQUIRED/PROVIDED: 29 SPACES

NUMBER OF HANDICAP SPACES: 2 (1 VAN ACCESSIBLE)

Solution State Bull Ding And Browners and Rechirch Technical Review Meeting Revised Solution Submitted Revised Revised

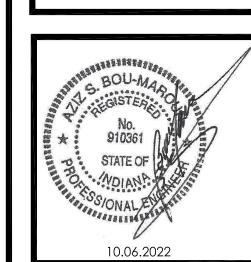




TECHNICAL

GROUP INC.
27300 HAGGERTY RD. SUITE F2
FARMINGTON HILLS, MI 48331
P:(248) 426-8000 F:(248) 426-7004








PROJECT
BURGER KING
1440 NAPPANEE ST,
ELKHART, IN 46514
ELKHART, IN 46514
SHEET TITLE
GRADING/UTILITY PLAN

SHEET C-5

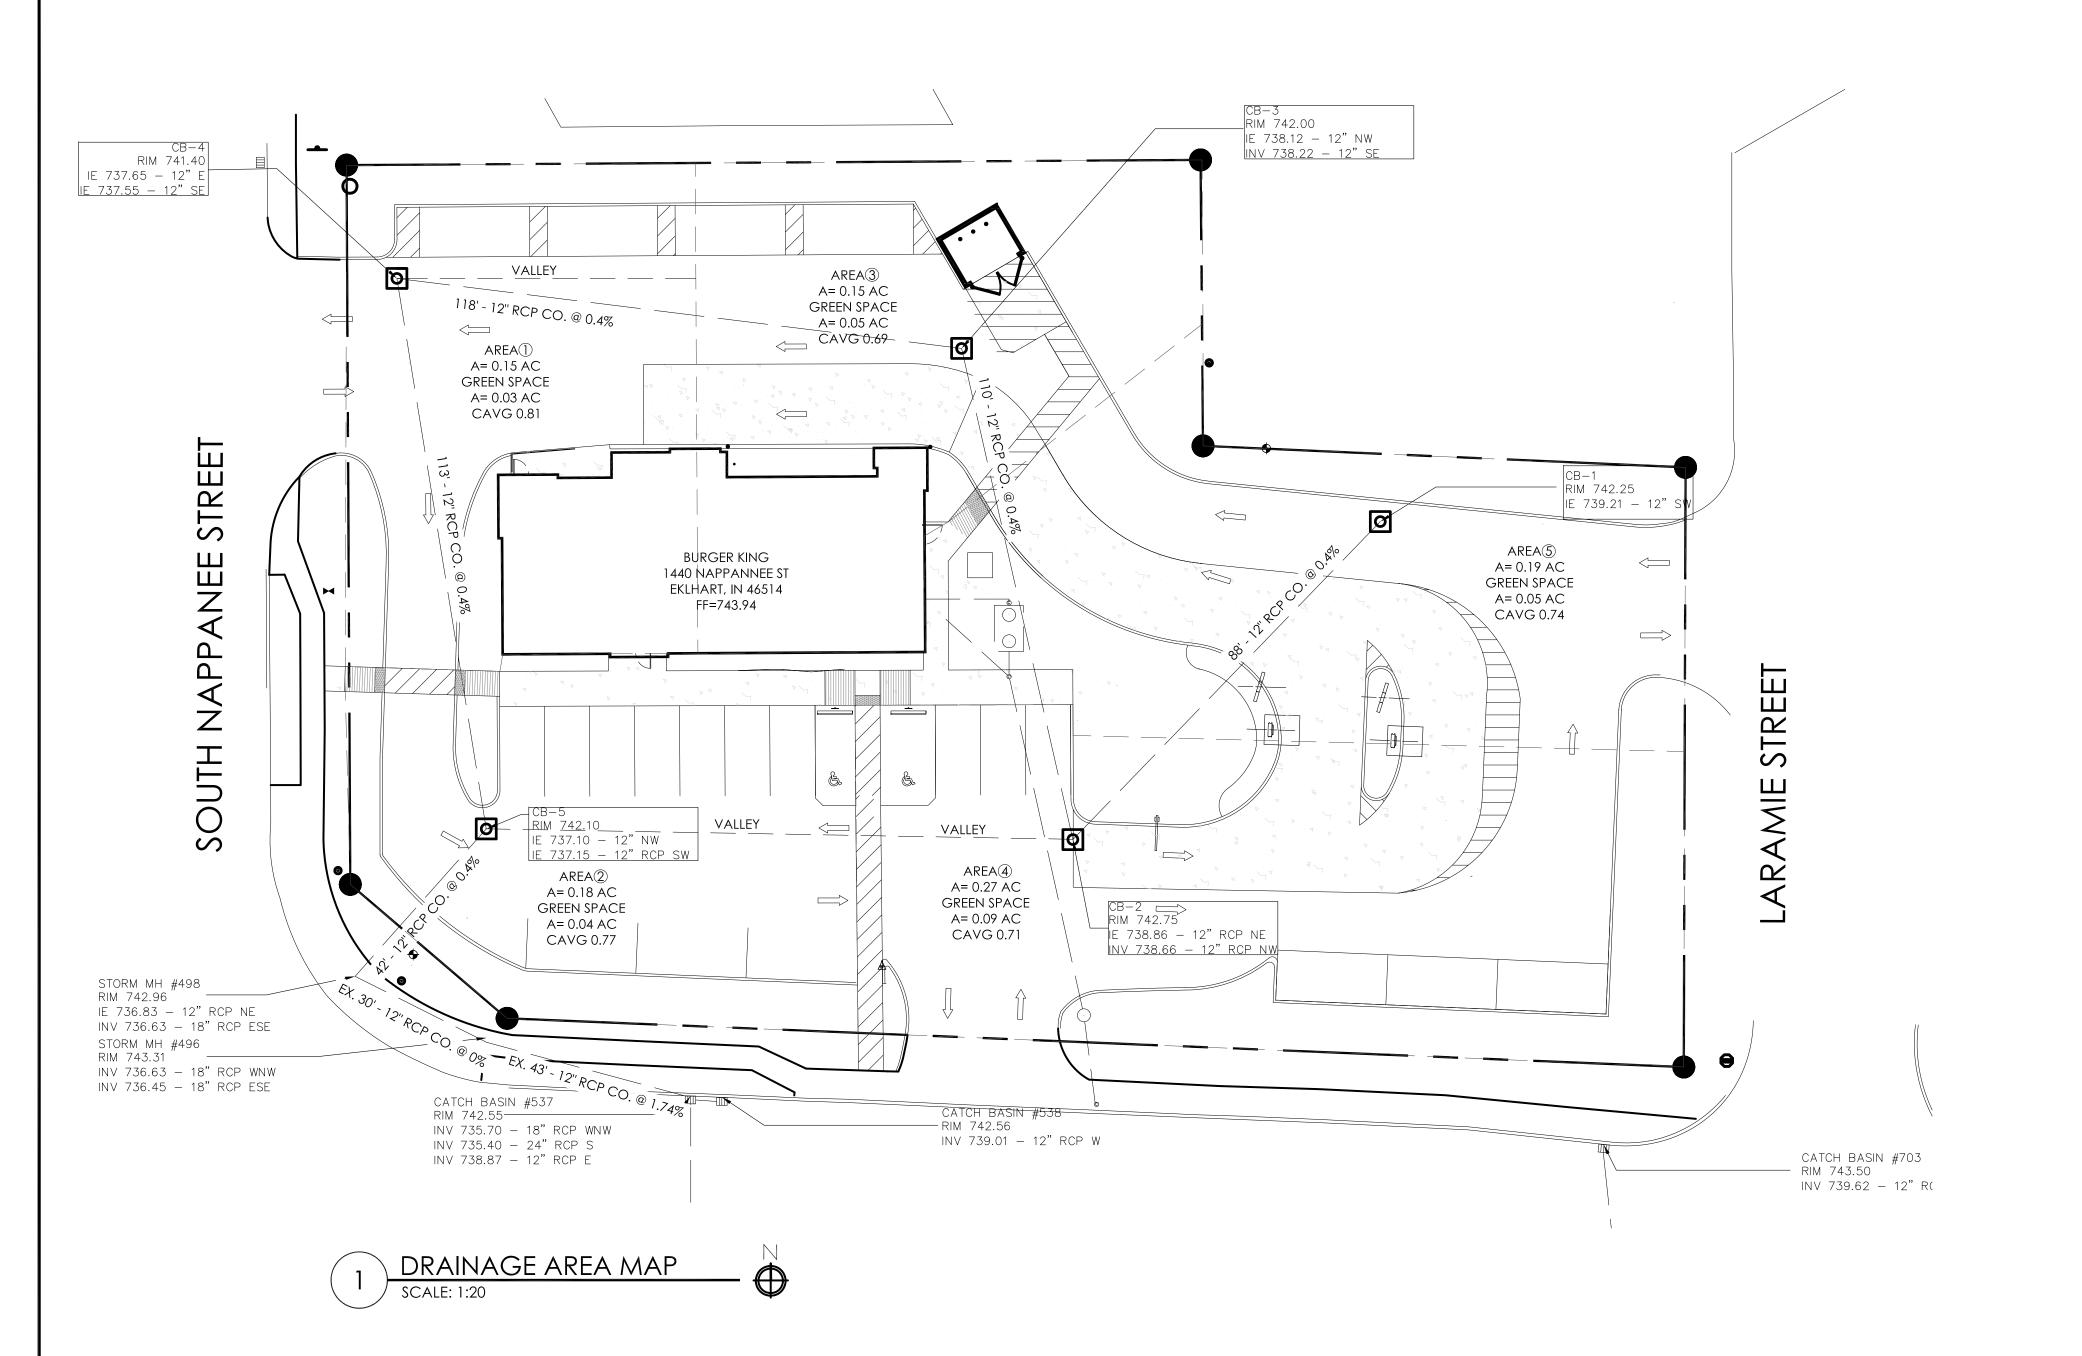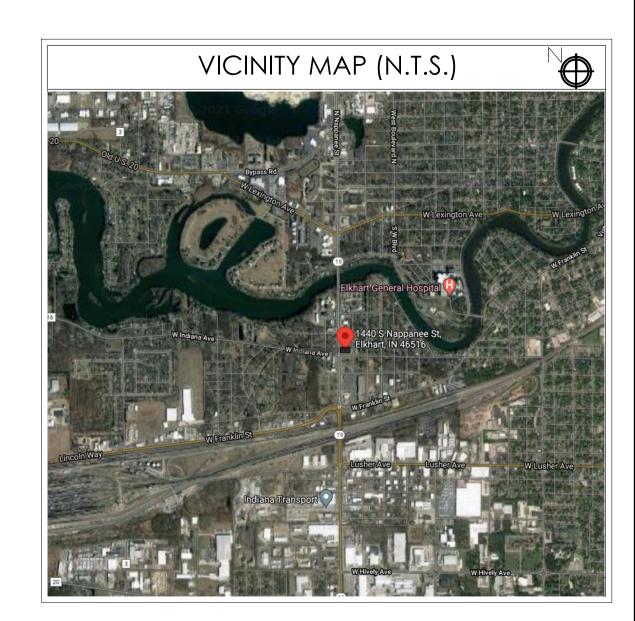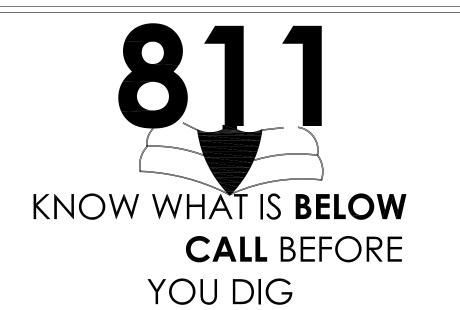TG-21668










SITE AREA	
TOTAL SITE AREA:	40,776 SF (0.94 ACRES)
BUILDING AREA:	3,130 SF
NUMBER OF PARKING SPACES REQUIRED/PROVIDED:	29 SPACES
NUMBER OF HANDICAP SPACES:	2 (1 VAN ACCESSIBLE)


R	UNOFF CO	DEFIECNT (CALCULA	ATION
Area	Total Area	Impervious Area	Pervious Area	Average Runoff Coeffiecient
1	0.16	0.13	0.03	0.8
2	0.18	0.14	0.04	0.
3	0.15	0.10	0.05	0.0
4	0.27	0.18	0.09	0.7
5	0.19	0.14	0.05	0.7
Total Area	0.95	0.69	0.26	

FROM M.H.	ТО М.Н.	Incr. AREA	C (Avg) FACTOR	Equiv	TOTAL Eg Area	TIME	Inten. in./hr.	FLOW-Q CFS	SUM of Flows	Pipe Size	n	SLOPE L	ENGT⊢ C	CAPACITY	VELOCITY FULL FLOW	TIME min.	Upstream HG	ELEV.	SEWER IN	VERT Lower En
		Acre		Area (CxA)	•					in.								Upper End	Upper End	
CB1	CB2	0.190	0.74	0.14	0.14	20.00	3.89	0.55	0.55	12	0.013	0.40%	88	2.25	2.87	0.51	740.01	742.75	739.21	738
CB2	CB3	0.270	0.71	0.19	0.33	20.51	3.85	0.74	1.28	12	0.013	0.40%	110	2.25	2.87	0.64	739.46	742.75	738.66	738
CB3	CB4	0.150	0.69	0.10	0.44	21.15	3.79	0.39	1.65	12	0.013	0.40%	118	2.25	2.87	0.69	738.92	742.00	738.12	737
CB4	CB5	0.150	0.81	0.12	0.56	21.84	3.74	0.45	2.08	12	0.013	0.40%	113	2.25	2.87	0.66	738.35	741.40	737.55	737
CB5	MH 478	0.180	0.77	0.14	0.70	22.49	3.68	0.51	2.56	12	0.013	0.40%	42	2.25	2.87	0.24	738.57	742.10	737.10	736
ИН 498	MH 496			0.14	0.70	22.74	3.67	0.51	2.55	18	0.013		30				738.59	742.96	736.63	736
ИН 496	EXCB 537			0.14	0.70	22.74	3.67	0.51	0.51	18	0.013	1.74%	43	13.85	7.84	0.09	738.59	743.31	736.45	738

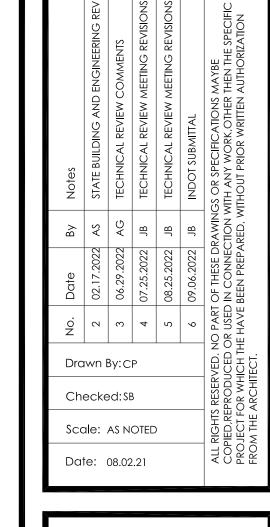

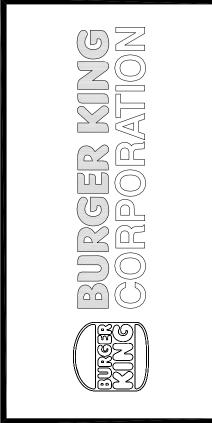

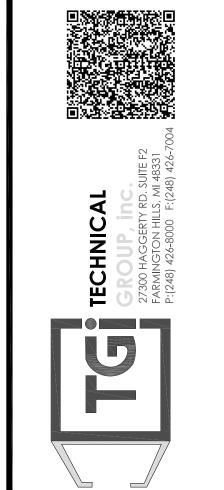

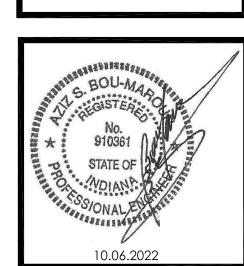

PROJECT
BURGER KING
1440 NAPPANEE ST,
ELKHART, IN 46514
ELKHART, IN 46514
SHEET TITLE
DRAINAGE AREA MAP

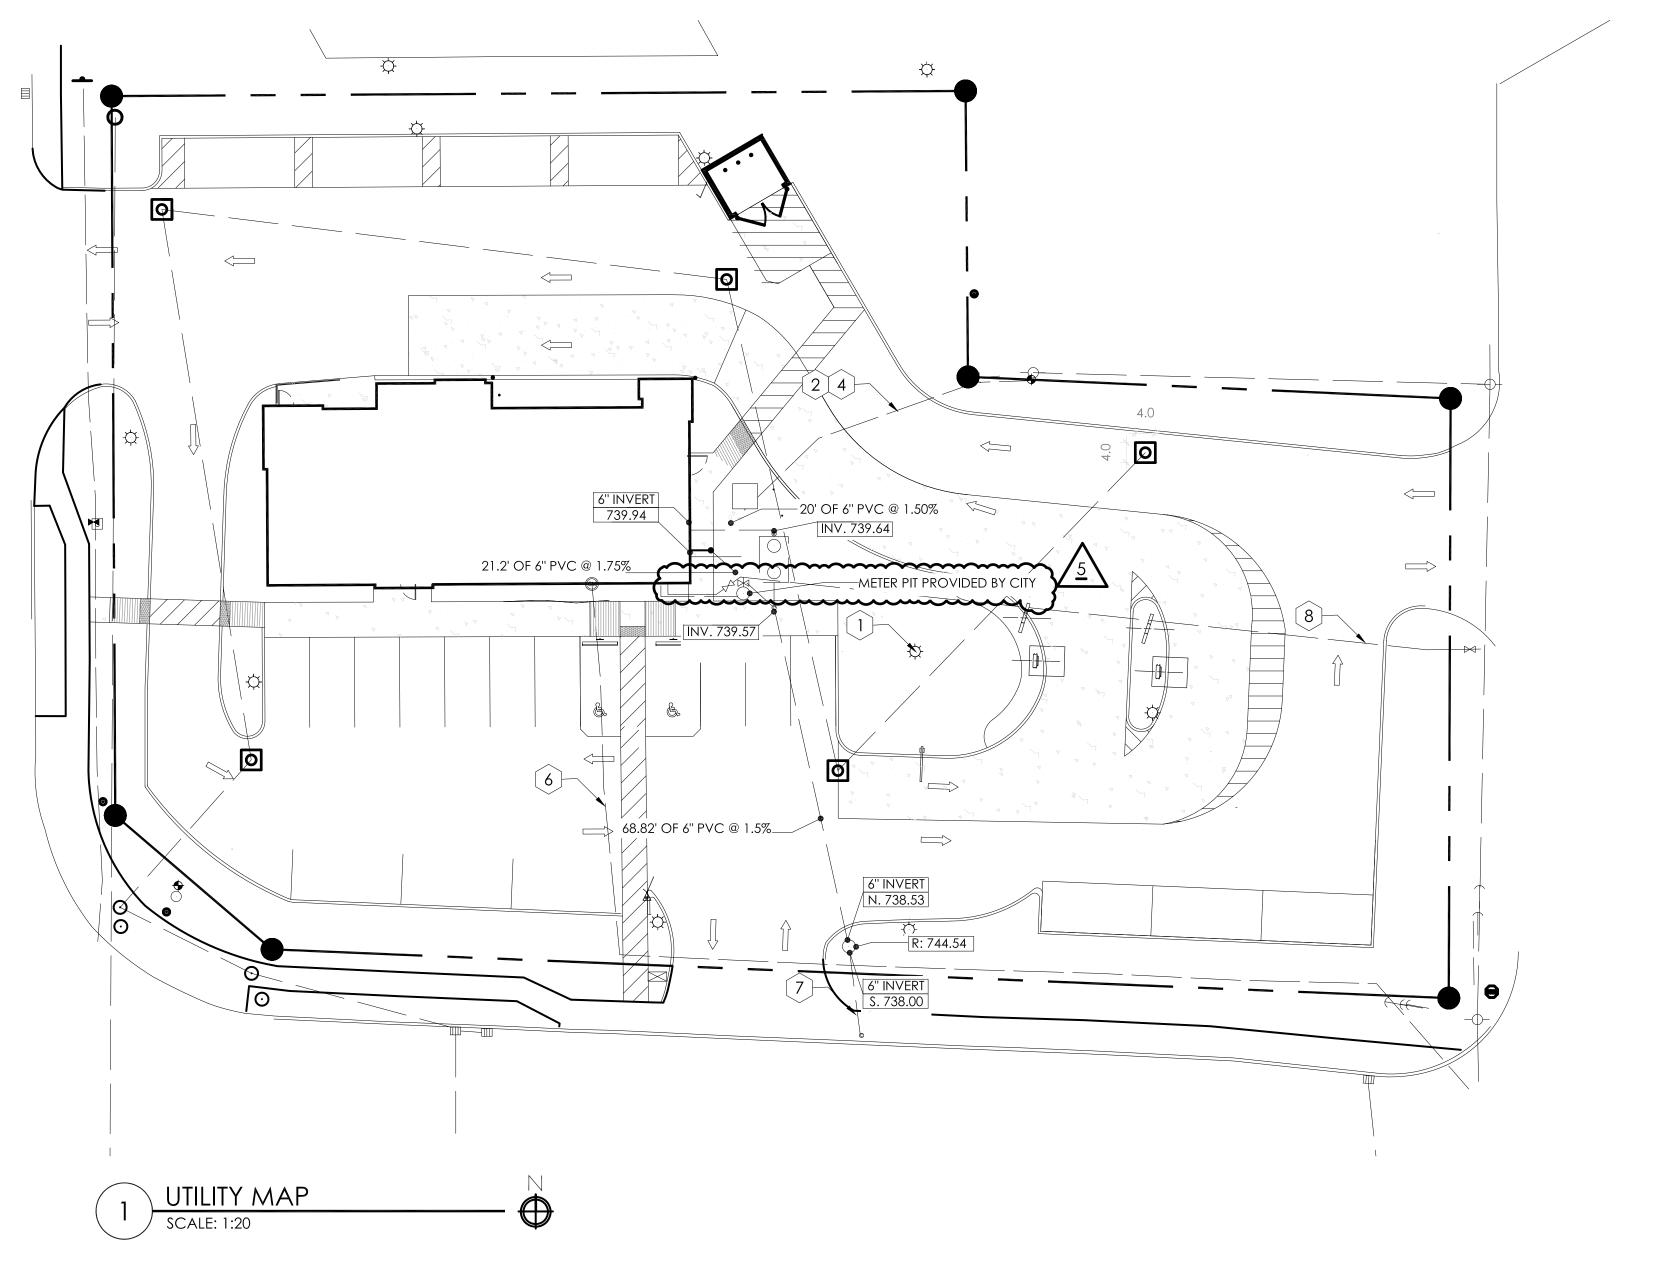
STANDARD SPECIFICATIONS

GENERAL CONTRACTOR TO REFERENCE STANDARD SPECIFICATIONS OF THE CITY OF ELKHART WHICH CAN BE FOUND IN DIVISION C OF THE PROVIDED LINK.

https://elkhartindiang.org/wpfd_file/standard-specifications-for-construction-2019/

738.59 742.96 736.63 736.63 5 7.84 0.09 738.59 743.31 736.45 735.70

Beginning H.G= 737.00



GENERAL NOTES

- A. THE CONTRACTOR SHALL SUPPLY AND INSTALL ALL ITEMS AND PERFORM ALL WORK NOT COVERED BY UTILITY COMPANIES. CONTRACTOR SHALL VERIFY ORIGIN OF SERVICE, INSTALLATION PROCEDURES, AND ALL STANDARDS FOR WORK WITH UTILITY COMPANIES PRIOR TO CONSTRUCTION. ON SITE TRENCHING SHALL BE MINIMIZED WHEN POSSIBLE. UTILITIES, CONDUITS, AND IRRIGATION SHALL MAKE USE OF SHARED TRENCHING WHEN PERMITTED. FOR TRENCHING INFORMATION, SEE DETAIL.
- B. CONTRACTOR IS RESPONSIBLE FOR FIELD VERIFYING ALL UTILITY SIZES, TYPES, AND LOCATIONS SHOWN ON PLANS. ALL UTILITY WORK SHALL BE IN COMPLIANCE WITH ALL FEDERAL, STATE, AND LOCAL REGULATIONS. NOTIFY THE ENGINEER IMMEDIATELY OF ANY DISCREPANCY FOUND BETWEEN THE FIELD CONDITIONS, THESE PLANS, AND/OR GOVERNING REGULATIONS.
- C. ALL PIPE LENGTHS ARE APPROXIMATE FROM CENTER OF STRUCTURE TO CENTER OF STRUCTURE.
- D. PROVIDE CLEANOUTS, AS INDICATED BY "CO" OR "DCO", ON ALL SANITARY SEWER LATERALS.
- E. EXISTING SANITARY MAIN LOCATED BY GIS DATA. CONTRACTOR SHALL FIELD LOCATE AND VERIFY DEPTHS PRIOR TO CONSTRUCTION.

VICINITY MAP (N.T.S.)





SITE AREA

TOTAL SITE AREA:

BUILDING AREA:

NUMBER OF PARKING SPACES REQUIRED/PROVIDED:

NUMBER OF HANDICAP SPACES:

3,130 SF 29 SPACES

40,776 SF (0.94 ACRES)

2 (1 VAN ACCESSIBLE)

STANDARD SPECIFICATIONS

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KEYED NOTES (X)

- 1. SITE LIGHT. SEE SITE LIGHTING ELECTRICAL PLAN AND PHOTOMETRIC PLAN
- 2. PROPOSED UNDERGROUND ELECTRIC SERVICE. CONTRACTOR TO INSTALL SERVICE PER ALL STATE AND LOCAL CODES, POWER COMPANY, N.F.P.A., AND N.E.C. STANDARDS AND COORDINATE WITH THE POWER COMPANY TO VERIFY THE TRANSFORMER LOCATION, SIZE, ORIGIN OF SERVICE, AND ALL STANDARDS FOR WORK. MINIMUM CONDUIT COVER SHALL BE 3 FT. SEE ARCHITECTURAL SHEETS FOR SECONDARY WIRING DESIGN. DIVISION OF WORK SHALL BE AS FOLLOWS: UTILITY COMPANY IS RESPONSIBLE FOR INSTALLING TRANSFORMER, FINAL CONNECTION, SOCKET AND METER. GENERAL CONTRACTOR IS RESPONSIBLE FOR INSTALLING SECONDARY CONDUCTORS AND CONDUIT, CT CABINET, TRANSFORMER PAD (IF REQUIRED) AND TRENCHING AND BACKFILL.
- 3. PROPOSED UNDERGROUND TELEPHONE SERVICE. VERIFY EXACT ROUTING AND TERMINATION REQUIREMENTS WITH TELEPHONE COMPANY BEFORE STARTING WORK. CONTRACTOR TO COORDINATE WITH OTHER UTILITIES AND UTILIZE SHARED TRENCHING IF PERMITTED. MINIMUM CONDUIT COVER SHALL BE 3 FT. GENERAL CONTRACTOR TO COORDINATE WITH UTILITY COMPANY ON POINT OF CONNECTION. DIVISION OF WORK SHALL BE AS FOLLOWS: UTILITY COMPANY IS RESPONSIBLE FOR PROVIDING AND INSTALLING CABLE, AND FINAL CONNECTION. GENERAL CONTRACTOR IS RESPONSIBLE FOR PROVIDING AND INSTALLING CONDUIT (WITH PULL WIRE), AND TRENCHING AND BACKFILL.
- PROPOSED OVERHEAD ELECTRIC SERVICE FROM EXISTING SERVICE POLE TO EXISTING UTILITY POLE. CONTRACTOR TO INSTALL SERVICE PER ALL STATE AND LOCAL CODES, POWER COMPANY, N.F.P.A., AND N.E.C. STANDARDS AND COORDINATE WITH THE POWER COMPANY TO VERIFY THE TRANSFORMER LOCATION, SIZE, ORIGIN OF SERVICE, AND ALL STANDARDS FOR WORK.
- PROPOSED OVERHEAD TELEPHONE SERVICE FROM EXISTING SERVICE POLE TO EXISTING UTILITY POLE. VERIFY EXACT ROUTING AND TERMINATION REQUIREMENTS WITH TELEPHONE COMPANY BEFORE STARTING WORK. CONTRACTOR TO COORDINATE WITH OTHER UTILITIES AND UTILIZE SHARED TRENCHING IF PERMITTED. GENERAL CONTRACTOR TO COORDINATE WITH UTILITY COMPANY ON POINT OF CONNECTION.
- PROPOSED NATURAL GAS SERVICE. ALL MATERIALS AND INSTALLATION ARE TO BE IN ACCORDANCE WITH ALL STATE AND LOCAL CODES AND N.F.P.A. STANDARDS. DIVISION OF WORK SHALL BE AS FOLLOWS: UTILITY COMPANY IS RESPONSIBLE FOR PROVIDING AND INSTALLING THE TAP AND METER GENERAL CONTRACTOR IS RESPONSIBLE FOR PROVIDING AND INSTALLING THE REGULATOR, PIPING, COPPER LOCATOR WIRE, DITCH TAPE, AND TRENCHING AND BACKFILL.
- 6" SANITARY SEWER LATERAL. SEE NOTE E. PIPE SHALL BE P.V.C. ASTM D-3034 SDR 35. JOINTS SHALL CONFORM TO ASTM D-3212. PROVIDE CLEANOUTS AS INDICATED BY "CO" OR "DCO" PER DETAIL. COORDINATE LOCATION OF SANITARY SEWER LATERAL THROUGH FOUNDATION WITH STRUCTURAL DRAWINGS. MAINTAIN A MINIMUM OF 10' HORIZONTAL AND 18" VERTICAL SEPARATION FROM WATER.
- 8. DOMESTIC WATER SERVICE. THE WATER LINE, VALVES, AND FITTINGS SHALL BE INSTALLED PER UTILITY PROVIDER REQUIREMENTS INCLUDING THE WATER METER AND BACKFLOW DEVICE. CONTRACTOR TO VERIFY REQUIREMENTS OF LOCAL CODES, UTILITY COMPANIES AND GOVERNING OFFICIALS. PIPING SHALL BE TYPE 'K' COPPER. INCLUDE IN BASE BID ALL VALVES, PIPING STRUCTURES, ETC. THAT WILL BE REQUIRED. MINIMUM DEPTH OF WATER LINE SHALL BE 4'. DIVISION OF WORK SHALL BE AS FOLLOWS: GENERAL CONTRACTOR IS RESPONSIBLE FOR PROVIDING AND INSTALLING VALVES, PIPING, FITTINGS, METER IN BUILDING, AND BACKFLOW PREVENTER INSIDE BUILDING.

PROPOSED MINIMUM 1,575 GALLONS GREASE

10. EXISTING UTILITY POLE, UTILITY CONTRACTOR TO INSTALL TRANSFORMER AS NECESSARY.

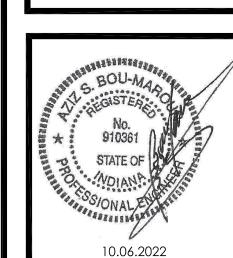
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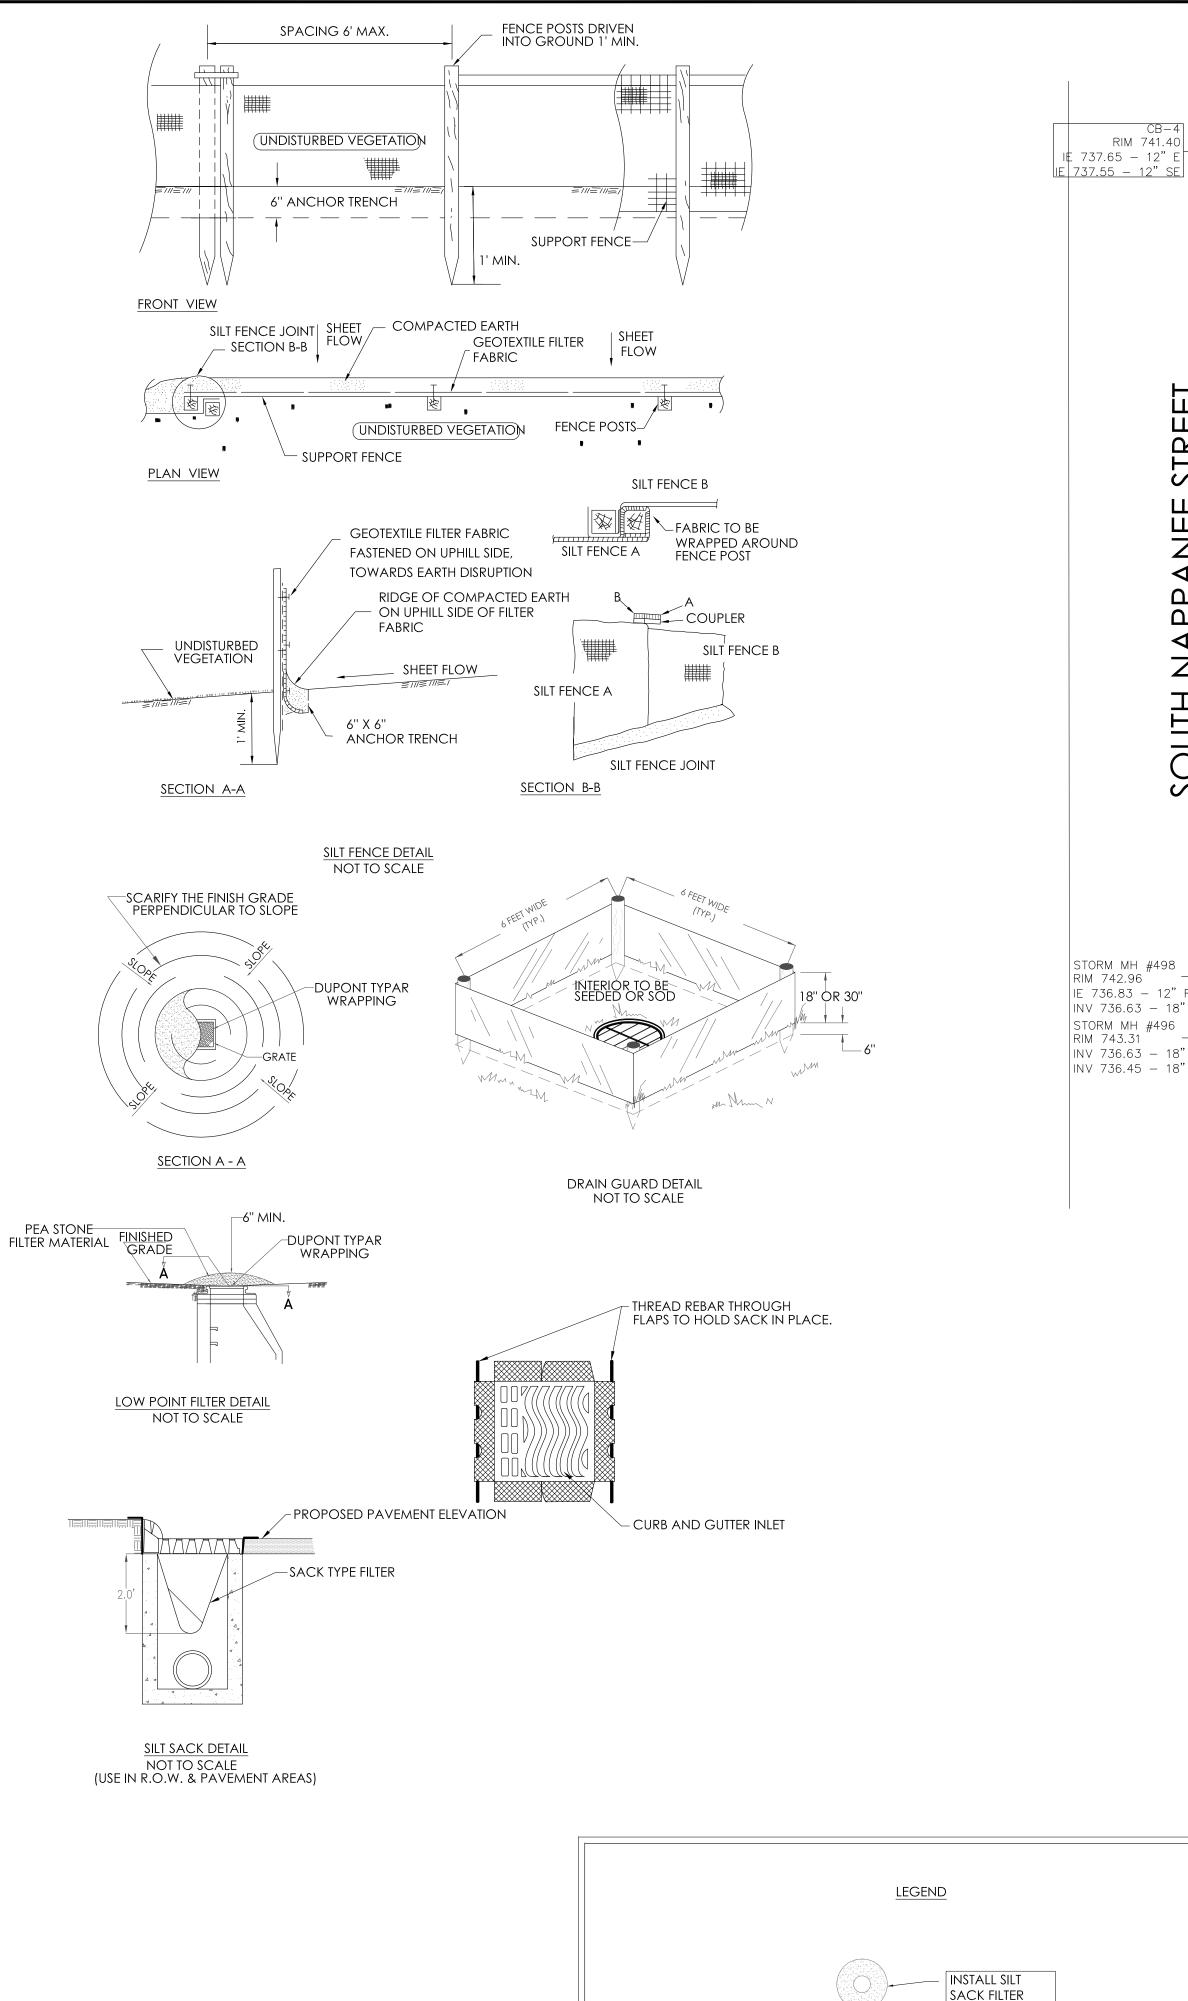








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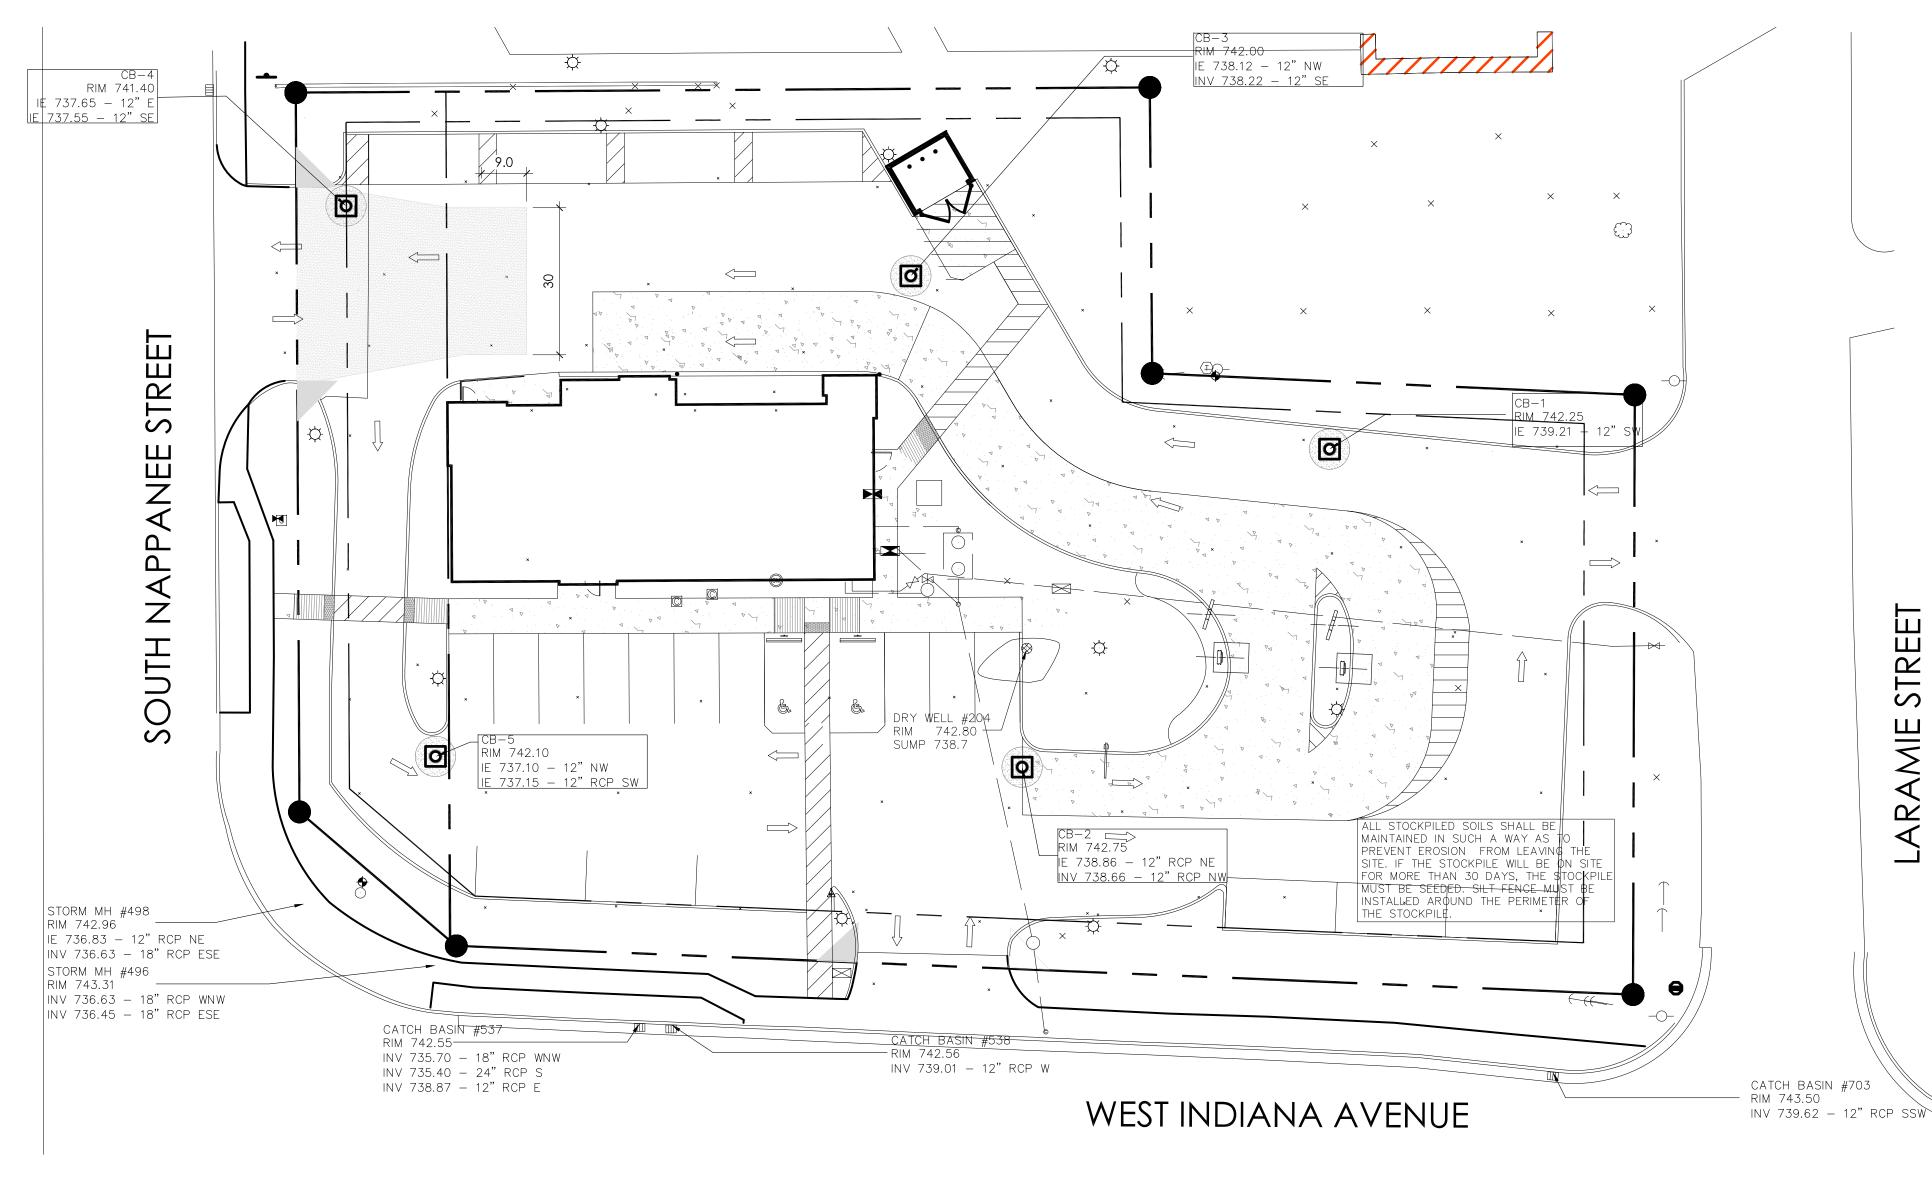


STANDARD SPECIFICATIONS

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ELKHART WHICH CAN BE FOUND IN DIVISION C OF THE PROVIDED LINK.



SOIL EROSION SITE PLAN
SCALE: 1:20

SOIL EROSION AND SEDIMENTATION CONTROL:

1. ALL EROSION AND SEDIMENT CONTROL WORK SHALL CONFORM TO CURRENT STANDARDS AND SPECIFICATIONS OF ELKHART, INDIANA

2. DAILY INSPECTION SHALL BE MADE BY THE CONTRACTOR TO DETERMINE EFFECTIVENESS OF EROSION AND SEDIMENT CONTROL MEASURES, AND ANY NECESSARY REPAIRS SHALL BE PERFORMED WITHOUT ANY DELAY.

3. EROSION AND ANY SEDIMENTATION FROM WORK ON THIS SITE SHALL BE CONTAINED ON THE SITE AND NOT ALLOWED TO COLLECT ON ANY OFF-SITE AREAS OR WATERWAYS. WATERWAYS INCLUDE BOTH NATURAL AND MAN-MADE DITCHES, STREAMS, STORM DRAINS, LAKES AND PONDS.

4. EROSION AND SEDIMENT CONTROL MEASURES ARE TO BE PLACED, PRIOR TO, OR AS THE FIRST STEP IN, CONSTRUCTION. SEDIMENT CONTROL PRACTICES SHALL BE APPLIED AS A PERIMETER DEFENSE AGAINST ANY TRANSPORTATION OF SILT OFF THE SITE.

5.. CONTRACTOR SHALL APPLY TEMPORARY EROSION AND SEDIMENTATION AS REQUIRED AND AS DIRECTED IN THESE PLANS. HE SHALL REMOVE TEMPORARY MEASURES AS SOON AS PERMANENT STABILIZATION OF SLOPES, DITCHES, AND OTHER EARTH CHANGES HAS BEEN ACCOMPLISHED.

6. PERMANENT SOIL EROSION CONTROL MEASURES FOR ALL SLOPES, CHANNELS, DITCHES, OR ANY DISTURBED LAND AREA SHALL BE COMPLETED WITHIN 15 CALENDAR DAYS AFTER FINAL GRADING, OR THE FINAL EARTH CHANGE HAS BEEN COMPLETED. WHEN IT IS NOT POSSIBLE TO STABILIZE A DISTURBED AREA AFTER AN EARTH CHANGE ACTIVITY CEASES, TEMPORARY SOIL EROSION CONTROL MEASURES SHALL BE IMPLEMENTED & MAINTAINED UNTIL PERMANENT

SOIL EROSION CONTROL MEASURES ARE IMPLEMENTED.

ALL PERMANENT SOIL EROSION CONTROL MEASURES WILL BE IMPLEMENTED AND ESTABLISHED BEFORE A CERTIFICATE OF

COMPLIANCE IS ISSUED. 7. ALL MUD/DIRT TRACKED ONTO EXISTING CITY/ COUNTY/STATE ROADS FROM THIS SITE, DUE TO CONSTRUCTION, SHALL BE PROMPTLY REMOVED BY THE CONTRACTOR/BUILDER.. ALL MUD/DIRT TRACKED OR SPILLED ON PAVED ROADS/SURFACES WITHIN THE SITE SHALL BE PROMPTLY REMOVED BY THE

CONTRACTOR/BUILDER. 8. PLACE GEOTEXTILE FILTER CLOTH ON ALL

REPLACEMENT.

CATCH BASINS DURING CONSTRUCTION. CONSTRUCTION SHALL BE RESTORED TO EQUAL OR BETTER THAN ORIGINAL EXISTING CONDITIONS. ALL RESTORATION SHALL CONSIST OF A MIN. OF 4"TOPSOIL W/SEED AND MULCH OR 3"OF TOPSOIL AND CLASS "A" SOD WHERE EXISTING CONDITION REQUIRE SOD

SOIL EROSION CONTACT PERSON TECHNICAL GROUP ATTENTION: SHAHEEN

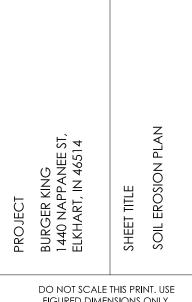


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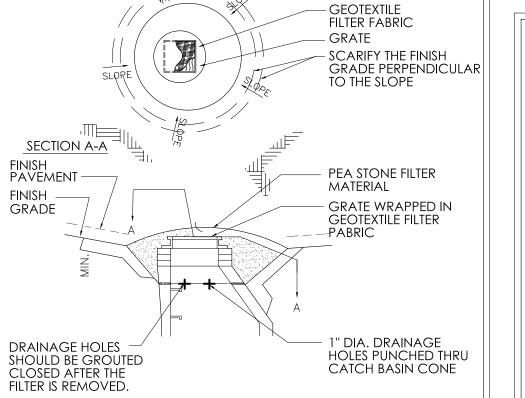
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Date: 08.02.21



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SOIL EROSION AND SEDIMENTATION CONTROL SEQUENCE:

1. PLACE A SILT FENCE ALONG BOUNDARY LINES AS

SHOWN ON PLAN & INSTALL TEMPORARY ACCESS DRIVE. 2. INSTALL UNDERGROUND UTILITIES & INSTALL INLET FILTERS 3. CONTRACTOR SHALL SHAPE AND PREPARE SUB GRADE TO ELEVATIONS AND CROSS SECTIONS SHOWN ON PLANS.

BEGIN BUILDING CONSTRUCTION. 4. MAINTAIN EROSION AND SEDIMENTATION CONTROL

MEASURES. 5. BRING PAVEMENT AREAS TO SUBGRADE BASE, REMOVE PARKING LOT FILTER AND PLACE PERMANENT COVERS

AFTER PAVEMENT. 6. FINISH GRADING, REDISTRIBUTE TOP SOIL.

7. COMPLETE CONSTRUCTION OF BUILDING.

8. AFTER PAVING CONSTRUCTION, ALL DISTURBED AREAS SHALL BE TOP DRESSED WITH 3" TOP SOIL. AREAS BETWEEN EDGE OF PAVEMENT AND R.O.W. LINE TO BE SODDED, SEEDED AND MULCHED OR HYDRO SEEDED 15 DAYS AFTER PAVEMENT HAS BEEN INSTALLED. (WEATHER CONDITIONS PERMITTING).

PROFILE VIEW

PARKING LOT INLET FILTER DETAIL

TEMPORARY GRAVEL

ACCESS DRIVE FOR

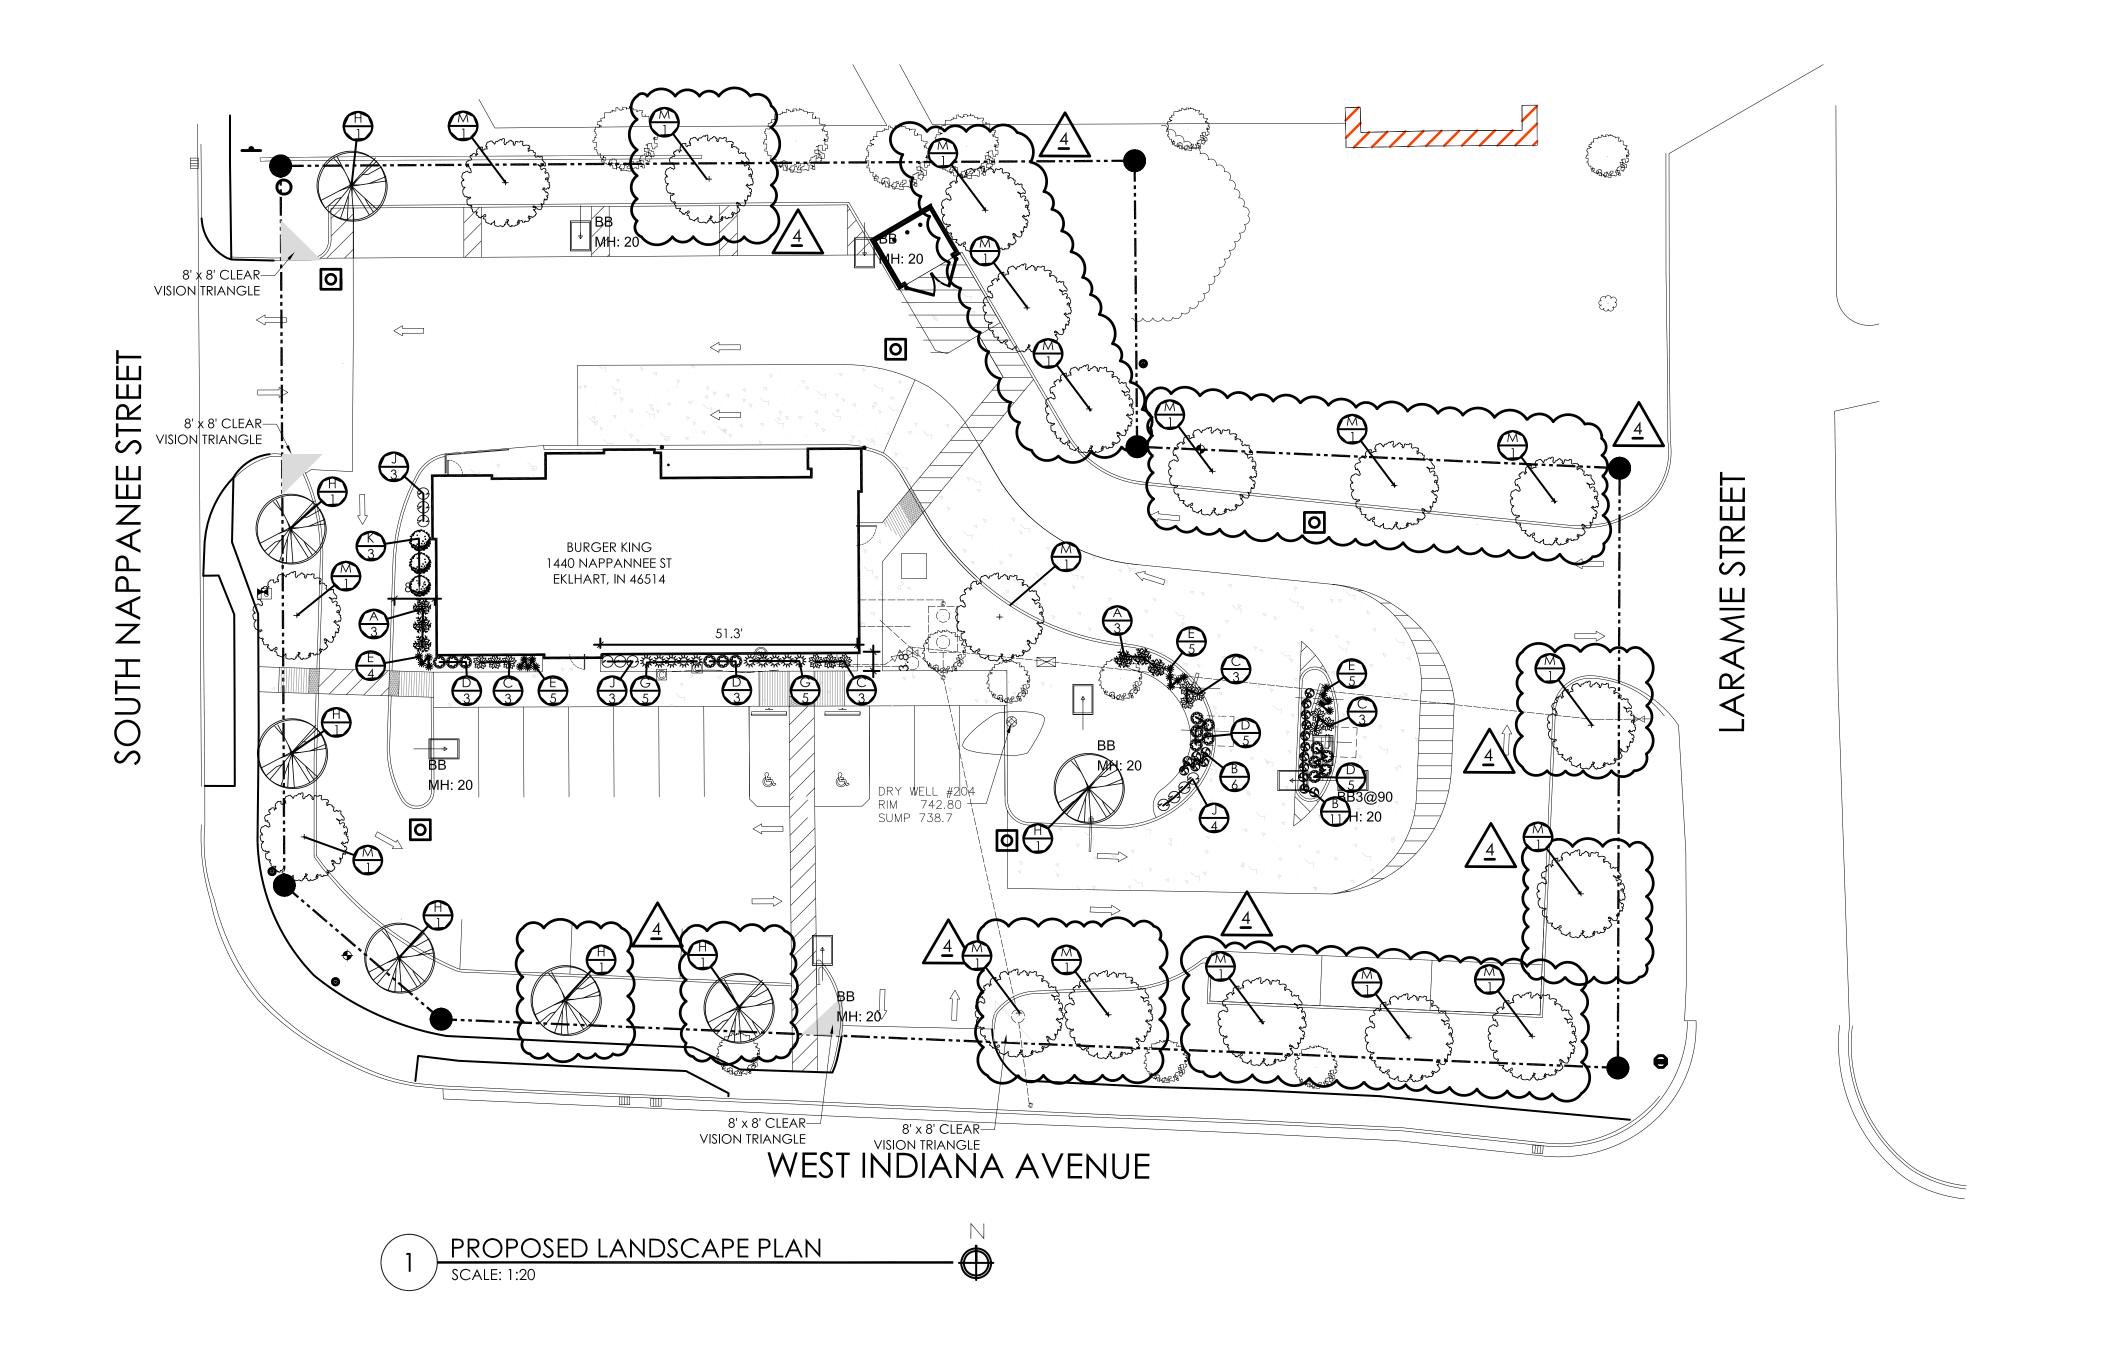
CONSTRUCTION

30'x40'x6" THICK

- SILT FENCE

9. ALL ONSITE AND OFFSITE AREAS DISTURBED BY

248-426-8000



STANDARD SPECIFICATIONS

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ELKHART WHICH CAN BE FOUND IN DIVISION C OF THE PROVIDED LINK.

INTERIOR LANDSCAPE CALCULATION

40,776

2,000 INTERIOR LANDSCAPE SF: CALCULATION: 2,000 / 40,776 = .05

TOTAL INTERIOR LANDSCAPE COVERAGE REQUIRED:

TOTAL INTERIOR LANDSCAPE COVERAGE PROVIDED:

		PL	ANT LISTING				
				PLANTING	MATU	RE SIZE	
KEY	QTY	BOTANICAL NAME	COMMON NAME	HEIGHT	HEIGHT	SPREAD	TYPE
Α	6	HYDRANGEA ARBORESCENS	ANNABELLE HYDRANGEA	24" (MIN.)	3'-5'	3'-5'	POT
В	17	CALAMAGROSTIS 'KARL FOERSTER'	KARL'S FOERSTERS	24" (MIN.)	4'-5'	12''-24''	GAL
С	12	HOSTAS SPECIES	HOSTA	24" (MIN.)	2'-3'	2'-3'	POT
D	16	CARYOPTERIS X CLANDONENSIS 'BLUE'	BLUE MIST SPIREA	12" (MIN.)	16"-24"	24"-30"	POT
Е	19	HEMEROCALLIS 'LITTLE GRAPETTE'	'LITTLE GRAPETTE' DAYLILY	8" (MIN.)	8"-12"	10"-16"	GAL
F	0	'TAXUS X MEDIE 'HICKSII	HICKS YEW	36" (MIN.)	2'-3'	3'-6'	POT
G	10	PENNISETUM ALOPECUROIDES 'LITTLE BUNNY'	LITTLE BUNNY FOUNTAIN GRASS	36" (MIN.)	8'-10'	24"-30"	GAL
Н	7	SYRINGA RETICULATA	JAPANESE LILAC TREE	10' (MIN.)	20'-30'	15'-20'	POT
J	10	LAVANDULA ANGUSTIFOLIA 'HIDCOTE'	ENGLISH LAVENDER	16" (MIN.)	16"-24"	24"-30"	POT
K	3	BERVERUS THUNBERGII 'ATROPURPUREA NANA'	BARBERRY 'CRIMSON PYGMY'	24" (MIN.)	3'-4'	3'-5'	POT
L	0	THUJA OCCIDENTALIS	ARBORVITAE - PYRAMIDALIS	6' (MIN.)	8'-10'	3'-6'	POT
Μ	18	QUERCUS RUBRA	RED OAK TREE	10' (MIN.)	40'-60'	30'-50'	POT

TOTAL SITE SF:

LANDSCAPE NOTES:

PLANTING:

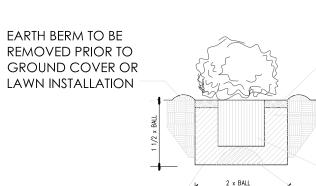
- INSTALLATION OF ALL PLANT MATERIALS SHALL BE IN ACCORDANCE WITH THE LATEST EDITION OF THE AMERICAN ASSOCIATION OF NURSERYMEN LANDSCAPE STANDARDS AND WITH THE SPECIFICATIONS SET FORTH BY THE CITY OF ELKHART, IN.
- IT IS THE RESPONSIBILITY OF THE PROPERTY OWNER TO MAINTAIN THE LANDSCAPING INSTALLED SO THAT IT IS HEALTHY, NEAT AND ORDERLY IN APPEARANCE AND IS FREE FROM REFUSE AND DEBRIS.
- ALL PLANTINGS SHALL BE COMPLETED WITHIN THREE (3) MONTHS, AND NO LATER THAN NOVEMBER 30, FROM THE DATE OF ISSUANCE OF A CERTIFICATE OF OCCUPANCY IF SUCH CERTIFICATE IS ISSUED DURING THE APRIL 1 - SEPTEMBER 30 PERIOD; IF THE CERTIFICATE IS ISSUED DURING THE OCTOBER 1 - MARCH 31 PERIOD; PLANTING SHALL BE COMPLETED NO LATER THAN THE ENSUING MAY 31; PLANTINGS SHALL THEREAFTER BE REASONABLY MAINTAINED, INCLUDING PERMANENCE AND HEALTH OF PLANT MATERIALS TO PROVIDE A SCREEN TO ABUTTING PROPERTIES AND
- INCLUDING THE ABSENCE OF WEEDS AND REFUSE. ALL PLANTING BEDS TO BE FILLED WITH FOUR INCHES (3") OF RIVER ROCK. PLANTING BEDS TO HAVE ONE-EIGHTH BY FOUR INCH (1/8"X4") BLACK ANODIZED PERMA-LOC ALUMINUM EDGING, OR APPROVED EQUIVALENT,
- DIG SHRUB PITS ONE FOOT (1') LARGER THAN THE SHRUB ROOTBALL, TREE PITS TWO FOOT(2') THAN TREE ROOTBALLS AND BACKFILL WITH ONE (1)
- PART TOP SOIL AND ONE(1) PART SOIL FROM EXCAVATED PIT. REMOVE TWINE AND WIRE FROM ROOTBALL AND PLANT TOPS. ORGANIC FRIABLE TOPSOIL SHALL BE EVENLY DISTRIBUTED AND FINE GRADED OVER ALL AREAS TO RECEIVE LAWNS AT UNIFORM DEPTH OF FOUR INCHES AFTER SETTLEMENT.
- ALL NEW LAWN AREAS SHALL BE SODDED WITH A GRADE A SOD PLANTED OVER THE TOPSOIL.
- TREES IN LAWN AREAS TO HAVE A THREE FOOT (3') CIRCLE OF MULCH 2"-3" DEEP; NOT MORE THAN 3". (HARDWOOD - NATURAL DARK BROWN). TOPSOIL SHALL BE FERTILE, FRIABLE, AND REPRESENTATIVE OF PRODUCTIVE SOIL, CAPABLE OF SUSTAINING VIGOROUS PLANT GROWTH AND SHALL BE DARK ORGANIC NATURAL SURFACE SOIL, EXCLUSIVE OF PEAT, MUCK, AND/OR DARK BROWN OR BLACK LOAM, CLAY LOAM, SILT LOAM, OR
- SANDY LOAM. REQUIRED LANDSCAPE MATERIAL SHALL SATISFY AMERICAN ASSOCIATION OF NURSERYMAN STANDARDS AND BE:

* PLANT MATERIAL SIZES (MINIMUM)

~

- MATERIAL AND DEBRIS TO A MINIMUM DEPTH OF EIGHTEEN INCHES (18") AND BACKFILLED WITH A MEDIUM TEXTURED PLANTING SOIL. ALL LANDSCAPED AREAS ARE TO HAVE MINIMUM SIX INCHES (6") OF TOPSOIL AND ARE TO BE CROWNED A MINIMUM SIX INCHES (6") HIGHER THAN ADJACENT CURBS AND SIDEWALKS. 2. ALL WRITTEN DIMENSIONS OVERRIDE SCALE DIMENSIONS ON PLAN.
- REPORT ALL CHANGES, SUBSTITUTIONS, OR DELETIONS TO THE ARCHITECT. ALL BIDDERS MUST INSPECT THE SITE AND REPORT ANY DISCREPANCIES TO THE ARCHITECT.
- 5. ALL SPECIFICATIONS SUBJECT TO CHANGE DUE TO EXISTING SITE
- CONDITIONS. 6. THE LANDSCAPE ARCHITECT RESERVES THE RIGHT TO APPROVE ALL PLANT MATERIAL.
- 7. DO NOT PLANT DECIDUOUS OR EVERGREEN TREES DIRECTLY OVER UTILITY LINES. MAINTAIN A FIVE FOOT (5') DISTANCE FROM CENTER OF UTILITIES FOR PLANTING HOLES. CALL 411 OR OUPS FORTY-EIGHT (48) HOURS PRIOR TO LANDSCAPE CONSTRUCTION FOR FIELD LOCATION OF UTILITY LINES. MEASUREMENT AND QUANTITIES ARE ESTIMATES ONLY AND CONTRACTOR
- IS RESPONSIBLE FOR HIS/HER OWN QUANTITIES. LANDSCAPE CONTRACTOR SHALL BE RESPONSIBLE FOR 100% OF SOD REQUIRED INCLUDING AREAS IN R.O.W.
- IRRIGATION IS REQUIRED ON 75%-100% OF THE PROPERTY WITH EMPHASIS ON AREAS ALONG PRIMARY AND SECONDARY ROADWAYS AND 100% OF ALL LANDSCAPE AREAS ADJACENT TO THE STRUCTURE. IN COMPLIANCE WITH SECTION 1136.09 (a)(2).
- 10. G.C. TO PROVIDE IRRIGATION, IRRIGATION TO BE DESIGNED BY OTHER,
- RAIN SENSOR & TIMER AS PART OF SPRINKLER SYSTEM DESIGN. 11. ALL SERVICE STRUCTURES TO BE SCREENED PER CHAPTER 1136.08.

SHRUB PLANTING




UNDISTURBED SOIL -

BROKEN W/ PICK

-FINISH GRADE -AGRIFORM PLANTING TABLETS ROOTBALL-REMOVE BURLAP FROM TOP 1/3 OF BALL 20% COMPACTED BACKFILL MIX


MAX. 3" MULCH

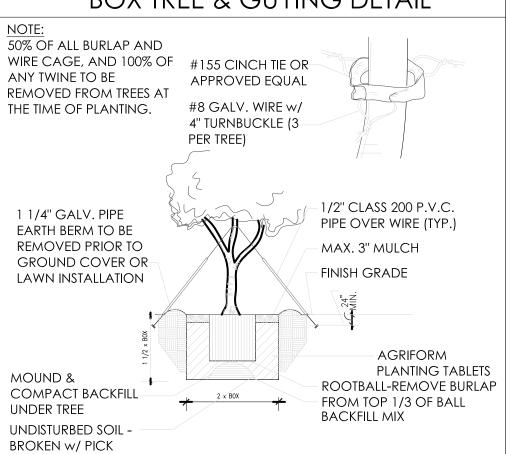BOX TREE & GUYING DETAIL





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DRWG. NO. EX50084-Rev2.AGI

0.2 0.9 1.9 3.1 3.6 2. MH: 204.3 4.8 4.1 2.9 BB 0.8.5 1.1 2.5 4.0 4.7 4.7 4.9 5.9 6.9 6.8 5.9 4.7 4.6 0.6.4 1.0 2.5 4.0 3.7 3.6 4.0 4.9 6 6.9 5.2 4.4 4.0 4.1 4.0 0.8.4 1.0 2.1 2.6 2.1 2.6 4.4 4.6 3.3 3.2 4.0 4.5 2.3 1.8 1.8 0.5 0.5 0.5 0.5 EXISTING BURGER KING RESTAURANT 1.0 1.1 1.3 1.6 1.8 1.9 1.4 1.1 1.1 0.9 0.7 0.4 0.2 3.5 4.6 5.9 5.1 3.4 2.8 2.9 2.7 1.7 0.8 0.8 \$0.4 \$\frac{1}{2}0.6 \$\frac{1}{3}.8 \$\frac{1}{4}.7 \$\frac{1}{3}.9 \$\frac{1}{2}.2 \$\frac{1}{2}.8 \$\frac{1}{3}.5 \$\frac{1}{3}.0 \$\frac{1}{2}.7 \$\frac{1}{2}.7 \$\frac{1}{2}.9 \$\frac{1}{3}.2 \$\frac{1}{2}.1 \$\frac{1}{1}.0 \$\left| \frac{1}{0}.8 \$\frac{1}{3}.8 \$\frac{1}{3}.8 \$\frac{1}{3}.3 \$\frac{1}{3}.7 \$\frac{1}{5}.2 \$\frac{1}{3}.5 \$\frac{1}{1}.2 \$\frac{1}{3}.5 \$\frac{1 0.5 3.1 3.9 3.9 2.3 3.0 4.2 4.2 4.2 4.4 4.0 2.5 1.1 0.8 1.6 4.1 4.5 2.8 3.2 4.5 3.8 1.2 1 8 2.2 2.2 1.9 2.6 3.6 4.0 3 3.0 4.0 3.4 2.2 1.1 0.8 1.5 3.2 3.1 2.2 2.4 3.1 3.0 1.2 1.5 1.2 1.3 1.5

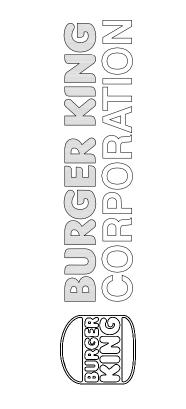
CRITERIA. ANY SUBSTITUTIONS IN SPECIFIED FIXTURES OR CHANGES TO LAYOUT WILL AFFECT LIGHTING LEVELS SHOWN AND WILL NOT

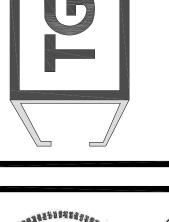BE THE RESPONSIBILITY OF SECURITY LIGHTING.

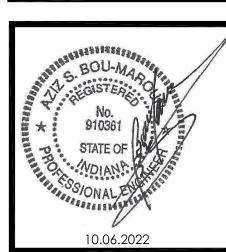2. distance between readings ____10

Calculation Summary							
Label	CalcType	Units	Avg	Max	Min	Avg/Min	Max/Min
PAVED SURFACE READINGS	Illuminance	Fc	2.99	11.5	0.2	14.95	57.50
PROPERTY LINE READINGS	Illuminance	Fc	0.25	0.5	0.0	N.A.	N.A.

Luminaire	e Schedu	ule						-	
Symbol	Qty	Label	Arrangement	LLF	Description	Lum. Watts	EPA	Mtg Height	Pole Type
	5	BB	SINGLE	0.900	RAR-2-320L-165-5K7-4-BC	154.2	0.617	20	SES-18-40-1-TA-xx-xx (4")
*	4	L	SINGLE	0.900	RWSC-36L-5K-DO-U-PS	14.4	N/A	10	N/A
	12	M	SINGLE	0.698	VO-RP-40DW277-4	28	N/A	VARIES	N/A
	1	BB3@90	3 @ 90°	0.900	RAR-2-320L-165-5K7-4-BC	154.2	1.486	20	SES-18-40-1-TA-xx-xx (4")

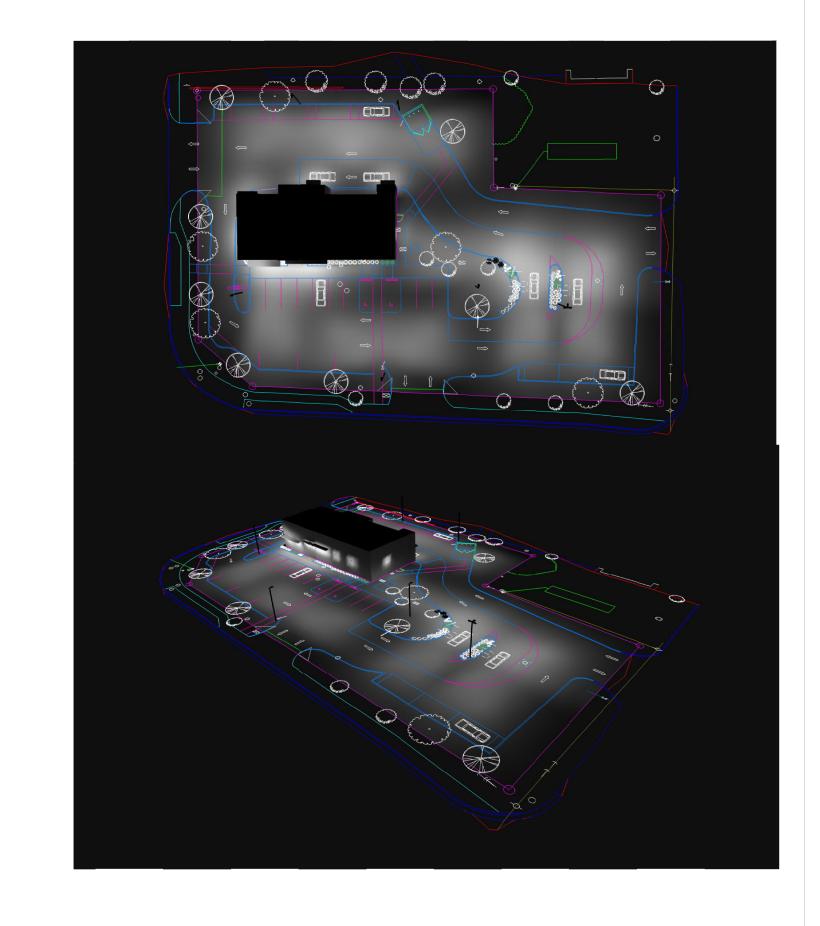

Pole Fixtures Are Full Cutoff Tilt=0 Calculation Grids Are At Grade Pole Light Mounting Height=20ft (18' Pole + 2' Base)



1. THIS LIGHTING DESIGN IS BASED ON INFORMATION SUPPLIED BY OTHE SECURITY LIGHTING SYSTEMS. SITE DETAILS PROVIDED HEREON ARE REPR ONLY AS A VISUALIZATION AID. FIELD DEVIATIONS MAY SIGNIFICANTLY. PREDICTED PERFORMANCE. PRIOR TO INSTALLATION, CRITICAL SITE INFO (POLE LOCATIONS, ORIENTATION, MOUNTING HEIGHT, ETC.) SHOULD BE COORDINATED WITH THE CONTRACTOR AND/OR SPECIFIER RESPONSIBLE FOR

2. LUMINAIRE DATA IS TESTED TO INDUSTRY STANDARDS UNDER LABORATO CONDITIONS. OPERATING VOLTAGE AND NORMAL MANUFACTURING TOLERANCE LAMP, BALLAST, AND LUMINAIRE MAY AFFECT FIELD RESULTS.

3. CONFORMANCE TO FACILITY CODE AND OTHER LOCAL REQUIREMENTS IS THE RESPONSIBILITY OF THE OWNER AND/OR THE OWNER'S REPRESENTATIVE.

4. THIS LAYOUT MAY NOT MEET TITLE 24 OR LOCAL ENERGY REQUIREMENTS. IF THIS LAYOUT NEEDS TO BE COMPLIANT WITH TITLE 24 OR OTHER ENERGY REQUIREMENTS, PLEASE CONSULT FACTORY WITH SPECIFIC DETAILS REGARDING

PROJECT REQUIREMENTS SO THAT REVISIONS MAY BE MADE TO THE DRAWING.

	SECURITY LIGHTING
HERS TO	2100 Golf Road, Suite 460, Rolling Meadows, IL 60008 1-800-544-4848
PRODUCED Y AFFECT	UNLESS OTHERWISE SPECIFIED, ALL DIMENSIONS ARE IN INCH
FORMATION	1" = 20' 0" DATE $7/1/2022$
OR THE	DRAWN BY VH
TORY CES OF	POINT-BY-POINT FOOTCANDLE PLOT FO

BURGER KING 1440 S NAPPANEE ST ELKHART, IN

STANDARD SPECIFICATIONS

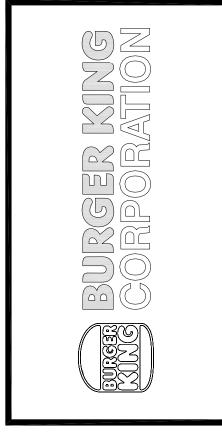
GENERAL CONTRACTOR TO REFERENCE STANDARD SPECIFICATIONS OF THE CITY OF

ELKHART WHICH CAN BE FOUND IN DIVISION C OF THE PROVIDED LINK.

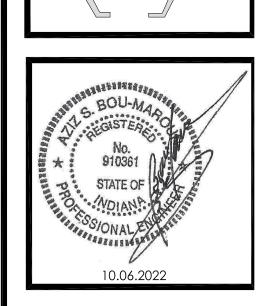
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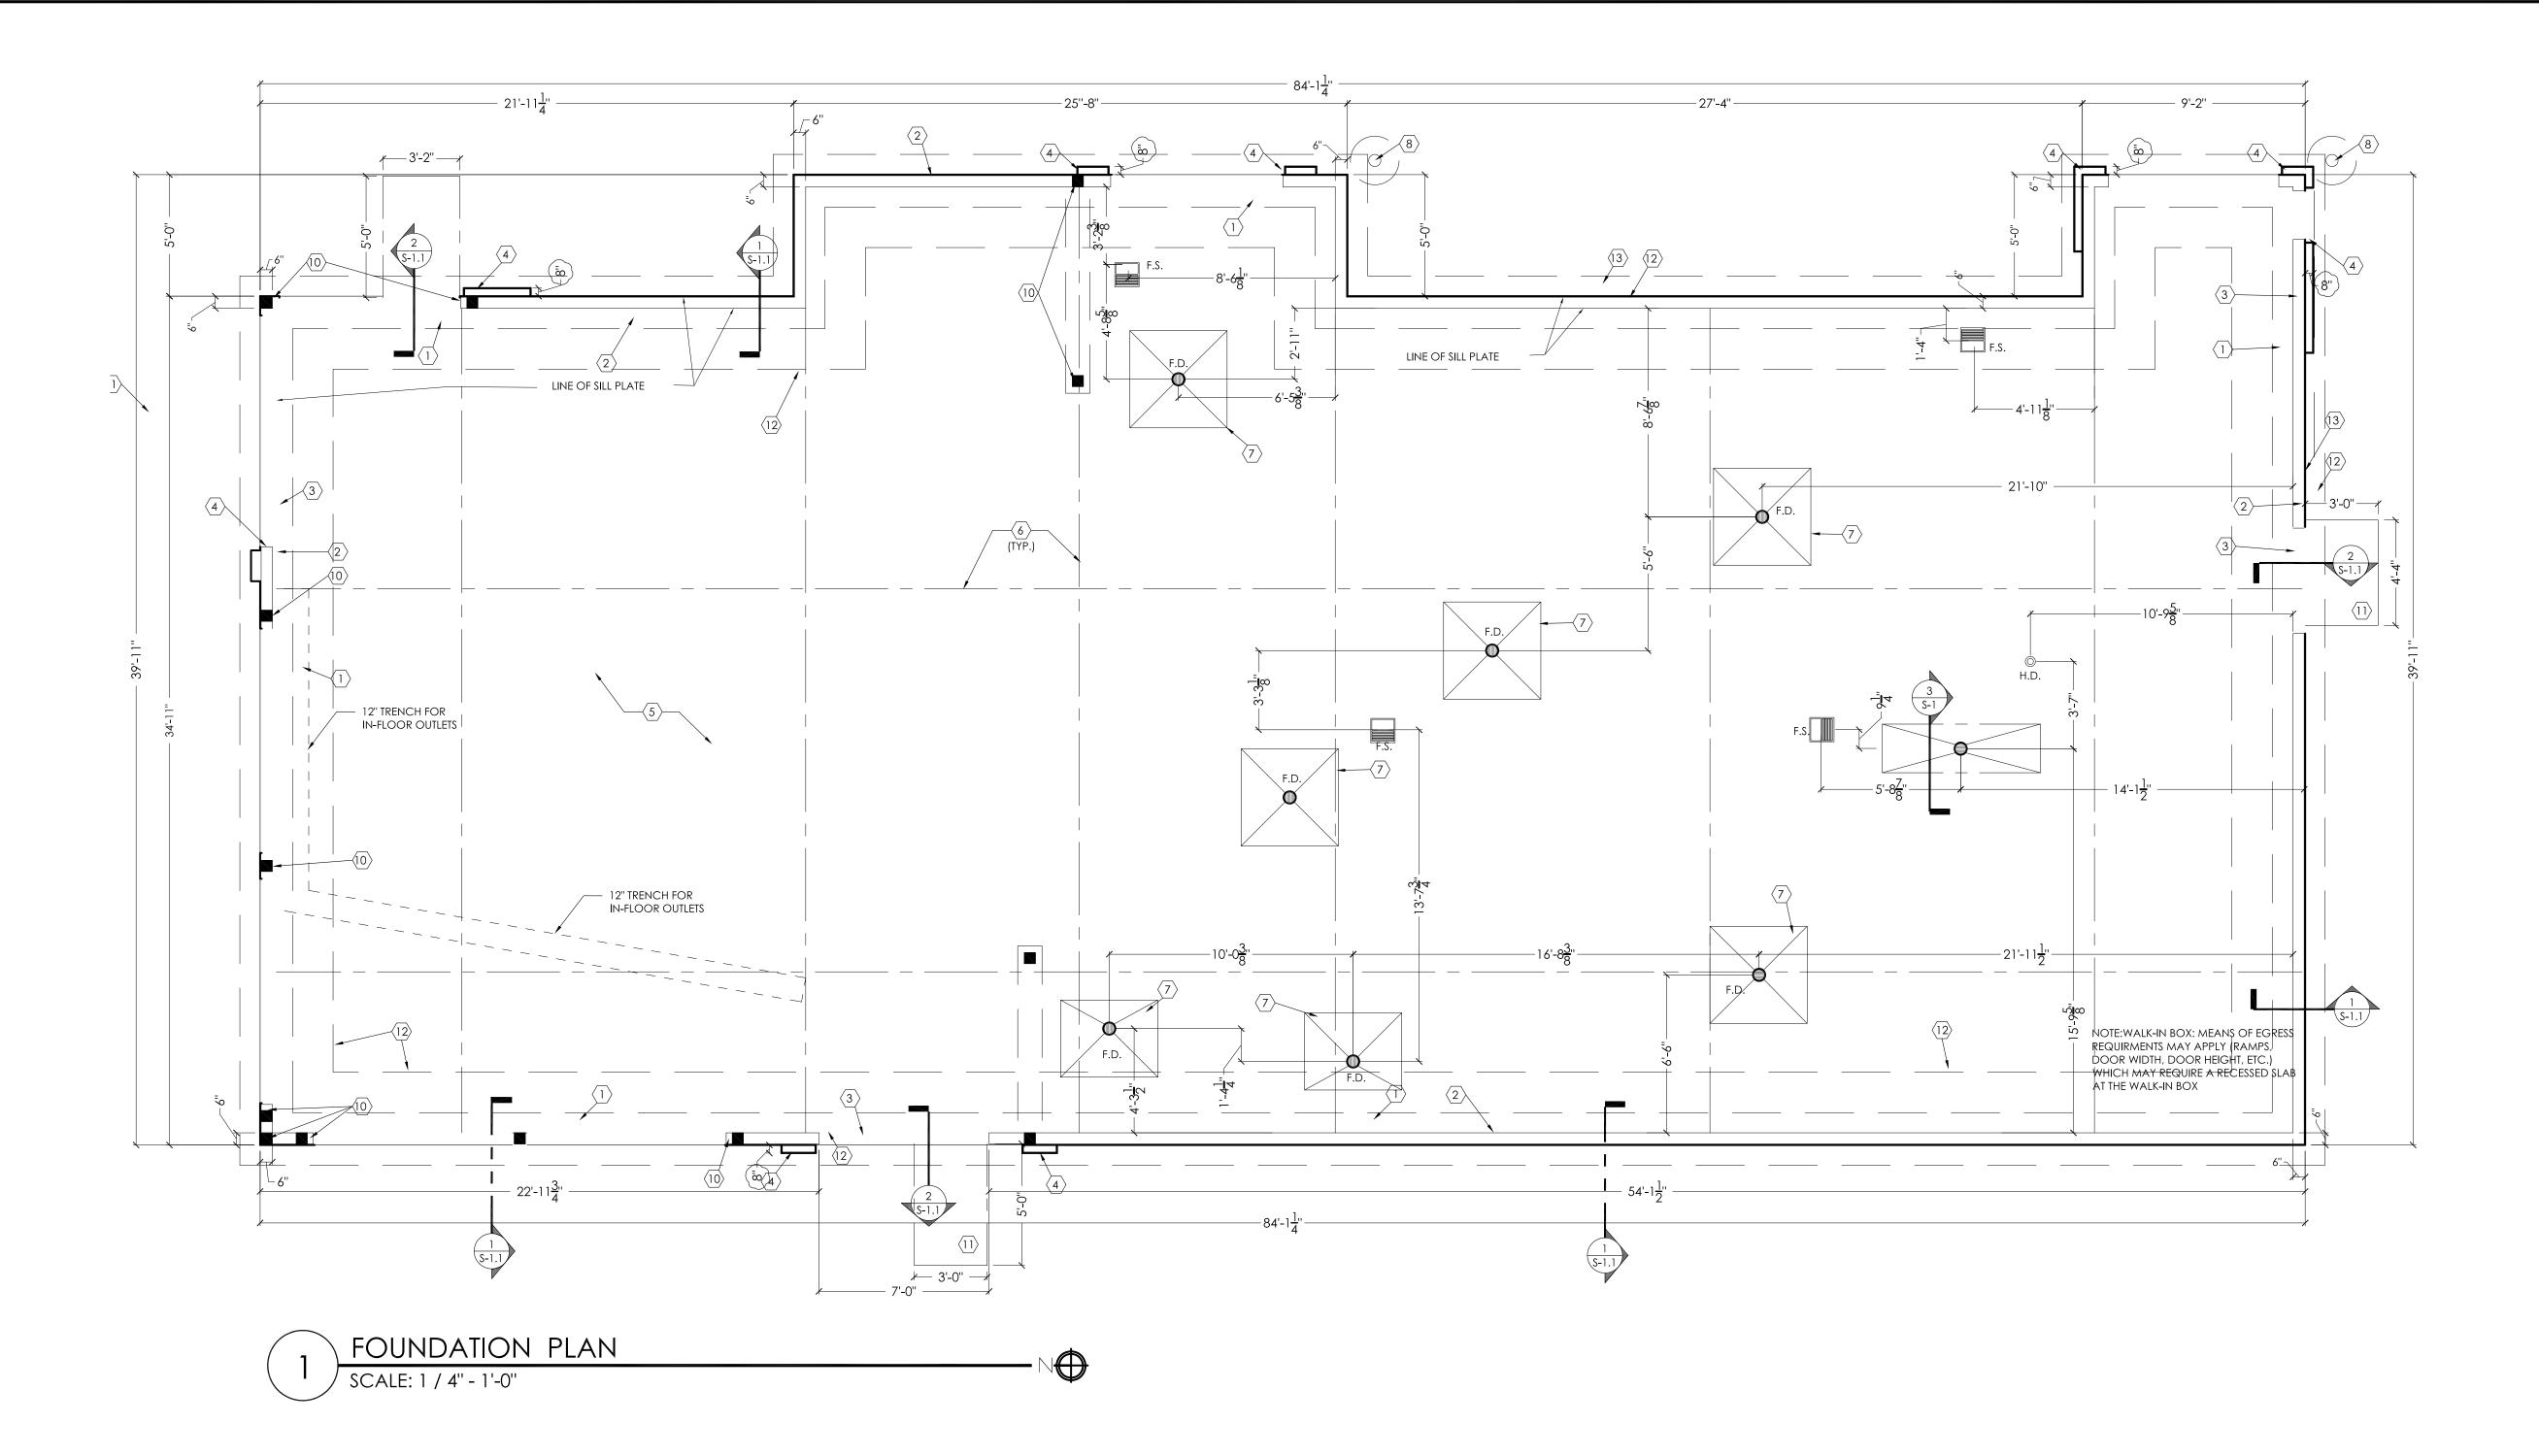
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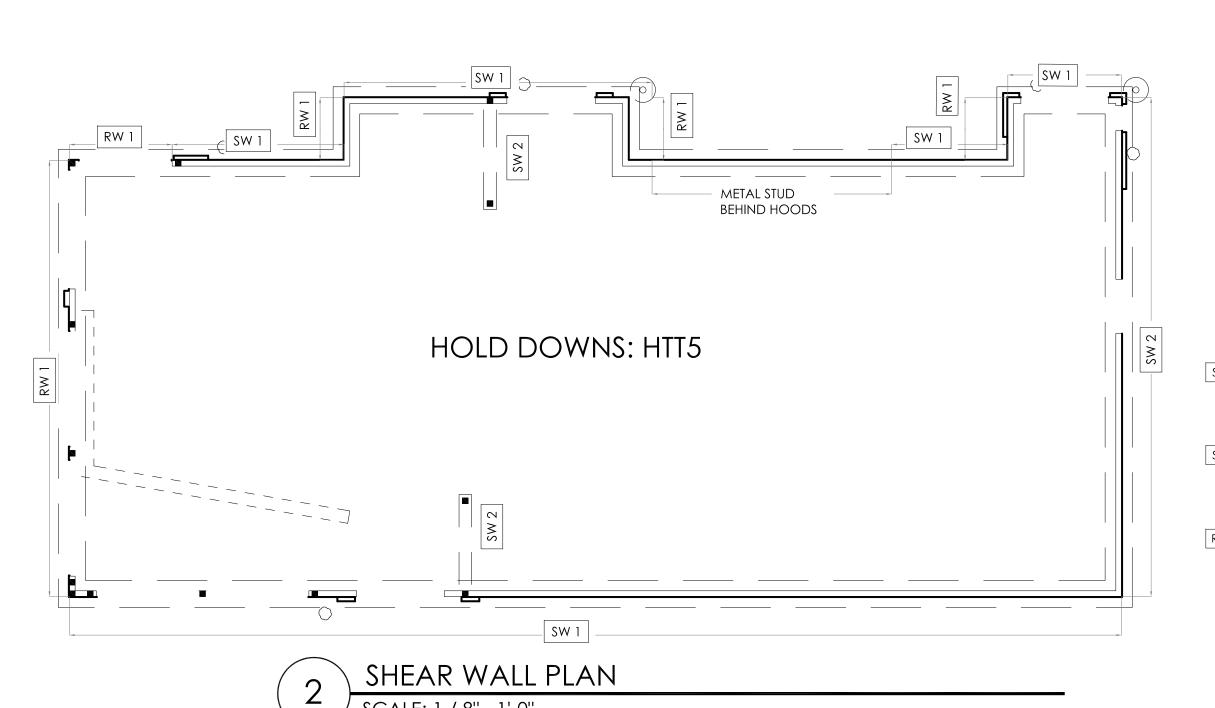
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2x6 @ 16" O.C. WOOD STUD

W/ 1/2 " PLYWOOD SHEATHING (ALL PANEL EDGES BLOCKED)

W/ 8d NAILS @ 6" O.C. AT PANEL EDGES AND 12" O.C. ON THE FIELD.

PROVIDE 6x6 POST OR PACKED STUDS AT EACH END OF SHEAR WALL AND AT CENTER FOR HOLDDOWN ATTACHMENT (USE SIMPSON HTT5)

2x6 @ 16" O.C. WOOD STUD

W/ 1/2" PLYWOOD SHEATHING (ALL PANEL EDGES BLOCKED)

W/ 8d NAILS @ 4" O.C. AT EDGES AND 12" O.C. ON THE FIELD

PROVIDE 6x6 POST OR PACKED STUDS AT EACH END OF SHEAR WALL AND AT CENTER FOR HOLDDOWN ATTACHMENT (USE SIMPSON HTT5)

2x6 @ 16" O.C. WOOD STUD
W/ 1/2" PLYWOOD SHEATHING (ALL PANEL EDGES BLOCKED)
W/ 8d NAILS @ 8" O.C. AT PANEL EDGES AND 6" O.C. AT INTERMEDIATE SUPPLIER
PROVIDE 6x6 POST OR PACKED STUDS AT EACH END OF SHEAR WALL AND AT
CENTER FOR HOLDDOWN ATTACHMENT (USE SIMPSON HTT5)

KEYED NOTES:

- 18" WIDE x 42" MIN DEEP CONTINUOUS CONCRETE FOOTING WITH (3) #5 BARS CONTINUOUS TOP & BOTTOM
- 2 LINE OF SILL PLATE
- 3 EXTEND SLAB THRU AT OPENINGS (DETAIL 2/S-1.1)
- PROVIDE 16" DEEP (4" A.F.F.) FOR FURR-OUT ELEMENTS AT TOWERS.

 CURB WIDTH TO BE DETERMINED BY FINISH FURR-OUT WIDTH. REFER TO SHEET

 A-1 FOR REQUIRED WIDTH AND DETAIL 1A/S-1.1.
- 4" MIN. CONCRETE SLAB WITH 6x6-W1.4xW1.4 W.W.F. (MIN REINF'G) AT MID DEPTH OVER 6 MIL VAPOR BARRIER OVER 4" GRANULAR FILL.
- 6 CONTROL/CONSTRUCTION JOINTS REFERENCE 4/S-1.1.
- 7 4'x4' AREA SLOPED TO DRAIN @ 2% (TYP.)
- 8 6"Øx 8'-0" STEEL BOLLARD, FILL WITH CONCRETE, TOP OF BOLLARD AT 5'-0" ABOVE SURFACE OF PAVING WITH 24"Ø x 3'-0" DEEP CONCRETE FOOTING (DETAIL S-1.1)
- SHEAR WALL FOOTING 12" x 2'-0" DEEP CONCRETE PAD W/ #4 BARS @ 12" O.C. BOTH DIRECTION, TOP & BOTTOM
- (10) 6X6 WOOD COLUMN OR (3)-2X6 BUILT-UP COLUMN
- 6x6 WOOD COLUMN OR (3)-2x6 BUILT-UP COL
- 2" HORIZONTAL INSULATION AROUND PERIMETER OF BUILDING

GENERAL NOTES:

- A. FOUNDATION PLAN WAS BASED ON AN ALLOWABLE BEARING CAPACITY OF 2500 PSF. SEE GEOTECHNICAL ENGINEERING REPORT BY TERRACON.
- B. ALL SOIL EXCAVATIONS FOR FOOTINGS & COMPACTION SHALL BE INSPECTED AND APPROVED BY A QUALIFIED SOILS ENGINEER REPRESENTING THE OWNER PRIOR TO PLACING CONCRETE. EXCAVATIONS SHALL BE FREE OF WATER AT ALL TIMES.
- C. NO ENGINEERED FILL SHALL BE PLACED UNTIL EXCAVATION BOTTOMS HAVE BEEN INSPECTED AND APPROVED BY A SOILS ENGINEER.
- D. BACKFILLING:
 D.1. BOTH SIDES OF FOUNDATION WALLS SHALL BE BACKFILLED SIMULTANEOUSLY SO AS TO
- PREVENT OVERTURNING OR LATERAL MOVEMENT OF WALLS.
 D.2. NO FILL OR BACKFILL SHALL BE SETTLED BY THE USE OF WATER.
- E. SEE SHEET S-3 FOR STRUCTURAL NOTES.

PROCEEDING WITH THE WORK.

- F. SEE ELECTRICAL SHEETS FOR LOCATIONS OF UNDERGROUND CONDUIT.
- G. SEE PLUMBING PLAN FOR LOCATIONS OF UNDERGROUND PIPING.
- H. GC SHALL COORDINATE PIPING WITH FOOTINGS AND/OR STEM WALL, AND REPORT TO A/E OF ANY PENETRATIONS.
- I. ALL CONTINUOUS FOOTINGS SHALL BE CENTERED UNDER FOUNDATION WALLS UNLESS NOTED OTHERWISE.
- J. SOILS CONTRACTOR SHALL REFER AND CONFORM TO ALL RECOMMENDATIONS AND FINDINGS AS SET FORTH IN THE SOILS GEOLOGICAL REPORT. THE OWNER AND/OR ARCHITECT ACCEPTS NO RESPONSIBILITY FOR THE ACCURACY OF THE FINDINGS. OR FOR THE FINAL RECOMMENDATIONS, GRADING, TRENCHING, ETC. CONTACT OWNER FOR INSTRUCTIONS PRIOR TO THE CONTINUATION OF WORK SHOULD ANY UNUSUAL CONDITIONS BECOME APPARENT DURING GRADING OR FOUNDATION CONSTRUCTION. EXISTING ELEVATIONS AND LOCATIONS TO BE JOINTED SHALL BE VERIFIED BY THE CONTRACTOR PRIOR TO CONSTRUCTION. IF THEY DIFFER FROM THOSE SHOWN ON THE DRAWINGS, THE CONTRACTOR SHALL NOTIFY THE OWNER SO THAT MODIFICATIONS CAN BE MADE BEFORE
- K. REFER TO EQUIPMENT SUPPLIER DRAWINGS FOR LOCATIONS OF ALL FLOOR SINKS AND HUB DRAINS.

Date By Notes

No. Date By Notes

State Building and Engineering Review

Review Comments

Ocity 2022 AG Technical Review Meeting Revisions

Ocity 2022 AG Technical Revisions

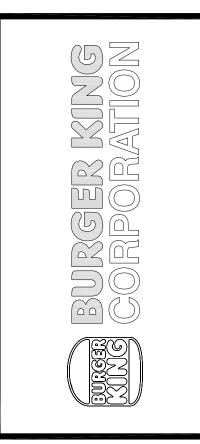
Ocity 2022 AG Technical Review Meeting Revisions

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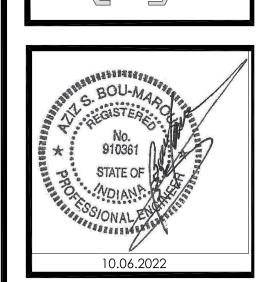
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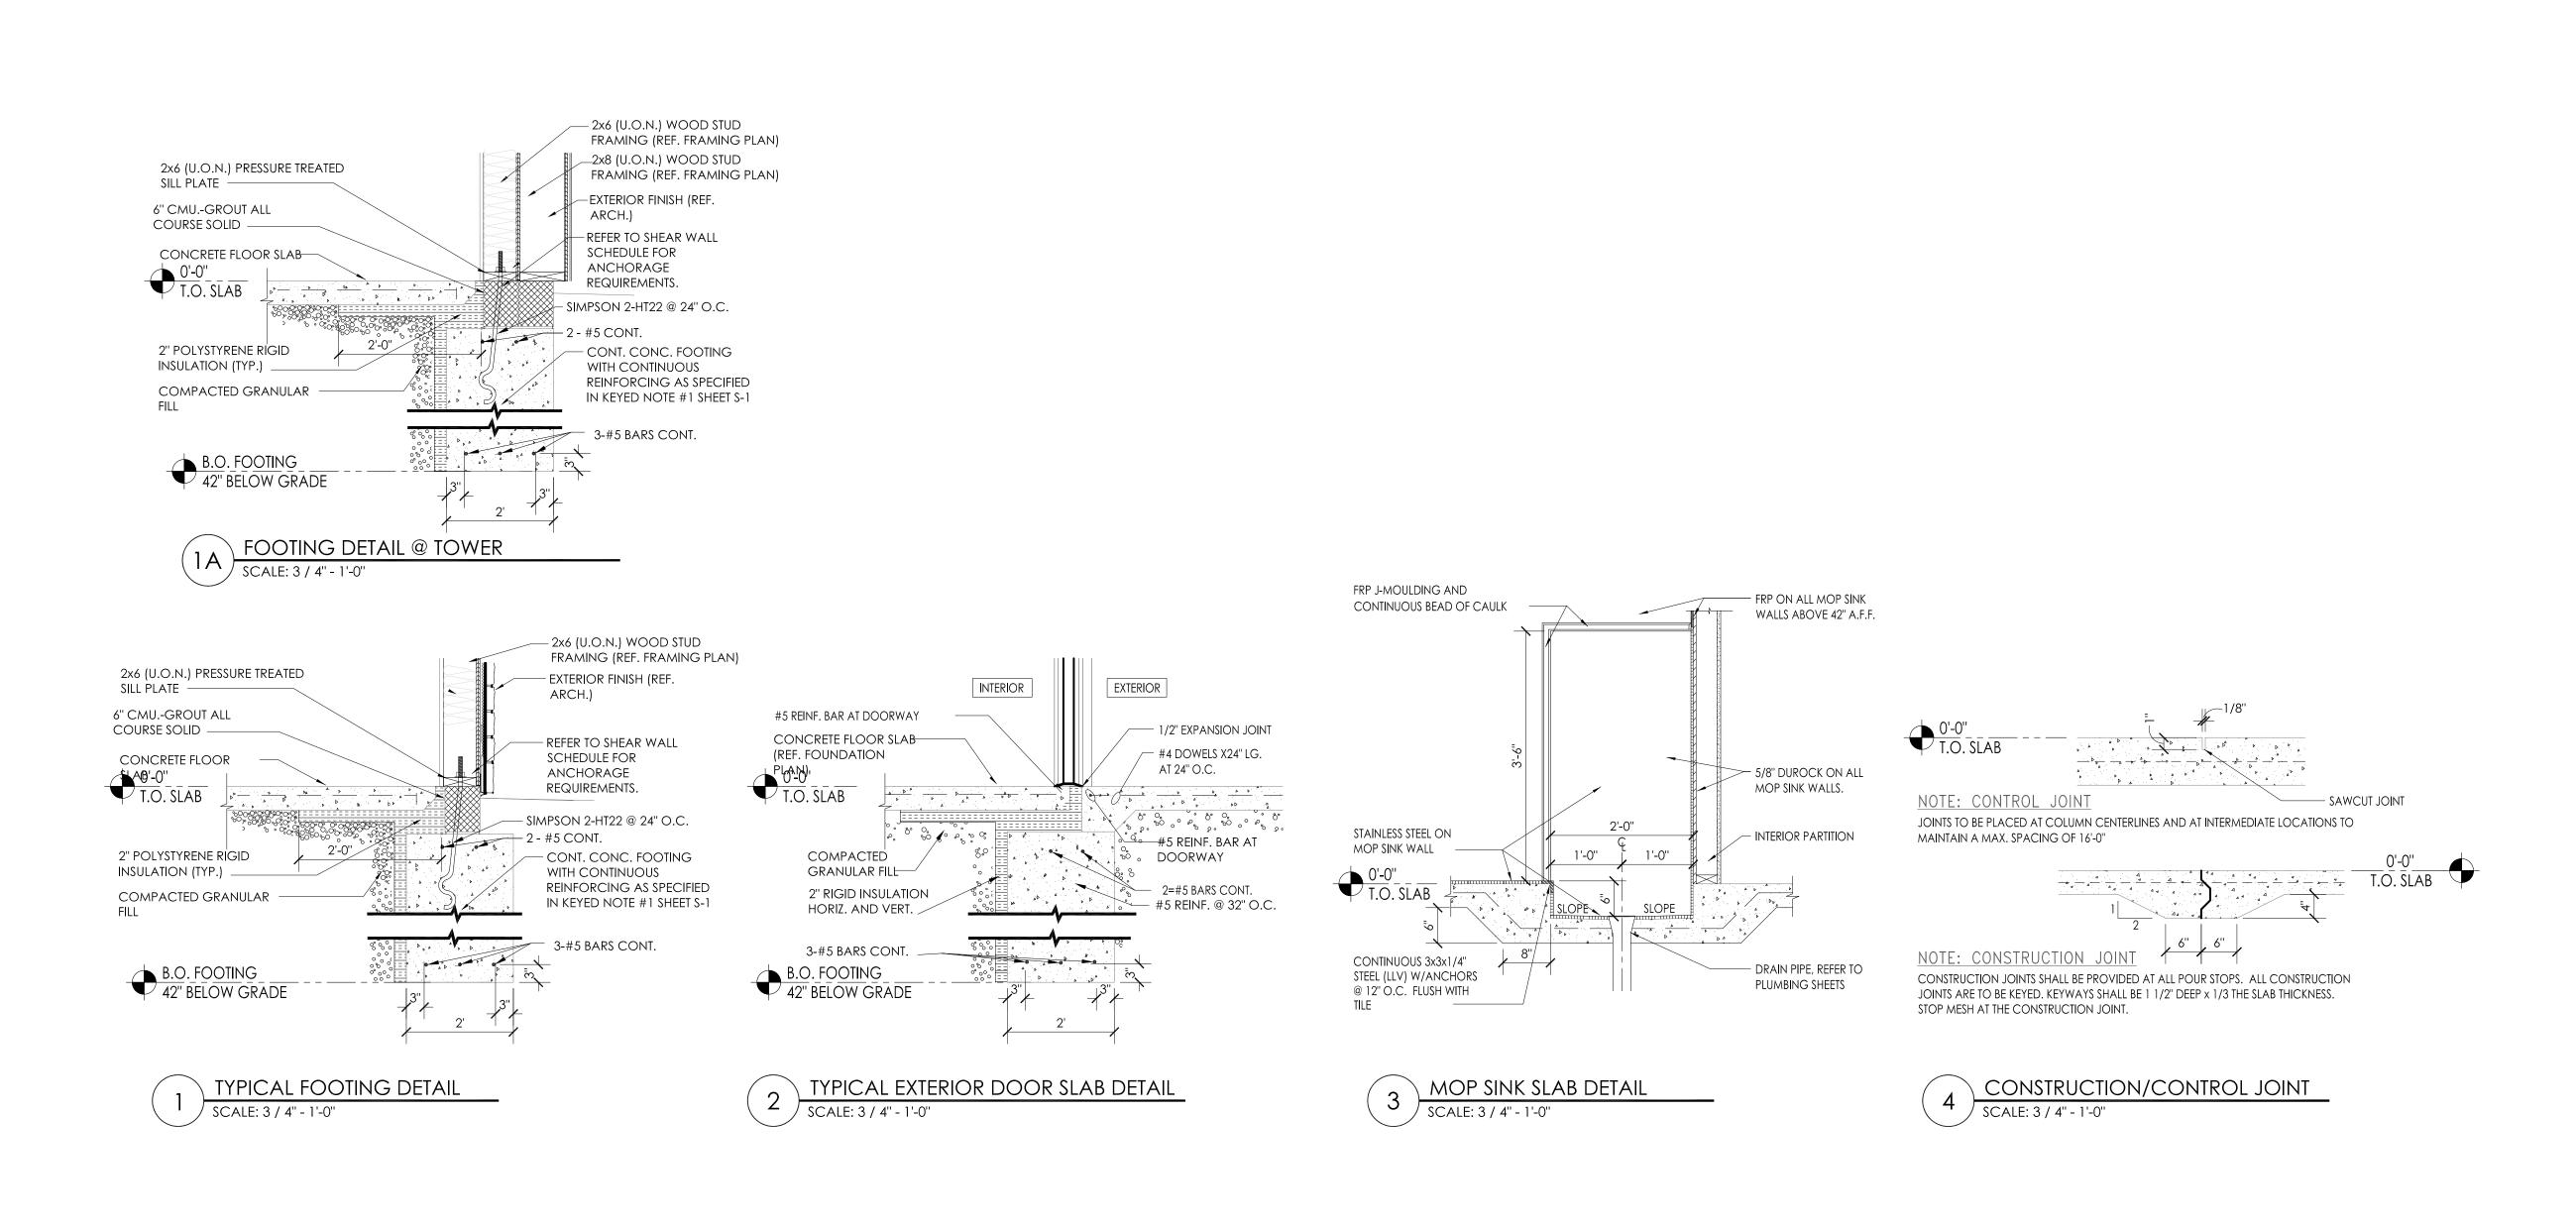









PROJECT
BURGER KING
1440 NAPPANEE ST,
ELKHART, IN 46514

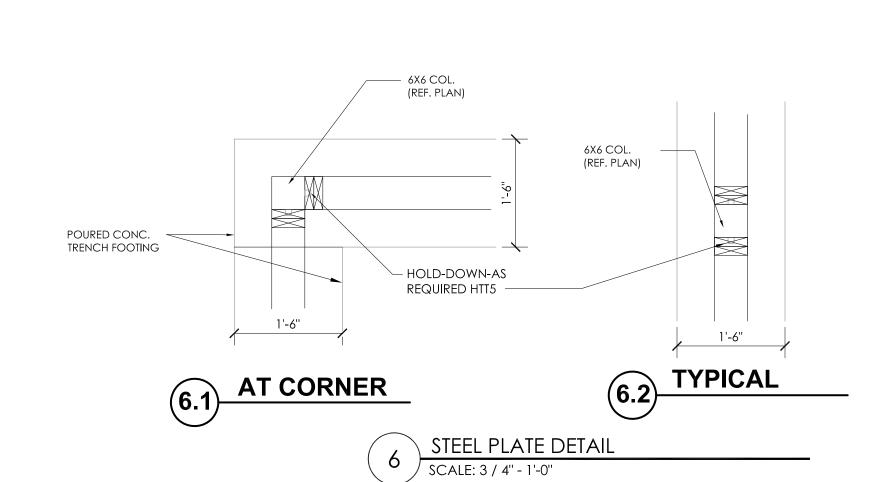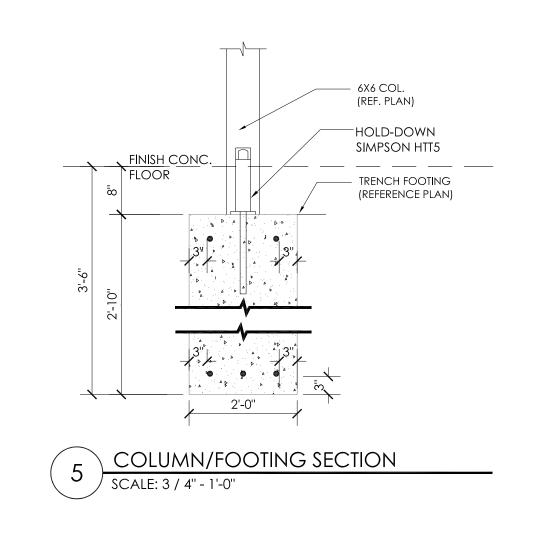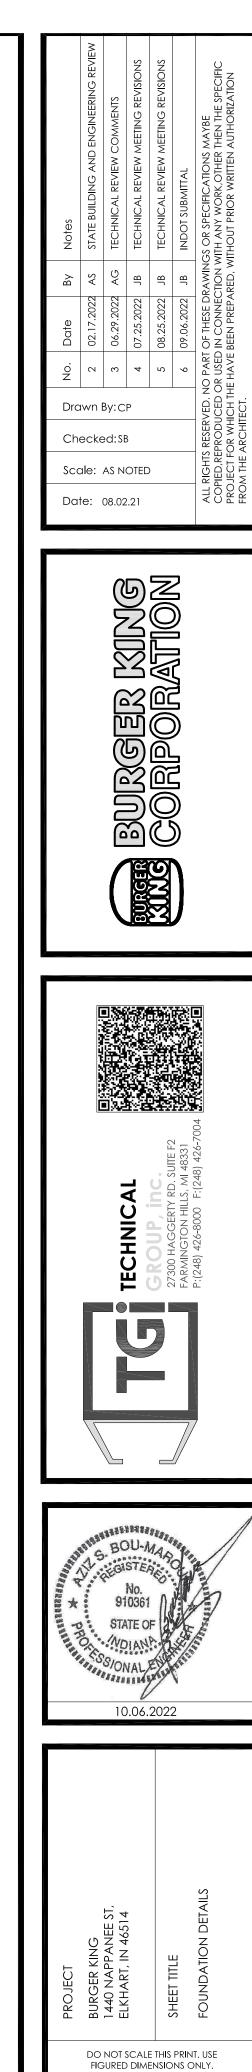TOUNDATION PLAN
FOUNDATION PLAN










TG-21668

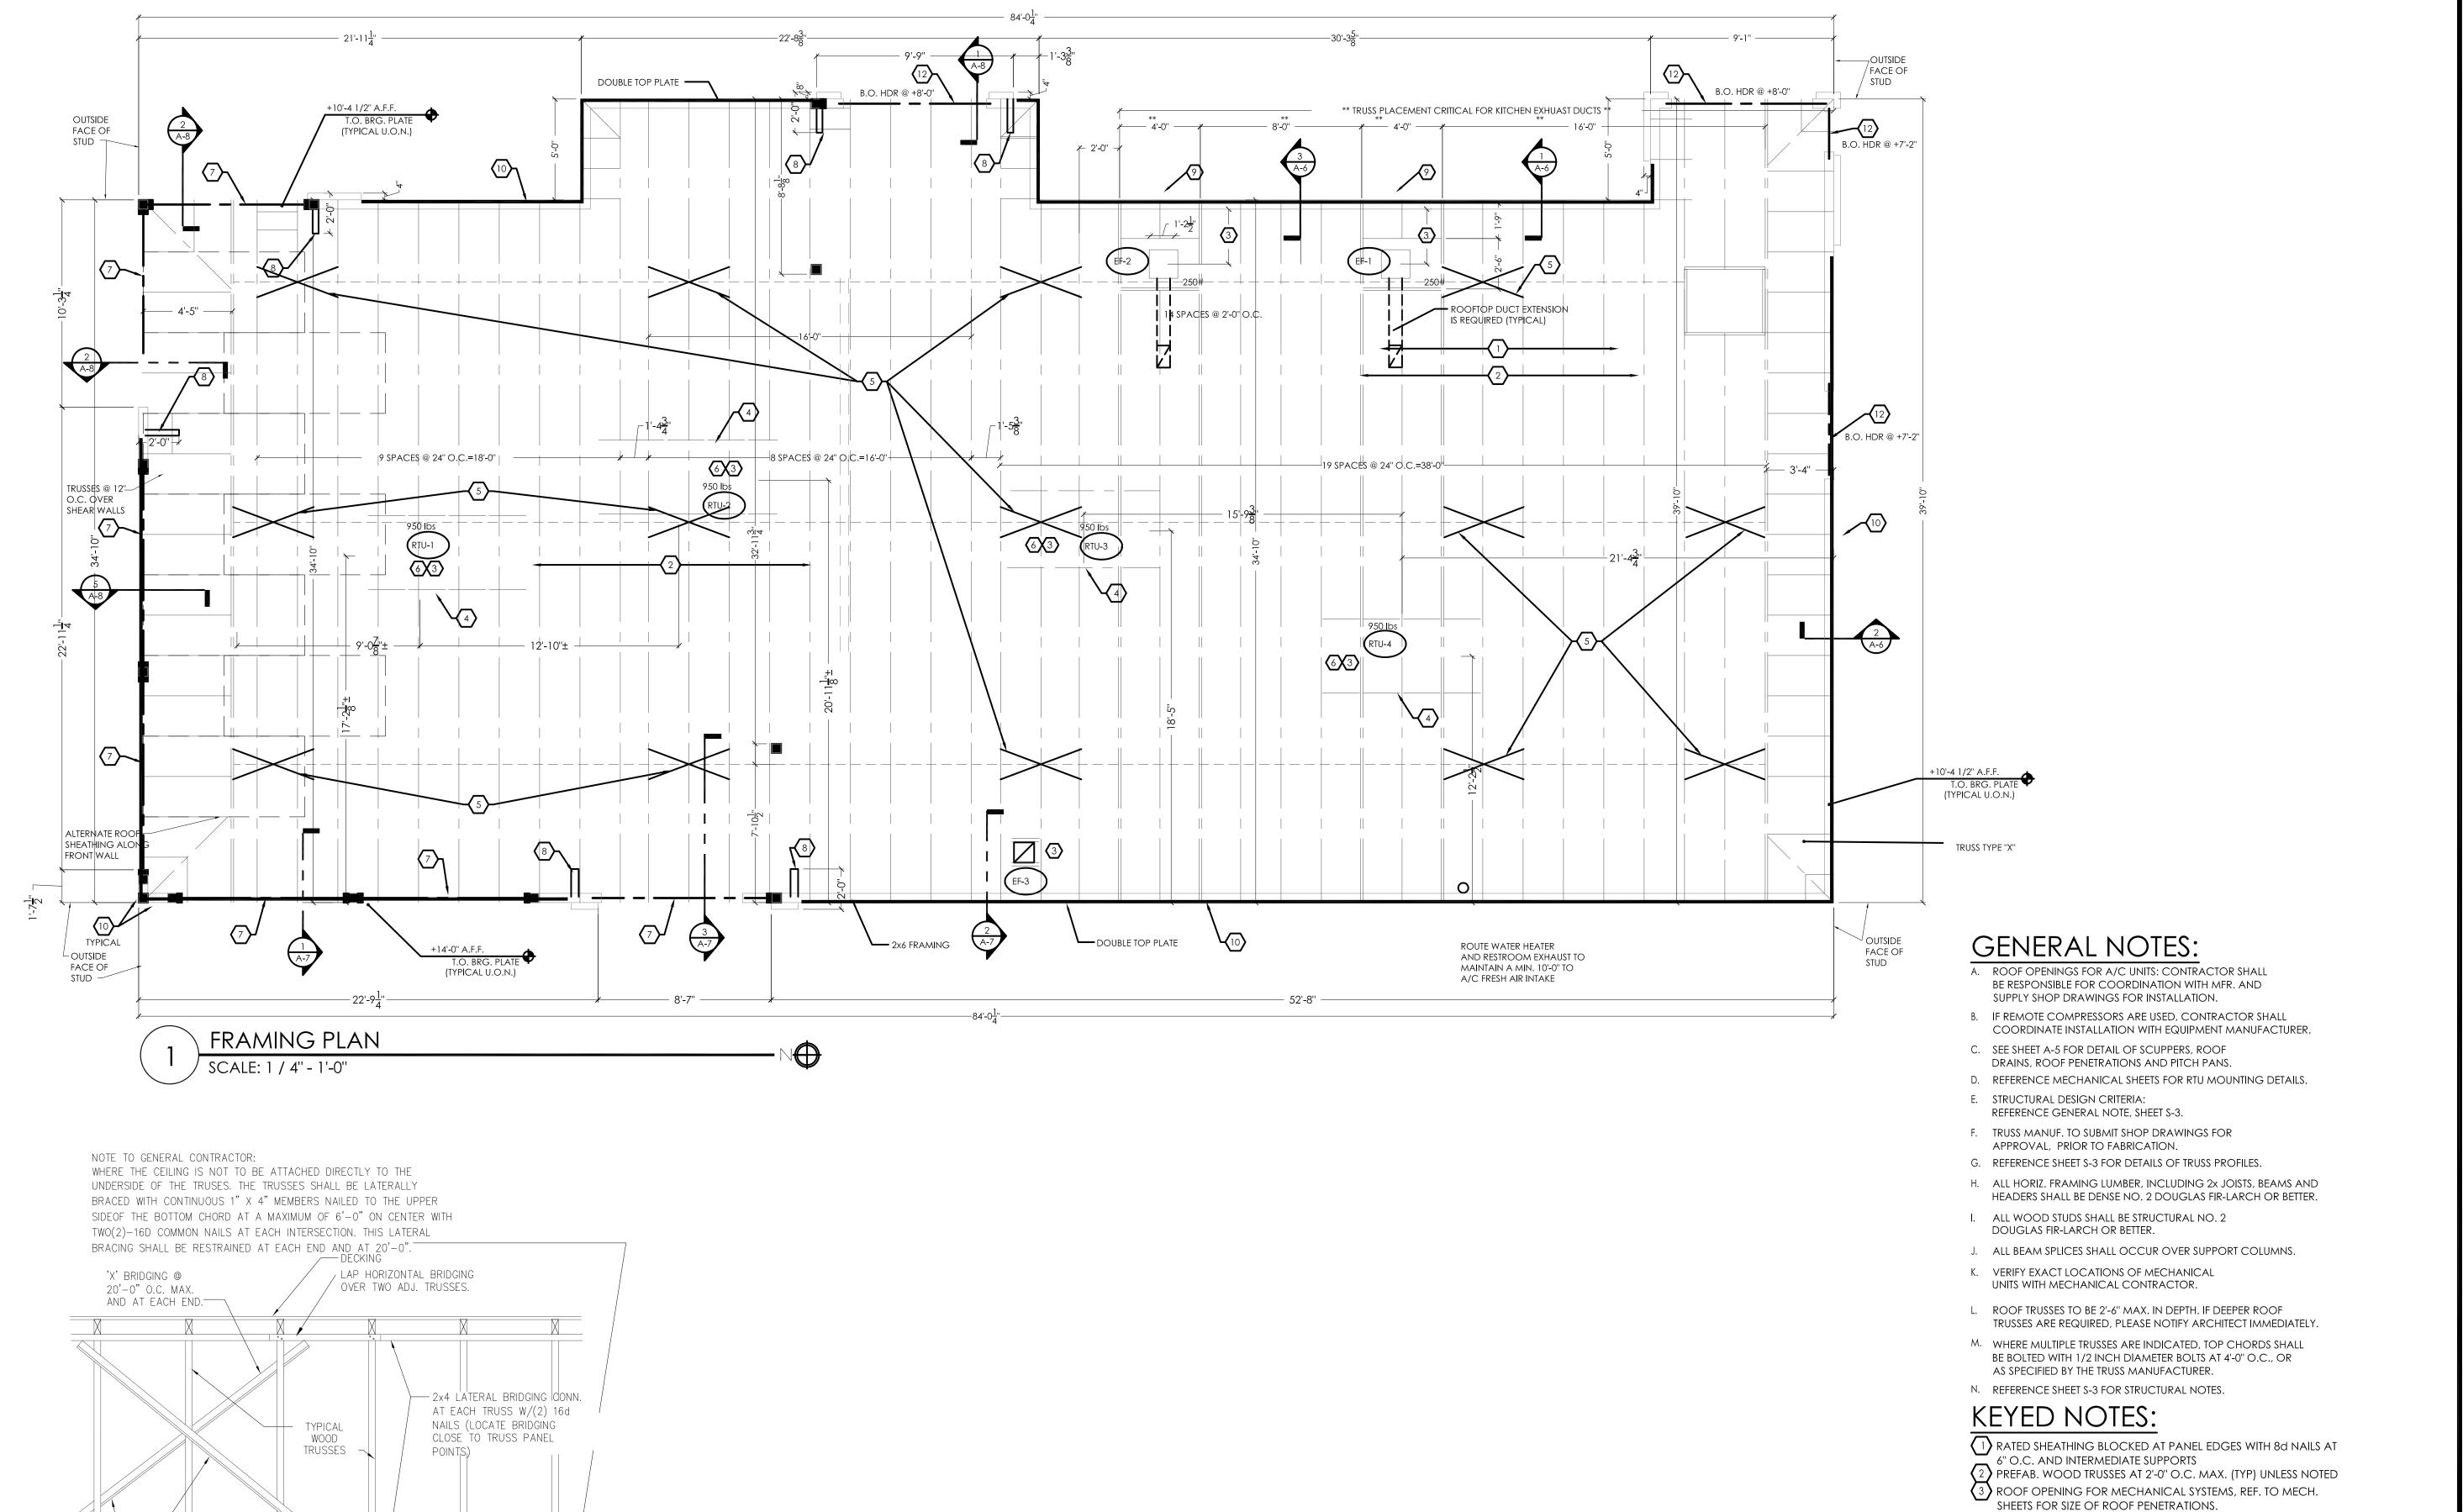

- 2x4 DIAGONAL BRIDGING. CONN. W/ (2) 16d NAILS.

CONNECT AT END WALLS TO A 2X4 (12" LONG) PT

AND (4) 10d NAILS EA. END.

BRIDGING DETAIL

SCALE: NTS

LEDGER, CONN TO BLOCK W/(2) 5/8"ø WEDGE ANCH.

BOLTS. CONN. WOOD TO WOOD WITH HURRICANE STRAP

No. Date By Notes

2 02.17.2022 AS STATE BUILDING AND ENGINEERING REVIEW
3 06.29.2022 AG TECHNICAL REVIEW COMMENTS
4 07.25.2022 JB TECHNICAL REVIEW MEETING REVISIONS
5 08.25.2022 JB INDOT SUBMITTAL
6 09.06.2022 JB INDOT SUBMITTAL
7 09.06.2022 JB INDOT SUBMITTAL
9 09.06.2022 JB INDOT SUBMITTAL
1 DOR USED IN CONNECTION WITH ANY WORK, OTHER THEN THE SPECIFIC THANKE BEEN INDOM WITH ANY WORK, OTHER THEN THE SPECIFIC THANKE BEEN INDOM WITH ANY WORK, OTHER THEN THE SPECIFIC THANKE BEEN INDOM WITH ANY WORK, OTHER THEN THE SPECIFIC THANKE BEEN INDOM WITH ANY WORK, OTHER THEN THE SPECIFIC THANKE BEEN INDOM WITH ANY WORK, OTHER THEN THE SPECIFIC THANKE BEEN INDOM WITH ANY WORK, OTHER THEN THE SPECIFIC THANKE BEEN INDOM WITH ANY WORK, OTHER THEN THE SPECIFIC THANKE BEEN INDOM WITH ANY WORK, OTHER THEN THE SPECIFIC THE ANY BEEN INDOM WITH ANY WORK, OTHER THEN THE SPECIFIC THE ANY BEEN INDOM WITH ANY WORK, OTHER THEN THE SPECIFIC THE ANY BEEN INDOM WITH ANY WORK, OTHER THEN THE SPECIFIC THE ANY BEEN INDOM WITH ANY WORK.

Checked:SB

Scale: AS NOTED

Date: 08.02.21





TECHNICAL
GROUP, Inc.
27300 HAGGERTY RD. SUITE F2
FARMINGTON HILLS, MI 48331
P:(248) 426-8000 F:(248) 426-7004





BURGER KING
1440 NAPPANEE ST,
1440 NAPPANEE ST,
ELKHART, IN 46514
SINCE SHEET TITLE
FRAMING PLAN

(4) (2) 2x8 BETWEEN TRUSSES LVS28-2 SIMPSON JOIST HANGER EACH END

 $\langle 7 \rangle$ front: upper beams (3) 2x12 wood studs; lower beams (3) 2x10 wood studs

SIDE: UPPER BEAMS 3 PLY $1\frac{3}{4}$ " x 11 $\frac{1}{4}$ " LVL; LOWER BEAMS (3) 2X10 WOOD STUDS

(12) WOOD HEADER (3) 2×10 W/ (2) $\frac{1}{2}$ " PLWD SPACERS. DOUBLE STUDS AT EACH END

5 WOOD BRIDGING. REFERENCE DETAIL 02/S-2
6 REFER TO M-2 FOR A/C CURB MOUNTING DETAIL.

VERIFY DUCT SIZE WITH MANUFACTURER.

OF OPENING (4" MIN. BEARING)

8 PROVIDE 2x4 FRAMED RETURN WALL AT RAISED PARAPET

9 CENTER LINE OF EXHAUST DUCT. VERIFY LOCATION IN FIELD.

TOWER ELEMENT. REFER TO DETAILS #3 AND #4, SHEET A-8

10 ALL WALL FRAMING TO BE 2x10 WOOD STUDS @ 16" O.C. (U.O.N.)

2x4 BLOCKING @ 24" O.C. AT BOTTOM CHORD OF TRUSS FOR FOR BRACING OF NON-LOAD BEARING EXTERIOR WALLS.

TG-21668

S-2

STRUCTURAL NOTES

A. GENERAL

THE DRAWINGS ARE INTENDED TO SHOW THE GENERAL ARRANGEMENT design and extent of the work and are partially diagrammatic THEY ARE NOT INTENDED TO BE SCALED FOR ROUGH-IN MEASUREMENTS, OR O SERVE AS SHOP DRAWINGS OR PORTIONS THEREOF. ALL DETAILS AND SECTIONS SHOWN ON THE DRAWINGS ARE INTENDED TO BE TYPICAL AND SHALL BE CONSTRUED TO APPLY TO ANY SIMILAR
SITUATION ELSEWHERE ON THE PROJECT, EXCEPT WHERE A DIFFERENT DETAIL

OR SECTION IS SHOWN. PRIOR TO START OF CONSTRUCTION, THE CONTRACTOR AND ALL THE SUB-CONTRACTORS SHALL VERIFY ALL GRADES, LINES, LEVELS, DIMENSIONS AND COORDINATE EXISTING CONDITIONS AT THE JOB SITE WITH THE PLANS AND SPECIFICATIONS. THEY SHALL REPORT ANY INCONSISTENCIES OR ERRORS IN THE ABOVE TO THE ARCHITECT/ ENGINEER BEFORE COMMENCING WORK. THE CONTRACTOR AND HIS

AND MEASUREMENTS IN CONNECTION WITH THEIR WORK. IT IS SOLELY THE CONTRACTOR'S RESPONSIBILITY TO DETERMINE ERECTION PROCEDURE AND SEQUENCE AND TO INSURE THE SAFETY OF THE BUILDING AND ITS COMPONENT PARTS DURING CONSTRUCTION. THIS INCLUDES ANY REQUIRED SHORING, SHEETING, TEMPORARY BRACING, GUYS OR TIE DOWNS WHICH MIGHT BE NECESSARY. SUCH MATERIAL SHALL REMAIN THE CONTRACTOR'S PROPERTY AFTER THE COMPLETION OF THE PROJECT. IT IS SOLELY THE CONTRACTOR'S RESPONSIBILITY TO FOLLOW ALL

SUBCONTRACTORS SHALL LAY OUT THEIR WORK FROM ESTABLISHED

REFERENCE POINTS AND BE RESPONSIBLE FOR ALL LINES. FLEVATIONS

APPLICABLE SAFETY CODES AND REGULATIONS DURING ALL PHASES OF CONSTRUCTION. THE CONTRACTOR SHALL USE THE STRUCTURAL DRAWINGS AND SPECIFICATIONS TOGETHER WITH THE ARCHITECTURAL, MECHANICAL ELECTRICAL AND OTHER TRADE DRAWINGS AND SHOP DRAWINGS, TO COORDINATE ALL DETAILS, DIMENSIONS, ELEVATIONS, ETC., NOTIFY ARCHITECT/ENGINEER, IN WRITING, OF ANY POTENTIAL CONFLICTS BEFORE

PROCEEDING WITH THE WORK. SHOULD ANY OF THE DETAILED INSTRUCTIONS SHOWN ON THE PLANS CONFLICT WITH THESE STRUCTURAL NOTES, THE SPECIFICATIONS, OR WITH EACH OTHER, THE STRICTEST PROVISION SHALL GOVERN.

3. GOVERNING CODE: 2014 - INDIANA BUILDING CODE ROOF SNOW LOADS

- GROUND SNOW LOAD: Pg = 30 PSF. (FIGURE 1608.2) FLAT-ROOF SNOW LOAD: Pf = 30 PSF. (ASCE 7, SECT 7.3) SNOW EXPOSURE FACTOR: Ce = 1 (TABLE 1608.3.1)
- SNOW LOAD IMPORTANCE FACTOR: Is = 1 (TABLE 1604.5) SNOW THERMAL FACTOR: Ct = 1 (TABLE 1608.3.2) ALL APPLICABLE EFFECTS DUE TO SNOW DRIFTING (SECTION 1608)
- ROOF LIVE LOADS MINIMUM ROOF LIVE LOAD = 30 PSF. (SECTION 1607.11.2) SEE "PREFABRICATED WOOD TRUSSES" DESIGN CRITERIA FOR ADDITIONAL LOADING INFORMATION.
- BASIC WIND SPEED = 115 MPH (FIGURE 1609)
- WIND LOAD IMPORTANCE FACTOR: Iw = 1 (TABLE 1604.5) WIND EXPOSURE CATEGORY "B" (SECTION 1609.4)

(TABLE 1617.6.2, ITEM 1 K)

SEISMIC SITE CLASS - VFY WITH SOIL TEST BASED ON SECTION 1615.1 SEISMIC IMPORTANCE FACTOR: Ie = 1 (TABLE 1604.5) SITE (SOIL) CLASS - VFY WITH SOIL TEST SECTION 1615.1.2 STRUCTURAL FRAMING AND SEISMIC RESISTING SYSTEM: LIGHT-FRAMED WALLS WITH SHEAR PANELS

. FOUNDATION

FOUNDATIONS ARE DESIGNED TO BEAR ON NATURAL GRADE OR FILL, WELL COMPACTED OF AN ALLOWABLE BEARING CAPACITY, INDICATED ON THE

- A CERTIFIED TESTING LABORATORY SHALL BE ENGAGED BY THE OWNER TO PERFORM SOIL BORINGS, PROVIDE A FOUNDATION REPORT AND VERIFY THAT THE REQUIRED MINIMUM BEARING CAPACITY WAS OBTAINED.
- SAID SOIL CAPACITY SHALL BE CERTIFIED AND TESTED BY A REGISTERED FOUNDATION ENGINEER, PRIOR TO CASTING OF CONCRETE IN THE
- BOTTOM OF FOOTING ELEVATION TO BE DETERMINED BY THE SOIL CONDITIONS AND FROST-LINE DEPTH.
- ALL LONGITUDINAL REBARS IN THE WALL FOOTINGS, SHALL BE CONTINUOS AND CORNERS BY BENDING THE REBARS 48 BAR DIAMETERS AROUND THE BAR-DIAMETERS INTO FOOTING EACH SIDE OF CORNER OR BENT

D. REINFORCED CONCRETE

- A. SPECIFICATIONS: IN GENERAL, COMPLY WITH ACI 301-(LATEST EDITION) "SPECIFICATIONS FOR STRUCTURAL CONCRETE FOR BUILDINGS." B. STRUCTURAL CONCRETE:
- II. INTERIOR SLABS ON GRADE, AND ALL INTERIOR CONCRETE NOT OTHERWISE
- EXTERIOR SLABS ON GRADE, AND ALL EXTERIOR CONCRETE (WITH AIR) NOT
- OTHERWISE IDENTIFIED IV. BACKFILL BELOW FOOTINGS AND GRADE BEAMS
- C. ALL DEFORMED REINFORCING BARS: FY = 60,000, D. GALVANIZED WELDED WIRE FABRIC SHALL CONFORM TO ASTM A165 (LATEST EDITION). USE SHEET FORM, NOT ROLLED.
- 2. FIELD MANUAL: PROVIDE AT LEAST ONE COPY OF THE ACI FIELD REFERENCE MANUAL, SP-15, IN THE FIELD OFFICE AT ALL TIMES.
- A. PROVIDE SUPPORTS AS REQUIRED TO MAINTAIN ALIGNMENT AND CONCRETE COVER OVER THE REINFORCING.
- VERTICAL DOWELS IN FOOTINGS TO MATCH VERTICAL WALL REINFORCING. B. PROVIDE LEAN CONCRETE (CLASS IV) UNDER FOUNDATIONS FOR ACCIDENTAL OVER-EXCAVATION, SOFT SPOTS AND TRENCHES.
- 5. SPLICES: UNLESS NOTED OTHERWISE, MINIMUM LAP SPLICE LENGTHS TO
- BE AS FOLLOWS:

 A. VERTICAL BARS IN WALLS, PIERS, OR COLUMNS (INCLUDING DOWELS)
- B. HORIZONTAL BARS IN SLABS & FOOTING
 C. HORIZONTAL BARS IN WALL
- 6. SAW-CUT & CONSTRUCTION JOINTS: PROVIDE JOINTS IN ALL SLABS-ON-GRADE, AS INDICATED ON THE FOUNDATION

7. CONCRETE COVER: UNLESS NOTED OTHERWISE, DETAIL REINFORCING TO

- A. CONCRETE CAST AGAINST AND PERMANENTLY B. CONCRETE EXPOSED TO EARTH OR WEATHER: 1-1/2 INCHES #5 BARS AND SMALLER
- C. CONCRETE NOT EXPOSED TO EARTH OR WEATHER: BEAM AND COLUMN BARS INCLUDING TIES, STIRRUPS AND SPIRALS 1-1/2 INCHES SLABS, WALLS, JOISTS: #11 BARS AND SMALLER

STRUCTURAL STEEL

STRUCTURAL STEEL: ASTM A36, FY = 36 KSI: ASTM A572. ANCHOR BOLTS: ASTM A307 OR A36: ELECTRODES: SERIES E70: EXPANSION BOLTS: HILTI "KWIK BOLTS" OR APPROVED EQUAL.

1-1/2 INCHES

SPECIFICATIONS: WELDING PERSONNEL AND PROCEDURES ARE TO BE QUALIFIED PER AWS D1.1. UNLESS SPECIFICALLY SHOWN OTHERWISE, DESIGN, FABRICATION AND ERECTION TO BE GOVERNED BY: (ALL CODES - LATEST EDITION) AISC SPECIFICATION FOR STRUCTURAL STEEL BUILDINGS.

- AISC CODE OF STANDARD PRACTICE. STRUCTURAL WELDING CODE, AWS D1.1- OF THE AMERICAN WELDING
- CONNECTIONS: CONNECTIONS TO BE DESIGNED BY THE FABRICATOR TO DEVELOP FULL STRENGTH OF MEMBER OR FORCES SHOWN ON THE PLANS, WHICHEVER GOVERNS. FOLLOW INSTRUCTIONS ON DRAWINGS FOR GENERAL
- ARRANGEMENT OR PARTICULAR DETAILS. 4. GALVANIZING: ALL SHELF ANGLES, LINTELS IN EXTERIOR WALLS, AND ALL EXTERIOR STEEL EXPOSED TO THE ELEMENTS SHALL BE HOT DIP GALVANIZED.
- PROVIDE HOLES FOR OTHERS. IF OPENING IS NOT SHOWN ON THE
- STRUCTURAL DRAWINGS, OBTAIN PRIOR APPROVAL. STEEL SUPPORTING OR CONNECTED TO HVAC AND OTHER EQUIPMENT AND ROOF OPENINGS AS SHOWN ON THE DRAWINGS IS SHOWN FOR BIDDING PURPOSES ONLY. CONTRACTOR SHALL RECONCILE EXACT SIZE AND LOCATION BEFORE PROCEEDING WITH HIS WORK.
- GROUT UNDER BEARING PLATES, BASE PLATES, AND SETTING PLATES TO BE NON-SHRINKING TYPE. STEEL BELOW GRADE TO BE PROTECTED BY A MIN. OF 3 INCHES OF
- PROVIDE HEAVY WASHER AT ALL ANCHOR BOLTS. EMBEDMENT LENGTH OF EXPANSION BOLTS INTO SOLID MASONRY OR CONCRETE SHALL BE AS FOLLOWS: 1/2 INCH DIAMETER BOLTS --- 3 1/2 INCHES EMBEDMENT 3/4 INCH DIAMETER BOLTS --- 5 INCHES EMBEDMENT

F. MASONRY

- MATERIALS: A. CONCRETE BLOCK: ASTM C90 (HOLLOW) ASTM C145 (SOLID).
 - MINIMUM (AT 28 DAYS). BOND BEAM AND CORE FILL: ASTM C476, COARSE TYPE. JOINT REINFORCING: MILL GALVANIZED FINISH, 9 GAGE MINIMUM SIDE WIRES AND
- E. BAR REINFORCING: ASTM A615, GRADE 60.
- REINFORCED MASONRY, WHERE VERTICAL BARS ARE TO BE GROUTED INTO CORES, THE FOLLOWING REQUIREMENTS APPLY:

MORTAR: ASTM C270 TYPE "S", AVERAGE COMPRESSIVE STRENGTH: 1800 PSI

- PROVIDE DOWELS FROM FOOTING, SAME SIZE AND SPACING AS WALL BARS. LAP 12 INCHES MINIMUM WITH WALL BAR. EMBED INTO FOOTING 9 INCHES. PROVIDE A CONTINUOUS VERTICAL CAVITY, AT LEAST 2"x3" IN SIZE, FREE OF MORTAR DROPPINGS.
- AT SPLICES IN VERTICAL BARS, PROVIDE MECHANICAL COUPLERS OR 48 DIAMETER ALL REINFORCEMENT MUST BE INSTALLED AND SECURELY ANCHORED IN PLACE PRIOR TO PLACEMENT OF GROUT.
- FILL CORE SOLID AROUND ANCHOR BOLTS PROVIDE 100% SOLID BLOCKS OR SOLIDLY FILLED HOLLOW BLOCKS AT ALL
- EXPANSION BOLT LOCATIONS. C. HOLLOW MASONRY UNITS TO BE LAID WITH FULL MORTAR COVERAGE ON HORIZONTAL AND VERTICAL FACE SHELLS. WEBS SHALL ALSO BE BEDDED IN ALL COURSES IN THE STARTING COURSE ON FOOTINGS, AND WHEN ADJACENT TO CELLS OR CAVITIES TO BE REINFORCED OR FILLED WITH CONCRETE OR GROUT.

 SOLID UNITS TO BE LAID WITH FULL HEAD AND BED JOINTS.
- PROVIDE JOINT REINFORCING AT 16 INCHES, EXCEPT AS NOTED LAP JOINT REINFORCING 6 INCHES FOR STANDARD, 15 INCHES FOR HEAVY 6. WHERE MASONRY UNITS ARE USED ABOVE HOLLOW UNITS OF A DIFFERENT THICKNESS, PROVIDE A CONTINUOUS COURSE OF 100% SOLID MASONRY (OR SOLID

GROUTED BLOCK) AT LEAST 8 INCHES HIGH BELOW TRANSITION.

H. STRUCTURAL LUMBER A. STUDS: STRUCTURAL LUMBER: DOUGLAS FIR-LARCH #2, OR APPROVED EQUAL:

- ROOF/WALL: ORIENTED STRAND BOARD: STRUCTURAL 1, EXPOSURE I, EXTERIOR GLUE FOR ROOF AND WALLS PANEL IDENTIFICATION INDEX 24/16 - 5/8 INCH OR 24/0 - 1/2 INCH (WITH PLYWOOD CLIPS AT ROOF).
- ROOF/WALL: PLYWOOD: C-CPLUGGED, STRUCTURAL 1, EXPOSURE 1. EXTERIOR GLUE FOR ROOF AND WALL PANEL IDENTIFICATION INDEX 24/16-5/8 INCH OR 24/0-1/2 INCH (WITH PLYWOOD CLIPS AT ROOF).

 D. SILL PLATES: NO. 2 SPRUCE-PINE-FIR, OR EQUAL FC=675 PSI, FV=70 PSI, E=
- SPECIFICATIONS: UNLESS SPECIFICALLY SHOWN OTHERWISE, DESIGN, FABRICATION AND FRECTION SHALL BE GOVERNED BY THE LATEST REVISIONS OF: NATIONAL DESIGN SPECIFICATION FOR STRESS-GRADE LUMBER AND ITS FASTENINGS.
 B. U.S. PRODUCT STANDARD PS-1 FOR SOFTWOOD PLYWOOD - CONSTRUCTION AND
- A. JOISTS TO BEAMS 16 GA. GALVANIZED STD. JOIST HANGERS, UNLESS SHOWN B. PLYWOOD TO ROOF TRUSSES OR RAFTERS - NAILED - USE 8d RING SHANK NAILS AT 6 INCHES O/C AT PANEL EDGES AND 12 INCHES C/C AT INTERMEDIATE SUPPORTS. PROVIDE PLYWOOD CLIPS AT MID-SPAN OF PLYWOOD BETWEEN SUPPORTS.
- 4. ALL STRUCTURAL WOOD TO BE SURFACED FOUR (4) SIDES (S-4-S) A AND MAXIMUM MOISTURE CONTENT OF 19 PERCENT.
- ALL LUMBER AND PLYWOOD IN CONTACT WITH CONCRETE, STUCCO, MASONRY OR OTHER CEMENTITIOUS MATERIALS SHALL BE TREATED WITH AN E.P.A. ACCEPTABLE WOOD PRESERVATIVE (SUCH AS "AQC" - ALKALINE-COPPER-QUATERNARY OR "CBA-A" COPPER
- ALL WOOD CONNECTORS SHALL BE GALVANIZED STEEL OR RUST-PROOF PAINTED STEEL (U.O.N.). ALL GALVANIZED METAL CONNECTORS IN CONTACT WITH TREATED WOOD (ITEM #5) SHALL BE "TRIPLE-ZINK G-185" GALVANIZED. ANY FIELD WELDS (INTERIOR OR EXTERIOR) OF SUCH CONNECTORS SHALL BE WIRE BRUSH CLEANED AND RUST PROOF
- MISCELLANEOUS:
- A. USE ONE LINE OF SOLID BLOCKING OR CROSS BRIDGING AT 8'- 0" O/C MAX. FOR ALL JOISTS AND RAFTERS, USE SOLID BLOCKING AT JOIST AND RAFTER BEARING.
 B. USE SOLID BLOCKING AT MID-HEIGHT FOR ALL EXTERIOR STUD WALLS AND INTERIOR BEARING PARTITIONS.
 C. USE DOUBLE STUDS UNDER BEAM AND LINTEL BEARING, UNLESS SHOWN

I. PREFABRICATED WOOD TRUSSES

LUMBER: SEE "STRUCTURAL LUMBER" SECTION FOR WOOD INFORMATION.
METAL CONNECTOR PLATES: GALVANIZED SHEET STEEL ASTM A446 (LATEST EDITION) GRADE "A". COATING CLASS G60 PER ASTM A525 (LATEST EDITION). MANUFACTURED WITH HOLES, PLUGS, TEETH, OR PRONGS UNIFORMLY SPACED AND FORMED. SEE "STRUCTURAL LUMBER" SECTION FOR GALVANIZED CONNECTIONS FOR TREATED

DESIGN CRITERIA: A. LOADING:

TOP CHORD LIVE LOAD TOP CHORD DEAD LOAD: 20 PSF + MECH EQUIP BOTTOM CHORD DEAD LOAD: NET WIND LIPLIET:

DESIGN OF MEMBERS AND CONNECTIONS IS TO BE BY A PROFESSIONAL ENGINEER, REGISTERED IN THE STATE OF THIS PROJECT, EXPERIENCED IN SIMILAR DESIGN, RETAINED BY THE TRUSS MANUFACTURER. SHOP DRAWINGS SHALL BE SIGNED AND SEALED BY THE ENGINEER RESPONSIBLE FOR THE TRUSS DESIGN. IN ADDITION, SIGNED AND SEALED DESIGN CALCULATIONS FOR THESE TRUSSES SHALL BE SUBMITTED TO THE ARCHITECT FOR REVIEW. MEMBER SIZES SHOWN ARE MINIMUM SIZES. MAXIMUM LIVE LOAD DEFLECTION IS TO BE L/360.

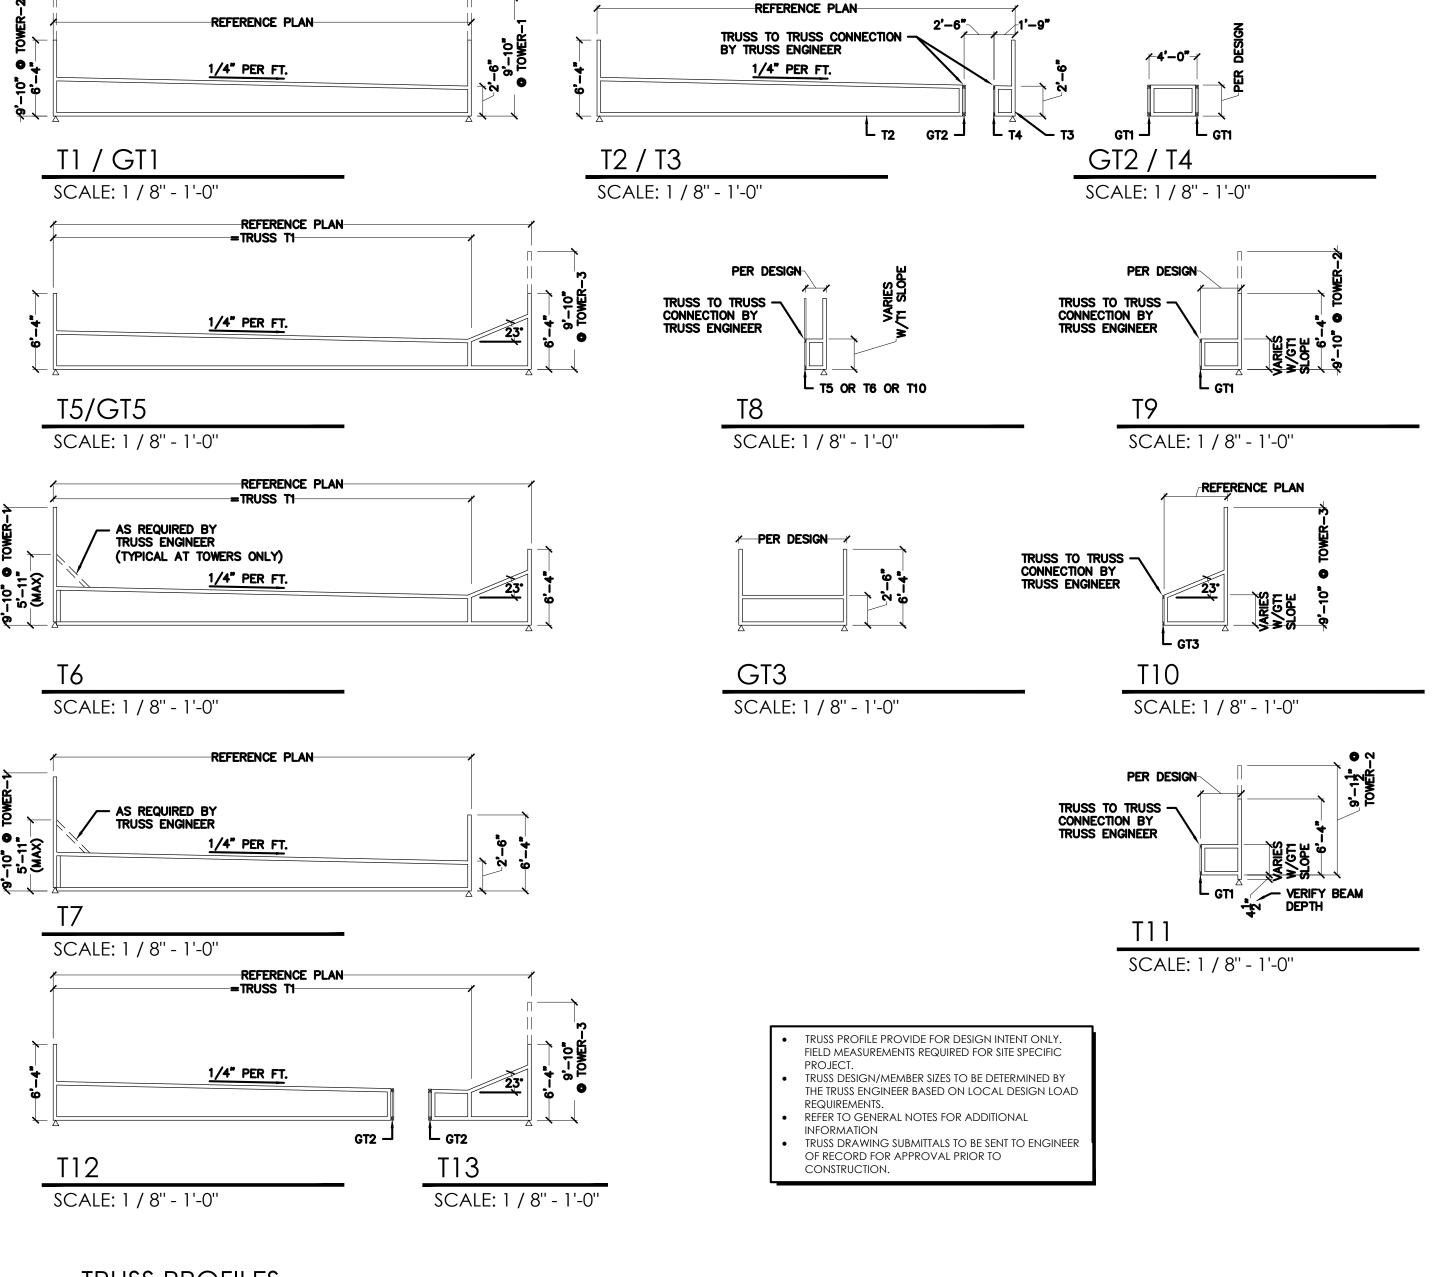
MAXIMUM TOTAL LOAD DEFLECTION IS TO BE L/240.

A. BOLT TOP CHORDS OF ALL MULTIPLE MEMBER TRUSSES TOGETHER WITH 1/2"Ø BOLTS AT 4'-0" O.C.. BOLT WEB MEMBERS TOGETHER WITH 1/2"Ø BOLTS AT 2'-0" O.C. AT CONCENTRATED LOADS LINESS OTHERWISE SPECIFIED BY THE TRUSS DESIGN ENGINEER B. VERIFY ALL DIMENSIONS, ELEVATIONS AND SLOPES PRIOR TO MANUFACTURING, REPORT ANY DISCREPANCIES IMMEDIATELY TO THE ARCHITECT.


C. WOOD TRUSSES SHALL BE DESIGNED AND FABRICATED TO CONFORM TO THE GEOMETRY SHOWN ON THE DRAWINGS. WEB CONFIGURATIONS ARE TO BE DETAILED AS REQUIRED BY THE DESIGNER/FABRICATOR. D. PROVIDE 2x4 BOTTOM CHORD BRIDGING AT A MAXIMUM SPACING OF 10'-0" O.C.

J. ABBREVIATIONS:

T.O.W. = TOP OF WALL ELEVATIONS B = BOTTOMC.M.U. = CONCRETE MASONRY UNIT W.W.F. = WELDED WIRE FABRIC E.F. = EACH FACE U.N.O. = UNLESS NOTED OTHERWISE E.W. = EACH WAY TYP = TYPICAL T.B. = TRUSS BEARING ELEVATION E.E. = EACH END J.B. = JOIST BEARING ELEVATION T.O.F. = TOP OF FOOTING ELEVATION L.L.V. = LONG LEG VERTICAL T.O.S. = TOP OF SLAB ELEVATION L.L.H. = LONG LEG HORIZONTAL



TRUSS PROFILES

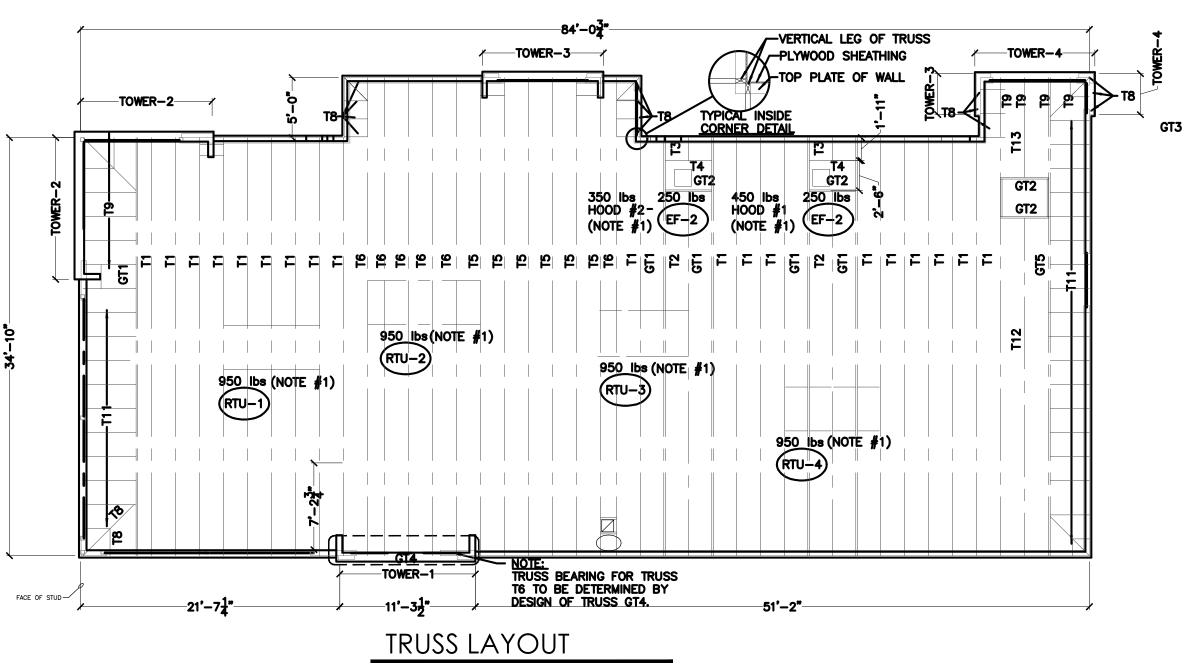


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FLOOR PLAN

	B.O.H FINISH SCHEDULE							
CODE	MATERIAL	LOCATION	SOURCE	PRODUCT	COLOR	DIMENSIONS		
CT-10G	TILE	BACK OF HOUSE	GRANITE FIANDRE/ EUROWEST	TCG0606142	CAPITOL GRAY TX	6" x 6"		
FRP-1G	FIBERGLASS REINFORCED PANEL	BACK OF HOUSE	MARLITE	FRP SYMMETRIX 204561B (4'x8') 204551 (4'x10') WHITE/BLK CORE NO TOP COAT (GRAY SCORE LINE)	A916 G312	6" x 6"		
GR-6G	TILE	BACK OF HOUSE	LATICRETE	SPECTRALOCK 2000 IG	#45 RAVEN			
			CUSTOM BUILDING PRODUCTS	CEG-IG INDUSTRIAL GRADE 100% SOLIDS EPOXY GROUT	#370 DOVE GRAY			

GENERAL NOTES:

A. ALL DIMENSIONS ARE TO FACE OF STUDS

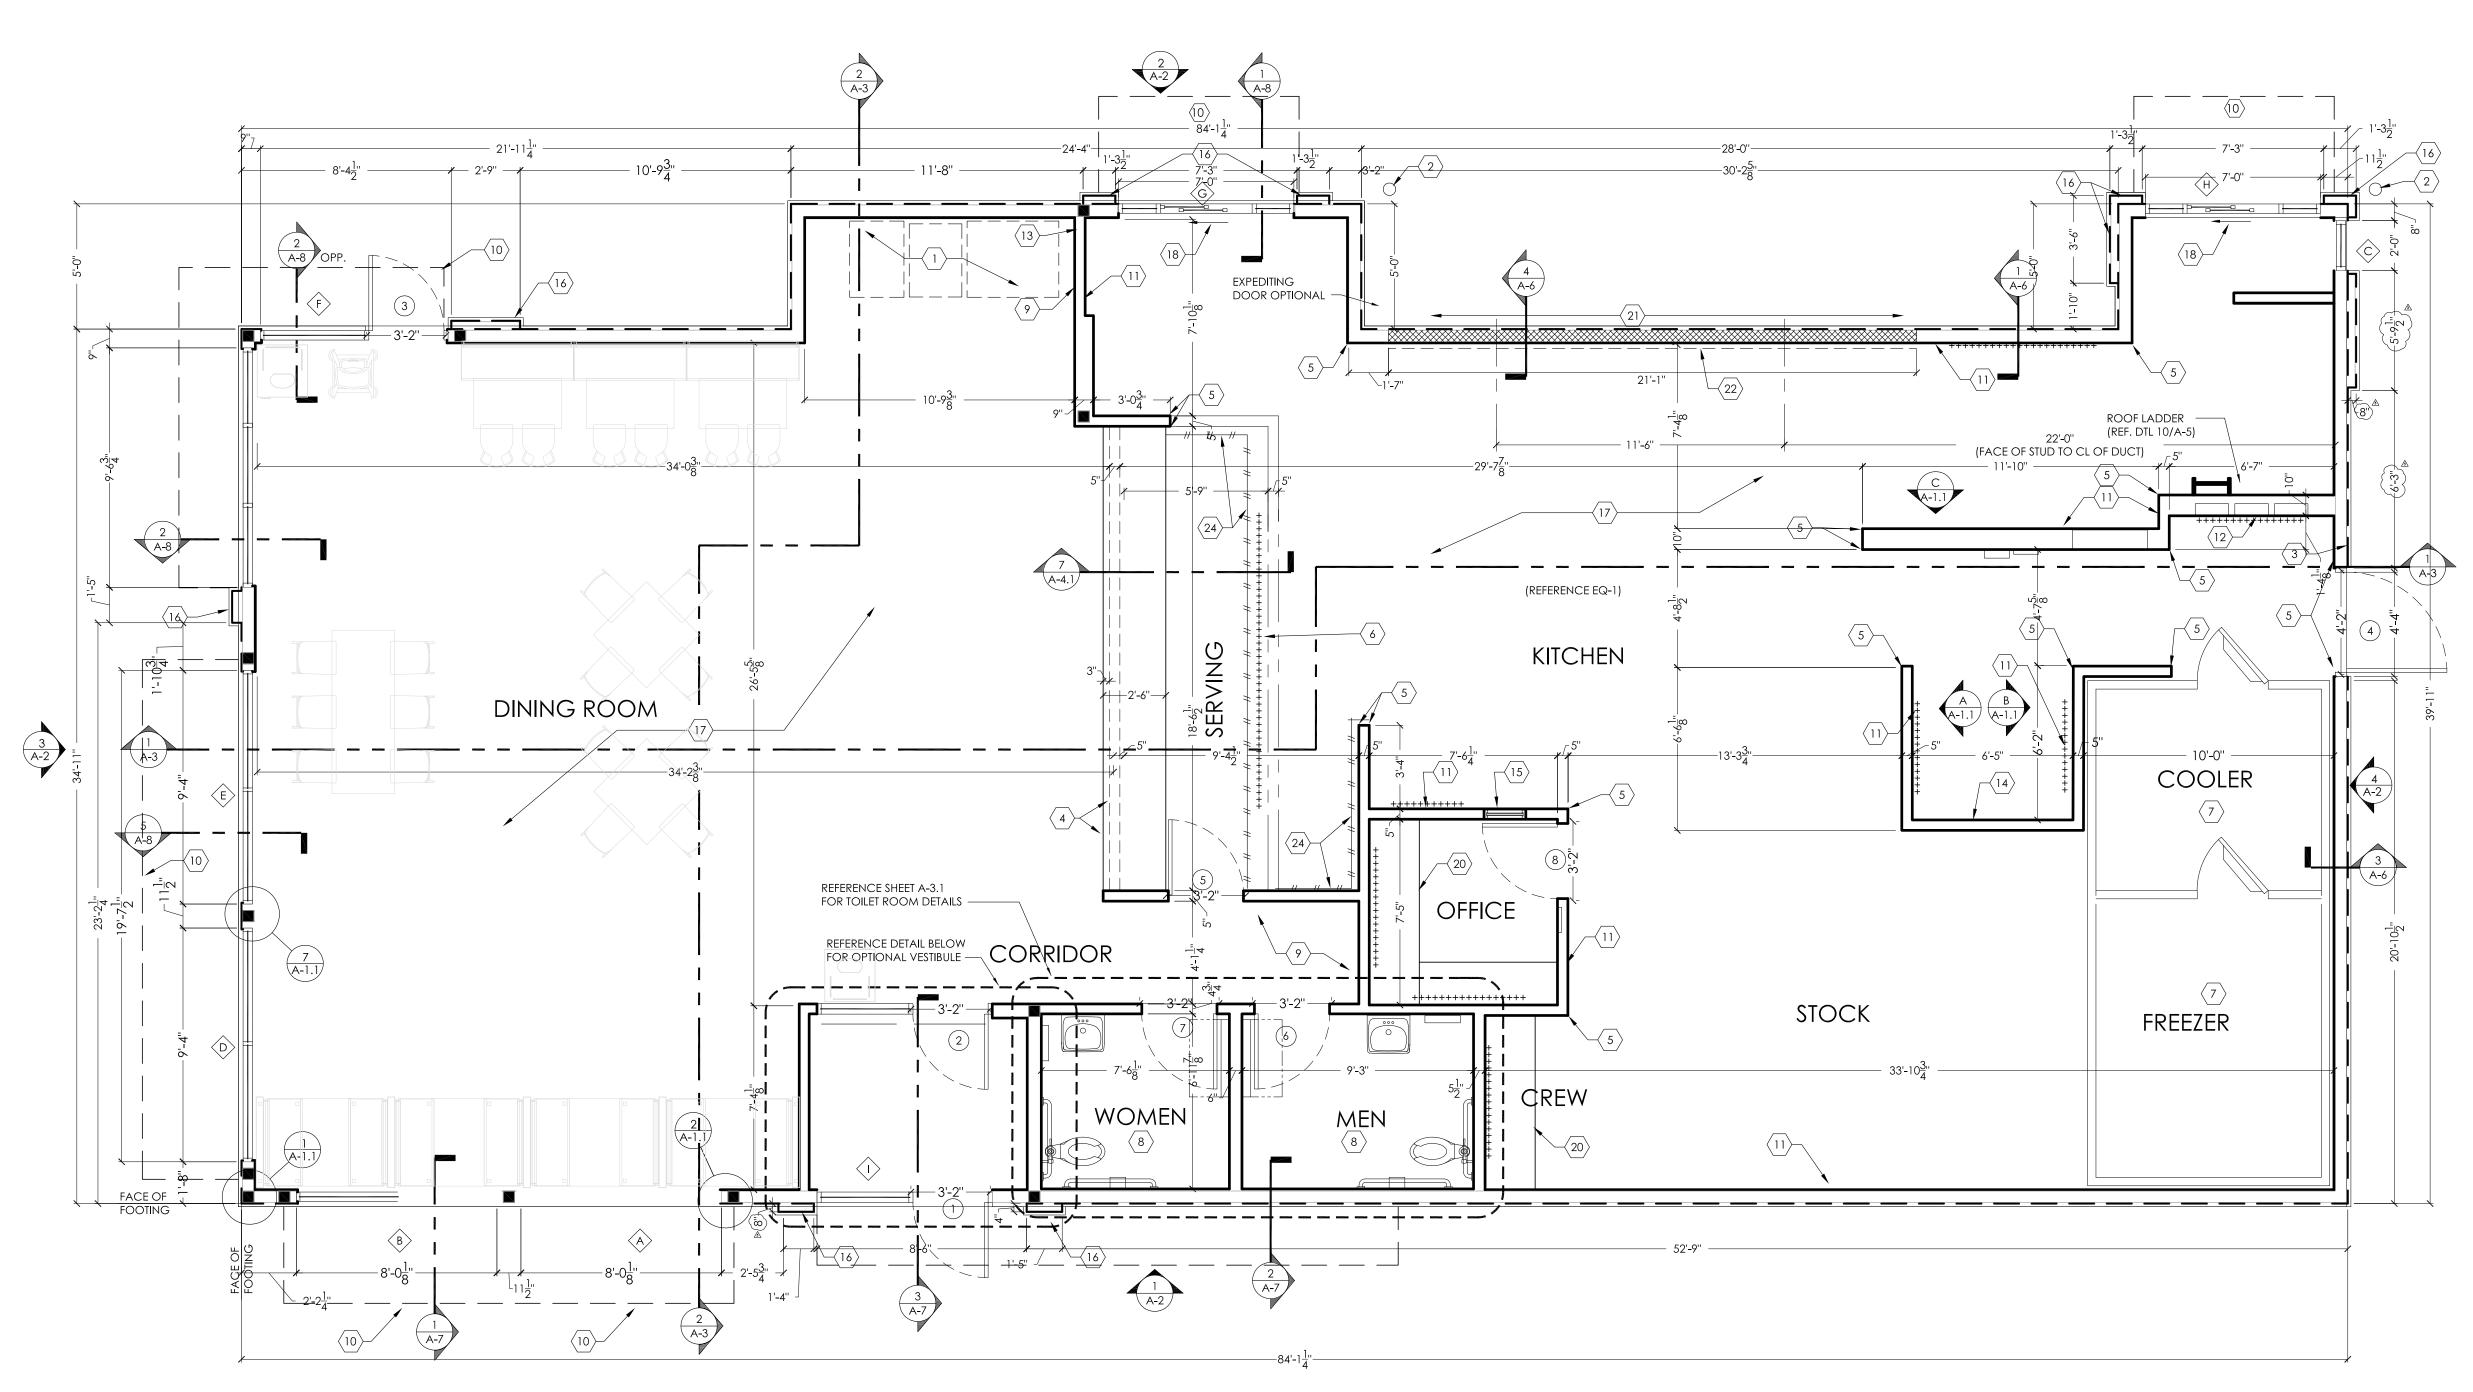B. OVERALL DIMENSIONS TO EXTERIOR WALLS ARE THE SAME AS TO THE OUTSIDE

FACE OF FOUNDATION WALL BELOW.

C. ALL ANGLED WALLS ARE AT 90° UNLESS NOTED OTHERWISE.D. FIRE EXTINGUISHER, SHALL COMPLY WITH APPLICABLE BUILDING CODES AND LOCAL RESTRICTIONS.

E. ELEVATION OF DRIVE-THROUGH LANE 2" (MAXIMUM) BELOW FINISH FLOOR ELEVATION. DRIVE-THROUGH LANE AT SAME ELEVATION AS FINISH FLOOR

IS PREFERRED. REFERENCE DETAIL #5, SHEET A-1.1 F. FOR DOOR AND WINDOW TYPES, REFER TO SHEET A-10.

○ KEYED NOTES:

1. SELF-SERVE DRINKS AND CONDIMENT STAND. REFER TO KITCHEN DRAWINGS.

2. STEEL BOLLARD - REFER TO SHEET S-1.

3. ELECTRIC SERVICE. REFER TO ELECTRICAL DRAWINGS. 4. SERVICE COUNTER PARTITION BY G.C. REFER TO DETAILS ON SHEET E-4 FOR ADDITIONAL INFORMATION. COORDINATE COUNTER TOP/FINISHES INSTALLATION RESPONSIBILITIES WITH THE DECOR SUPPLIER. MAXIMUM COUNTER HEIGHT = 32"

5. CORNER GUARDS - REFER TO DETAIL #4, SHEET A-1.1.

6. MENU BOARD BULKHEAD ABOVE. REFER TO SHEET A-4.1 7. INTERIOR WALK-IN BOX WITH FLOOR ON CONCRETE SLAB. VERIFY SIZE WITH

MANUFACTURER. 8. PROVIDE ADDITIONAL BLOCKING IN WALLS BEHIND URINAL SCREEN AND BEHIND

PLUMBING FIXTURES FOR SUPPORT OF WATER LINES (TYPICAL).

9. ALL WALLS AT EXPOSED TRUSSES TO BE FRAMED AND FINISHED TO THE ROOF DECK. 10. LINE OF CANOPY ABOVE.

11. SUBSTRATE PANELS: KITCHEN - CREW - RESTROOMS

5/8" USG "DUROCK" PANELS AT FINISH FLOOR TO 24" A.F.F. 5/8" WATER RESISTANT GYPSUM BOARD FROM 24" A.F.F. TO 6" ABOVE FINISHED

CEILING.

DINING ROOM - CORRIDOR

5/8" TYPE USG "SHEETROCK" TYPE "X" GYPSUM WALL BOARD. FINISH: CORONADO PAINT - LIGHT ORANGE PEEL APPLIED WITH CORONADO AIR

ASSIST TIP (Z-122KD) OR EQUAL 12. ELECTRICAL PANELS OPTION #1: RECESS ELECTRICAL CONTACTOR PANEL AND PANELS "A", "B" AND "M" IN FURRED

OUT WALL ADJACENT TO EXTERIOR FRAMING. G.C. TO VERIFY PANEL SIZES

PRIOR TO FURR-OUT TO INSURE ADEQUATE SPACE. 13. PROVIDE 10"x10" FINISHED OPENING THROUGH WALL CENTERED AT 13" A.F.F. FOR

ROUTING OF UTILITIES. 14. CAN WASH - DUROCK SUBSTRATE ON ALL THREE SIDES, FLOOR TO CEILING. 15. OFFICE WINDOW - REFERENCE SHEET A-10 16. Š" DEEP FURŘ-OŬT ELEMENT, 22" FINISH WIDTH MINIMUM (U.N.O.). REFER TO WALL SECTIONS. PROVIDE 16" DEEP CONCRETE CURB (REF. FOUNDATION PLAN) AND

17. TILE FLOOR. 18. DRIVE-THROUGH SLIDING WINDOW. 19. ++++++ INDICATES 5/8" PLYWOOD BACKING ON WALLS FOR EQUIPMENT AS

INDICATED ON PLAN OR SHELF SUPPORT FROM 48" A.F.F. TO 96" A.F.F., BEHIND 3-COMPARTMENT SINK AND PREP SINK AND ON BULKHEAD AT MENU BOARD WALL FROM 6'-8" A.F.F. TO BOTTOM OF ROOF TRUSSES.

FRAMING AS REQUIRED FOR FINISH DIMENSION REQUIREMENTS.

20. COUNTER TOP - REFERENCE DETAIL #6, A-1.1. 21. USG 5/8" DUROCK (BOTH SIDES) ON 3-5/8", 18 GAUGE CEE STUD FRAMING AT 16"

O.C. BEHIND HOOD. WALL TO EXTEND 18" BEYOND EACH END OF HOOD.

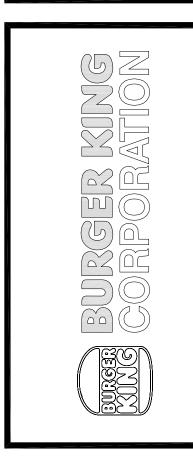
22. STAINLESS STEEL PANELS BELOW AND 18" WIDE AT EACH SIDE OF HOOD SUPPLIED BY HOOD MANUFACTURER AND INSTALLED BY G.C.

23. 4" CONCRETE WALK BETWEEN DRIVE-THROUGH BUMP-OUTS. CONCRETE WALK IS

NOT REQUIRED IF EXPEDITING DOORS ARE NOT USED.

24. —//—//— INDICATES 3"x12" SUBWAY TILE. REFER TO DECOR. REMAINING BACK OF HOUSE WALLS TO BE FINISHED IN FIBERGLASS REINFORCED PANELS, FRP-1G

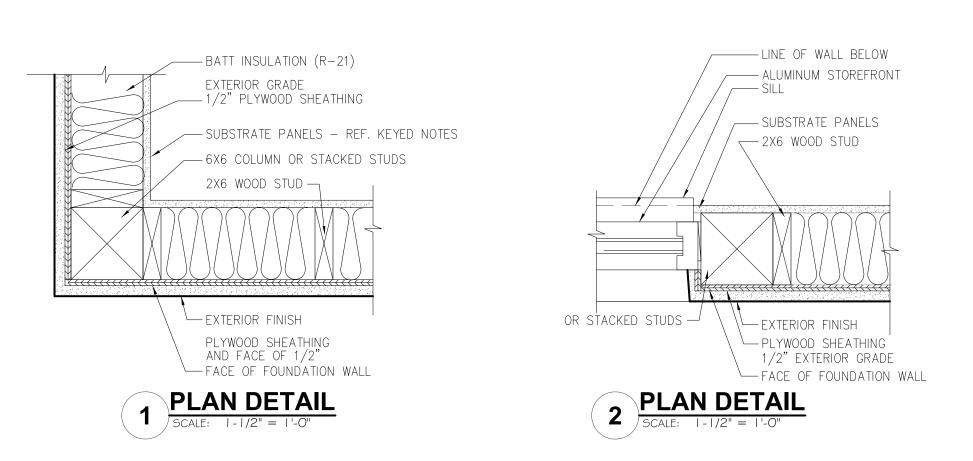
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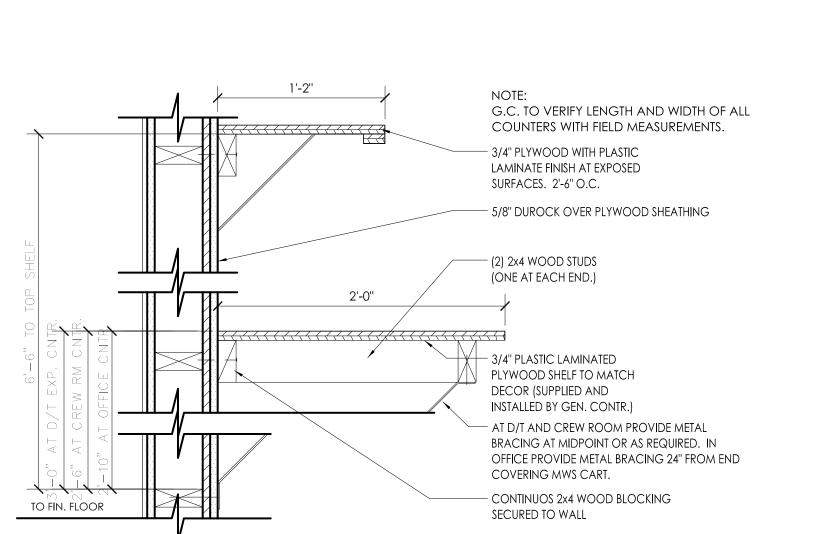







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PROJECT BURGER KING 1440 NAPPANEE ST, ELKHART, IN 46514	SHEET TITLE	FLOOR PLAN
DO NOT SCALE FIGURED DIMEN		
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SHEET .	_	





6 OFFICE COUNTER DETAIL

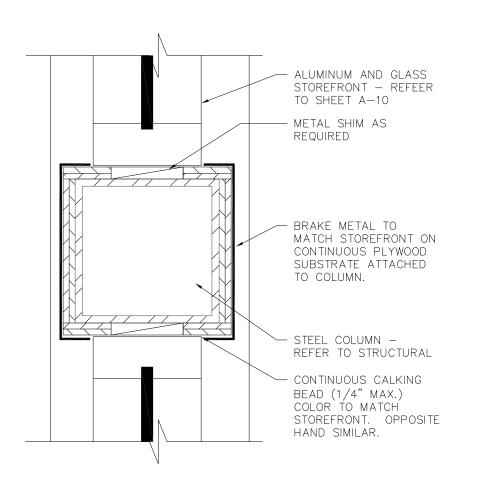SCALE: 1-1/2" = 1'-0"



2x4 WOOD STUDS

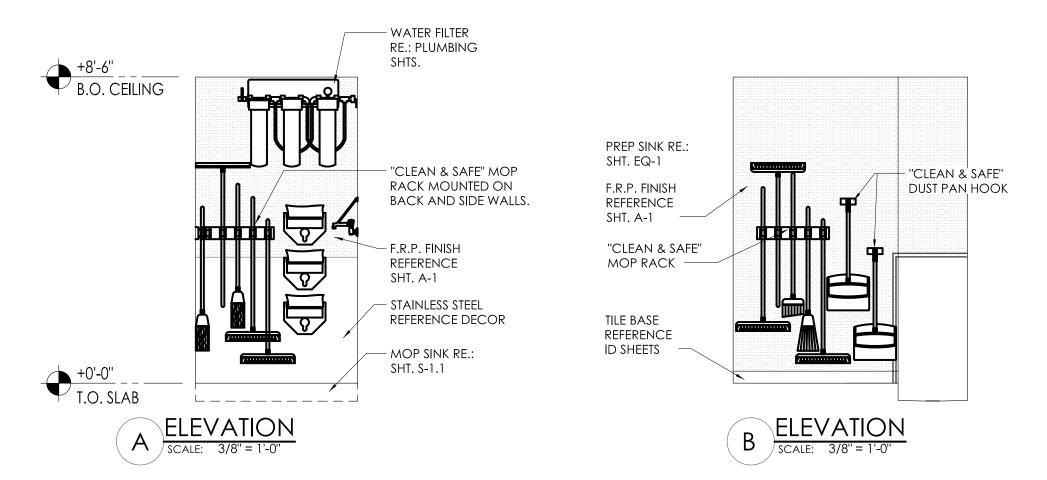
(REF. FRAMING PLAN)

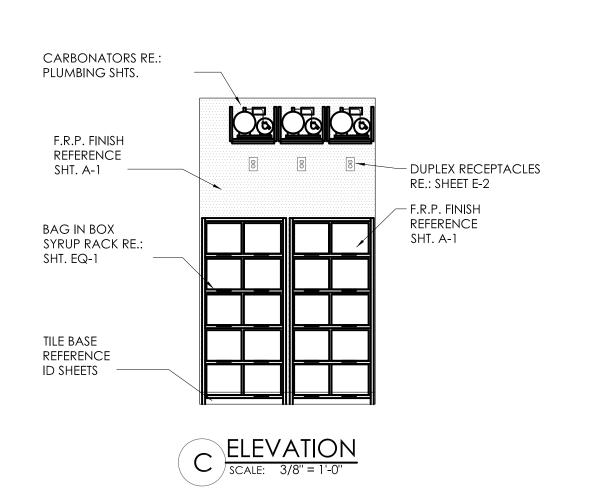
SUBSTRATE PANELS

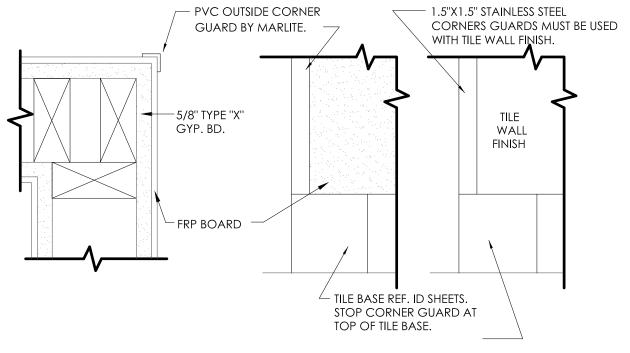
3 TYPICAL INTERIOR PARTITION

SCALE: 1-1/2" = 1'-0"












PLAN VIEW ELEVATION 4 CORNER GUARD DETAIL

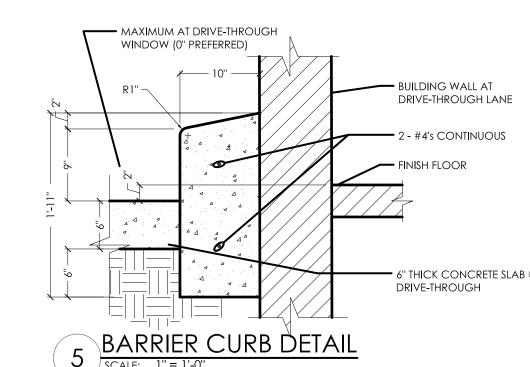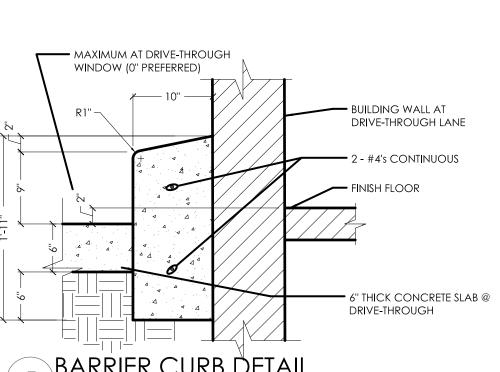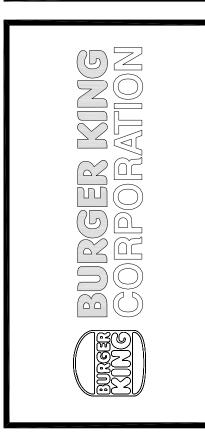SCALE: 1-1/2" = 1'-0"







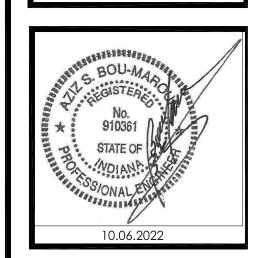
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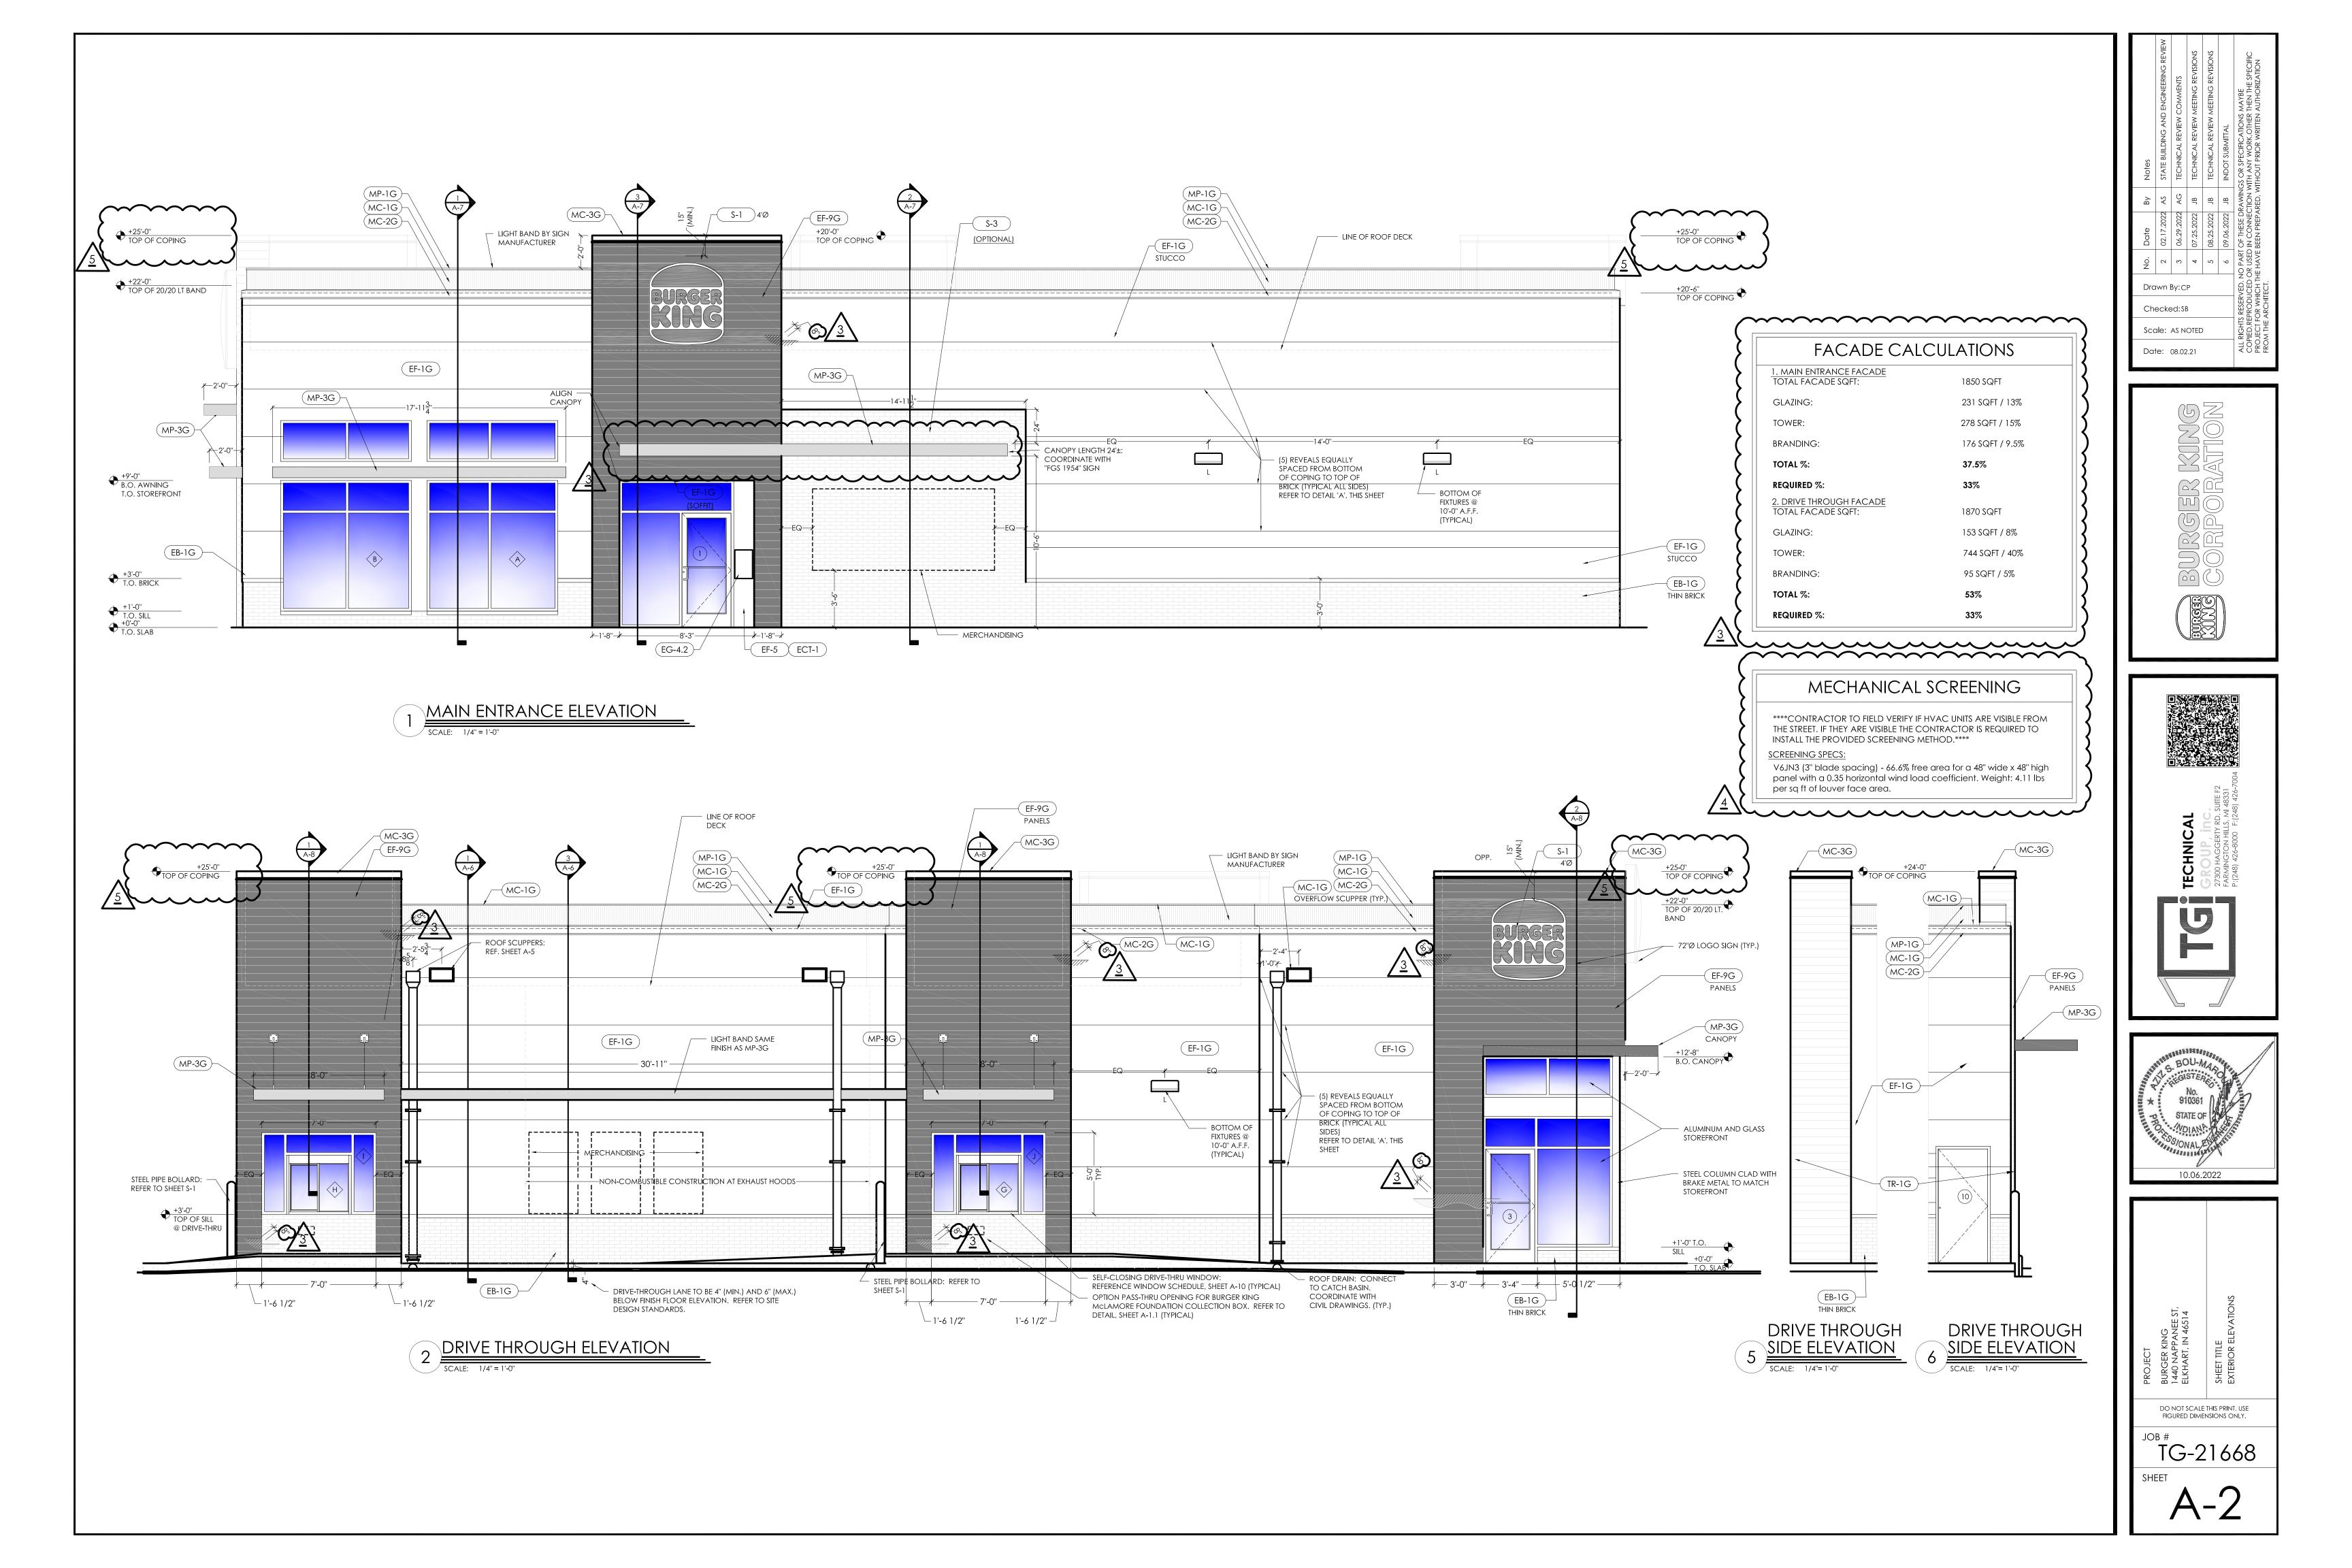
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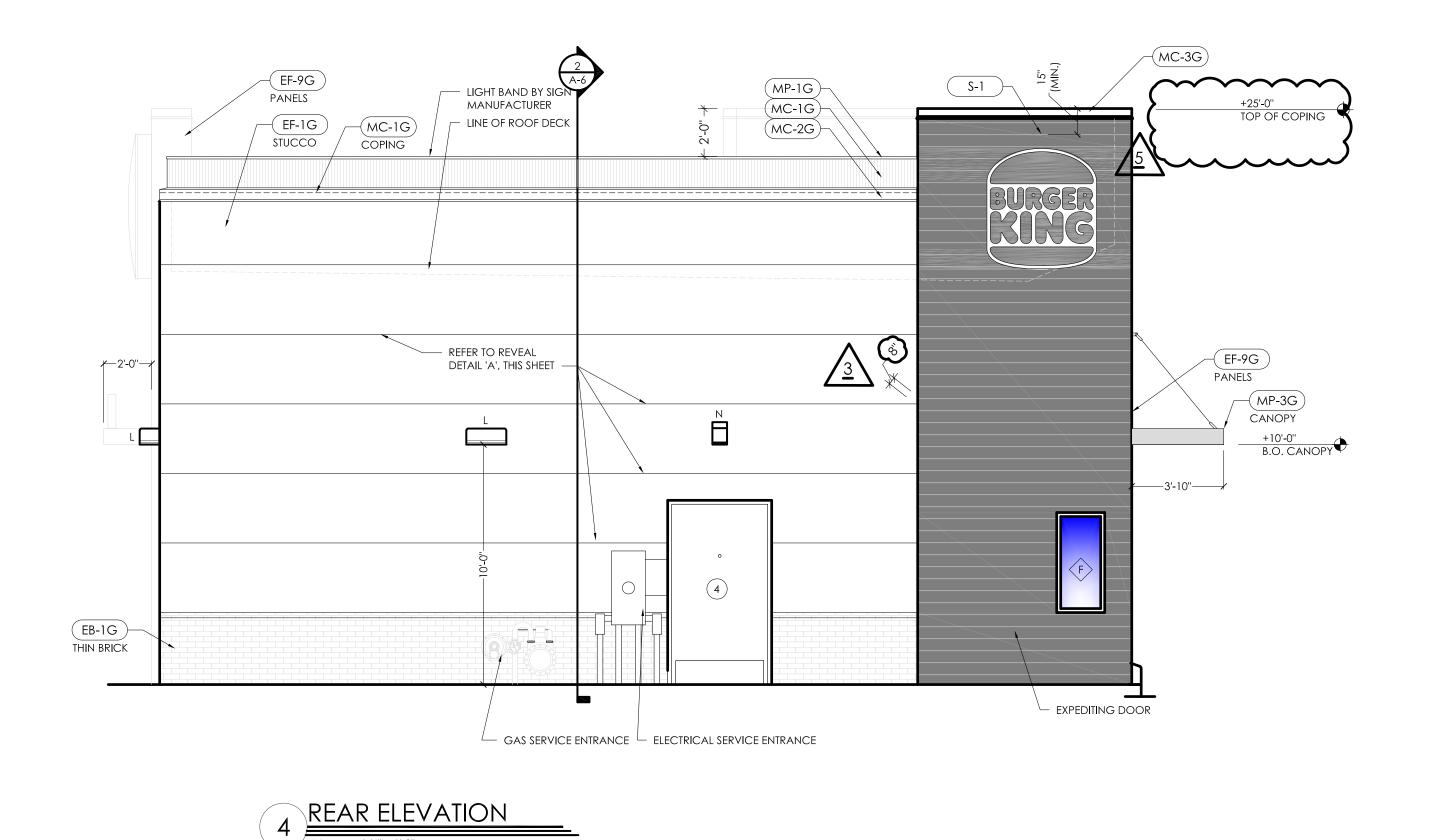
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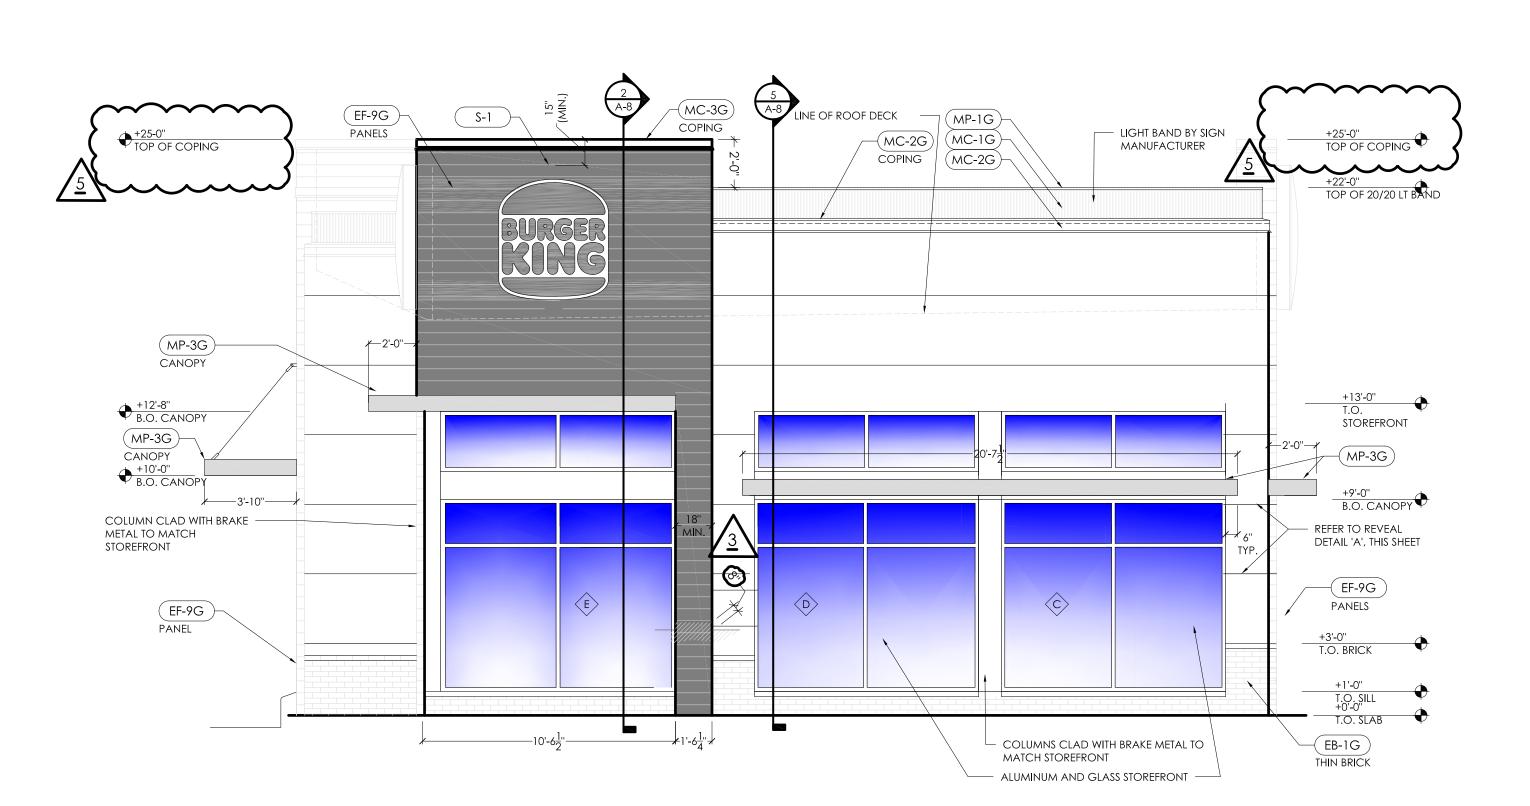


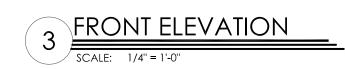


PROJECT	BURGER KING 1440 NAPPANEE ST, ELKHART, IN 46514	SHEET TITLE MISCELLANEOUS DETAILS	
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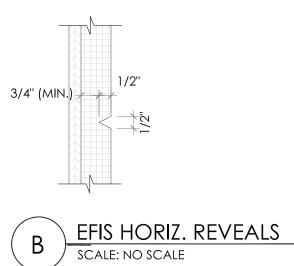








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FACADE CALCULATIONS

900 SQFT

9 SQFT / 1%

215 SQFT / 24%

70 SQFT / 8%

33%

33%

814 SQFT

300 SQFT / 36%

295 SQFT / 36%

57 SQFT / 7%

33%

1. REAR FACADE TOTAL FACADE SQFT:

GLAZING:

BRANDING:

TOTAL %:

GLAZING:

BRANDING:

TOTAL %:

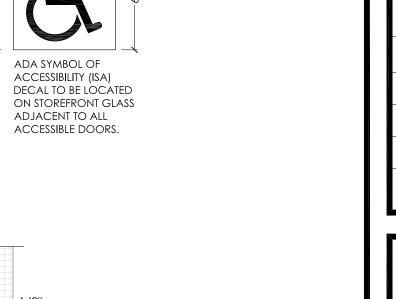
REQUIRED %:

TOWER:

REQUIRED %:

2. FRONT FACADE TOTAL FACADE SQFT:

TOWER:



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Checked:SB

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Date: 08.02.21







10.06.2022						
PROJECT BURGER KING 1440 NAPPANEE ST, ELKHART, IN 46514	SHEET TITLE EXTERIOR ELEVATIONS					
PROJECT BURGER KING 1440 NAPPANI ELKHART, IN 46	SHEET TITLE EXTERIOR E					

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TG-21668

****CONTRACTOR TO FIELD VERIFY IF HVAC UNITS ARE VISIBLE FROM THE STREET. IF THEY ARE VISIBLE THE CONTRACTOR IS REQUIRED TO INSTALL THE PROVIDED SCREENING METHOD.****

SCREENING SPECS:

V6JN3 (3" blade spacing) - 66.6% free area for a 48" wide x 48" high panel with a 0.35 horizontal wind load coefficient. Weight: 4.11 lbs per sq ft of louver face area.

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	BURGER KING - 20/20 GARDEN GRILL EXTERIOR EXTERIOR MATERIALS & FINISH SCHEDULE (not all specs are used on every project)						
02/05/21	MATERIAL	LOCATION	MANUFACTURER		DESCRIPTION		ADDITIONAL INFORMATION
CODE	MATERIAL	LOCATION	MANUFACIUKEK	PRODUCT	COLOR	DIMENSION	
			EVOLUTION BRICK	MOD / QS TUMBLED (FULL BRICK)	OLDE HILLSBORO		CONTACT: GABE POWERS (502) 558-4612 NOTE: USE WITH EGR-3G
EB-1G	EXTERIOR BRICK	R BRICK GENERAL PINE HALL BRICK FACE BRICK			SIERRA TUMBLED OLD IRVINGTON O/S		CONTACT: THERESA BEANE (800) 334-8689 - tbeane@pinehallbrick.com NOTE: USE WITH EGR-3G
			H.C. MUDDOX BRICK	THIN BRICK	BK WEST COAST BLEND		CONTACT: ERIN LYNCH (916) 206-7831 NOTE: USE WITH EGR-3G
EB-1AG	, , , , , , , , , , , , , , , , , , ,				"SHALE BROWN" - STAGGERED JOINTS - UNPAINTED IF NO OTHER BRICK IS PRESENT.		CONTACT NICHIHA CUSTOMER SERVICE (770) 805-9466 BK@NICHIHA.COM
ALTERNATE FOR	EXTERIOR FINISH FIBER CEMENT BRICK PANELS	GENERAL	NICHIHA FIBER CEMENT	NICHIHA CANYON BRICK PANELS	(ON REMODELS, IF THERE IS ANY EXISTING BRICK ON THE	18" X 6'	INSTALL PER MANUFACTURER'S SPECIFICATIONS
EB-1G)					BUILDING, THE EXISTING BRICK AND THE NICHIHA BRICK MUST BE PAINTED TO MATCH EP-4G)		VERTICAL APPLICATIONS ONLY (NOT FOR USE ON SOFFITS)
ECT-1G	EXTERIOR CERAMIC TILE	ACCENT AT BUILDING FRONT	GRANITI GIANDRE / EUROWEST	SENSIBLE STONE ED5052	"RED NATURAL"	12" X 24"	CONTACT: JOY DETER AT EUROWEST (714) 309-9551 OR JOY KLEIN (813) 334-3302
			, , , , , , , , , , , , , , , , , , , ,		STACKED BOND PATTERN		jklein@transamerica.com NOTE: USE WITH EGR-4G
ECT-18G	EXTERIOR CERAMIC TILE	INLINE RESTAURANTS ONLY	GRANITI GIANDRE / EUROWEST	ROVERE ANTICO LEGNI HIGH TECH	PAR 15334 "ROVERE"	6" X 36"	CONTACT: JOY DETER AT EUROWEST (714) 309-9551 OR JOY KLEIN (813) 334-3302
EC1-16G	EXTERIOR CERAMIC TILE	INCINE RESTAURANTS ONET	GRANITI GIANDRE / LOROWEST		STACKED BOND PATTERN	0 7 30	jklein@transamerica.com NOTE: USE WITH EGR-9G
			STO OR APPROVED EQUAL	STO POWERWALL STUCCO SYSTEM TEXTURE: FINE SAND	COLOR TO MATCH EP-2G PPG "DESERT DUNE"		CONTACT: TIM SALERNO AT STO CORP (407) 466-5371
EF-1G	EXTERIOR FINISH - STUCCO, STO, FIBER	GENERAL		OR STO THERM CI EIFS SYSTEM			CONTACT NICHIHA CUSTOMER SERVICE (770) 805-9466
	CEMENT SIDING PANELS		NICHIHA FIBER CEMENT	NICHIHA TUFFBLOCK	PREPAINTED TO MATCH EP-2G - PPG "DESERT DUNE" STACKED BOND PATTERN	18" X 6'	BK@NICHIHA.COM INSTALL PER MANUFACTURER'S SPECIFICATIONS
	EXTERIOR FINISH				COLOR TO MATCH EP-4G		VERTICAL APPLICATIONS ONLY (NOT FOR USE ON SOFFITS) CONTACT: TIM SALERNO AT STO CORP (407) 466-5371
EF-4G EF-8G	STUCCO	GENERAL	STO OR APPROVED EQUAL	STO POWERWALL STUCCO SYSTEM	PPG "GRANITE"		CONTACT:800-255-1727
LTERNATE FOR EF-9G)	EXTERIOR FINISH STONE	EXTERIOR SIGN ARCHONS	BORAL STONE PRODUCTS	COUNTRY LEDGESTONE	"ASPEN"		Susan King Susan.King@boral.com culturedstone@boral.com
EF-9G	EXTERIOR FINISH						CONTACT NICHIHA CUSTOMER SERVICE (770) 805-9466 BK@NICHIHA.COM
	FIBER CEMENT						INSTALL PER MANUFACTURER'S SPECIFICATIONS. VERTICAL
			NICHIHA FIBER CEMENT	VINTAGE WOOD EF762	"CEDAR"	18" X 10'	SEAMS SHALL BE MINIMIZED. ALL SPANS OF 10' OR MORE SHALL HAVE VERTICAL SEAMS ALIGNED IN THE CENTER OF THE ARCHON.
TR-1G	ALUMINUM TRIMS	EXTERIOR SIGN ARCHONS					SEAMS TO BE CAULKED WITH EC-1G OR USE "H-MOLD" FACTORY TRIMS. ALL TRIMS SHALL BE FACTORY PAINTED
							TO MATCH PANELS. VERTICAL APPLICATIONS ONLY (NOT FOR USE ON SOFFITS)
EC-1G	EXTERIOR CAULK		ADSEAL PRODUCTS	ADSEAL 458-63	"VINTAGE WOOD CEDAR"		CONTACT: MATT KLINGE AT ADFAST (314) 753-0964 matt.klinge@adfastcorp.com
EP-2G	EXTERIOR PAINT	EXTERIOR GENERAL		PRIMER: 17-921	"DESERT DUNE" 1023-4, former "TANNERS TAUPE"		NOTE: USE WITH EF-9G CONTACT: KEVIN LASTACY @ PPG
				PAINT: 6-2045XI PRIMER: 17-921	PPG1023-4 "GRANITE" 1022-6 , former "MONTERREY CLIFFS"		Corporate National Accounts Manager (616) 335-3259
EP-4G 	EXTERIOR PAINT	EXTERIOR WAINSCOT LOGO SIGN CABINETS & BURGER		PAINT: 6-2045XI PRIMER: 6-212	10YY 14/080 "STEPPING STONE" 1010-4 , former "BURGER KING SILVER"		klastacy@ppg.com NOTE: FOR REMODELS ONLY
EP-6G	EXTERIOR PAINT	KING CHANNEL LETTER CABINETS		PAINT: 6-230	Custom Formula		NOT FOR USE ON ROOFS. SEE EP-6AG & EP-6BG
EP-6AG	EXTERIOR PAINT	EXISTING MANSARD ROOFS, SHINGLES & BARREL TILE	PPG	PRIMER: 17-921 PAINT: 90-1110	"DOVER GRAY" 1001-1, former "GRYMMYS GREY" 00NN 20/000		NOTE: BY EXCEPTION FOR REMODELS ONLY
EP-6BG	EXTERIOR PAINT	EXISTING STANDING SEAM METAL ROOF	, FFG	PRIMER: 90-1110 PRIMER: 90-712 PAINT: 90-1110	"GRAY STONE" 1009-4 , former "MARCH WIND" Custom Formula		NOTE: BY EXCEPTION FOR REMODELS ONLY
EP-8BG	EXTERIOR PAINT	METAL COPING AT ARCHON TOWERS		PRIMER: 17-921 PAINT: 6-2045XI	"CARAVEL BROWN" 1079-6 , former "CEDAR"		
EXT-1G	EXTERIOR PAINT	POLES & POLE SIGN		PRIMER: 90-712	Custom Formula "BLACK"		
EXT-2G	EXTERIOR PAINT	SIGNS		PAINT: 90-353 PRIMER: 90-712	Tint to match		
				PAINT: 90-375 PRIMER:	PPG 1006-6 "DECONSTRUCTION" "TAUPE TONE"		Contact: GLENN REMLER, ARCHITECTURAL ACCOUNT EXECUTIVE
EP-2G	EXTERIOR PAINT	EXTERIOR GENERAL		Loxon Concrete & Masonry A24W300 PAINT:	SW 7633		phone: (954) 547-1217
				Superpaint Ext Satin A89 Series Satin			email: Glenn.J.Remler@Sherwin.com
				PRIMER: Loxon Concrete & Masonry A24W300	"HOMESTEAD BROWN" SW 7515		
EP-4G	EXTERIOR PAINT	EXTERIOR WAINSCOT		PAINT: Superpaint Ext Satin A89 Series			
				Satin PRIMER:	FACTORY FINISH SILVER		NOTE: FOR REMODELS ONLY
EP-6G	EXTERIOR PAINT	LOGO SIGN CABINETS & BURGER KING CHANNEL LETTER		Kem Bond HS B50A28 PAINT:			NOT FOR USE ON ROOFS.
	,	CABINETS		Silver Brite B59S11 PRIMER:	"WESTCHESTER GRAY"		NOTE: BY EXCEPTION FOR REMODELS ONLY
EP-6AG	EXTERIOR PAINT	EXISTING MANSARD ROOFS,		Pro Industrial Pro-Cryl Primer B66-310 PAINT:	SW 2849		
2. 5/10		SHINGLES & BARREL TILE		Pro Industrial High Performance Acrylic B66-660 Eggshell			
			SHERWIN-WILLIAMS	PRIMER: Pro Industrial Pro-Cryl Primer B66-310	"MARCH WIND" Custom Formula	 	NOTE: BY EXCEPTION FOR REMODELS ONLY
EP-6BG	EXTERIOR PAINT	EXISTING STANDING SEAM METAL ROOF		PAINT: Pro Industrial High Performance Acrylic B66-660	Custom Formula		
				Eggshell PRIMER:	"CEDAR"		
ED 90	EVTEDIOD DATE:	METAL COPING AT ARCHON		Pro Industrial Pro-Cryl Primer B66-310	"CEDAR" Custom Formula		
EP-8G	EXTERIOR PAINT	TOWERS		PAINT: Pro Industrial High Performance Acrylic B66-650			
				Semi-Gloss PRIMER:	FACTORY FINISH BLACK		
EXT-1G	EXTERIOR PAINT	POLES & POLE SIGN		Pro Industrial Pro-Cryl Primer B66-310 PAINT:			
				Pro Industrial High Performance Acrylic B66-600 Gloss			
				PRIMER: Pro Industrial Pro-Cryl Primer B66-310	FACTORY FINISH TO MATCH SW 6075 "GARRET GRAY"		
EXT-2G	EXTERIOR PAINT	SIGNS		PAINT: Pro Industrial High Performance Acrylic B66-600			
EOD 30	CROLET	PDTO!/	MADET	Gloss	#E KOLLANOTOP		NOTE: USE WITH EB-1G
EGR-3G	GROUT	BRICK	MAPEI		#5 "CHAMOIS"		NOTE: USE WITH ECT-1G
EGR-4G	GROUT	CERAMIC TILE	CUSTOM BUILDING PRODUCTS	POLYBLEND SANDED	#335 "WINTER GRAY"		*** FOR SETTING MATERIALS USE COMPLETE CONTACT RAPID SET *** SEAL GROUT WITH AQUAMIX SEALERS CHOICE GOLD
							NOTE: USE WITH ECT-18G
		INLINE RESTAURANTS ONLY					*** CONTRACTOR TO ALLOW 1/16" MAX FOR GROUT JOINT *** FOR SETTING MATERIALS USE COMPLETE CONTACT RAPID SET
EGR-9G	GROUT	CERAMIC TILE	LATICRETE	POLYBLEND SANDED	#66 "CHESTNUT BROWN"		*** SEAL GROUT WITH AQUAMIX SEALERS CHOICE GOLD
							CONTACT: W.B. HICKMAN COMPANY (838)676-1700 - WWW W.BH. COM
MC-1G	METAL COPING	TOP OF LIGHT BAND WALL CAP		PERMA SNAP PLUS	A-30 "SILVERSMITH"		CONTACT: W.P. HICKMAN COMPANY (828)676-1700 - WWW.WPH.COM
		,			FACTORY FINISH TO MATCH EP-2G		
MC-2G	METAL COPING	BELOW LIGHT BAND	W.P. HICKMAN SYSTEMS, INC.	PERMA SNAP PLUS	PPG "TANNERS TAUPE"		
MC-3G	METAL COPING	TOP OF ARCHON		PERMA SNAP PLUS	TO BE PAINTED TO MATCH EP-8G PPG "CEDAR"		
							PRODUCT INFORMATION: KEVIN RUBOTTOM AT LEKTRON
MP-1G		PARAPET LIGHT BAND	LEKTRON *SEE APPROVED SIGN SUPPLIERS	LED LIGHT BAND		*SEE PLANS	(800) 634-4059 OR (918) 622-4978 Email: KRubottom@lektroninc.com
MP-3G	METAL CANOPY	ABOVE DOORS AND WINDOWS	*SEE APPROVED CANOPY SUPPLIERS	CUSTOM METAL CANOPY	COLOR: CLEAR ANODIZED	*SEE PLANS	

DateByNotes02.17.2022ASSTATE BUILDING AND ENGINEERING REVIEW06.29.2022AGTECHNICAL REVIEW COMMENTS07.25.2022JBTECHNICAL REVIEW MEETING REVISIONS08.25.2022JBTECHNICAL REVIEW MEETING REVISIONS09.06.2022JBINDOT SUBMITTALOF THESE DRAWINGS OR SPECIFICATIONS MAYBEIN CONNECTION WITH ANY WORK,OTHER THEN THE SPECIFIC

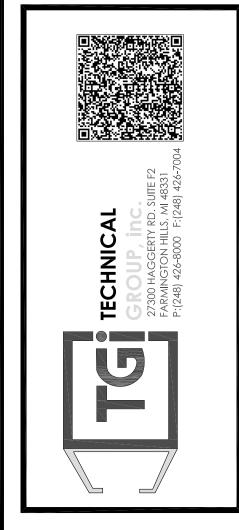
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Date: 08.02.21

BURGER KING King Corporation






PROJECT
BURGER KING
1440 NAPPANEE ST,
ELKHART, IN 46514
STEET TITLE
EXTERIOR FINISH SCHEDULE

TG-21668

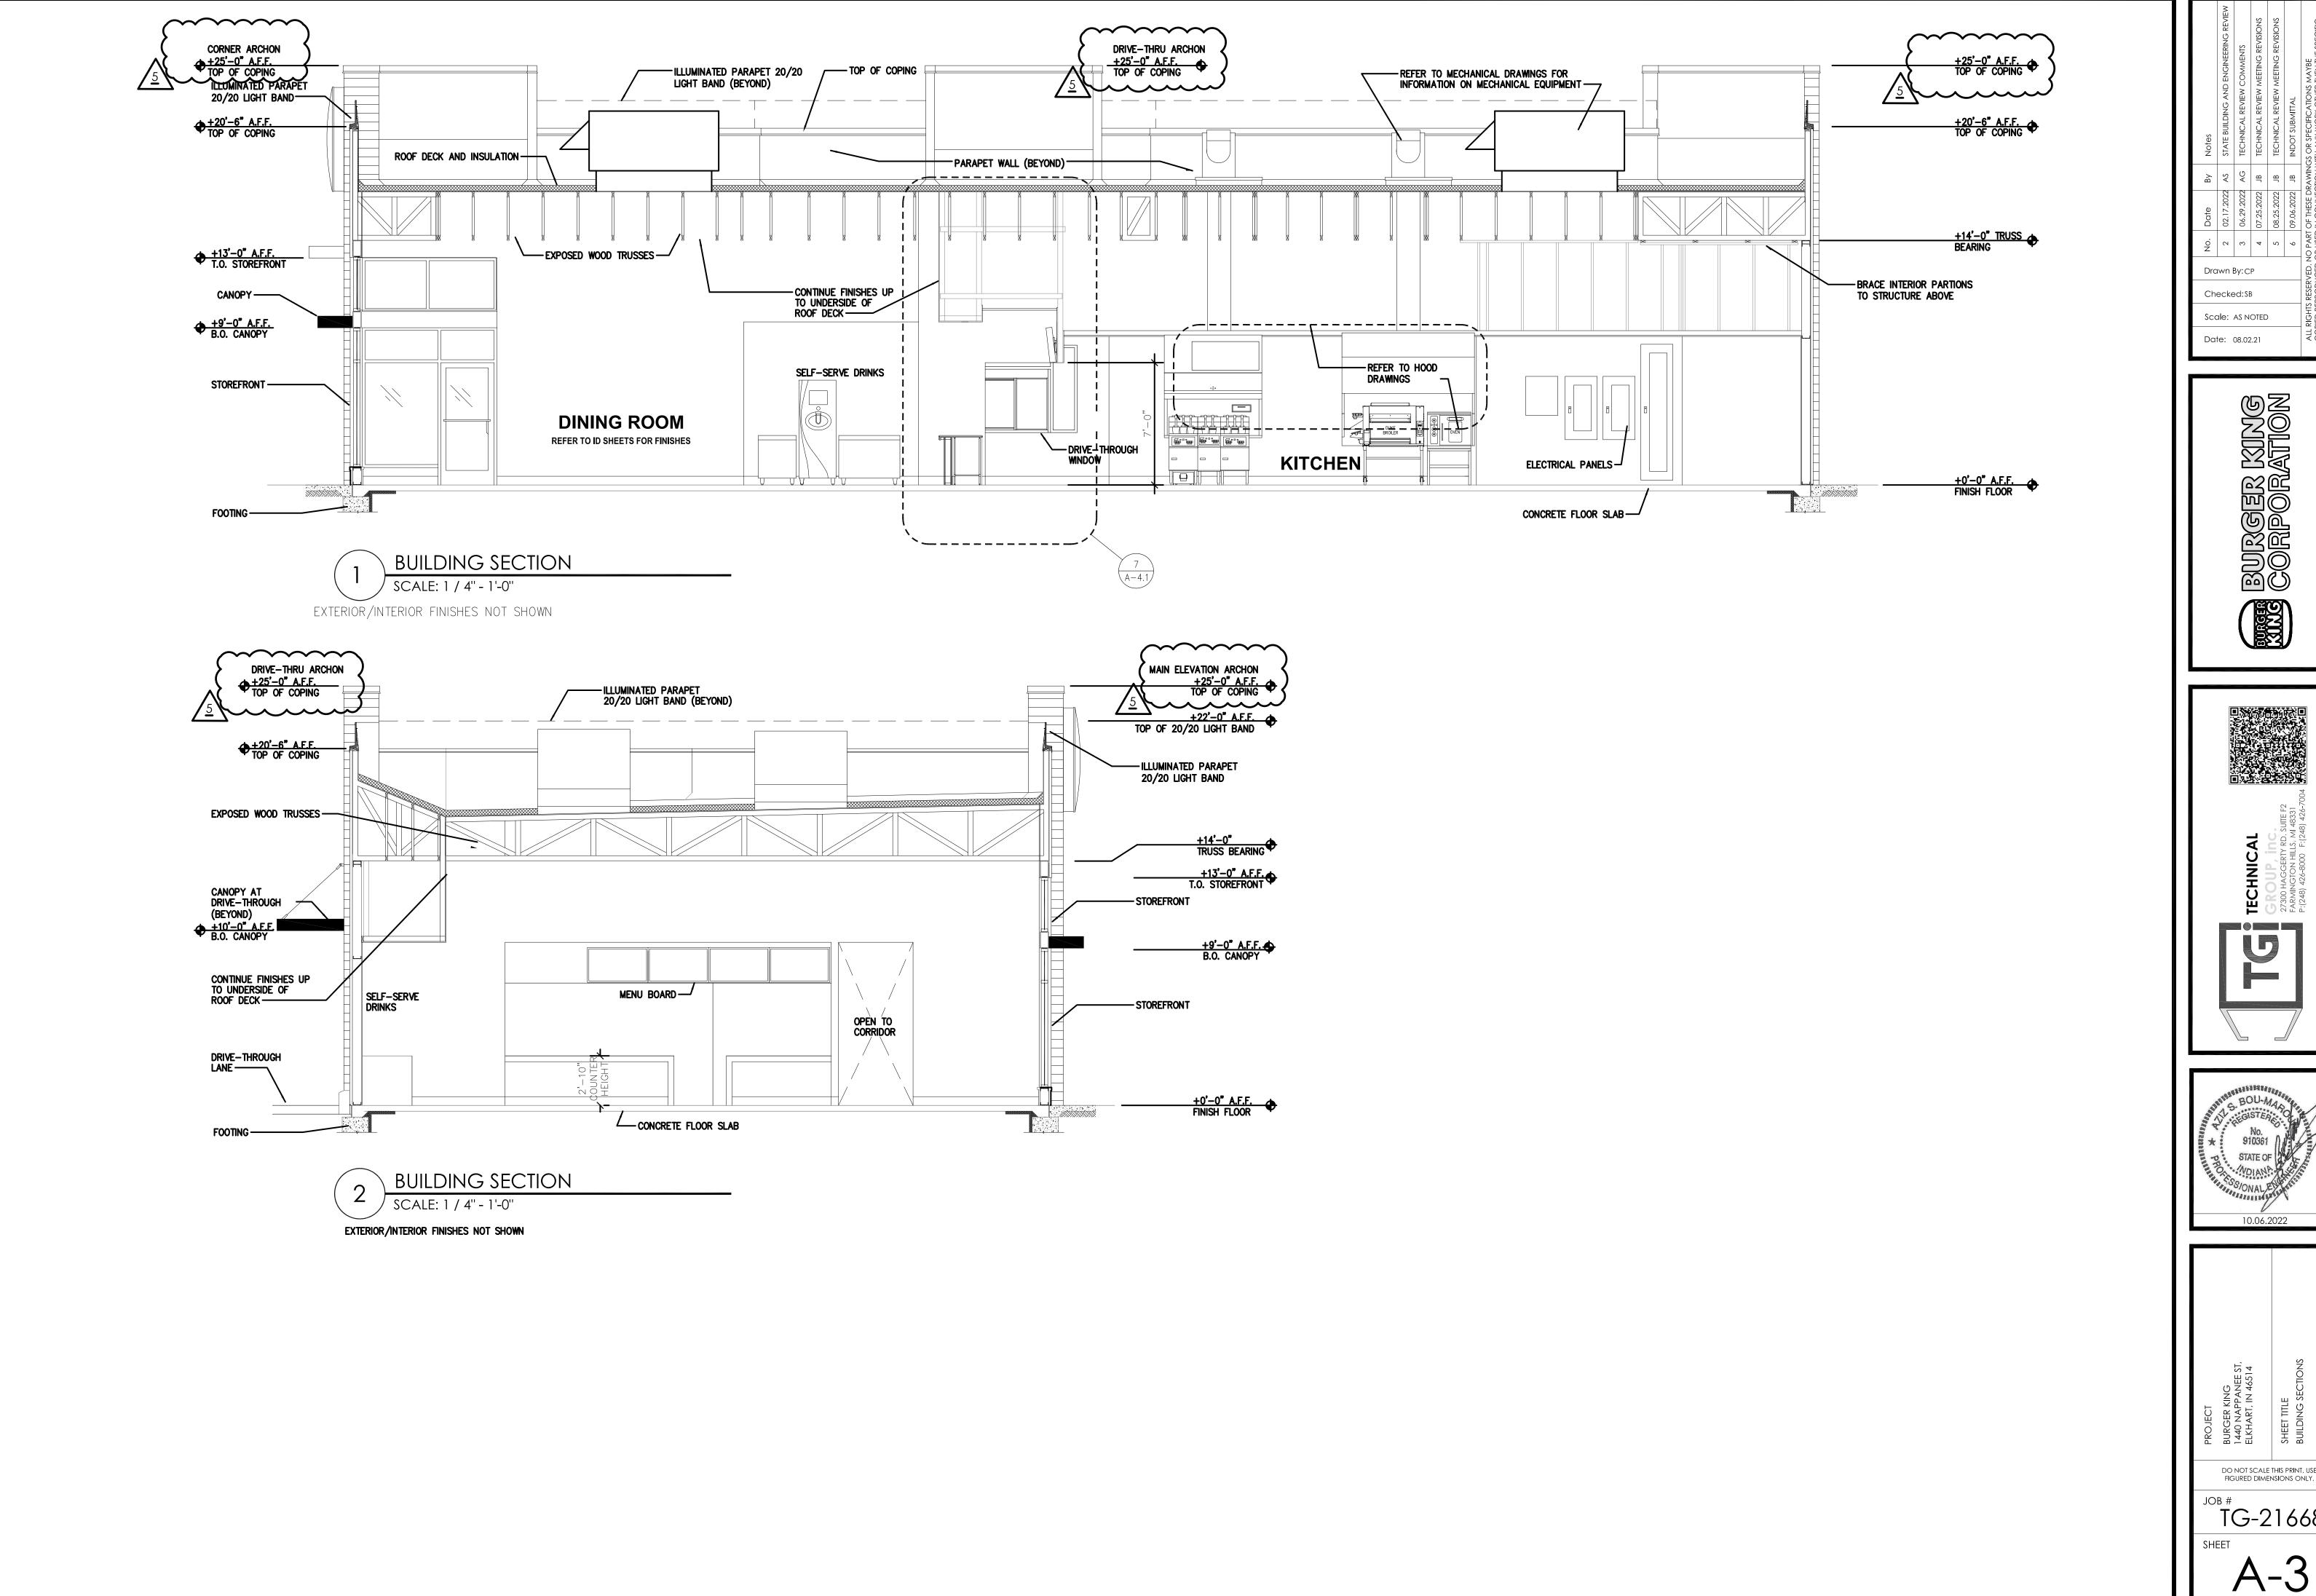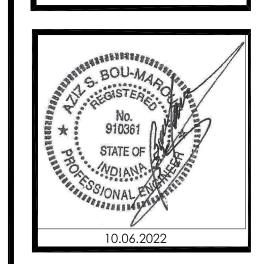
A-2.2



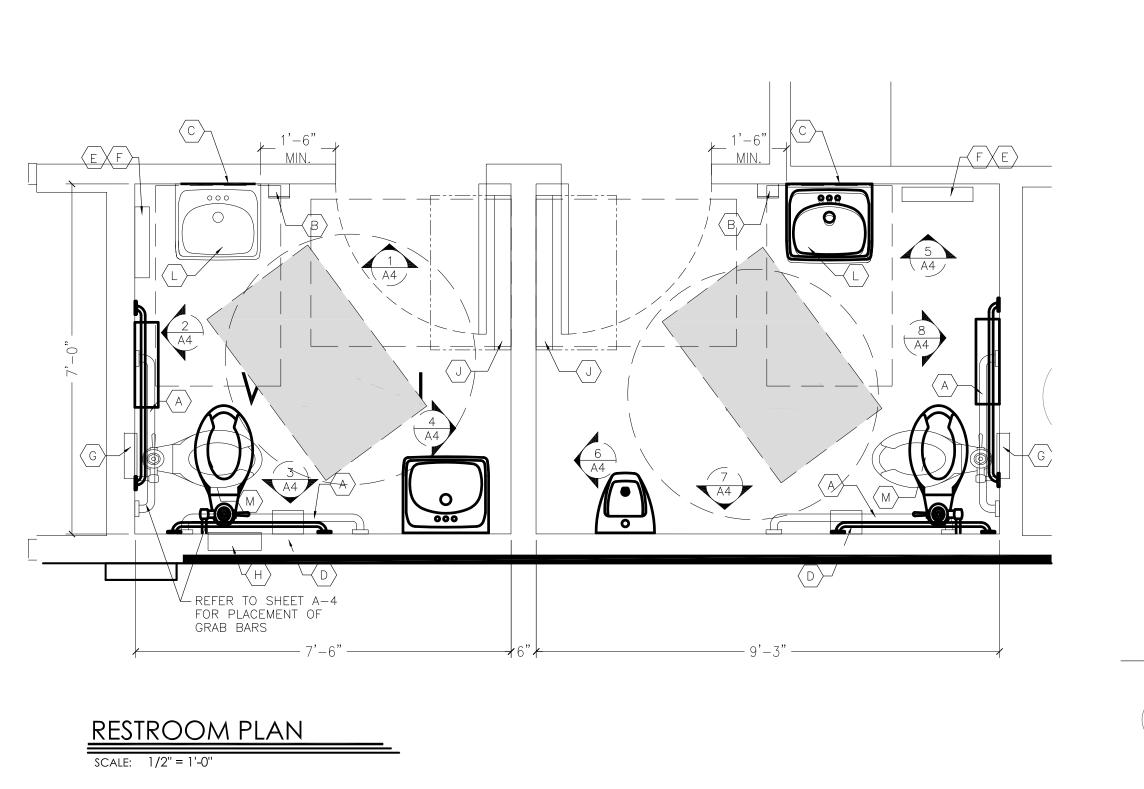
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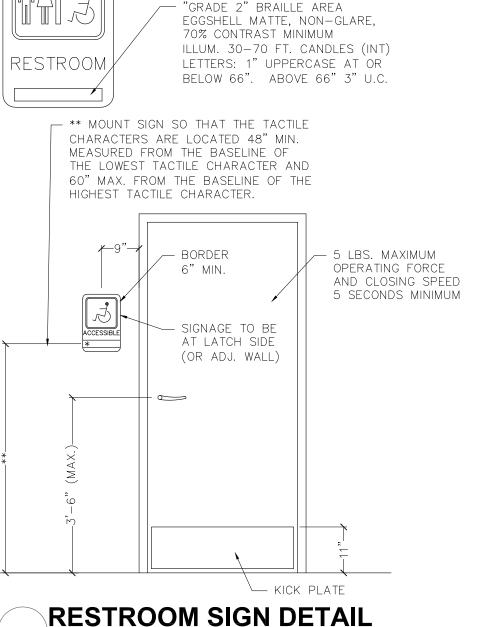







PROJECT	BURGER KING 1440 NAPPANEE ST, ELKHART, IN 46514	SHEET TITLE BUILDING SECTIONS			
		LE THIS PRINT. USE MENSIONS ONLY.			
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SHE	EET	3			






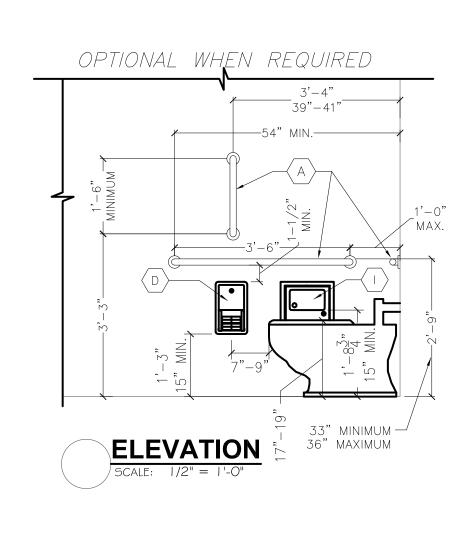

REFER TO 20/20 GARDEN GRILL DECOR GUIDELINES FOUND AT DESIGNWITHBK.COM (INTERIOR DESIGN GUIDELINES) FOR REQUIRED RESTROOM GRAPHICS.

ELEVATION

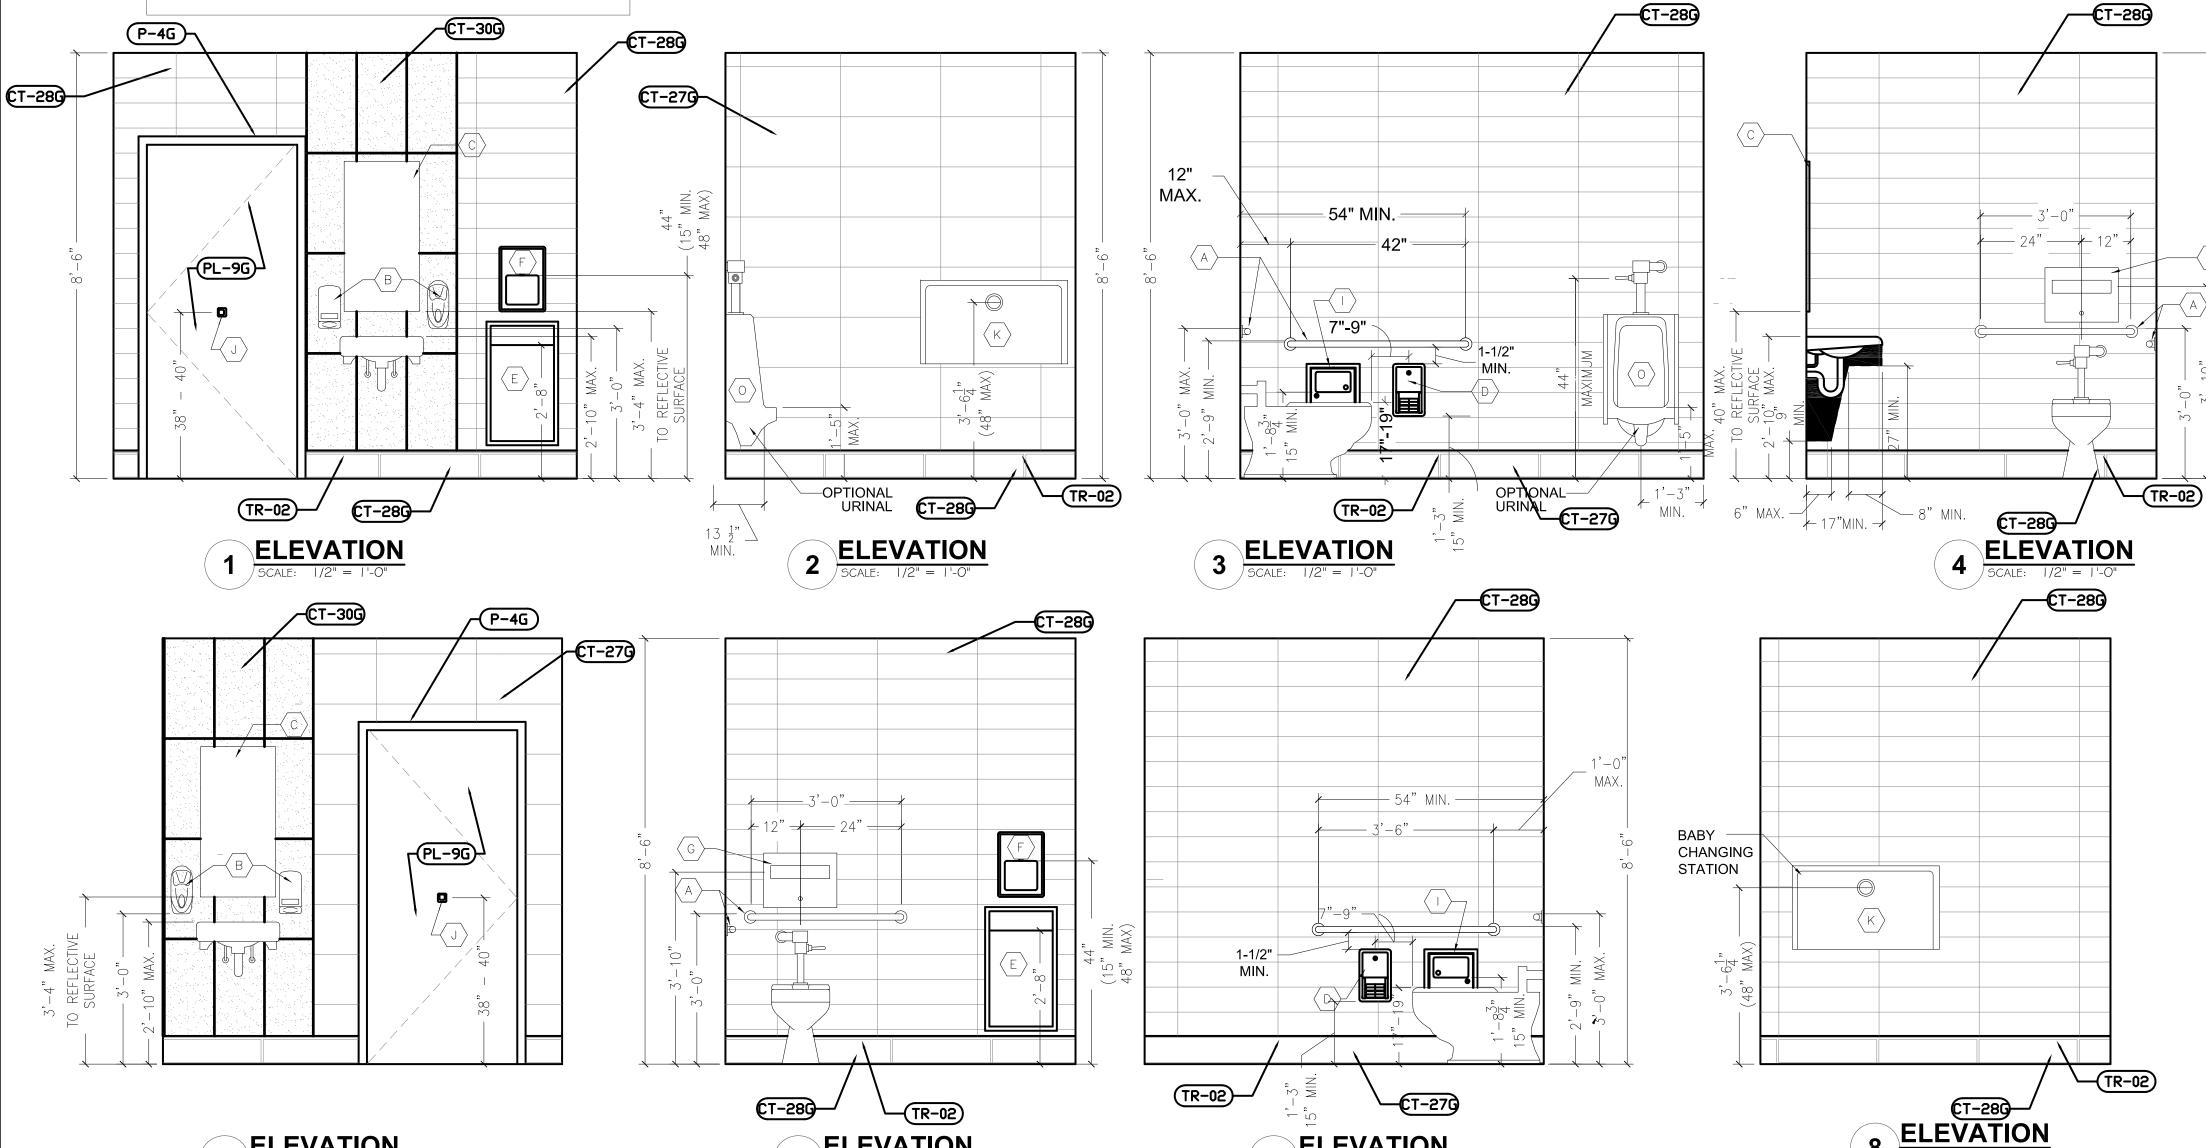SCALE: 1/2" = 1'-0"



ELEVATION

ELEVATION

GENERAL NOTES:

LAVATORIES.

FOR INTERIOR FINISHES, REFER TO INTERIOR DECOR SHEETS.

PLUMBING FIXTURES TO BE PROVIDED BY THE GENERAL CONTRACTOR ALL PLUMBING FIXTURES, FAUCETS AND ACCESSORIES TO BE ADA COMPLIANT ALL EXPOSED PIPING UNDER LAVATORIES TO BE INSULATED TO PROTECT FROM CONTACT. THERE SHALL BE NO SHARP OR ABRASIVE SURFACES UNDER

RESTROOM / KITCHEN ACCESSORIES:

- 〈 A 〉 GRAB BAR: BOBRICK 250 LBF. MINIMUM 33" MIN. TO 36" MAX. HEIGHT TO THE TOP OF THE GRIPPING SURFACE. PROVIDE THE REQUIRED QUANTITY AND LENGTH AS INDICATED ON THE DRAWINGS OR AS REQUIRED BY THE GOVERNING CODE. THE BAR SHALL BE 1-1/2" IN DIAMETER AND MOUNTED WITH 1-1/2" CLEARANCE FROM THE WALL.
- (B) WALL MOUNTED SOAP DISPENSER AND HAND SANITIZER DISPENSER (36" MAX. HEIGHT) SUPPLIED BY "ECOLAB" AND INSTALLED BY THE G.C. NOTE: SOAP AND HAND SANITIZER DISPENSERS TO BE PROVIDED AT EACH KITCHEN HANDSINK.
- (C) MIRROR: (BOTTOM OF REFLECTIVE SURFACE AT 40" MAXIMUM HEIGHT) MODEL B-165-1836 (18"x36") STAINLESS STEEL CHANNEL FRAME MIRROR WITH THEFT RESISTANT SCREWS BY BOBRICK OR APPROVED EQUIVALENT.
- ⟨D⟩ TOILET PAPER HOLDER: OPTION 1: BOBRICK B-3888, SUPPLIER - HAINES JONES & CADBURY OPTION 2: 9" TWIN JUMBO MODEL #58250 BY NORTH AMERICAN CORPORATION.
- (E) PAPER WASTE RECEPTACLE: (REQUIRED) MODEL B-3644 AS MANUFACTURED BY BOBRICK OR APPROVED EQUIVALENT. (ROUGH OPENING 17-3/16"W x 30-5/8"H x 8-1/8"D MIN.)
- F ELECTRIC HAND DRYER: ASI ROVAL SERIES AUTOMATIC TOUCH-FREE SENSOR HAND DRYER.MODEL: ASI ROVAL 20199 NOTE: HAND DRYER TO BE INSTALLED AT A MAXIMUM HEIGHT OF 48" FROM FINISH FLOOR ELEVATION TO TOP OF SENSOR OR PER ADA REQUIREMENTS. NOTE: PROVIDE PAPER TOWEL DISPENSER "SAN JAMAR" MODEL #T-1490BK AT EACH HAND SINK IN KITCHEN.
- TOILET SEAT COVER DISPENSER: BOBRICK B-3013, SUPPLIER - HAINES JONES & CADBURY
- H URINAL SCREEN: (OPTION 1) NEVAMAR WK0017T COLOR: VENERABLE OLD OAK (OPTION 2) BOBRICK 1080/1180 DURALINE SERIES #EO-09 COLOR: BLACK
- SANITARY NAPKIN DISPOSAL: BOBRICK B-353, RECESSED.
- COAT HOOK: BOBRICK MODEL B-6717 TO BE MOUNTED ON INSIDE OF EACH ackslash RESTROOM DOOR FOR SINGLE OCCUPANCE RESTROOMS AND EACH RESTROOM STALL DOOR FOR MULTIPLE OCCUPANCY RESTROOMS. MOUNT AT 38"-40" A.F.F. FOR ADA ACCESSIBLE LOCATIONS AND AT 48" A.F.F. MAXIMUM FOR NON-ADA ACCESSIBLE LOCATIONS.
- BABY CHANGING STATION: KOALA KARE #KB110-SSWM (HORIZONTAL) WALL $^{
 m >}$ MOUNTED OR #KB200-01 (HORIZONTAL) WALL MOUNTED IN GREY. SANITARY BED LINERS FOR BABY CHANGING STATION: KOALA KARE #KB150-99 CHANGING STATION OPTION TO COMPLY WITH ALL ACCESSIBILITY REQUIREMENTS. PROVIDE BLOCKING AS REQUIRED FOR STATION SUPPORT.
- LAVATORY FAUCET: WATERFRONT MODEL: 300988 SINGLE LEVER HANDLE LAVATORY FAUCET, CHROME-PLATED FINISH
- WATER CLOSET:

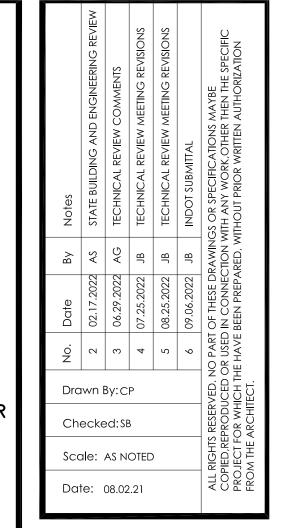
 AMERICAN STANDARD MADERA FLOWISE 15" HEIGHT ELONGATED FLUSHOMETER TOILET, SUPPLIER - HAINES JONES & CADBURY
- WATER CLOSET- ADA:

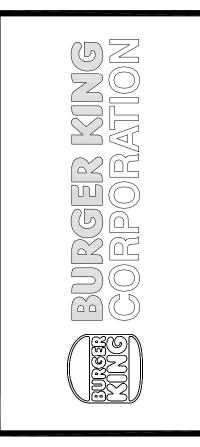
 AMERICAN STANDARD MADERA FLOWISE 16 1/2" HEIGHT 1.6 GPF FLUSHOMETER TOILET SYSTEM, SUPPLIER - HAINES JONES & CADBURY
- ⁾ AMERICAN STANDARD WASHBROOK FLOWISE UNIVERSAL URINAL HAINES JONES &
- P LAVATORY: CUSTOM THROUGH SINK "GLACIER WHITE" COMMERCIAL INTERIORS MANUFACTURING (CIM) OR HAINES JONES & CADBURY

OPTIONAL:

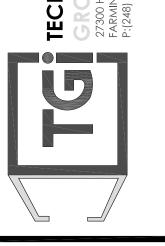
TOILET STALL PARTITIONS: NEVAMAR WK0017T COLOR: VENERABLE OLD OAK

(OPTIONAL) BOBRICK 1080/1180 DURALINE SERIES #EO-09 COLOR: BLACK OR PHENOLIC URINAL SCREEN AND TOILET PARTITIONS MAY BE USED AS AN ALTERNATE TO NEVAMAR SPECIFICATION.

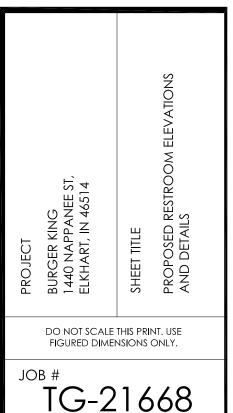


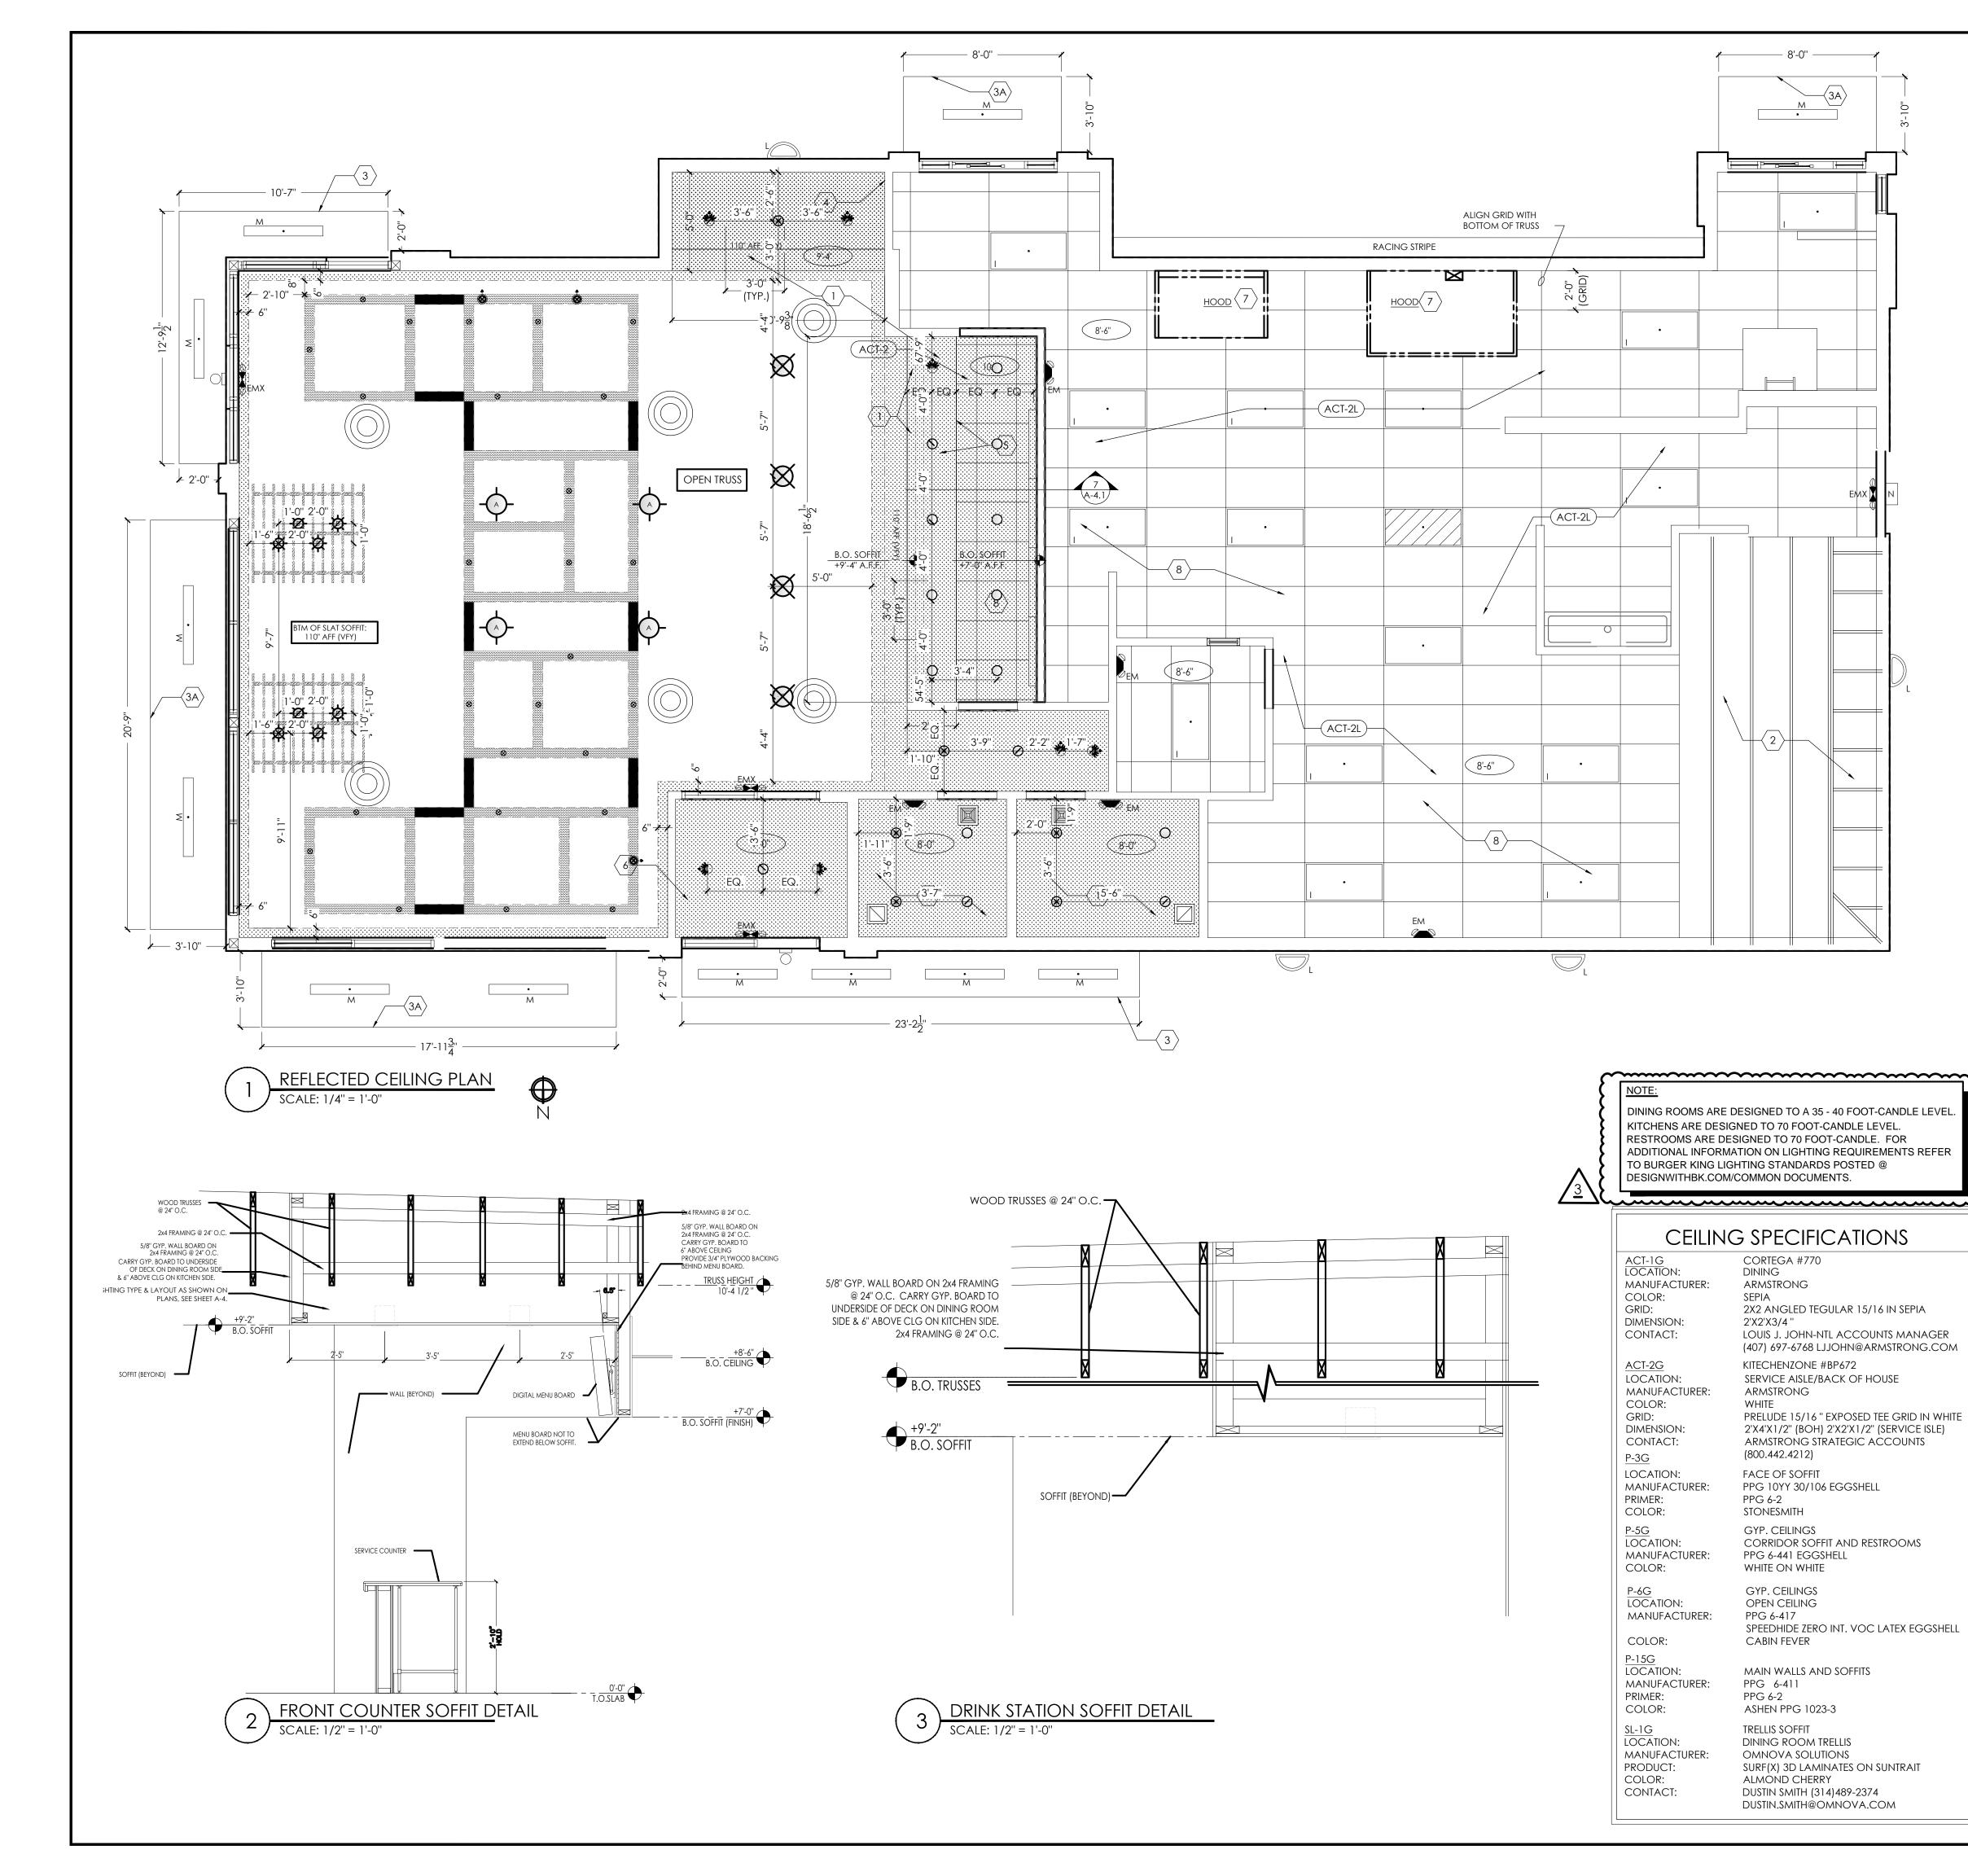












GENERAL NOTES:

DRAWINGS.

- A. ALL DIMENSIONS SHOWN ON REFLECTED CEILING PLAN ARE FROM FACE OF WALL FINISH UNLESS NOTED
- OTHERWISE.

 B. THE REFERENCE HEIGHTS INDICATED ON PLAN ARE
- FROM FINISH FLOOR (F.F.)

 C. GENERAL CONTRACTOR TO COORDINATE DINING ROOM LIGHTING WITH APPROVED INTERIOR DECOR
- D. CONTRACTOR SHALL VERIFY FIXTURE QUANTITIES AND ALSO MAKE PROPER ADJUSTMENTS FOR ANY CHANGES IN PLAN DUE TO ADDITIONAL REQUIREMENTS, LOCAL
- E. FOR H.V.A.C. PLAN, SECTIONS, DUCT LOCATIONS, SUPPLY AND RETURN GRILLE SIZES AND ADDITIONAL
- INFORMATION, REFERENCE SHEET M-1.

 F. ALL FIXTURES SHALL BE LOCATED IN THE CENTER OF
- CEILING TILES UNLESS NOTED OTHERWISE.
- G. REFERENCE SHEET E-1 FOR LIGHTING LAYOUT REQUIREMENTS AND ADDITIONAL INFORMATION.
- H. REFERENCE INTERIOR DECOR SHEETS FOR FINISH SPECIFICATIONS.
- I. CONTRACTOR TO COORDINATE PENDANT LIGHT LOCATIONS WITH DECOR SUPPLIER DRAWINGS.

KEYED NOTES:

GYPSUM BOARD CEILING/SOFFIT
EXPOSED TRUSSES ABOVE WALK-IN BOX, REFER TO

W.I.B. DRAWINGS FOR INTERIOR LIGHT FIXTURES

PREFABRICATED METAL CANOPY

STAINLESS STEEL SERVICE CHASE

MENU BOARD AND HEADER. REFERENCE DTL 7/A-4.1

SOFFIT ABOVE ENTRY.
-CEILING PAINT TO MATCH INTERIOR CEILING IF VESTIBULE

IS ENCLOSED.
-CEILING PAINT TO BE EP-2G IF VESTIBULE IS OPEN.

(REFER TO EXTERIOR FINISH SCHEDULE)

MECHANICAL EXHAUST HOOD ABOVE

SUSPENDED ACCOUSTICAL TILE CEILING.

REFER TO FINISH SCHEDULE.

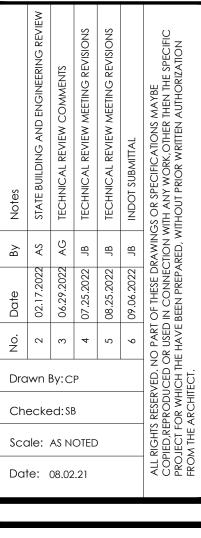
EXPOSED WOOD TRUSSES TO BE PAINTED.

REFER TO ID SHEETS FOR COLOR.

REFER TO ID SHEETS FOR COLOR.

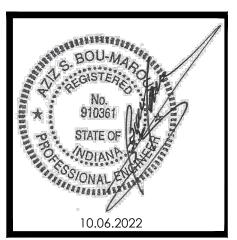
EXPOSED PLYWOOD ROOF DECK SHEATHING

SYMBOLS LEGEND SYMBOL DESCRIPTION SUPPLY AIR DIFFUSERS RETURN AIR GRILLES EXHAUST FAN GRILLES SINGLE PENDANT. COORDINATE LOCATION AND **(o)** QUANTITY WITH DECOR SUPPLIER. SINGLE PENDANT. COORDINATE LOCATION AND \bigoplus QUANTITY WITH DECOR SUPPLIER. C6w © 6" DIAMETER RECESSED DOWNLIGHT D6w 🕩 6" DIAMETER ADJUSTABLE WALL WASH DOWNLIGHT ADJUSTABLE TRACK LIGHT PROFILE LIGHT 2" DIAMETER DOWNLIGHT G G1 2" DIAMETER WALL WASH DOWNLIGHT 2x4 RECESSED FLAT LENS (NIGHT LIGHT WHEN SHOWN HATCHED) 12x12 RECESSED SOFFIT LIGHT SURFACE MOUNTED EXTERIOR WALL SCONCE (ALSO USED IN OPEN CANOPIES) WET LISTED 4'-0" CANOPY LIGHT (USED UNDER AWNINGS AND CLOSED CANOPIES) WALL MOUNTED SECURITY LIGHT EMERGENCY LIGHT EMX EXIT LIGHT










PROJECT
BURGER KING
1440 NAPPANEE ST,
ELKHART, IN 46514

AC

SHEET TITLE

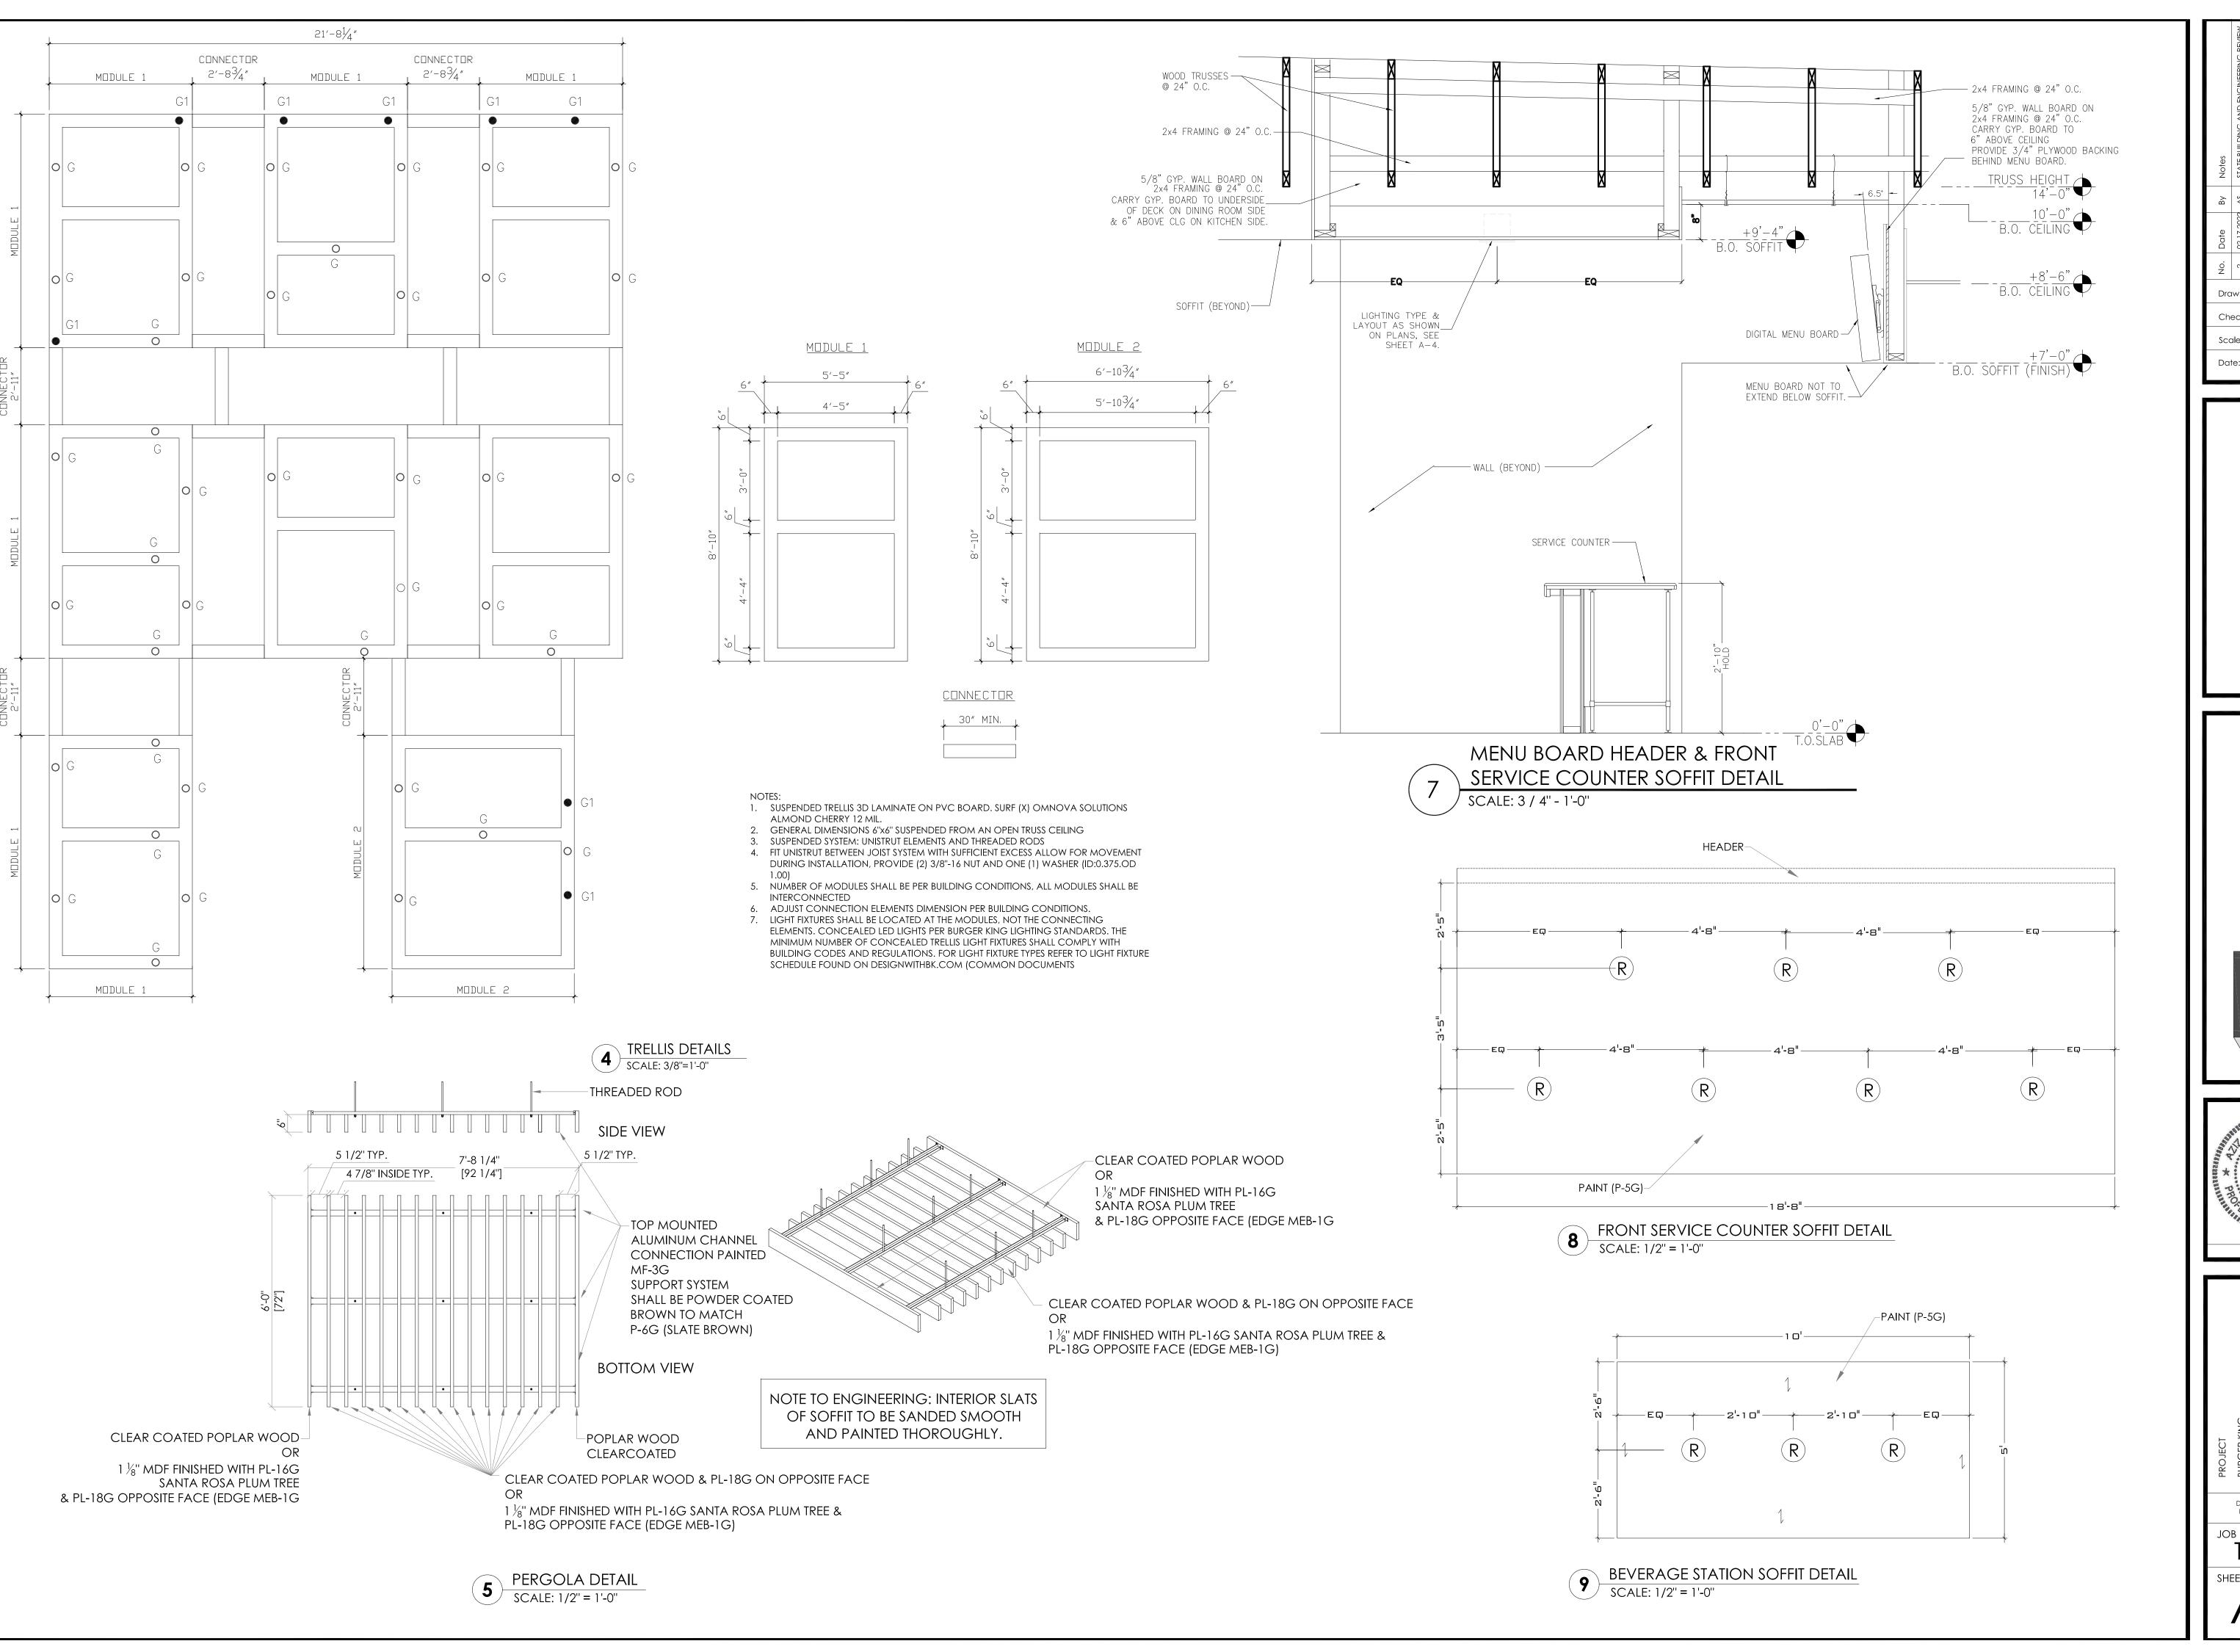REFLECTED CEILING PLAN



Date
By Notes

No. Date
By Notes

No. Date
By Notes

No. Date
By Notes

STATE BUILDING AND ENGINEERING REVIEW

STATE BUILDING AND ENGINEERING REVIEW

ON. 29.2022
AG TECHNICAL REVIEW MEETING REVISIONS

TECHNICAL REVIEW MEETING REVISIONS

S 08.25.2022
B TECHNICAL REVIEW MEETING REVISIONS

S 08.25.2022
B TECHNICAL REVIEW MEETING REVISIONS

B 09.06.2022
B INDOT SUBMITTAL

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BURGER KING ANG CORPORATION




TECHNICAL


GROUP, Inc.
27300 HAGGERTY RD. SUITE F2
FARMINGTON HILLS, MI 48331
P:(248) 426-8000 F:(248) 426-7004





SHEET TITLE REFLECTED CEILING DETAILS						
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Date By Notes

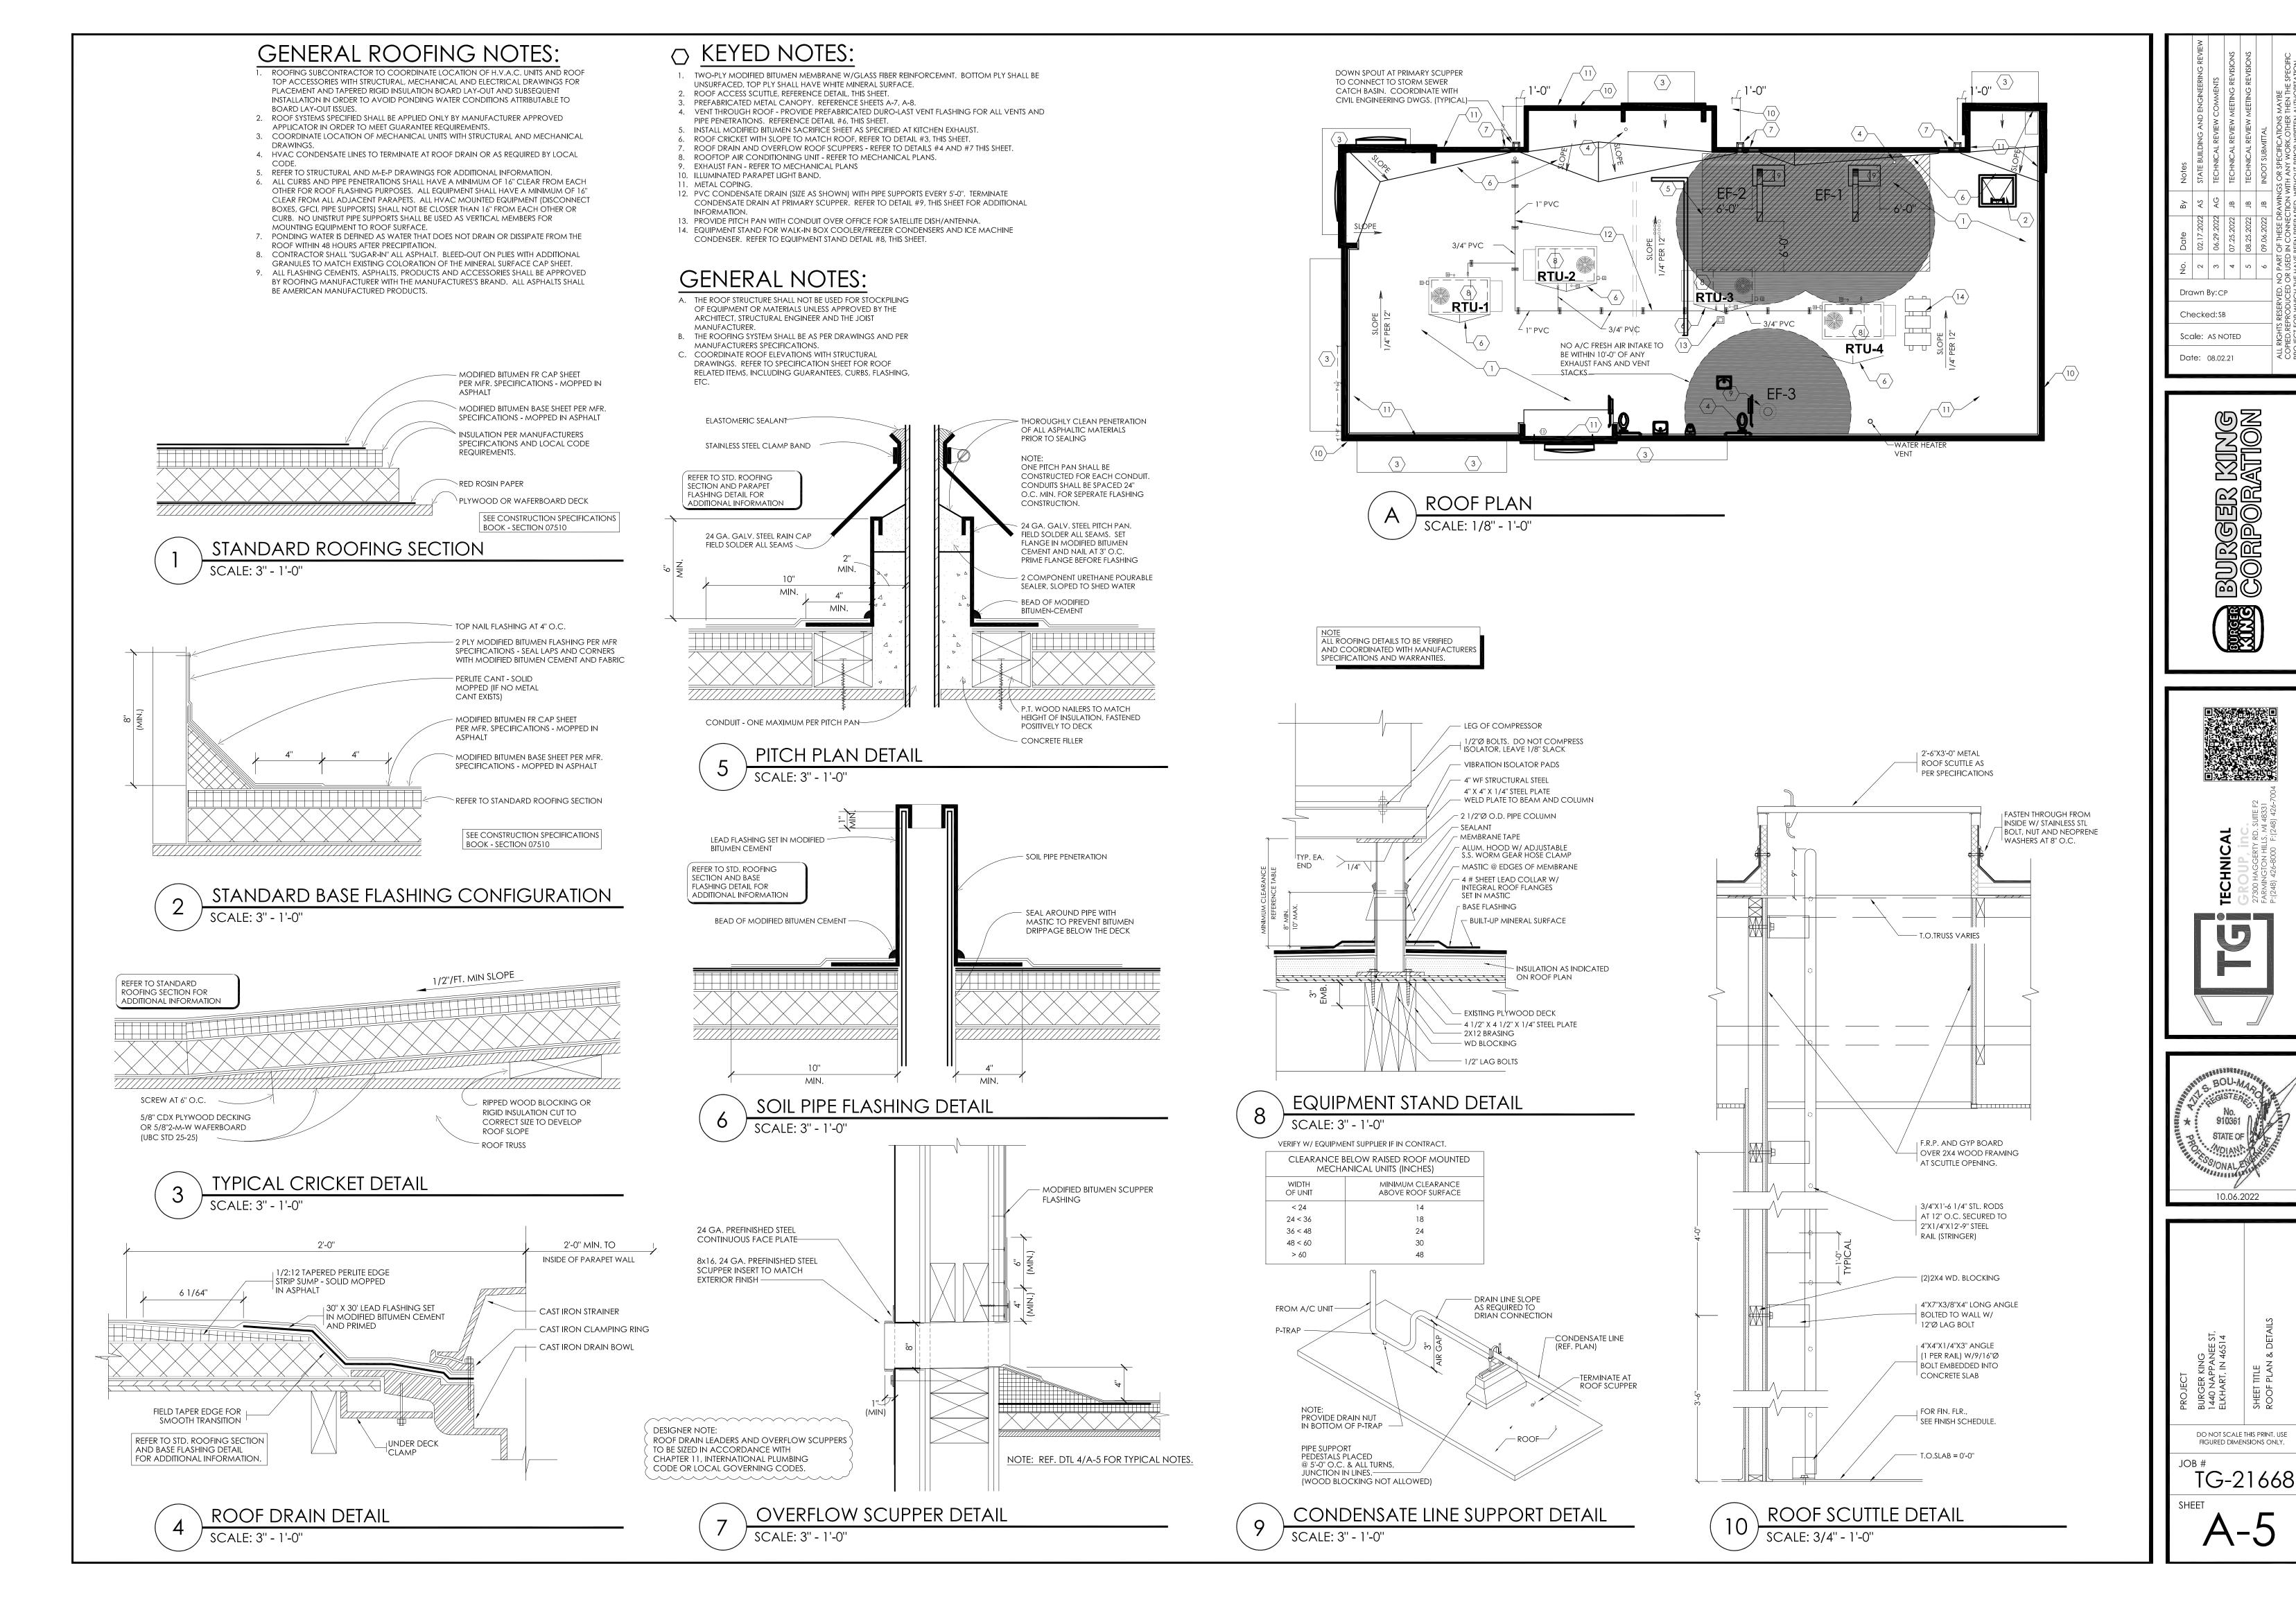No. Date By Notes

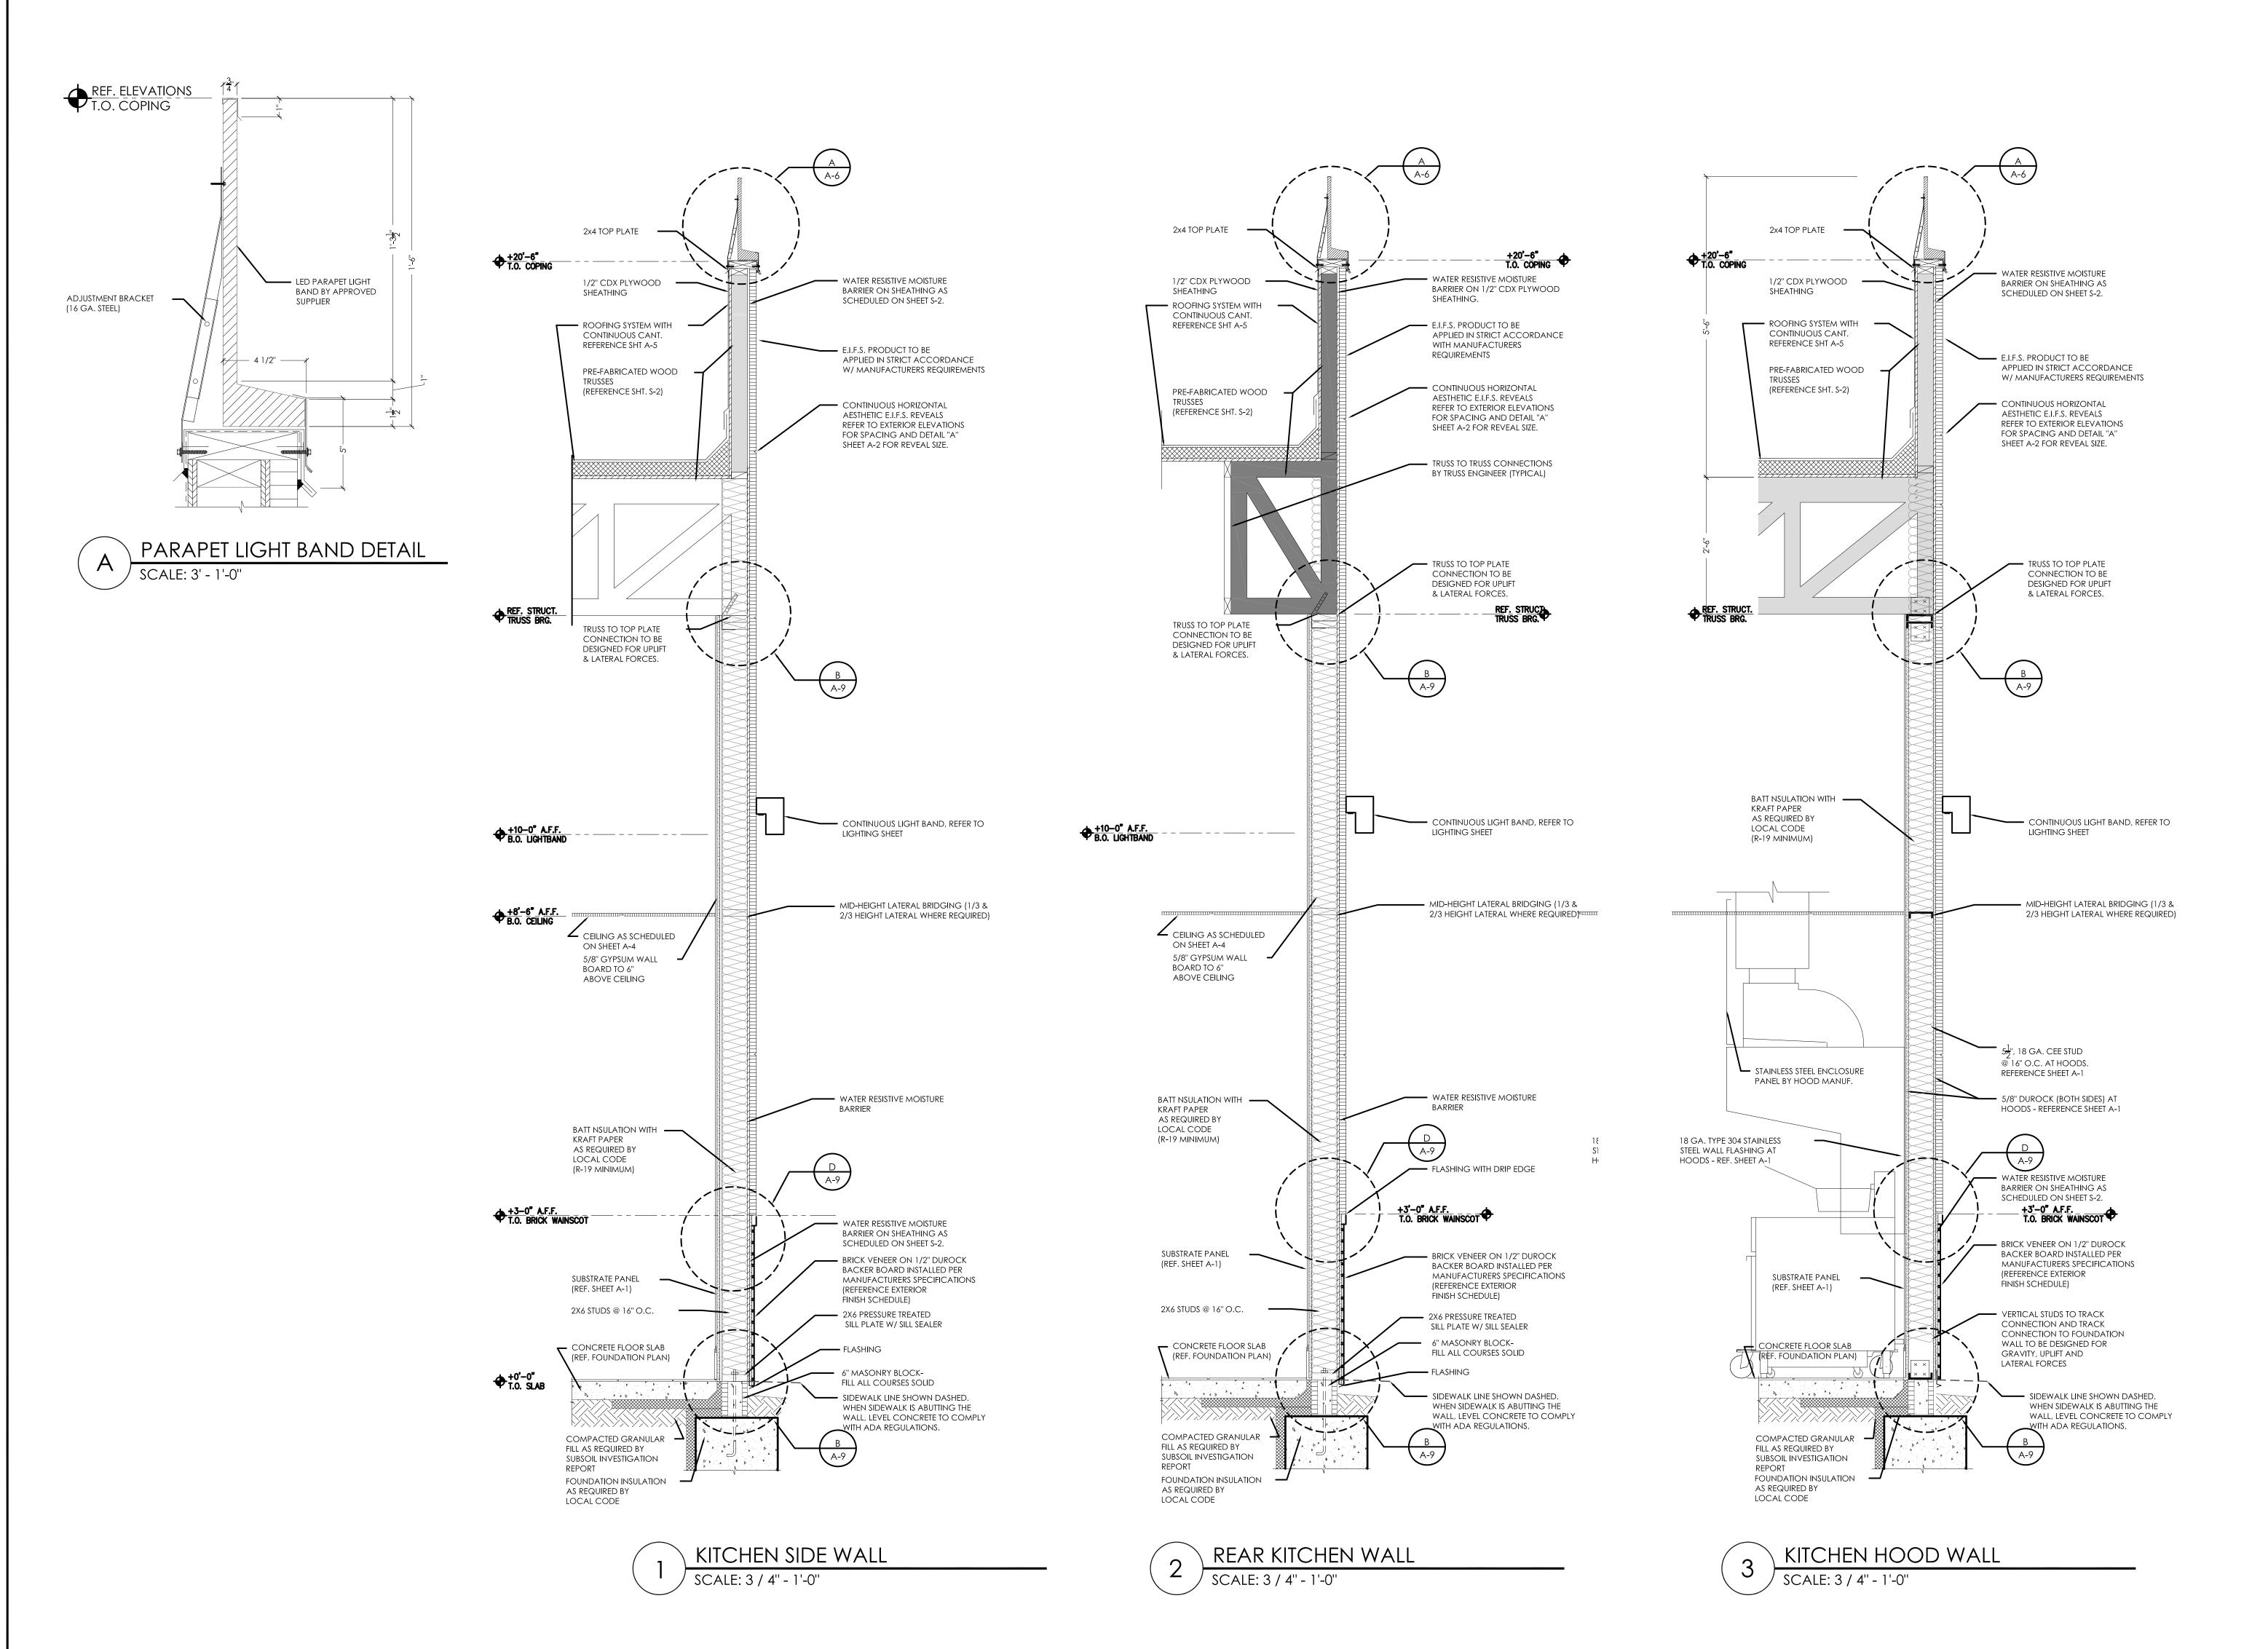State Building And Engineering Review

State Building And Engineering Review

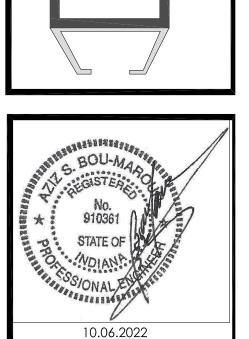
State Building And Engineering Revisions

State Building And Engineering And Engineering Revisions

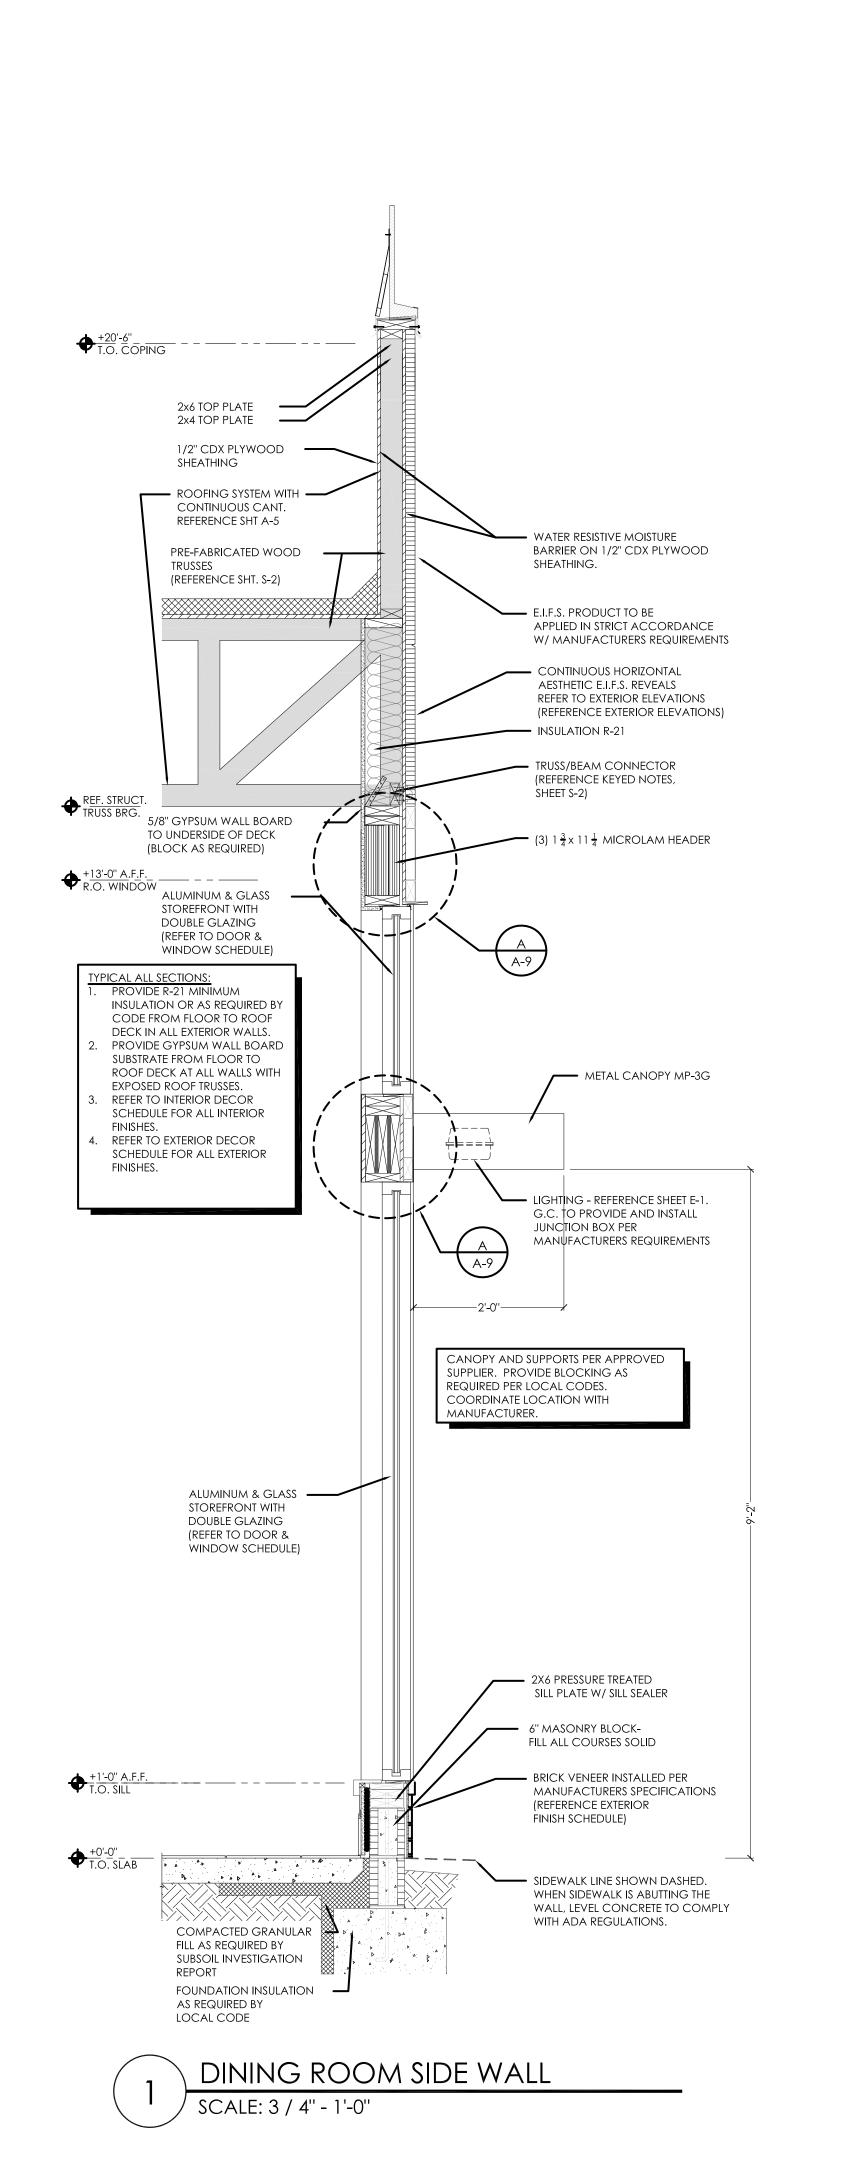
State Building And Engineering And Eng

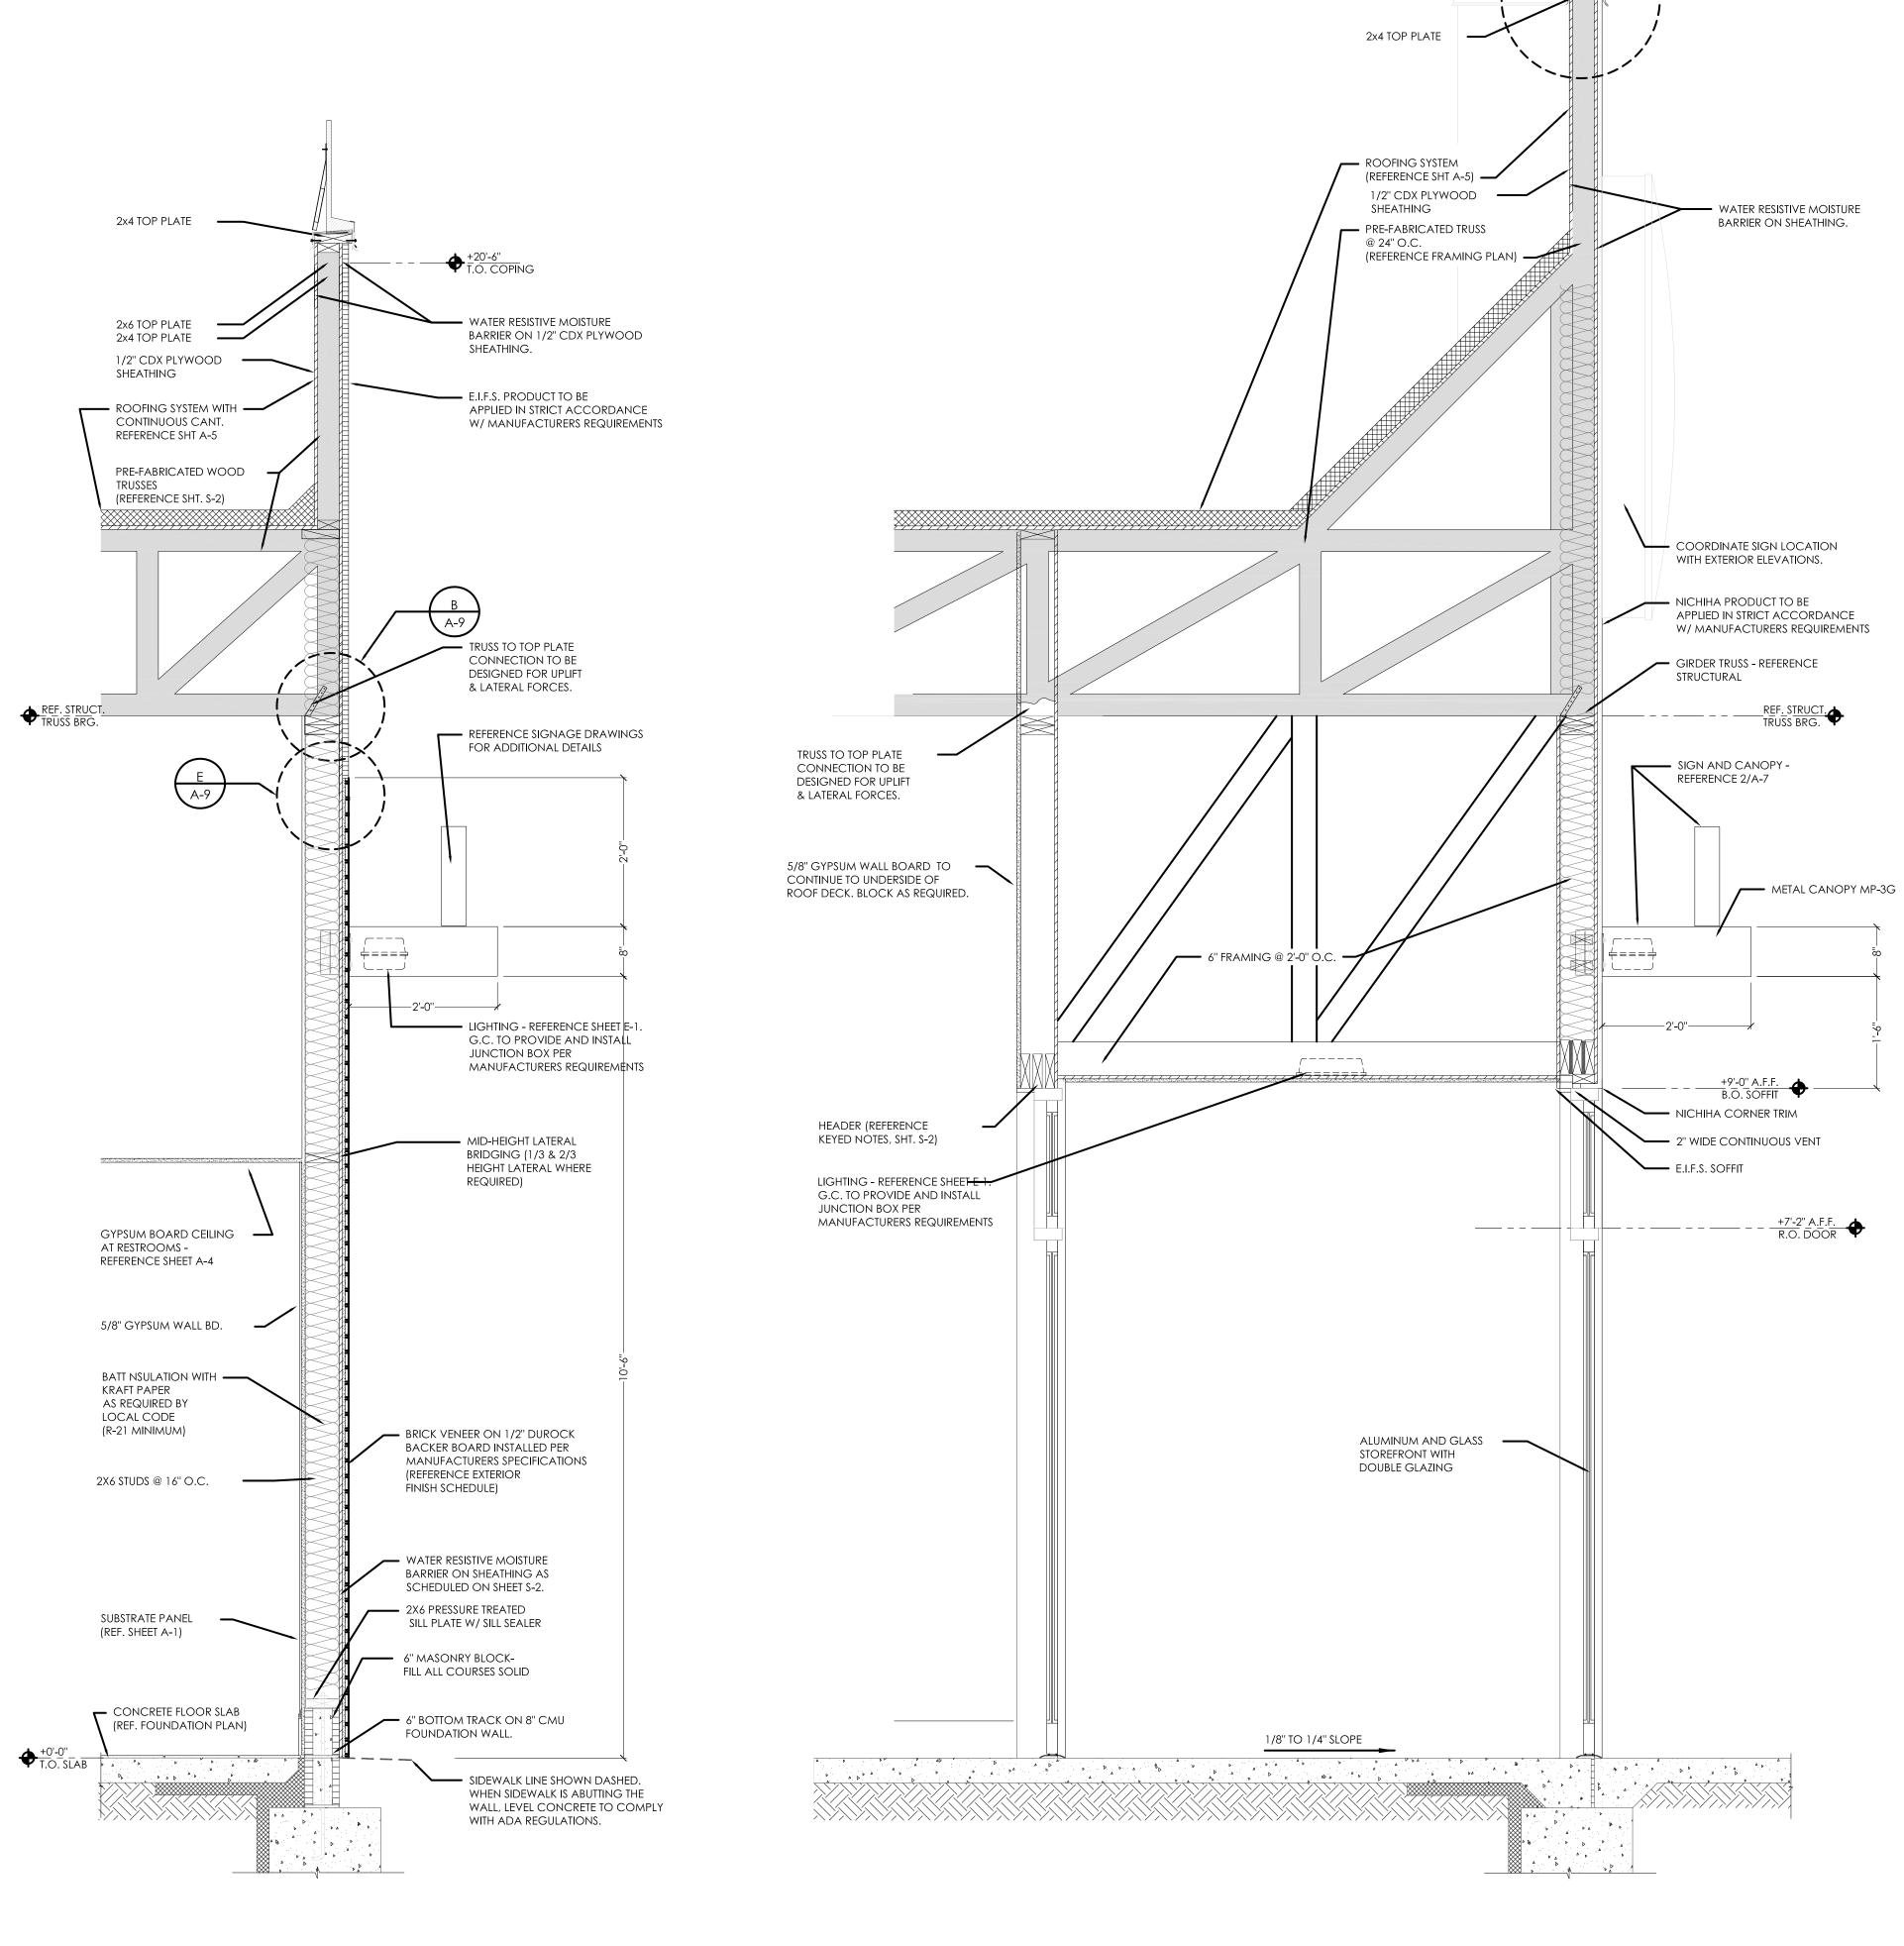
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PROJECT	BURGER KING 1440 NAPPANEE ST, ELKHART, IN 46514	SHEET TITLE WALL SECTIONS AND DETAILS
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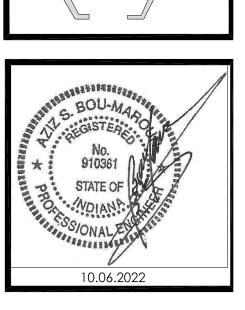


MAIN ENTRANCE WALL


MAIN ENTRANCE TOWER

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No. Date By Notes

State Building and Engineering Review

State Building and Engine Review

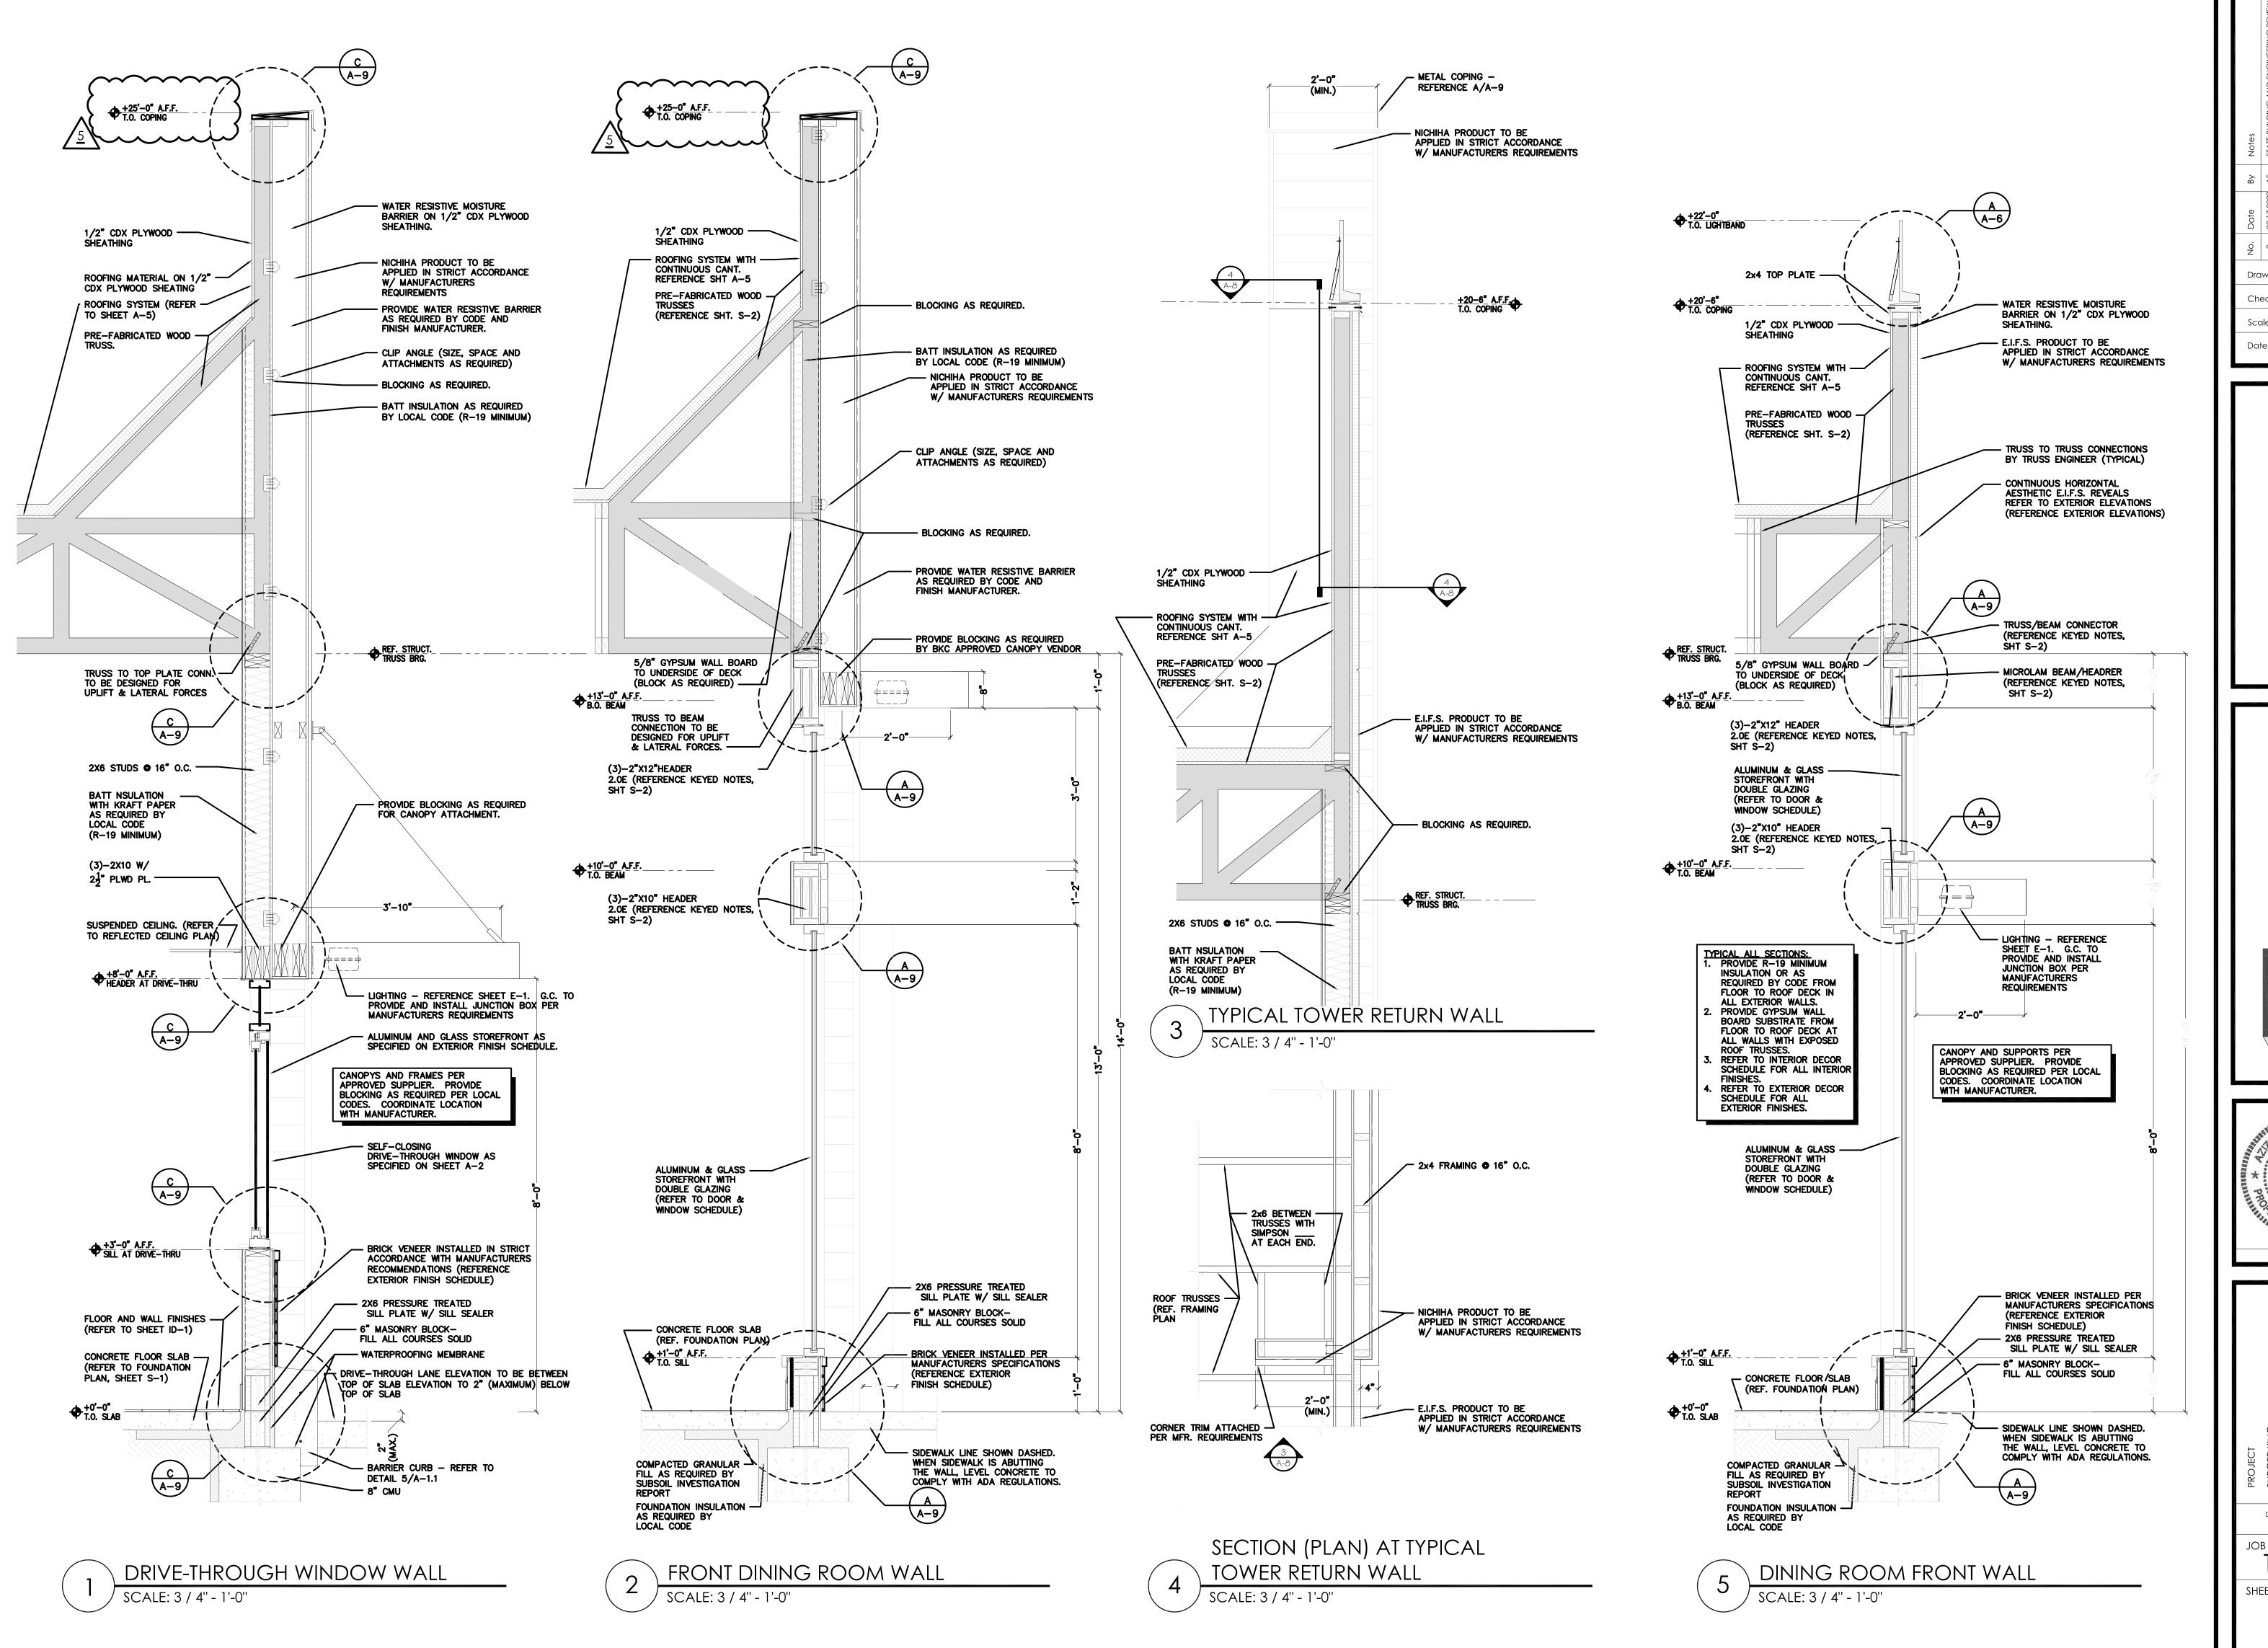
State Building and Engineering Review

State Building Review

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WING CORPORATION



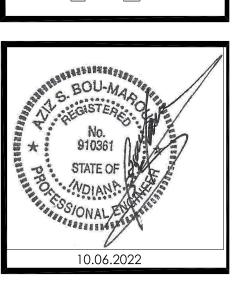

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ELKHART, IN 46514
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1440 NAPPANEE ST,
ELKHART, IN 46514

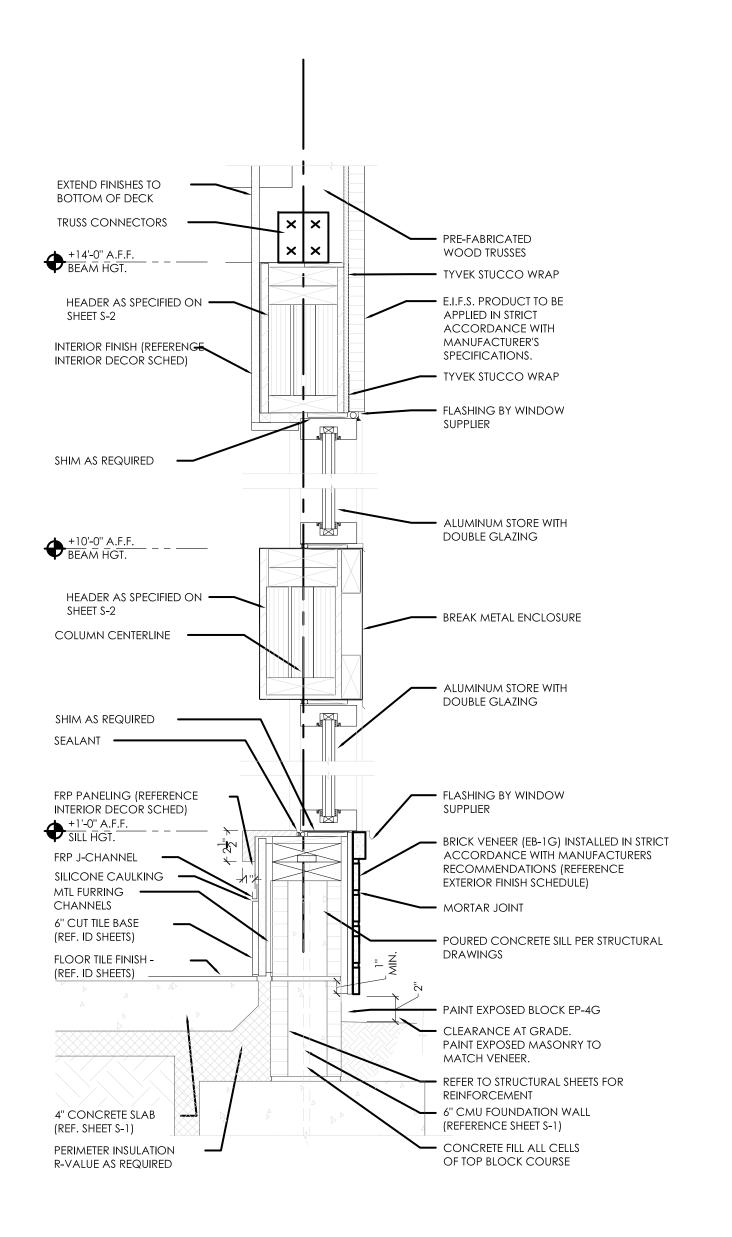
WALL SECTIONS

SHEET TITLE

SHEET

SHEET

A-8



BASE-SILL-HEADER-CAP DETAILS

SCALE: 1 1 / 2" - 1'-0"

WAINSCOT/STUCCO TRANSITION

+3'-0" A.F.F. T.O. WAINSCOT

SUBSTRATE PANELS

SCALE: 1 1 / 2" - 1'-0"

(REF. SHEET A-1)

BATT INSULATION

- EIFS PRODUCT INSTALLED

PER MANUFACTURER'S

REINFORCE EDGE PER EIFS

BARRIER.

FLASHING

- 1" THICK THIN BRICK

THIN BRICK FINISH (EB-1G)

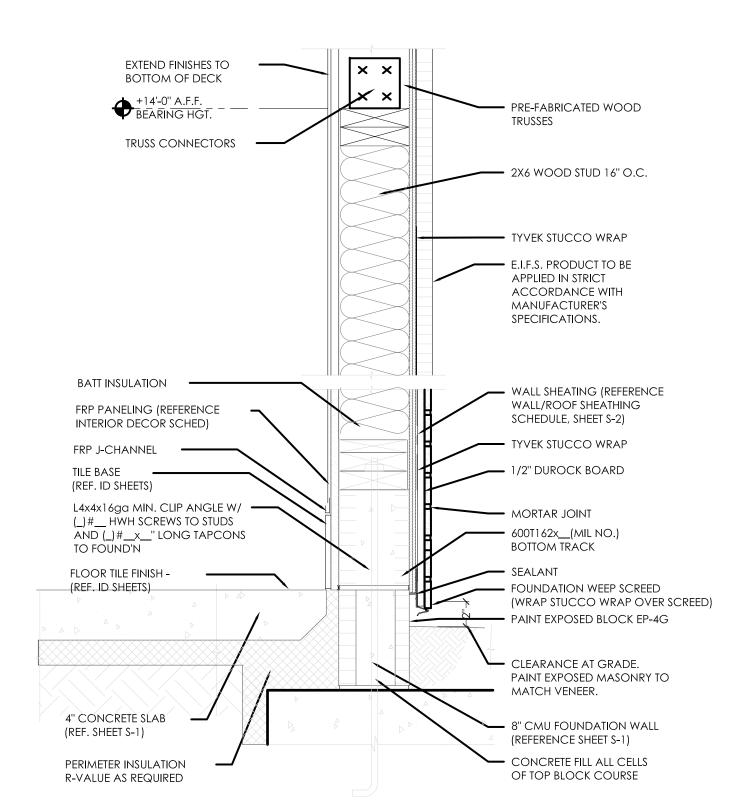
INSTALLED PER MFR. SPEC.

 WALL SHEATING (REFERENCE WALL/ROOF SHEATHING SCHEDULE, SHEET S-2)

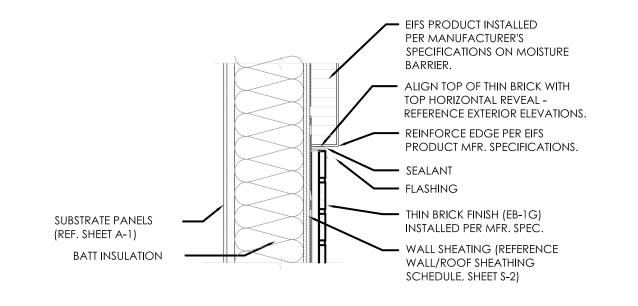
AT TOP COURSE

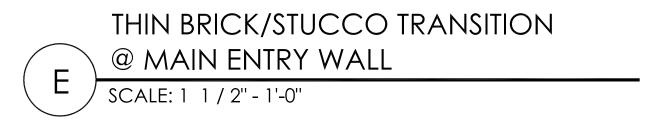
SPECIFICATIONS ON MOISTURE

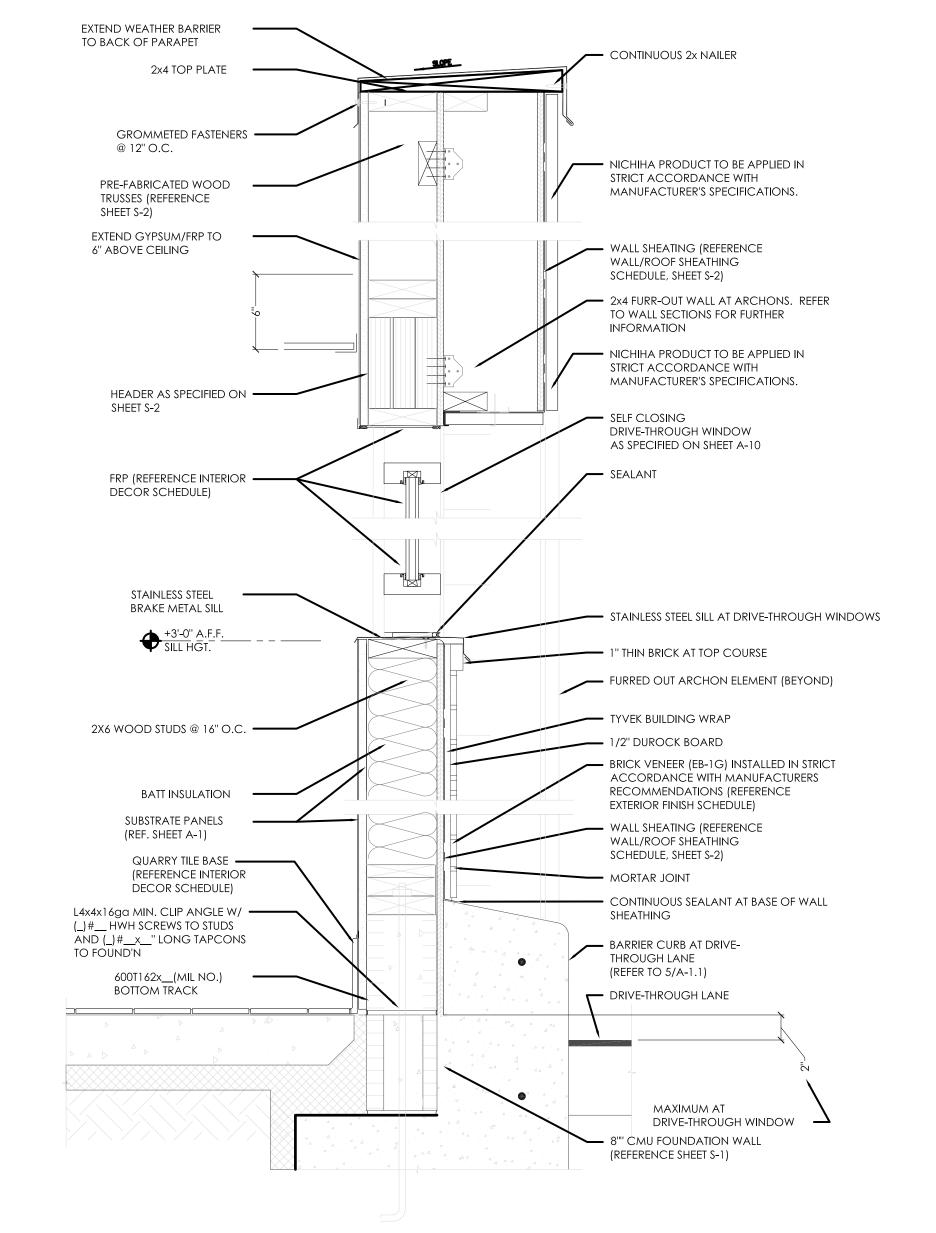
PRODUCT MFR. SPECIFICATIONS.













DRIVE-THROUGH

BASE-SILL-HEADER-CAP DETAILS

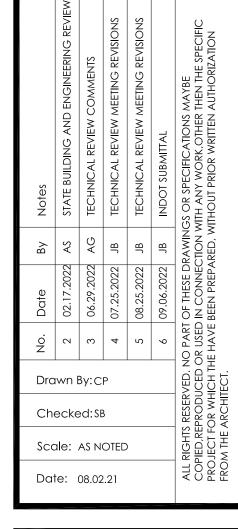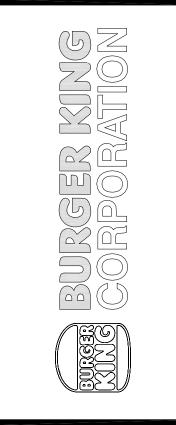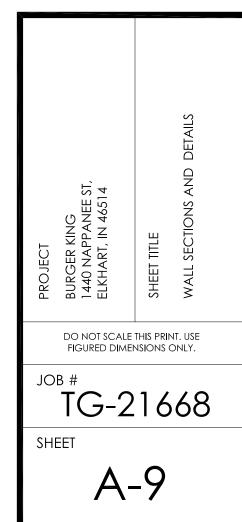
SCALE: 1 1 / 2" - 1'-0"

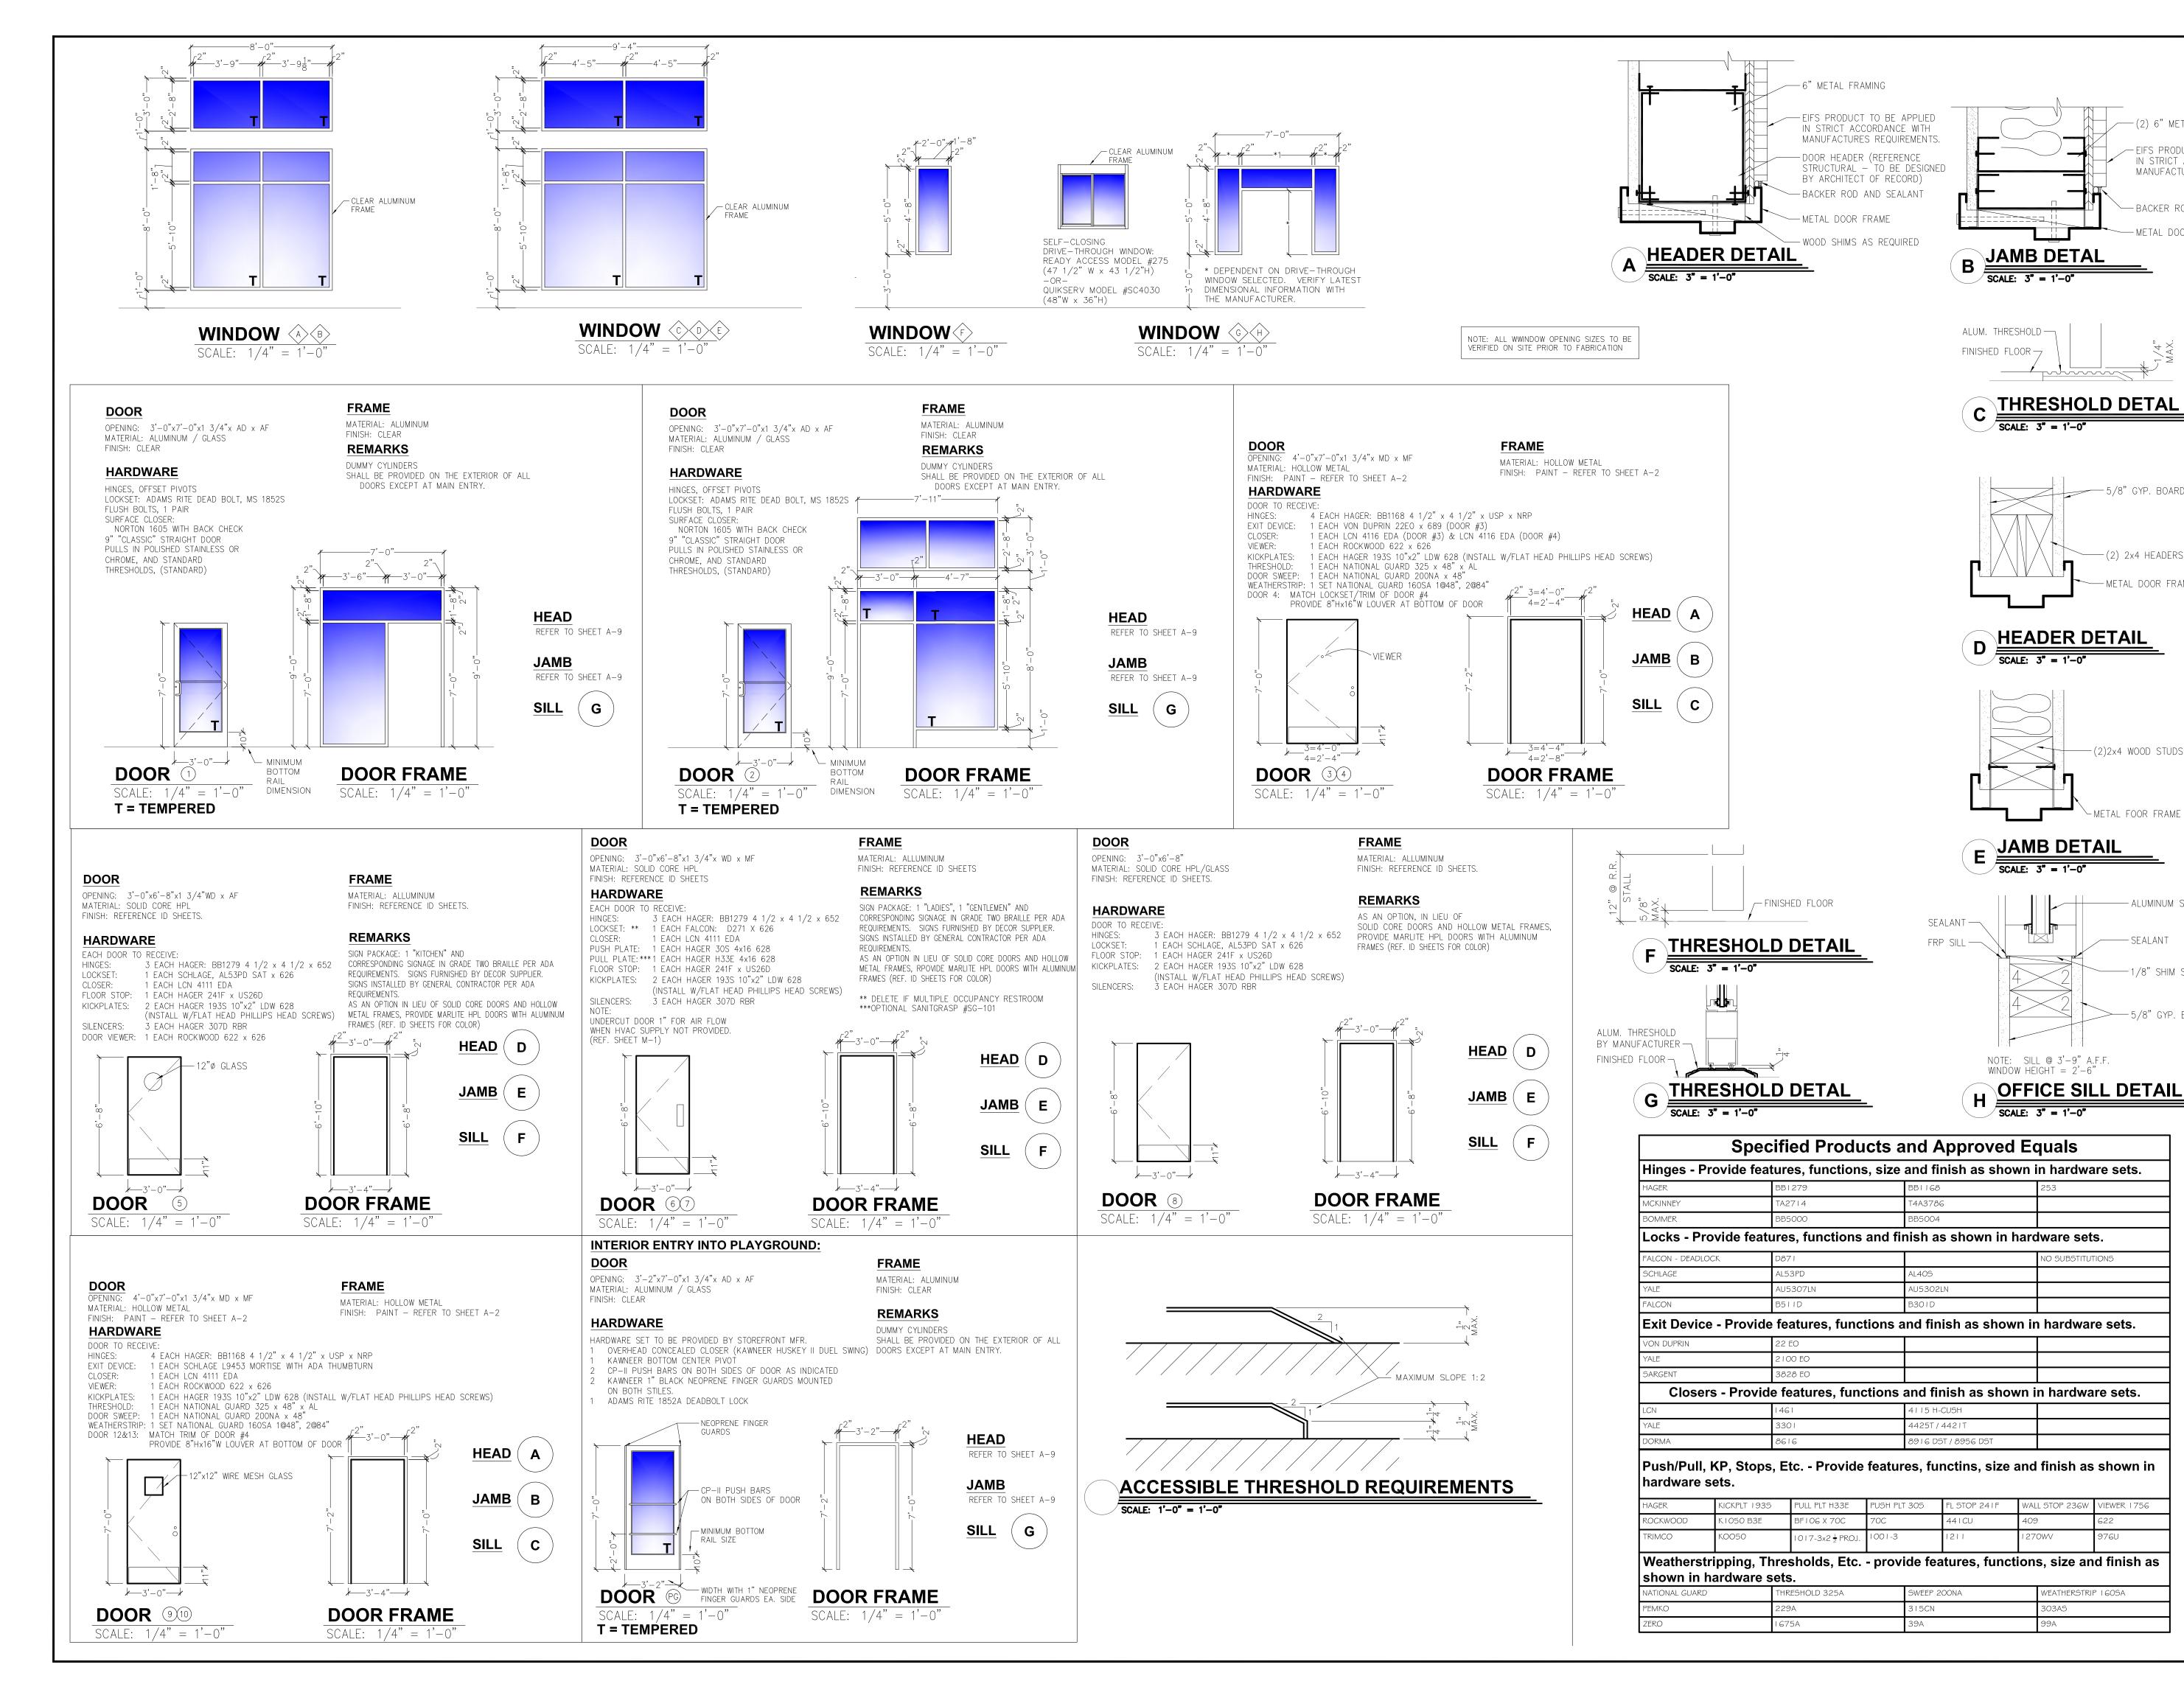


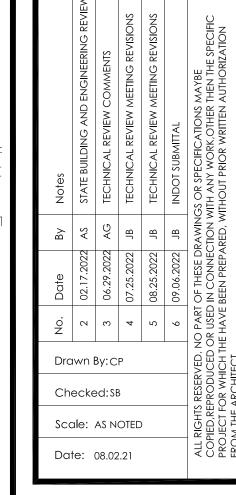












—(2) 6" METAL STUDS

-EIFS PRODUCT TO BE AP

IN STRICT ACCORDANCE W

MANUFACTURES REQUIREME

--- BACKER ROD AND SEALAN

- METAL DOOR FRAME

-(2) 2x4 HEADERS

-METAL DOOR FRAME

— (2)2x4 WOOD STUDS

- METAL FOOR FRAME

– SEALANT

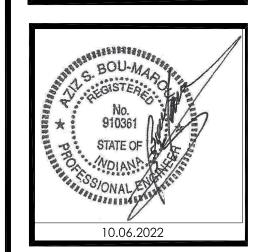
EATHERSTRIP 160SA

- ALUMINUM STOREFRONT

-1/8" SHIM SPACE










PROJECT BURGER KING 1440 NAPPANEE ST, ELKHART, IN 46514	Sheet title Door and window schedule				
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JOB # TG-2	1668				

	This list i	s intended to assist the contractor in sourcing building mater	als and products. In many cases, approved Burger King materia	RY OF MANUFACTURERS AND als and products may be purchased directly from these source	30-40 () 30-30 () 31-31 () 34-31	roved manufacturers, see plans and specifications, and visit RSI	's eRedbook.	
JPDATE: 7-15-2021 DIVISION 4 - MASONRY		DIVISION 9 - FINISHES		DIVISION 15 - MECHANICAL		EQUIPMENT, PLAYGROUNDS AND DÉCOR		
PINE HALL BRICK CO. THIN BRICK & FACE BRICK) 1701 SHOREFAIR DRIVE, NW VINSTON-SALEM, NC 27105 THERESA BEANE: (800) 334-8689 TBEANE@PINEHALLBRICK.COM	EVOLUTION BRICK (THINK BRICK, PANELIZED THIN BRICK & FACE BRICK) 126 OLD HIGHWAY 60 EAST HARDINSBURG, KY 40143 GABE POWERS: (502) 558-4612 gabe@evolutionbrick.com		NISH SCHEDULES FOUND IN THE "COMMON DOCUMENTS" ESIGNWITHBK.COM WEBSITE.	RINNAI (INSTANT WATER HEATERS) RINNAI NATIONAL ACCOUNT PRICING THROUGH HAINES, JONES, & CADBURY bk@hjcinc.com OR 800-459-7099	EVERPURE, INC (WATER FILTERS) 1040 MUIRFIELD DRIVE HANOVER PARK, IL. 60133 SEAN TEAL 630-306-0296 sean.teal@pentair.com	SICOM (XENIAL) (POS, IDMB&ODMB HARDWARE/SOFTWARE, SPEED OF SERVICE TIMER, KITCHEN MINDER -CHEF) 4434 MEADOW DRIVE DOYLESTOWN, PA, 18901 bksales@sicom.com MICHAEL SCHWARTZ 215-489-2500 EXT 2249 michael.schwartz@xenial.com	STRATACACHE (CONTROLLERS FOR INTERIOR MENU BOARDS AND OUTDOOR DIGITAL MENU BOARDS) 40 North Main Street Dayton Ohio 45423 KEVIN FENTON (678)427-3139 kfenton@stratacache.com	BMC USA LLC (INTERIOR & EXTERIOR DÉCOR) 2655 SOUTH LE JEUNE ROAD, SUITE 905 CORAL GABLES, FL 33134 EMILIO MARTINEZ FERNÁNDEZ emiliomartinez@bmcec.com
MUDDOX BRICK CO. ICE BRICK) 75 BRADSHAW ROAD CRAMENTO, CA 95827 IN LYNCH 916-206-7831	BORAL STONE (MANUFACTURED STACKED STONE) 1370 GRAND AVENUE, SUITE B SAN MARCOS, CA 92078 SUSAN KING (413) 207-7285 Susan.King@boral.com culturedstone@boral.com	ARMSTRONG STRATEGIC ACCOUNTS (CEILING TILE) CHERYL SMITH 252-214-4426 cbsmith@armstrongceilings.com OR ARMSTRONG STRATEGIC ACCOUNTS (800) 442-4212 armstrongcsa@armstrongceilings.com	USG INTERIORS (CEILING TILE) JOHN FUNES 312.436.5841 JFUNES@USG.COM NOTE: USE PROGRAM QUOTE # 00103139 TO RECEIVE NATIONAL BKC PRICING	RHEEM (WATER HEATERS) RHEEM NATIONAL ACCOUNT PRICING THROUGH HAINES, JONES, & CADBURY bk@hjcinc.com OR 800-459-7099	SELECTO SCIENTIFIC, INC (WATER FILTERS) 3980 LAKEFIELD COURT SUWANEE, GA. 30024 CUSTOMER SERVICE (800)635-4017 x3	Samsung/LSI (INTERIOR & OUTDOOR DIGITAL MENU BOARD SCREENS) 10000 ALLIANCE ROAD CINCINNATI, OH 45242 DAVID WATFORD 850-826-4602 d.watford@sea.samsung.com	PANASONIC (DRIVE THRU HEADSETS) 2 RIVERVIEW PLAZA, 6TH FLOOR NEWARK, NJ 07102 THERESA MURPHY 201-492-0925 theresa.murphy@us.panasonic.com	CASABLANCA DESIGN GROUP (DECOR) 811 PICKENS INDUSTRIAL DRIVE MARIETTA, GA 30026 JOHN HARRISON 770-423-9575 John.Harrison@cdg.com
IVISION 5 - METALS DDISON STEEL TRUCTURAL STEEL) DDISON, IL 56-747-1554	DIVISION 6 - WOODS, COMPOSITES REDBUILT TRUSSES (PRE-FABRICATED ENGINEERED TRUSSES) Delaware, OH 43015 JARVIS JACKSON 740-368-4229 jjackson@redbuilt.com	DIVISION 10 - SPECIALTIES BOBRICK/KOALA KARE PRODUCTS (RESTROOM ACCESSORIES, TOILET PARTITIONS & HARDWARE, BABY CHANGING TABLES & HIGHCHAIRS) CONTACT: HAINES, JONES, & CADBURY (HJC) RESTROOM REMODELS COMPANY HAMILTON PARKER	SPROVERI'S CUSTOM COUNTERS (CORIAN VANITY SINKS) 55 LAURA DRIVE ADDISON, IL 60101 CONTACT: HAINES, JONES, & CADBURY (HJC) RESTROOM REMODELS COMPANY	3M FOOD SERVICE (WATER FILTERS) 3M CENTER BLDG. 223-2N-20 ST. PAUL, MN. 55144-1000 DAVID RADCLIFF 518-281-7754 dpradliff@mmm.com foodservice@mmm.com	ANTUNES (WATER FILTERS) 180 KEHOE BOULEVARD CAROL STREAM, IL 60188 SUSAN SUTTER 630-784-3447 susan.sutter@antunes.com	LG ELECTRONICS (INTERIOR & OUTDOOR DIGITAL MENU BOARD SCREENS) 2000 MILLBROOK DRIVE LINCOLNSHIRE, IL 60069 MICHAEL HA 847-941-8855 michael1.ha@lge.com	3M FOOD SERVICE BUSINESS (DRIVE THRU HEADSETS) 3M CENTER BLDG. 223-2N-20 ST. PAUL, MN. 55144-1000 JOE CIAMPI: 704-771-2449 jjciampi@mmm.com	CHARTER HOUSE INC. (INTERIOR & EXTERIOR DÉCOR) 4660 136 AVENUE HOLLAND, MI. 49424 800-314-7659 KEITH LEBERT 248-996-0315 keith.lebert@charter-house.com
IVISION 7 - THERMAL MOISTURE PROTECTION URO-LAST ROOFING (LAT ROOFING) 25 MORLEY DRIVE AGINAW, MI 48601 ationalaccounts@duro-last.com 800-432-9331	BASF CORPORATION (POLYURETHANE ROOFING SYSTEMS) 1703 CROSS POINT AVE HOUSTON, TX 77054 ANDREW FOPPE (980) 218-1894 andrew.foppe@basf.com	HAINES, JONES, AND CADBURY (HJC) (RESTROOM PLUMBING & ACCESSORIES, TOLIET PARTITIONS, CORIAN SINKS, WATER HEATERS, HIGH CHAIRS) 310 SW 24TH STREET BENTONVILLE, AR 72712 bk@hjcinc.com OR 800-459-7099	RESTROOM REMODELS COMPANY (RESTROOM PLUMBING & ACCESSORIES, CORIAN SINKS) 15 HAMMATT STREET IPSWICH, MA 01938 Krislynn Maciel 978-525-0008 kris@restroomremodels.com	ECOLAB (WATER FILTERS) 1801 RIVERBEAND WEST DRIVE FORT WORTH, TX 76118 AL POWELL 816-206-2513 al.powell@ecolab.com	CARRIER CORPORATION (AIR CONDITIONING) 6304 CARRIER PARKWAY SYRACUSE, NY. 13221 KEN REVILLA 954-218-0070 Ken.revilla@carriercom	HM ELECTRONICS, INC (HME) (DRIVE THRU HEADSETS) 14110 STOWE DRIVE POWAY, CA. 92064 STEVE LEE 858-848-3704 SLee@hme.com	FRANKE (KITCHEN EQUIPMENT CONSOLIDATOR, SMALLWARES, HOODS) 800 AVIATION PARKWAY SMYRNA, TN. 37086 CUSTOMER SERVICE: 800-877-5178 fs-bkparts.us@franke.com JOHN EDMONDS 615-267-1563 john.edmonds@franke.com	ELKAY SYSTEMS (FORMERLY ISI) (DECOR) 241 NORTH BROADWAY, SUITE 600 MILWAUKEE, WI 53202 CHRISTINA GUTIERREZ 414.847.0709 christina.gutierrez@elkay.com
ERRIDGE ROOFING METAL ROOF) YLER HALL AN ANTONIO, TX. 10-650-7047	TAMKO ROOFING PRODUCTS (FLAT ROOFING) P.O. BOX 1404 JOPLIN, MO. 64802 800-641-4691	AMERICAN STANDARD (RESTROOM ACCESSORIES) 1 CENTENNIAL AVENUE PISCATAWAY, NJ. 08854 CONTACT: HAINES, JONES, & CADBURY (HJC) RESTROOM REMODELS COMPANY HAMILTON PARKER	HAMILTON PARKER COMPANY (RESTROOM PLUMBING & ACCESSORIES, HIGH CHAIRS) 1865 LEONARD AVENUE COLUMBUS, OH 43219 JIM CAMPBELL 614-358-7806 jimcampbell@hamiltonparker.com	TRANE (AIR CONDITIONING UNITS, RTU's/SPLIT SYSTEMS CONTROLS) 2884 CORPORATE WAY MIRAMAR, FL. 33025 CHRIS ST. JOHN 407-325-7123 bkhvac@trane.com	LOREN COOK CO (EXHAUST FANS) 2015 E. DALE SPRINGFIELD, MO 65803-4637 BRENT FULLERTON 417-869-6474 bfullerton@lorencook.com	QUALSERV SOLUTIONS (KITCHEN EQUIPMENT CONSOLIDATOR, SMALLWARES) 7400 SOUTH 28th STREET FORT SMITH, AR. 72908 BRITTANY GOODWIN (479)646-8386 x335 BGoodwin@qualservsolutions.com	DUKE MANUFACTURING (BROILERS & PRODUCT HOLDING UNITS) 2305 NORTH BROADWAY ST. LOUIS MO. 63102 RICK GARRIGA 306-606-2084 rgarriga@dukemfg.com	FCC COMMERCIAL FURNITURE (INTERIOR & EXTERIOR DÉCOR) 8452 OLD HWY. 99 NORTH ROSEBURG, OR. 97470 PRESTON O'HARA 800-322-7328 EXT 284 preston.ohara@fccfum.com
IRESTONE METAL PRODUCTS METAL ROOF) 50 WEST 96TH STREET NDIANAPOLIS, IN 46260 USUKE KOREEDA: 615-345-9991 oreedayusuke@firestonebp.com	G.A.F. (FLAT ROOF) 1361 ALPS ROAD WAYNE, NJ. 07470 (201) 628-3000 800-766-3411	SAN JAMAR (KITCHEN PAPER TOWEL DISPENSORS & SUPPLIES) 555 KOOPMAN LANE ELKHORN, WI. CONTACT: FRANKE, INC. H&K INTERNATIONAL QUALSERV SOLUTIONS	WORLD DRYER, CO (HAND DRYERS) CONTACT: HAINES, JONES, & CADBURY (HJC) RESTROOM REMODELS COMPANY HAMILTON PARKER	FRANKE, INC. (BROILER AND FRYER VENTILATION HOODS) 800 AVIATION PARKWAY SMYRNA, TN 37086 800-877-5718 fs-bkparts.us@franke.com	AMEREX CORPORATION (FIRE PROTECTION SYSTEMS) 7595 GADSDEN HIGHWAY TRUSSVILLE, AL 35173-0081 JAMES KNOWLES 205-655-5721 james.knowles@amerex-fire.com www.amerex-fire.com	H & K INTERNATIONAL (KITCHEN EQUIPMENT CONSOLIDATOR, SMALLWARES, HOODS) 2200 SKYLINE DR DALLAS, TX 75223 HEATHER VALVERDE 561-626-1020 heather.valverde@hki.com	NIECO CORPORATION (BROILERS) 7950 CAMERON DRIVE WINDSOR, CA 95492 GUIDO NAVA 630-303-6824 gnava@nieco.com	FACILITY CONCEPTS, INC (FCI) (DECOR) 7676 ZIONSVILLE ROAD INDIANAPOLIS, IN 46268 (800)915-8890 customerservice@fcius.com KEN WEAVER kweaver@fcius.com
ICHIHA USA LLC FIBERCEMENT PANELS) 465 EAST JOHNS CROSSING, SUITE 250 DHNS CREEK, GA 30097 ICHIHA CUSTOMER SERVICE (770) 805-9466 K@NICHIHA.COM		H&K INTERNATIONAL (STAINLESS STEEL BATHROOM SINKS) 2200 SKYLINE DRIVE MESQUITE, TX 75149 HEATHER VALVERDE 214-818-3521 heather.valverde@hki.com	ZURN INDUSTRIES (PLUMBING FIXTURES) CONTACT: HAINES, JONES, AND CADBURY or RESTROOM REMODELS COMPANY	H&K INTERNATIONAL (BROILER AND FRYER VENTILATION HOODS) 2200 SKYLINE DRIVE MESQUITE, TX 75149 HEATHER VALVERDE 214-818-3521 heather.valverde@hki.com	GAYLORD INDUSTRIES, INC (BROILER AND FRYER VENTILATION HOODS) 10900 SOUTHWEST AVERY STREET TUALATIN, OR, 97062 ROB CARMICHAEL 770-265-2562 Rob.Carmichael@gaylordventilation.com	TRIMARK USA (KITCHEN EQUIPMENT CONSOLIDATOR, SMALLWARES FOR AAFES ORDERS ONLY) 2601 HOPE CHURCH ROAD WINSTON-SALEM, NC 27103 BILLY HIGH 336-354-4262 billy.high@trimarkusa.com	PITCO FRIALATOR (FRYERS) 10 FERRY STREET CONCORD, NH. 03301 MARK MCCABE: 603-230-5509 MMcCabe@pitco.com	SEATING CONCEPTS (DECOR) 125 CONNELL STREET ROCKDALE, IL. 60436 (815)730-7980 ZACH DEPYSSLER zdepyssler@seating-concepts.com
		Customer 1st LLC (SAFES) 8899 EAST DAILY ROAD, SUITE #51 PEKIN, IN 47165 MIKE MARCOSA -877-768-9970 mike@customer1stsafes.com	ECOLAB FOOD SAFETY SPECIALTIES INC, DBA DAYDOTS (FIRST AID KITS) 201 EAST JOHN CARPENTER FREEWAY IRVING, TX 75062 ANNA MALHIS 800-321-3687 customercare@daydots.com			FRYMASTER CORPORATION (FRYERS) 8700 LINE AVE SHREVEPORT, LA 71106 JOAN SALAH 813-504-9262 Joan.Salah@welbilt.com	LANCER CORP. (BEVERAGE SYSTEM) 6655 LANCER BLVD SAN ANTONIO, TX. 78219 GREG EDWARDS: 817-692-5094 greg.edwards@lancercorp.com	NAUTICAL FURNISHINGS, LLC (LIMITED DÉCOR ITEMS) 60 NW 60TH STREET FT. LAUDERDALE, FL 33309 MICHAEL HOGLUND: 954-771-1100 mhoglund@nauticalfumishings.com
UIKSERV DRIVE-THRU WINDOWS & AIR CURTAINS) 1441 BRITTMOORE PARK DRIVE OUSTON, TX. 77041 00-388-8307 RIAN MCCLOSKEY mccloskey@quikserv.com	MARLITE (RESTROOM PARTITIONS, ALUMINUM FRAMES & DOORS, DOOR HARDWARE, (HINGES, LOCKS, ETC) 202 HARGER STREET DOVER, NH 44622 800-377-1221 ANITA CRAIG 330-260-7621 acraig@Marlite.com	DIVISION 10 - SIGNS & CANOPIES ALLEN INDUSTRIES, INC (CANOPIES AND SIGNS) 11351 49TH STREET NORTH CLEARWATER, FL 33762 MEGAN PYRTLE 336-615-8688 bk@allenindustries.com	LEKTRON, INC (LED PARAPET LIGHT BANDS) 7450 E. 46th PLACE TULSA, OK. 74145 LANCE MITCHELL 918-622-4978 BurgerKing@LektronInc.com	DIVISION 16 - ELECTRICAL SECURITY LIGHTING SYSTEMS (FULL STORE PACKAGE LIGHTING FOR INTERIOR/EXTERIOR BUILDING & SITE LIGHTS, SURVEYS AND PHOTOMETRICS) 2100 GOLF ROAD, SUITE 460 ROLLING MEADOWS, IL. 60008 WHITNEY WATSON: 800-544-4848 EXT 131 wilg@securitylighting.com	HERMITAGE LIGHTING NATIONAL ACCOUNTS (MASTER LIGHTING CONSOLIDATOR, SURVEYS AND PHOTOMETRICS) 3640 TROUSDALE DRIVE NASHVILLE, TN. 37204 WYATT CULVER (615) 843-3379 wculver@gohermitage.com	FBD PARTNERSHIP, LP (FROZEN BEVERAGE) 8161 INTERCHANGE PARKWAY SUITE 115 SAN ANTONIO, TX 78218 JOE CLEMENTS 214-732-9555 jclements@fbdfrozen.com	CORNELIUS, INC. (BEVERAGE SYSTEM) 101 BROADWAY STREET WEST OSSEO, MN 55369 ROSS DAVIS: 630-659-8690 ross.davis@comelius.com	COMMERCIAL INTERIOR MANUFACTURERS, I (LIMITED DÉCOR ITEMS) 158 HOLLY STREET JASPER, GA. 30143 AUSTIN HOLAN 706.299.0327 austin@cimgbiz.com
EADY ACCESS PRIVE THRU WINDOWS & AIR CURTAINS) B15 ARTHUR DRIVE WEST HICAGO, IL. 60185 ELLY MCGOLDRICK: 800-621-5045 EXT 113 Elly@ready-access.com	COMMERCIAL INTERIORS MANUFACTURING (RESTROOM PARTITIONS, HOLLOW METAL FRAMES & DOORS, HARDWARE (HINGES, LOCKS, ETC) 158 HOLLY STREET JASPER, GA 30143 AUSTIN HOLAN: 706.299.0327 austin@cimgbiz.com	ENTERA SIGNS (CANOPIES AND SIGNS) 1200 ENTERA DRIVE PANAMA CITY, FL. 32401 MATT CZAJKOWSKI 850-691-9652 matt@enterabranding.com	CUMMINGS SIGNS, INC (CANOPIES AND SIGNS) 105 DALTON PLACE WAY KNOXVILLE, TN 37912 JOEL EFFLER 615-872-5483 joel.effler@cummingssigns.com	LSI INDUSTRIES INC. (INTERIOR AND EXTERIOR LIGHTING, SURVEYS AND PHOTOMETRICS) 10000 ALLIANCE ROAD CINCINNATI, OH. 45242 BOB LUCAS 480-368-9399 OR 602-740-9894 Bob.Lucas@LSI-INDUSTRIES.com	ENERGYWISE SOULUTIONS, LLC (MASTER LIGHTING CONSOLIDATOR, SURVEYS AND PHOTOMETRICS) 8550 UNITED PLAZA BOULEVARD, SUITE 702 BATON ROUGE, LA 70809 JENNIFER WADDICK 877-225-1336 jennifer@energywisemail.com	INTERNATIONAL COLD STORAGE (ICS) (WALK-IN COOLERS / FREEZERS, DRY STORAGE COMPARTMENTS) 215 EAST 13th STREET ANDOVER, KS. 67002 LYNNE CLATTERBUCK 316-218-4126 Lynne.clatterbuck@icsco.com	TAYLOR ULTIMATE SERVICES, INC (SHAKE MACHINE, FROZEN BEVERAGE MACHINE) 1780 NORTH COMMERCE PKWY WESTON, FL. 33326 RJ PIEDRA: 954-217-9100 raul@taylorus.com	TWENTY FOUR 7 GLOBAL SOLUTIONS, INC. (GARDEN GRILL, PRIME & ROYAL CHAIRS AND BARSTOOLS) 898 NORTH SEPULVEDA BLVD, SUITE 465 EL SEGUNDO, CA 90245 GIANNE WON 323-319-2727 gianne.won@twentyfour7-global.com
AMILTON PARKER COMPANY HOLLOW METAL FRAMES & DOORS, WOOD DOORS, IARDWARE (HINGES, LOCKS, ETC) 865 LEONARD AVENUE OLUMBUS, OH 43219 IM CAMPBELL 614-358-7806 mcampbell@hamiltonparker.com	3M COMMERCIAL CORE DIVISION (WINDOW FILM) 3M CENTER ST. PAUL, MN JOE CIAMPI: 704-771-2449 OR 800-328-0033 jjciampi@mmm.com	SIGN RESOURCE (CANOPIES AND SIGNS) 6135 DISTRICT BLVD. MAYWOOD, CA. 90270 KEN SIEGERT 810-241-0272 ken.siegert@signresource.com	FEDERAL HEATH SIGN CO (CANOPIES AND SIGNS) 12704 DUPONT CIRCLE TAMPA FL 33626 FIONA PAUL 813-855-4415 fpaul@federalheath.com	CREE LIGHTING (INTERIOR AND EXTERIOR LIGHTING, SURVEYS AND PHOTOMETRICS) 9201 WASHINGTON AVENUE RACINE, WI 53406 ELVIR SULJIC 262-884-3332 esuljic@creelighting.com	VAOPTO, LLC (INTERIOR AND EXTERIOR BUILDING LIGHTING) 5178 WEST PATRICK LANE LAS VEGAS, NV 89188 Linda Xu (702)517-5789 linda@vaopto.com	MANITOWOC ICE (ICE MACHINES) 2110 SOUTH 26TH STREET MANITOWOC, WI 54221 JOAN SALAH 813-504-9262 Joan.Salah@welbilt.com	KOLPAK, A WELBILT COMPANY (WALK-IN COOLERS / FREEZERS) 952 KISSWICH MANOR LANE BALDWIN, MO 63011 JOAN SALAH 813-504-9262 Joan.Salah@welbilt.com	WAUSAU TILE, INC (EXTERIOR DÉCOR FURNITURE & ACCESSORI P.O. BOX 1520 WAUSAU, WI 54402 RACHEL BATHKE 715-241-0320 RRBathke@wausautile.com
IGERSAFE USA, INC. NGER IN JAMB SAFETY - PLAYGROUNDS) 5 WEST OGLETHORPE AVENUE VANNAH, GA 31401 ders@fingersafe.com EAGAN KUJAWSKI 912-234-6120 eagan@Fingersafe.com		DAKTRONICS, INC (DIGITAL READERBOARD) 210 DAKTRONICS DRIVE BROOKINGS, SD 57006 GREG BREYFOGLE 407-310-3695 Greg.Breyfogle@daktronics.com	OPTEC DISPLAYS, INC (DIGITAL READERBOARD) 1700 SOUTH DESOTO PLACE ONTARIO, CA 91768 Chad Engstrom (626)252-8333 cengstrom@optec.com	KONTECHUSA (INTERIOR AND EXTERIOR BUILDING LIGHTING) 18045 ROLAND STREET CITY OF INDUSTRY, CA 91748 (866) 236-8701 Miguel Martinez (626)622-1325 mmartinez@kontechusa.com	HILL PHOENIX POWER SYSTEMS DIVISION (FACTORY INTEGRATED SWITCH GEAR) 8166 INDUSTRIAL BLVD COVINGTON, GA. 30014 dfr-info@doverfoodretail.com 770-285-3264	HOSHIZAKI AMERICA (ICE MACHINES) 618 HIGHWAY 74 SOUTH PEACHTREE CITY, GA 30269 ANGIE WARREN (770)487-2331 x11329 adwarren@hoshizaki.com	SCOTSMAN ICE SYSTEMS (ICE MACHINES) 775 CORPORATE WOODS PARKWAY VERNON HILLS, IL 60061 Evolution Team (800)726-8762 x15204 team.resolution@scotsman-ice.com	APA COLOR GRAPHICS (LIMITED DECOR ITEMS & GRAPHICS) 2929 PACIFIC DRIVE NORCROSS, GA 800.543.5775 CHUCK BOGEL 404.355.1355 chuck@apacolorgraphics.com
		NRS - NATIONAL READERBOARD SUPPLY (READERBOARD LETTERS & SUPPLIES) 160 PAHLONE PARKWAY PONCHA SPRINGS, CO 81242 Patrick Case 800-243-6676 Sales@nationalreaderboard.com				PLAY SYSTEMS/SII (SUPERIOR PLAY SYSTEMS) (PLAYGROUND MANUFACTURER) 1050 COLUMBIA DR. CARROLLTON, GA 30717 SHAN MCGUIRE 678-390-1915 https://superiorplay.com/	SOFT PLAY, LLC (PLAYGROUND MANUFACTURER, SAFETY SURFACING, NON-CONTAINED PLAY EQUIPMENT) 13620 EAST REESE BLVD. SUITE 300 HUNTERSVILLE, NC. 28078 BROCK HODGE 704-948-3430 brock.hodge@softplay.com	VGS, INC (GRAPHICS) 1696 MABRY MILL DRIVE, SW NORTH CANTON, OH 44709 BURGERKING@VGS-INC.COM (800)201-0301 x1
								LSI INDUSTRIES (GRAPHICS) 10000 ALLIANCE ROAD CINCINNATI, OH. 45242 BOB LUCAS 480-368-9399 OR 602-740-9894 Bob.Lucas@LSI-INDUSTRIES.com
								MÖSS RETAIL AND ENVIRÖNMENTS (GRAPHICS) 2643 WEST CHICAGO AVE CHICAGO, IL 60622 bk@mossinc.com Scott Metzger 847.238.4245 smetzger@mossinc.com

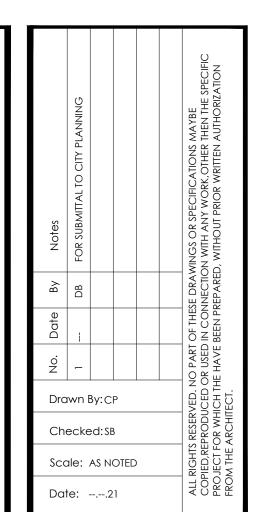

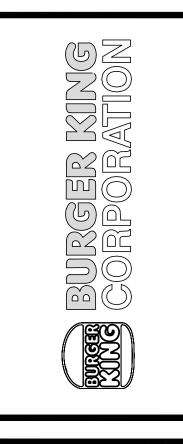


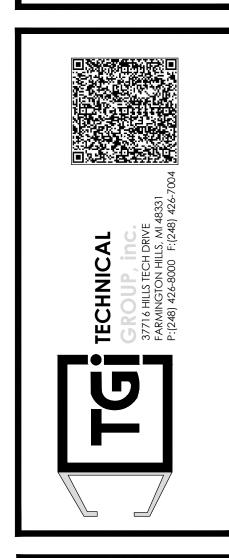





PROJECT	BURGER KING 1440 NAPPANEE ST, ELKHART, IN 46514	SHEET TITLE MANUFACTURERS AND SUPPLIERS
		ALE THIS PRINT. USE MENSIONS ONLY.
JOE		21668

TEM#	QTY.	DESCRIPTION	MANUFACTURER	MODEL#	UL#	NSF	
1.81	1	SERVICE CHASE	FRANKE	-	-	2	FRANI
2.02	10	DRY STORAGE SHELVING	INTERMETRO	-	-	2	FRANI
2.04	20	UNDERCOUNTER POST	INTERMETRO	-	-	2	FRANI
2.11	1	CUP LID HOLDER MOBILE CUP DISPENSER CART	FRANKE FRANKE	<u>-</u>	<u>-</u>	2	FRAN FRAN
2.46	1	STRAW DISPENSER	VOLLRATH	3815-28	_	2	FRAN
2.61	2	UNIVERSAL CONDIMENT HOLDER	FRANKE	-	-	2	FRAN
2.88	1	EXTREME COUNTERTOP DISPENSER	SERVER PRODUCTS	ECD 07500	_	-	FRAN
3.11 4.13	1	24"W x 30"D DRIVE THRU TABLE W/CUP DISPENSER DRIVE THRU TABLE W/ HAND SINK	FRANKE FRANKE	- 18006428	-	2	FRAN FRAN
4.13	1	DROP-IN-SINK	ADVANCE TABCO	DI-1-5		2	FRAN
5.02	1	POS TABLE	FFSUS	-	_	2	FRAN
6.02	1	DRIVE THRU WORKSTATION	INTERMETRO	BKROC2448DT	_	2	FRAN
6.52	1	14" X 30" ORDER ASSEMBLY CART	INTERMETRO	BKBC1430	-	-	FRAN
7.11 15.27	1	SLICER, SABER KING HEAT TREAT COMBINATION SHAKE/SUNDAE MACHINE	PRINCE CASTLE TAYLOR	980-000-00 C606	- SA2650	6	FRAN FRAN
15.69	1	FROZEN BEVERAGE DISPENSER	FBD	12-7361-0010	3A2030 -	2	FRAN
15.83	1	FROZEN BEVERAGE DISPENSER CART	FBD	12-2516-0003	_	2	FRAN
16.21	1	ICE MACHINE	HOSHIZAKI	KM1301SRJ-BK	-	12	FRAN
16.41	1	ICE STORAGE BIN	HOSHIZAKI	B-800SF-BK	-	2	FRAN
16.61	1	ICE MACHINE REMOTE CONDENSING UNIT	HOSHIZAKI	URC-14F	-	2	FRAN
16.81	1	WALL SERVICE CHASE	FRANKE	- ITCP DV	-	2	FRAN
17.56 18.03	2	INFUSION TEA COFFEE BREWER ICED TEA DISPENSER - SLIM	BUNN-O-MATIC BUNN-O-MATIC	ITCB-DV -	_	2	FRAI FRAI
20.37	1	41" EXPEDITER STATION STD FLOW	FRANKE	EXPO5	E163328	2	FRAN
21.66	1	60" PREP MODULE "A" - (ABCD/ACBD)	FRANKE			2	FRAI
21.67	1	28" BUN TOASTER MODULE "B"	FRANKE	-	-	2	FRAI
21.68	1	32.5" PREP MODULE "C"	FRANKE	-	-	2	FRAN
21.69 22.02	1	20" PREP MODULE "D" UNIVERSAL ONCUE MICROWAVE OVERSHELF	FRANKE FRANKE	-	-	2	FRAI FRAI
23.45	1	91" BROILER HOOD	FRANKE	- 18022081		2	FRAN
23.77	1	EXHAUST FAN	FRANKE	18020256	UL 762	2	FRAN
23.80	1	ROOF CURB	FRANKE	18018809	-	2	FRAN
24.07	1	BROILER	DUKE	FBB-NO-120	-	4	FRAN
25.12	1	50" MEAT WELL FREEZER	FRANKE	-	-	2	FRAN
30.04	1	35" FRY STATION - ROC	FRANKE	- DV SSUGOV <i>VIEEI</i> GOVV ED	-	4	FRAI FRAI
31.16 32.52	1	3 - BANK FRYER PRODUCT HOLDING FREEZER	PITCO FRANKE	BK-SSH60W/55/60W-FD -		7	FRAN
32.58	1	REFRIGERATED BATTER STATION	H&K	52976	_	7	FRAN
33.30	1	67" FRYER HOOD	FRANKE	18022081	-	2	FRAN
33.68	1	EXHAUST FAN	FRANKE	18020256	UL 762	2	FRAN
33.82	1	ROOF CURB	FRANKE	18018809	-	2	FRAN
36.01 36.13	1	CONVECTION OVEN CONVECTION OVEN STAND	LANG MANUF. FRANKE	ECOH-PP2-08BK	-	2	FRAI FRAI
38.04	1	30"W x 24"D x 36"H WORK TABLE W/ 4" BACKSPLASH	FRANKE	-		2	FRAN
38.04	1	48"W x 30"D x 36"H WORK TABLE	FRANKE	-	_	2	FRAN
40.05	1	WALK-IN COOLER/FREEZER BOX	NORLAKE	-	-	7	FRAN
40.22	1	WALK-IN COOLER CONDENSING UNIT	NORLAKE	MHMD010AC	-	7	FRAI
40.30	1	WALK-IN FREEZER CONDENSING UNIT	NORLAKE	MSLD020AC	-	7	FRAN
40.36 40.41	1	WALK-IN COOLER EVAPORATOR WALK-IN FREEZER EVAPORATOR	NORLAKE NORLAKE	E1MD0078A-TA2 E1LD0056B-TE2	=	7	FRAI FRAI
40.41	1	REACH-IN FREEZER	TURBO AIR	M3F24-2-N		7	FRAN
41.02	28	COLD STORAGE SHELVING	INTERMETRO	-	-	2	FRAN
41.03	8	RACK DUNNAGE - COLD	NEW AGE	-	=	2	FRAI
42.02	60	DRY STORAGE SHELVING	INTERMETRO	-	-	2	FRAI
42.20	88	POST	INTERMETRO	DIZOMES (/ CE = :	-	2	FRAN
43.01 50.21	2	DOUBLE SMARTWALL SHELVING MICROWAVE	INTERMETRO ACP	BKSWP8446DBL OC24HBK	-	3	FRAI FRAI
51.19	2	MULTI-PRODUCT HOLDING UNIT	DUKE	HS2-34-2086T2R	<u>-</u>	4	FRAI
51.20	1	MULTI-PRODUCT HOLDING UNIT	DUKE	HS2-24-2084T1R	_	4	FRAN
53.55	2	REACH-IN UNDERCOUNTER REFRIGERATOR - FIELD	TURBO AIR	MUR-28-N-1C	_	7	FRAN
		REVERSIBLE DOOR				,	
55.02 59.51	2	RAPID VERTICAL TOASTER EGG COOKER	ANTUNES A.J. ANTUNES & CO.	BKT-2V ES-1200	<u>-</u> E49407	4	FRAI FRAI
60.01	1	3 COMPARTMENT SINK	FRANKE	LO-1200 -	<u> -</u> -	2	FRAI
61.01	1	ONE COMPARTMENT SINK W/ LH DRAINBOARD	FRANKE	-	-	2	FRAI
62.05	1	HANDS-FREE WASH STATION SINK	JOHN BOOS	PBHS-W-KVMB-1	=	2	FRAI
70.04	1	SAFE W/ ANCHORING	FIRE KING SECURITY	BSD2920	-		FRAN
71.01	2	LOCKER WATER FILTER	PENCO PRODUCTS	EL/10/S/GRAY	-	-	FRAN
73.01 73.11	1	FILTER FEEDER SCALE INHIBITOR	EVERPURE EVERPURE	CB20-312E SR-X	-	2	FRAI FRAI
901.00	1	9'-8" ROC MAIN BEVERAGE STATION	FRANKE	18023142	_	2	OTHE
910.01	1	ICE/SODA DISPENSER	LANCER	IBD 4500-44	UL763	18	OTHE
910.81	3	CARBONATOR	LANCER	85-1923-00	UL403	2	OTH
910.90	3	SHELF CARBONATOR F/ LANCER	LANCER	82-3876	-	2	OTH
911.03	1	ICE/SODA DISPENSER	LANCER	85-2378T-124	-	18	OTHE
911.31	1	ICE/SODA CONVERSION STAND	LANCER	84-0058 VEDIEV	-	2	OTHE
923.90 931.91	1	FIRE PROTECTION SYSTEM SHORTENING DISPOSAL CADDY SYSTEM	VERIFY DARLING INT.	VERIFY 1500-C	-	2	OTHE OTHE
931.91	1	FIRE PROTECTION SYSTEM	VERIFY	VERIFY	-	_	OTHE
	•					\vdash	
972.03	1 l	BAG-N-BOX SYRUP RACK	CORNELIUS	621065776	-	2	

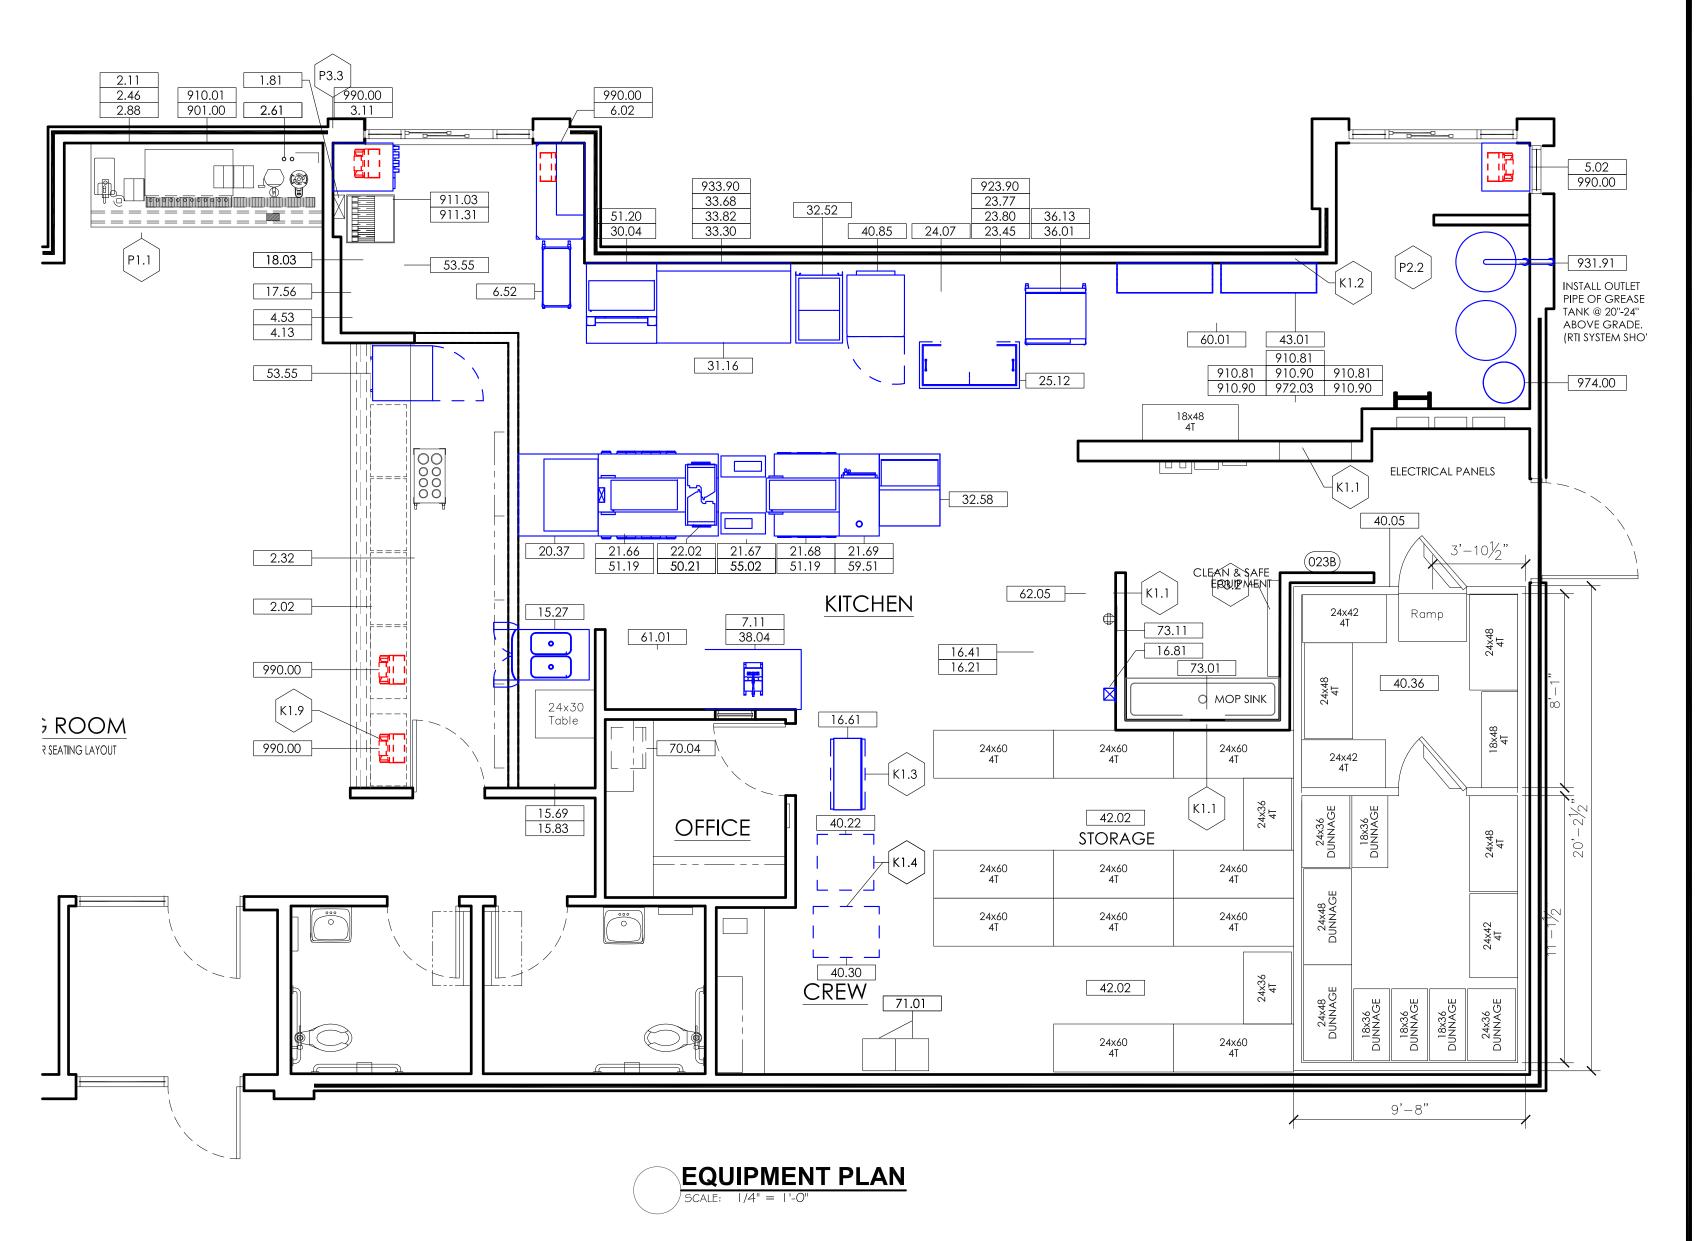

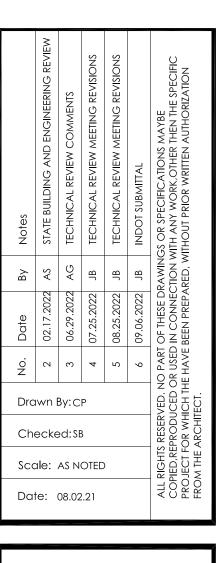


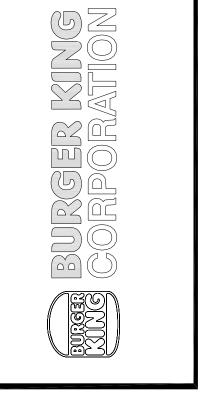





	NG ANEE ST, N 46514	T PLAN
PROJECT	BURGER KING 1440 NAPPANEE ST, ELKHART, IN 46514	SHEET TITLE EQUIPMENT PLAN
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PLENUMIZED CURB INSTALLATION NOTES

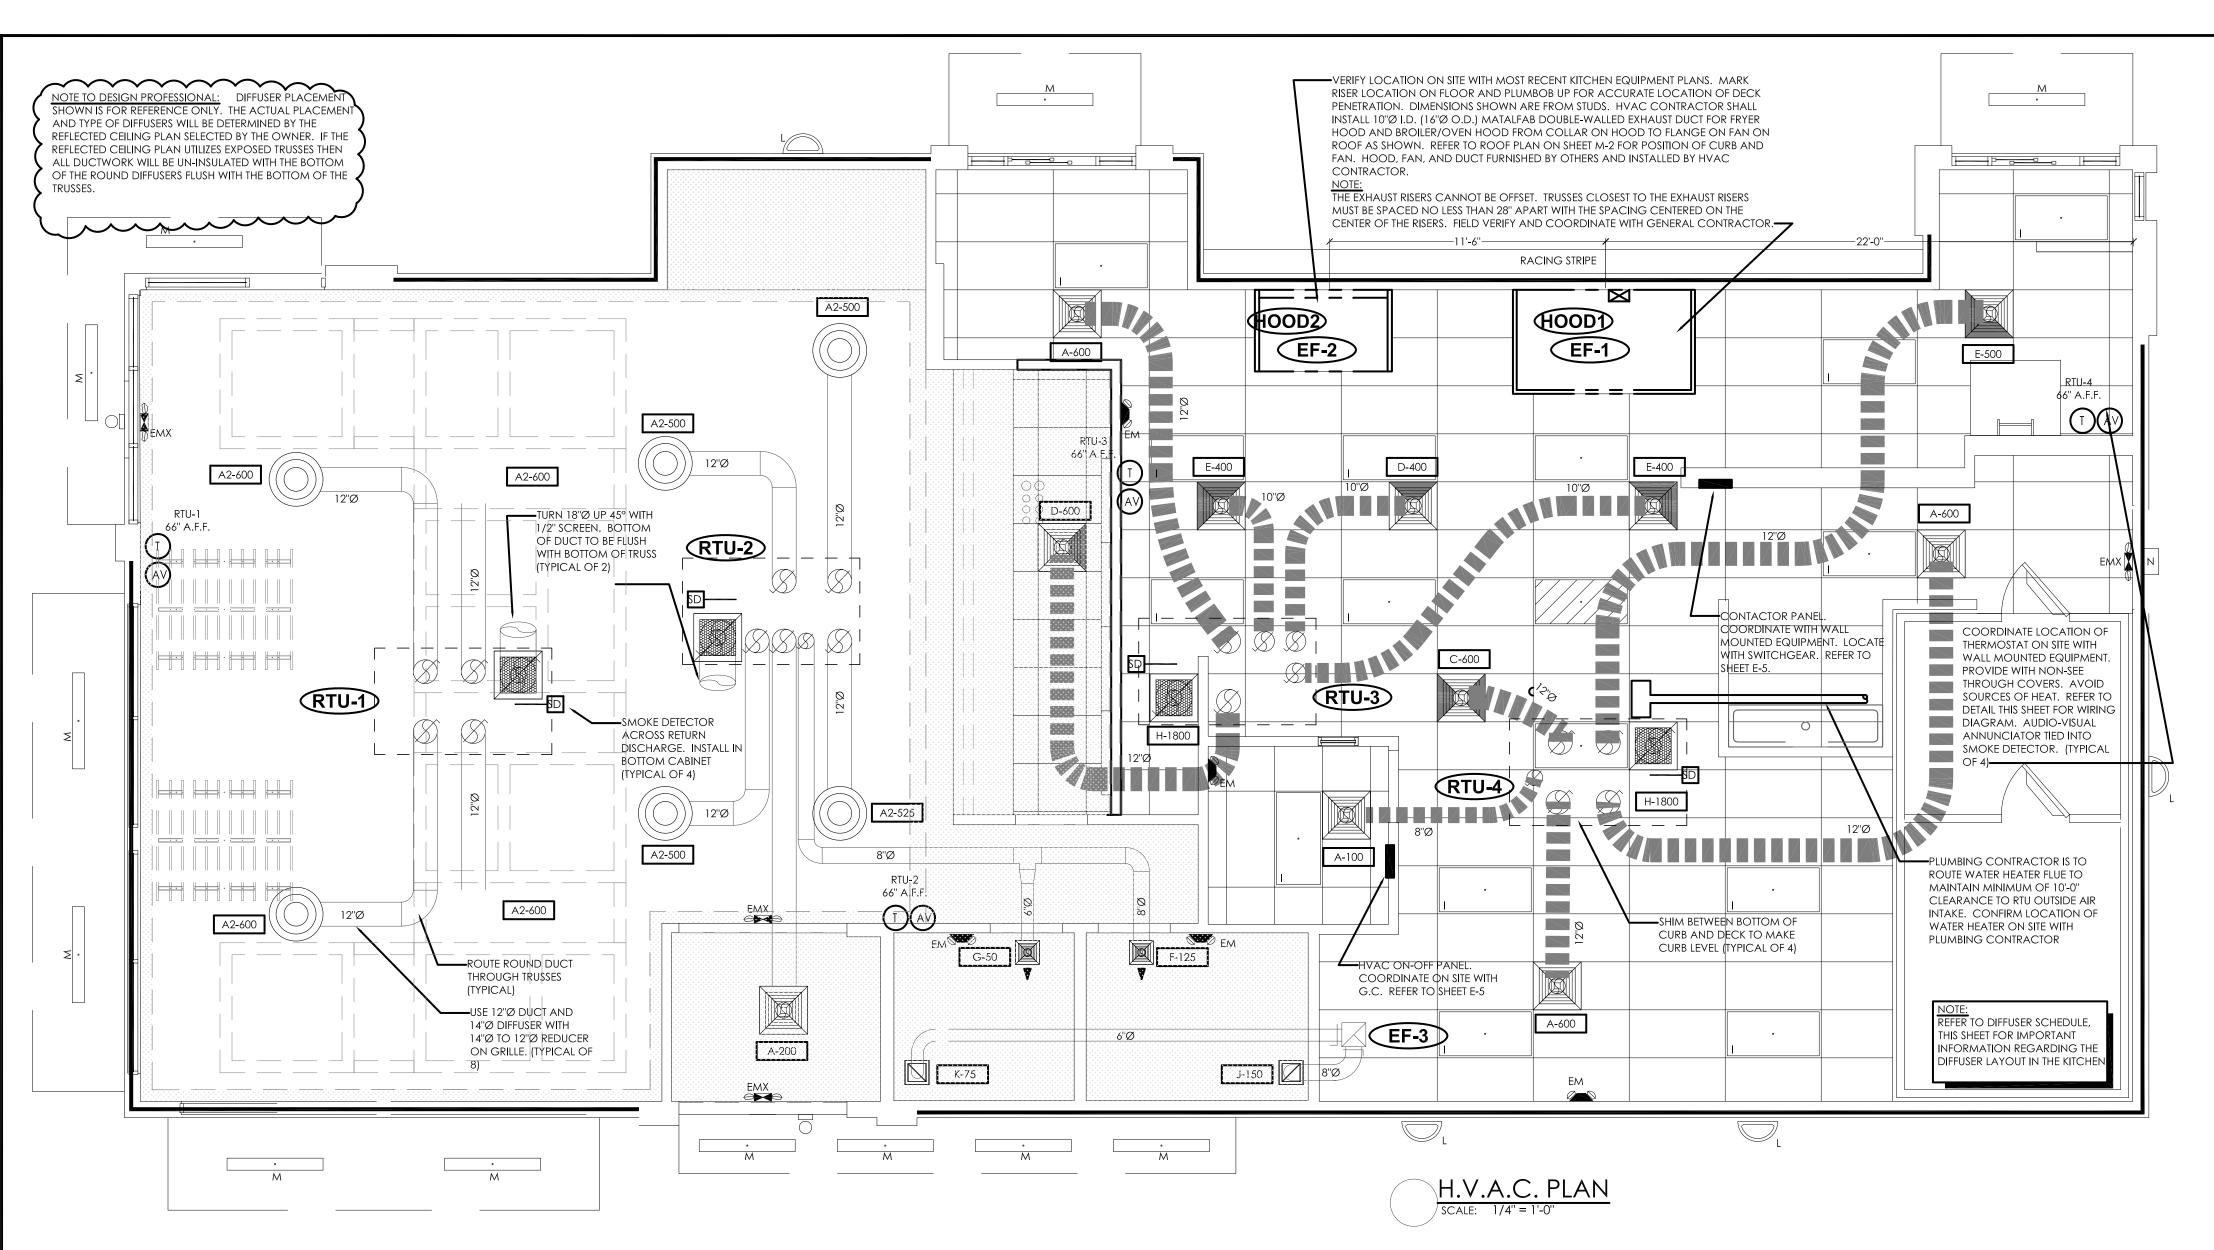1. CAREFULLY LOCATE AND MARK ROOF CURB LOCATIONS SO THAT DUCT WORK CAN BE INSTALLED IN THE APPROXIMATE LOCATIONS AS SHOWN BY THE FLOOR PLAN. PAY ATTENTION TO THE LOCATION OF THE ROOF STRUCTURE IN ORDER TO ACCOMMODATE THE DUCT DROPS.

2. MARK THE EXACT LOCATION OF EACH ROOF CURB. LAY OUT ALL EQUIPMENT LOCATIONS IN ORDER TO MAINTAIN PROPER CLEARANCES FROM EXHAUST FANS AND VENTS AS WELL AS PROVIDING FOR PROPER SERVICE CLEARANCES 3. GENERAL CONTRACTOR SHALL CUT ROOF DECKING MATERIAL TAKING CARE TO AVOID CUTTING ANY STRUCTURAL COMPONENTS. GENERAL CONTRACTOR SHALL ALSO INSTALL ANY NECESSARY FRAMING OR BLOCKING AT OPENINGS. 4. WITH ROOF CURB UPSIDE DOWN (SOLID METAL BOTTOM UP) MEASURE AND MARK THE LOCATION OF ANY JOISTS OR

OTHER FRAMING MEMBERS THAT MUST BE AVOIDED. MEASURE AND MARK THE LOCATION OF ALL THE DUCT TAPS. 5. CUT ALL DUCT TAPS INTO THE BOTTOM PANEL OF THE ROOF CURB. BE CAREFUL NOT TO DAMAGE THE ROOFING SURFACE WHILE MAKING THESE CUTS.

6. INSTALL DUCT TAP FITTINGS AND MANUAL DAMPERS INTO THE OPENINGS PREVIOUSLY CUT. SEAL ALL CONNECTIONS ON BOTH THE BOTTOM AND THE TOP SIDES OF THE TAPS. 7. FLATTEN TAB OF START COLLAR INSIDE CURB, TIGHT AGAINST INSULATION. SEAL INSIDE OF COLLAR AND TABS TO

INSULATION USING MASTIC DUCT SEALER. ALLOW SEALER TO DRY PRIOR TO PROCEEDING. 8. APPLY DUCT SEALER TO OPEN END OF COLLAR. SLIDE INNER CORE OF FLEXIBLE DUCT ONTO COLLAR, AND CONNECT PANDUIT STRAP PER MANUFACTURERS INSTRUCTIONS.

Pressure-sensitive foil tape. Do not use tape meant for rigid ductboard. Squeegee out all air bubbles for 10. TURN CURB RIGHT SIDE UP, LEVEL CURB BETWEEN BOTTOM OF CURB AND DECK, INSTALL IN ROOF OPENING. SECURE

9. SLIDE OUTER INSULATION SLEEVE OF FLEX TIGHT TO BOTTOM OF CURB. SEAL INSULATION TO BOTTOM OF CURB WITH

CURB TO ROOF FRAMING AS REQUIRED. 11. GENERAL CONTRACTOR OR ROOFING CONTRACTOR SHALL FLASH AND ROOF IN THE CURB AS DETAILED ON THE

12. INSIDE BUILDING, THE DUCT RUNS SHALL BE INSTALLED FROM THE TAPS TO THE DIFFUSER LOCATIONS AS SHOWN ON THE PLANS. SUPPORT PER SMACNA AND LOCAL CODES.

13. NOTE: IF NECESSARY, FLEX DROPS MAY BE CONNECTED TO TAPS AFTER CURB HAS BEEN INSTALLED. REFER TO STEPS #8

		AIR I	BALANCE	SCHEDUL	.E	
TAG	SUPPLY AIR	OUTSIDE AIR	RETURN AIR	EXHAUST AIR	BLDG. PRESSURE	% OUTSIDE AIR
RTU-1	2400 CFM	600 CFM	1800 CFM		+ 600 CFM	25
RTU-2	2400 CFM	600 CFM	1800 CFM		+ 600 CFM	25
RTU-3	2400 CFM	600 CFM	1800 CFM		+ 600 CFM	25
RTU-4	2400 CFM	600 CFM	1800 CFM		+ 600 CFM	25
EF-1				1100 CFM*	- 1100 CFM	+
EF-2	_			800 CFM*	- 800 CFM	<u></u>
EF-3	_			225 CFM	- 225 CFM	
TOTAL	9600 CEM	2400 CEM	7200 CEM	2125 CEAA	+ 275 CEM	25

*NOTE: UPON START-UP VERIFY THAT THE EXHAUST FAN CURRENT SENSOR IS SET TO THE MOTOR AMPERAGE. IF IT IS NECESSARY TO ADJUST THE AMPERAGE OF THE EXHAUST HOOD FAN MOTOR. THE FAN MOTOR CURRENT SENSOR MUST BE RESET BY THE ELECTRICAL CONTRACTOR AS FOLLOWS: ADJUST UNDERCURRENT POTENTIOMETER TO MINIMUM (CLOCKWISE IS MAXIMUM.) APPLY CURRENT. ONCE CURRENT IS STABILIZED, INCREASE UNDERCURRENT POT UNTIL RED LED LIGHTS. WITHIN SEVEN SECONDS TURN DOWN UNTIL RED LIGHT TURNS OFF. IF A LIGHT REMAINS ON FOR MORE THAN TEN SECONDS, DISCONNECT SUPPLY VOLTAGE o reset. See manufacturers operation-installation instructions that ship with the fan. With Limited Building RESSURE, THE ±10% TOLERANCE IS NOT ACCEPTABLE. SET CFM AS SPECIFIED. ENSURE THAT EXHAUST FAN PULLEY IS ADJUSTED FOR PROPER ALIGNMENT.

		AIR DI	EVICE S	CHEDU	LE			
SYM.	SIZE	TYPE	DUCT SIZE	MODEL#	FINISH	BOOT SIZE	OPENING SIZE	QT`
A*	24X24	SUPPLY 4 WAY	12''Ø	NCA12	WHITE	12''Ø	T-BAR	5
A2**	26''Ø	Supply round	12''Ø*	PARCD-14	WHITE		_	8
В*	24X24	SUPPLY 3 WAY	12''Ø	NCA12-3	WHITE	12''Ø	T-BAR	0
C*	24X24	SUPPLY 2 WAY (PARALLEL)	12''Ø	NCA12-2P	WHITE	12''Ø	T-BAR	1
D*	24X24	SUPPLY 3 WAY	10''Ø	NCA12-2C	WHITE	10''Ø	T-BAR	2
E*	24X24	SUPPLY 2 WAY (CORNER)	10''Ø	NCA10-3	WHITE	12''Ø	T-BAR	3
F	12X12	SUPPLY 1 WAY W/O.B.D.	8''Ø	630	WHITE	12X12	SIZE + 1/4"	1
G	12X12	SUPPLY 1 WAY W/O.B.D.	6''Ø	630	WHITE	12X12	SIZE + 1/4"	1
Н	24X24	RETURN	18''Ø	630TB	WHITE	22X22	T-BAR	4
J	12X12	EXHAUST	8''Ø	630	WHITE	12X12	SIZE + 1/4"	1
K	12X12	EXHAUST	8''Ø	630	WHITE	12X12	SIZE + 1/4"	1

NOTE: LOCATION AND ORIENTATION OF DIRECTIONAL BLOW PATTERN DIFFUSERS IN THE KITCHEN IS CRITICAL. INSTALLER WILL ENSURE PROPER INSTALLATION OF DIFFUSERS. CONTACT THE NCA CONSULTANTS PROJECT COORDINATOR IMMEDIATELY WITH ANY CONFLICTS THAT PREVENT INSTALLATION PER THE PROPOSED DESIGN.

TAG	RTU-1, 2, 3, 4		
MANUFACTURER	TRANE		
MODEL	YSC072A3EMA (6 TON)		
LOCATION, CURB DIMENSIONS	ROOF, 80" X 46"		
TYPE OF HEAT	NATURAL GAS		
TOTAL COOLING CAPACITY, MBTU/HR	75.0		
SENSIBLE COOLING CAPACITY, MBTU/HR	53.2		
ENTERING AIR CONDITIONS, DB°F/WB°F	80/67		
AMBIENT AIR DB TEMPERATURE, °F	95		
SUPPLY AIR, CFM	2400		
OUTSIDE AIR, CFM	SEE SCHEDULE		
EXTERNAL STATIC PRESSURE, "WG	0.75		
BHP - MEDIUM STATIC MOTOR	2.2		
E.E.R.	11.2		
GAS INPUT MBTU/HR	105/150		
GAS OUTPUT MBTU/HR	84/120		
UNIT WEIGHT, LBS.	950		
ELECTRICAL REQUIREMENT, V/PHASE/HZ	208-230/3/60		
MINIMUM CIRCUIT AMPERAGE	36.5		
MAXIMUM OVER CURRENT PROTECTION	50		

NOTE: COORDINATE RTU PLACEMENT ON SITE PRIOR TO SETTING EQUIPMENT. IF ADJUSTMENT IS NECESSARY

. 100% ECONOMISER WITH BAROMETRIC RELIEF

MAINTAIN FRESH AIR INTAKE CLEARANCES

3. ONE YEAR COMPLETE PARTS AND LABOR WARRANTY

5. SMOKE DETECTOR (SEE HVAC ROOF PLAN, SHEET M-2)

2. NCA PLENUMIZED CURB. TO ORDER CALL TOLL-FREE (877) 530-0078.

6. AQUAGUARD AG-3180E MOISTURE SENSOR FOR PRIMARY PAN

4. ADDITIONAL FOUR YEAR PARTS WARRANTY COVERING COMPRESSORS

TAG	EF-1	EF-2	EF-3
MANUFACTURER	COOK	СООК	COOK
MODEL	120 CPS-BK	100 CPS-BK	100C10DH
LOCATION	ROOF	ROOF	ROOF
AREA SERVED	BROILER	FRYERS	RESTROOM
CFM	1100*	800*	225
STATIC PRESSURE, "WG	1.85"	2.5"	0.25
FAN HORSEPOWER	1.0	1.0	1/25
FAN RPM	1957	2675	911
DRIVE	BELT	BELT	DIRECT
ELECTRICAL REQUIREMENT, V/Ø/HZ	208-230/1/60	208-230/1/60	120/1/60
ROOF OPENING, INCHES	22X22	22X22	13.5X13.5
ROOF CURB	YES	YES	YES
BACKDRAFT DAMPER	NO	NO	YES
BIRDSCREEN	NO	NO	YES
GREASE TROUGH	YES	YES	NO
INTERLOCK	YES	YES	NO

BURGER KING CORPORATION HAS A NATIONAL ACCOUNT AGREEMENT WITH THE NCA GROUP. NCA SHALL VISIT THE SITE, AS AUTHORIZED, TO VERIFY ALL MATERIALS, EQUIPMENT, AND INSTALLATION ARE PER THE PROFESSIONAL ENGINEER SEAL. PLANS ARE NCA DESIGN COPYRIGHT 2018.

FOR COMPLETE INFORMATION AND PRICING ON THE FOLLOWING PACKAGE OF EQUIPMENT AND ACCESSORIES

ON THESE PLANS.

INCLUDES ALL FANS WITH ALL ACCESSORIES AS SPECIFIED ON THESE PLANS.

INCLUDES ALL GRILLES, REGISTERS AND DIFFUSERS PER PLANS. SQUARE TO ROUND TRANSITIONS PROVIDED WHERE REQUIRED.

INCLUDES ONE-PIECE, FULLY WELDED NCA PLENUMIZED ROOF CURBS FOR ALL ROOF MOUNTED HEATING/COOLING EQUIPMENT, AND ALL FAN CURBS. ALTERNATIVES TO NCA PLENUMIZED CURBS MAY NOT BE

EXHAUST HOOD PACKAGE

INCLUDES EXHAUST FANS, HOODS, SHROUDS AND ANSUL SYSTEM, AS CODE REQUIRES.

NOTE: "RE-ENGINEERING" DEVIATIONS FROM THE SHOWN DESIGN AND REQUIRED HVAC EQUIPMENT MUST BE APPROVED IN ADVANCE BY THE ARCHITECT AND PROFESSIONAL ENGINEER. UNAUTHORIZED SUBSTITUTIONS OR alterations will void the signature and seal of the professional engineer and leave violators RESPONSIBLE FOR RESUBMISSION OF SIGNED AND SEALED DRAWINGS

FAN SCHEDULE					
TAG	EF-1	EF-2	EF-3		
MANUFACTURER	COOK	COOK	COOK		
MODEL	120 CPS-BK	100 CPS-BK	100C10DH		
LOCATION	ROOF	ROOF	ROOF		
AREA SERVED	BROILER	FRYERS	RESTROOM		
CFM	1100*	800*	225		
STATIC PRESSURE, "WG	1.85"	2.5"	0.25		
fan horsepower	1.0	1.0	1/25		
FAN RPM	1957	2675	911		
DRIVE	BELT	BELT	DIRECT		
ELECTRICAL REQUIREMENT, V/Ø/HZ	208-230/1/60	208-230/1/60	120/1/60		
ROOF OPENING, INCHES	22X22	22X22	13.5X13.5		
ROOF CURB	YES	YES	YES		
BACKDRAFT DAMPER	NO	NO	YES		
BIRDSCREEN	NO	NO	YES		
GREASE TROUGH	YES	YES	NO		
INTERLOCK	YES	YES	NO		

NCA HVAC EQUIPMENT PACKAGE

PLAN AND SPECIFICATIONS AS PER P.E. SEAL

CONTACT THE NCA GROUP MARKETING DEPARTMENT TOLL-FREE AT (877) 530-0078.

HEATING COOLING EQUIPMENT PACKAGE INCLUDES ALL ROOFTOP (OR SPLIT SYSTEM) AIR CONDITIONING EQUIPMENT WITH ALL ACCESSORIES AS SPECIFIED

INCLUDES PRESET DIGITAL THERMOSTATS, THERMOSTAT WIRE, LOCKING COVERS, AND AS CODE REQUIRES SMOKE DETECTORS AND AUDIBLE-VISUAL DEVICES; OCCUPIED/UNOCCUPIED PANEL, AND INTERLOCK PANEL, IF REQUIRED.



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ATTENTION GENERAL CONTRACTOR: "RE-ENGINEERING" DEVIATIONS FROM THE SHOWN DESIGN AND REQUIRED HVAC EQUIPMENT MUST BE APPROVED IN ADVANCE BY THE ARCHITECT AND PROFESSIONAL ENGINEER. UNAUTHORIZED SUBSTITUTIONS OR ALTERATIONS WILL VOID THE SIGNATURE AND SEAL OF THE PROFESSIONAL ENGINEER AND LEAVE VIOLATORS RESPONSIBLE FOR RESUBMISSION OF SIGNED AND

CONTRACTORS NOTES

1. THE HVAC CONTRACTOR SHALL FURNISH AND INSTALL THE HVAC SYSTEM AS SHOWN IN THE NCA HVAC EQUIPMENT PACKAGE NOTE, THIS SHEET. ALL FANS SHALL BE U.L. LISTED.

2. THE HVAC CONTRACTOR SHALL INSTALL THE EXHAUST HOOD. REFER TO MOST RECENT KITCHEN PLANS ON SITE. HOOD EXHAUST DUCT IS FACTORY-MANUFACTURED, NON-WELD, DOUBLE-WALLED DUCT WITH ZERO-CLEARANCE TO COMBUSTIBLES RATING. MANUFACTURED BY METAL-FAB. INSTALL ALL HOOD EXHAUST DUCT PER MANUFACTURERS PUBLISHED REQUIREMENTS THAT SHIP WITH THE DUCTWORK. VERIFY LOCATION ON SITE WITH MOST RECENT KITCHEN EQUIPMENT PLAN.

3. ALL AIR CONDITIONING UNIT CURBS SHALL BE SUPPLIED BY NCA CONSULTANTS.

WELDED SEAMS, WATER TIGHT AND INTERNALLY INSULATED.

5. SHIMS SHALL BE PROVIDED BY HVAC CONTRACTOR BETWEEN THE ROOF DECK AND THE CURB AS NEEDED TO COMPENSATE FOR

4. ALL AIR CONDITIONING UNIT CURBS SHALL BE FABRICATED BY NCA CONSULTANTS FROM 18 GA. GALVANIZED METAL WITH

6. ALL FLEX DUCT SHALL BE FOIL-BACKED, R-6, U.L. LISTED, CLASSIFIED AS A CLASS 1 AIR DUCT, AND MEET LOCAL CODE 7. EXCLUDING ANY EXPOSED DUCTWORK, ALL NON-FLEXIBLE DUCT AND ALL AIR DISTRIBUTION DEVICES SHALL BE INSULATED WITH

R-6, 2" X .75 DENSITY FOIL-BACKED INSULATION, WITH FIRE AND SMOKE RATING [25]-[50]. 8. ALL DUCTWORK SHALL BE INDEPENDENTLY HUNG FROM STRUCTURAL MEMBERS.

9. ALL DUCTWORK SHALL BE FABRICATED AND INSTALLED PER SMACNA LOW-VELOCITY DUCT MANUAL (LATEST ISSUE).

10. UNLESS OTHERWISE NOTED, EVERY SUPPLY TAP COLLAR SHALL HAVE A LOCKING MANUAL VOLUME DAMPER.

11. THE HVAC CONTRACTOR SHALL COORDINATE DIFFUSER LOCATIONS ON SITE WITH THE MOST RECENT REFLECTED CEILING PLAN. 12. The HVAC CONTRACTOR SHALL FURNISH A WRITTEN GUARANTEE COVERING A ONE-YEAR PERIOD FOR ALL EQUIPMENT AND AN ADDITIONAL FOUR-YEAR PERIOD FOR THE COMPRESSORS IN THE AIR CONDITIONING UNITS.

13. UPON COMPLETION OF PROJECT THE HVAC CONTRACTOR SHALL HIRE AN A.A.B.C. OR N.E.B.B. CERTIFIED, INDEPENDENT TEST AND BALANCE COMPANY TO CONDUCT A COMPLETE, CERTIFIED TEST AND BALANCE OF ALL HVAC EQUIPMENT. PROVIDE A WRITTEN REPORT TO NCA CONSULTANTS. ALL CAPACITIES MUST BE SET TO AMOUNTS INDICATED ON THE FLOOR PLANS AND

14. THE HVAC CONTRACTOR SHALL VERIFY LOCATIONS OF THE EXHAUST HOOD AND EF-1 FROM MOST RECENT KITCHEN EQUIPMENT PLANS ON SITE. THIS IS TO ENSURE NO OFFSETS IN EXHAUST DUCTWORK.

15. HVAC CONTRACTOR IS TO MAKE ALL LOW-VOLTAGE WIRING FINAL CONNECTIONS FOR ALL HVAC EQUIPMENT INCLUDING SENSORS, THERMOSTATS, AUDIO-VISUAL ANNUNCIATORS, ROOF-TOP UNITS, SMOKE DETECTORS, CONTACTOR PANEL, AND CONTROL PANEL

1. IT IS THE RESPONSIBILITY OF THE GENERAL CONTRACTOR TO RECEIVE, OFFLOAD, AND STORE ALL HVAC MATERIALS WHICH ARRIVE AT THE JOB SITE. JOINT EFFORT BETWEEN G.C. AND M.C. SHALL BE UNDERTAKEN TO POSITION HOODS IN THE KITCHEN, FOR

2. IT IS VERY IMPORTANT THAT ACCURATE MEASUREMENTS ARE USED WHEN LOCATING EXHAUST FAN ROOF OPENING TO ENSURE THAT NO OFFSETS ARE REQUIRED IN THE EXHAUST DUCTWORK FROM THE KITCHEN HOOD. COORDINATE ROOF OPENINGS WITH THE KITCHEN EQUIPMENT PLAN AND EXHAUST HOOD PLANS. OBTAIN THE CORRECT PLANS FROM THE KITCHEN EQUIPMENT SUPPLIER.

3. RTU ROOF OPENING SIZES AND ROOF CURBS ARE BASED ON EQUIPMENT SHOWN. IF OTHER EQUIPMENT IS USED, VERIFY ROOF OPENING REQUIREMENTS. MAKE PENETRATION AS NEEDED FOR INSTALLATION OF NEW CURB AND RTU. COORDINATE ON SITE WITH HVAC CONTRACTOR. ENSURE THAT ROOFING MATERIAL DOES NOT COVER THE TOP OF ANY HVAC EQUIPMENT CURB.

4. ANY FRAMING REQUIRED FOR HVAC WORK SHALL BE BY THE GENERAL CONTRACTOR.

5. GENERAL CONTRACTOR IS TO PROVIDE ANY SCREENING, GUARD RAILS, ETC. FOR ROOF-MOUNTED HVAC EQUIPMENT PER IBC AND LOCAL CODES. 6. ANY EXPOSED HVAC WORK IN THE DINING ROOM IS TO BE PREPARED, PRIMED, AND PAINTED BY THE GENERAL CONTRACTOR.

7. NOTE: EXCLUDING THE DUCT THAT SHIPS WITH THE HOODS, THE EXHAUST RISERS CANNOT HAVE ADDITIONAL, 'FIELD' OFFSETS, TRUSSES CLOSEST TO THE EXHAUST RISERS MUST BE SPACED SO THAT NO ADDITIONAL OFFSETS ARE NEEDED. FIELD VERIFY AND COORDINATE WITH GENERAL CONTRACTOR.

ELECTRICAL CONTRACTOR 1. THE ELECTRICAL CONTRACTOR SHALL FURNISH AND INSTALL PITCH POCKETS FOR POWER AND CONTROL WIRING TO MAINTAIN 12" MINIMUM CLEARANCE FROM BACK PANEL OF AIR CONDITIONING UNITS AND EXHAUST FANS. ELECTRICAL CONTRACTOR SHALL NOT PENETRATE BOTTOM OF RTU CURB AND EXHAUST FANS.

2. THE ELECTRICAL CONTRACTOR SHALL INSTALL THE CONTACTOR PANEL, ON-OFF PANEL, AND LOW-VOLTAGE CONTROL WIRING FOR ALL AIR CONDITIONING UNITS AND CONTROLS. COORDINATE AIR CONDITIONING AND ELECTRICAL PLANS. REFER TO SHEET E-5 FOR PANEL INFORMATION. FOR PROJECTS WITHOUT A PANEL THE ELECTRICAL CONTRACTOR WILL INTERLOCK THE COOKING APPLIANCE AND HVAC EQUIPMENT PER NFPA96.

3. THE ELECTRICAL CONTRACTOR SHALL FURNISH AND INSTALL DISCONNECTS FOR ALL HVAC EQUIPMENT.

4. THE ELECTRICAL CONTRACTOR SHALL USE A MINIMUM OF 4'-6" SEALTITE FLEXIBLE CONDUIT WHEN WIRING KITCHEN HOOD EXHAUST FANS ON ROOF SO THAT FANS MAY BE REMOVED FROM CURBS AND PLACED ON ROOF FOR CLEANING EXHAUST DUCTWORK.

5. THE ELECTRICAL CONTRACTOR SHALL PROVIDE ANY ADDITIONAL INTERLOCK REQUIRED BY LOCAL CODE BETWEEN THE HVAC EQUIPMENT, SMOKE DETECTORS, EXHAUST FANS, AND COOKING APPLIANCES.

6. ELECTRICAL CONTRACTOR SHALL RUN LINE VOLTAGE FROM THE CURRENT SENSOR LOCATED IN THE GREASE EXHAUST FAN TO THE CONTACTOR PANEL LOCATED BY THE SWITCHGEAR.

7. FOR EACH UNIT, THE ELECTRICAL CONTRACTOR SHALL PROVIDE ONE SINGLE-GANG RECEPTACLE TEST STATION FOR THE REMOTE SENSOR, AND ONE DOUBLE-GANG RECEPTACLE TEST STATION FOR THE ANNUNCIATOR, WITH GREEN AND RED LIGHT INDICATORS. THE FIRE AND MECHANICAL INSPECTORS WILL DETERMINE SUITABLE LOCATION FOR TEST STATIONS. ANNUNCIATORS AND TEST STATION WILL BE LOOPED IN THE CIRCUITRY OF THE SMOKE DETECTION DEVICES. WIRING WILL BE INSTALLED BY ELECTRICAL CONTRACTOR. PROVIDE ADDITIONAL RECEPTACLES IN MANAGERS OFFICE FOR THERMOSTATS.

PLUMBING CONTRACTOR

1. THE PLUMBING CONTRACTOR IS TO PROVIDE AND INSTALL PITCH POCKETS FOR CONDENSATE DRAINS/GAS PIPING FOR ALL A/C UNITS AND EXHAUST FANS. PLUMBING CONTRACTOR SHALL NOT PENETRATE BOTTOM OF RTU CURB. 2. THE PLUMBING CONTRACTOR TO COORDINATE PLUMBING VENT STACKS WITH OUTSIDE AIR INTAKES OF A/C UNITS. MAINTAIN

10'-0" MINIMUM CLEARANCE OR PER LOCAL CODE.

3. THE PLUMBING CONTRACTOR SHALL PROVIDE AND INSTALL FLUE GAS EXHAUST VENT FOR WATER HEATER. MAINTAIN 10'-0" MINIMUM HORIZONTAL OR 3' VERTICAL CLEARANCE TO AIR INTAKES.


| UPON COMMENCEMENT OF ROUGH-IN AS SCHEDULED BY NCA CONSULTANTS, THE AIR CONDITIONING CONTRACTOR IS TO REMAIN ON THE JOB SITE FULL TIME UNTIL THE ROUGH-IN IS 100% COMPLETE. THE GENERAL

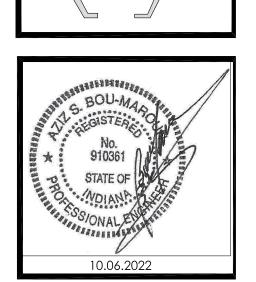CONTRACTOR'S SITE SUPERINTENDENT WILL VERIFY. UPON COMMENCEMENT OF TRIM-OUT AS SCHEDULED BY NCA CONSULTANTS, THE AIR CONDITIONING CONTRACTOR IS TO REMAIN ON THE JOB SITE FULL TIME UNTIL THE TRIM-OUT IS 100% COMPLETE. THE GENERAL CONTRACTOR'S SITE SUPERINTENDENT WILL VERIFY.

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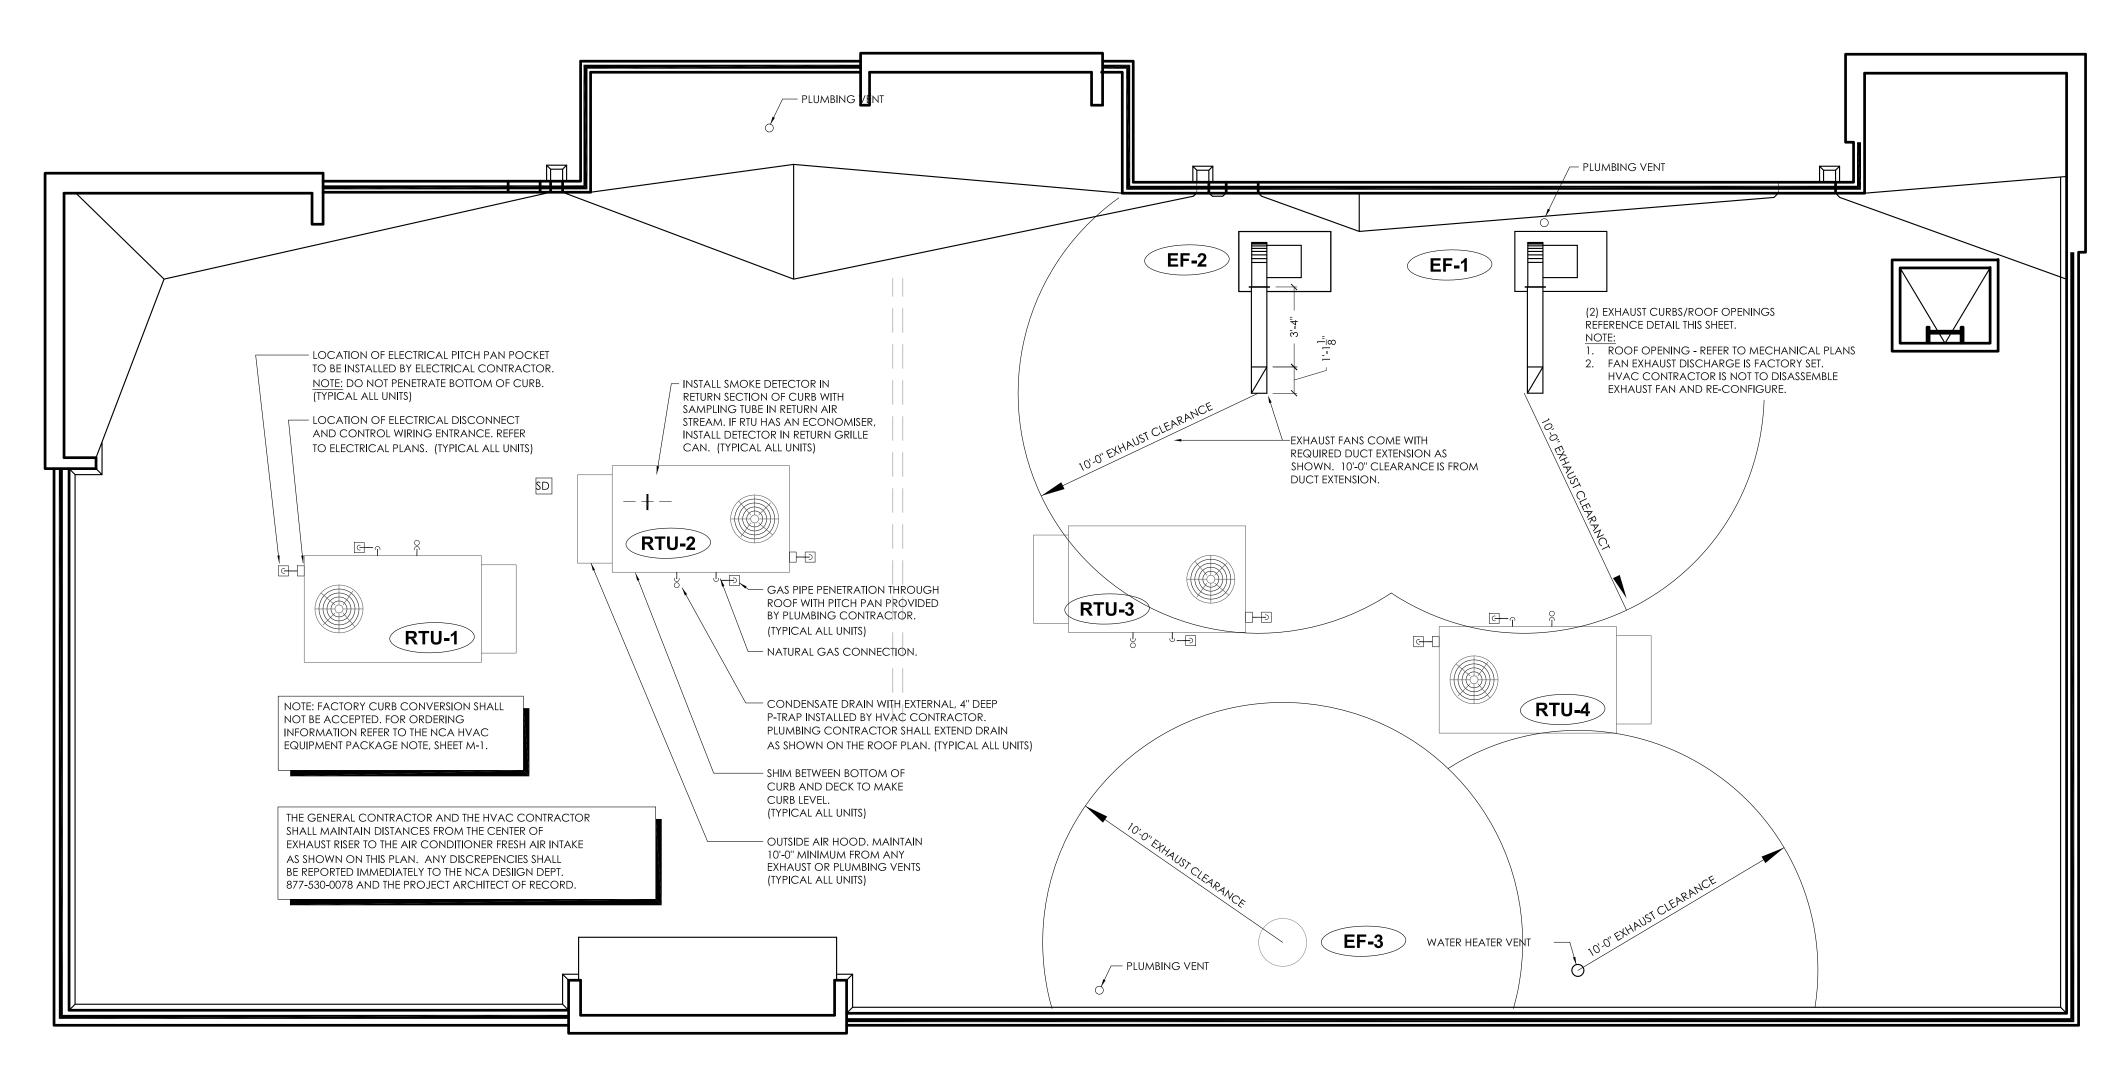
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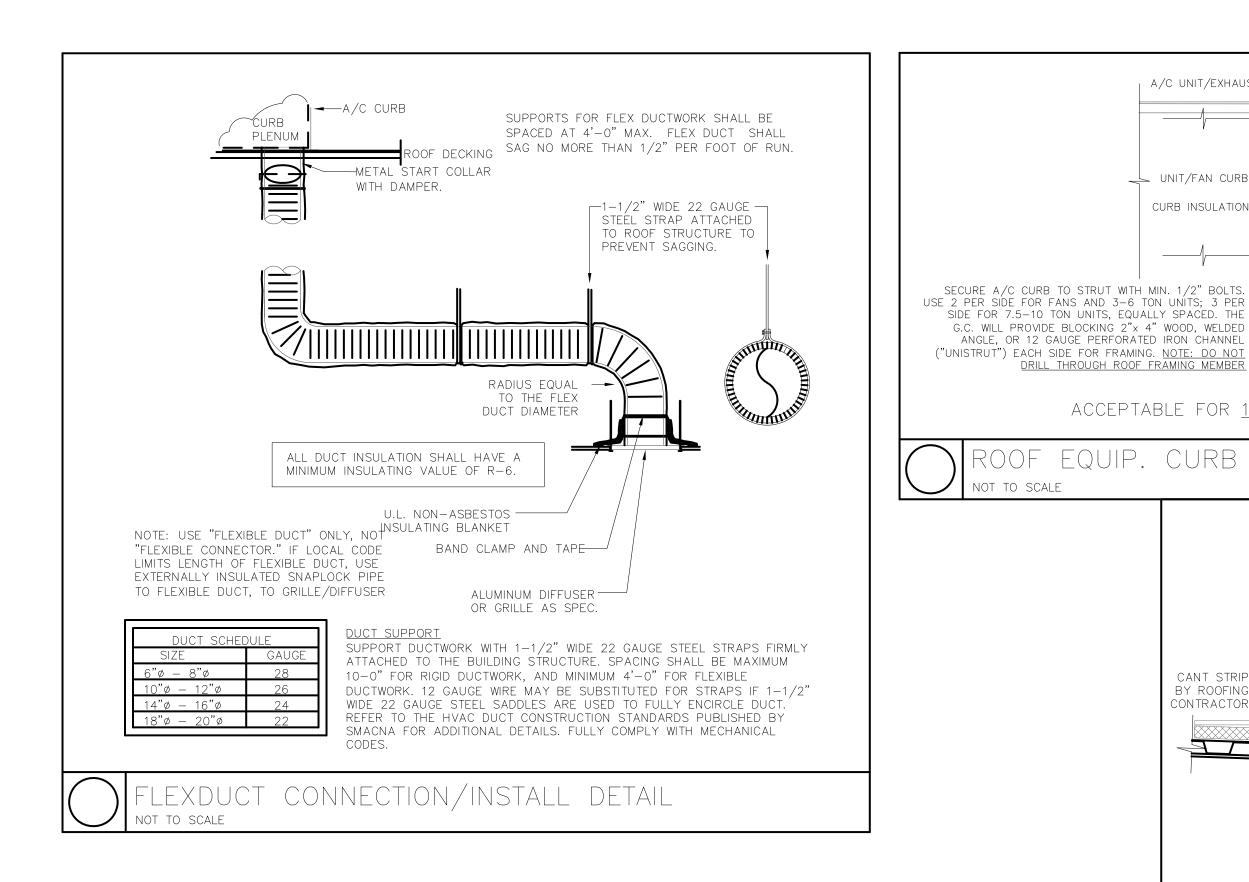
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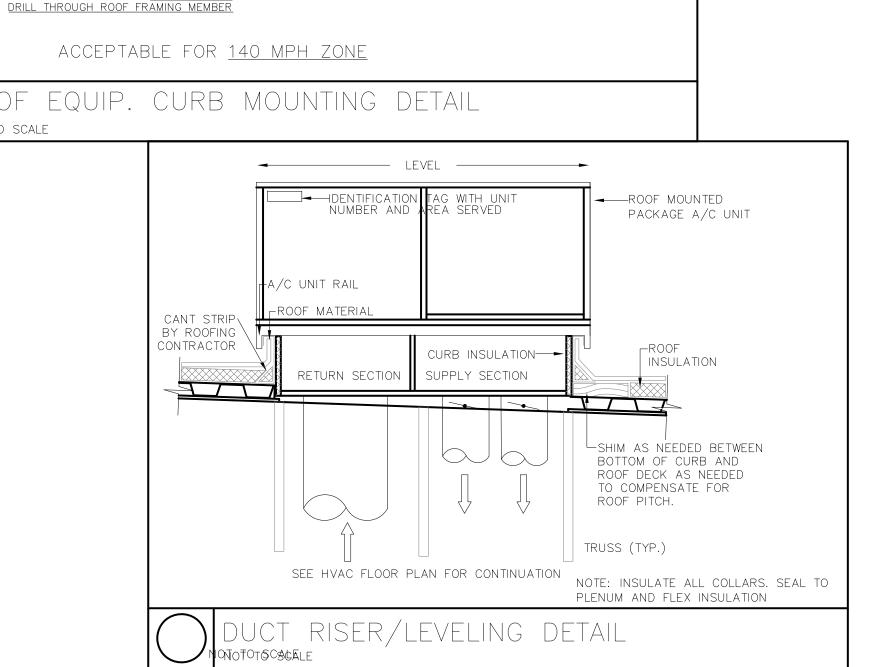


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H.V.A.C. ROOF PLAN SCALE: 1/4" = 1'-0"





A/C UNIT RAIL/EXHAUST FAN FLANGE

-DECK INSULATION

ROOFING MATERIAL

MECHANICAL FASTENER - FULL PERIMETER APPLY MIN. OF

-ROOF DECKING

ROOF STRUCTURE

ONE 6" #14 SCREWS NO MORE THAN 8" FROM EDGE AND NO MORE THAN 12" ON CENTER THROUGH CURB FLANGE.

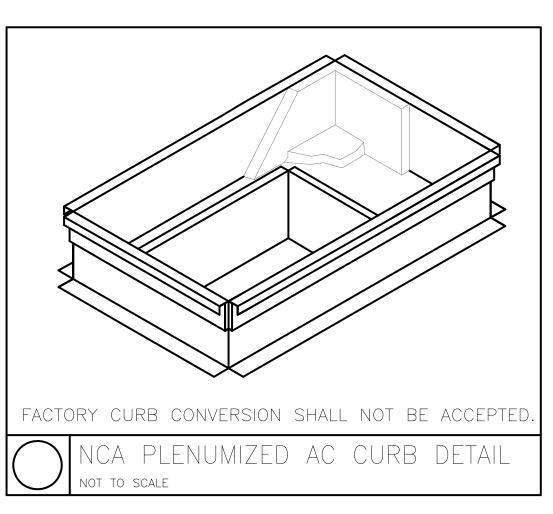
A/C UNIT/EXHAUST FAN

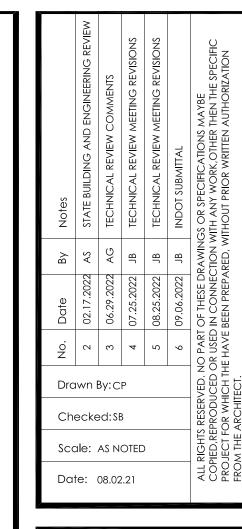
UNIT/FAN CURB -

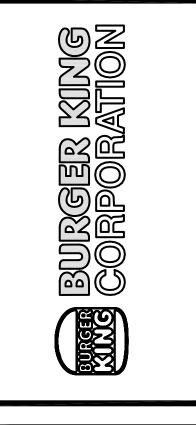
SECURE A/C CURB TO STRUT WITH MIN. 1/2" BOLTS.

SIDE FOR 7.5-10 TON UNITS, EQUALLY SPACED. THE G.C. WILL PROVIDE BLOCKING 2"x 4" WOOD, WELDED ANGLE, OR 12 GAUGE PERFORATED IRON CHANNEL ("UNISTRUT") EACH SIDE FOR FRAMING. NOTE: DO NOT

CURB INSULATION-

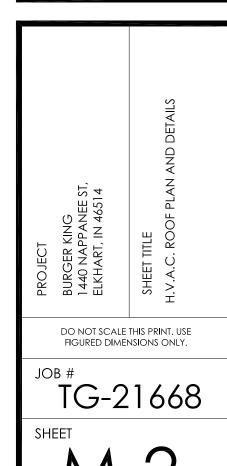


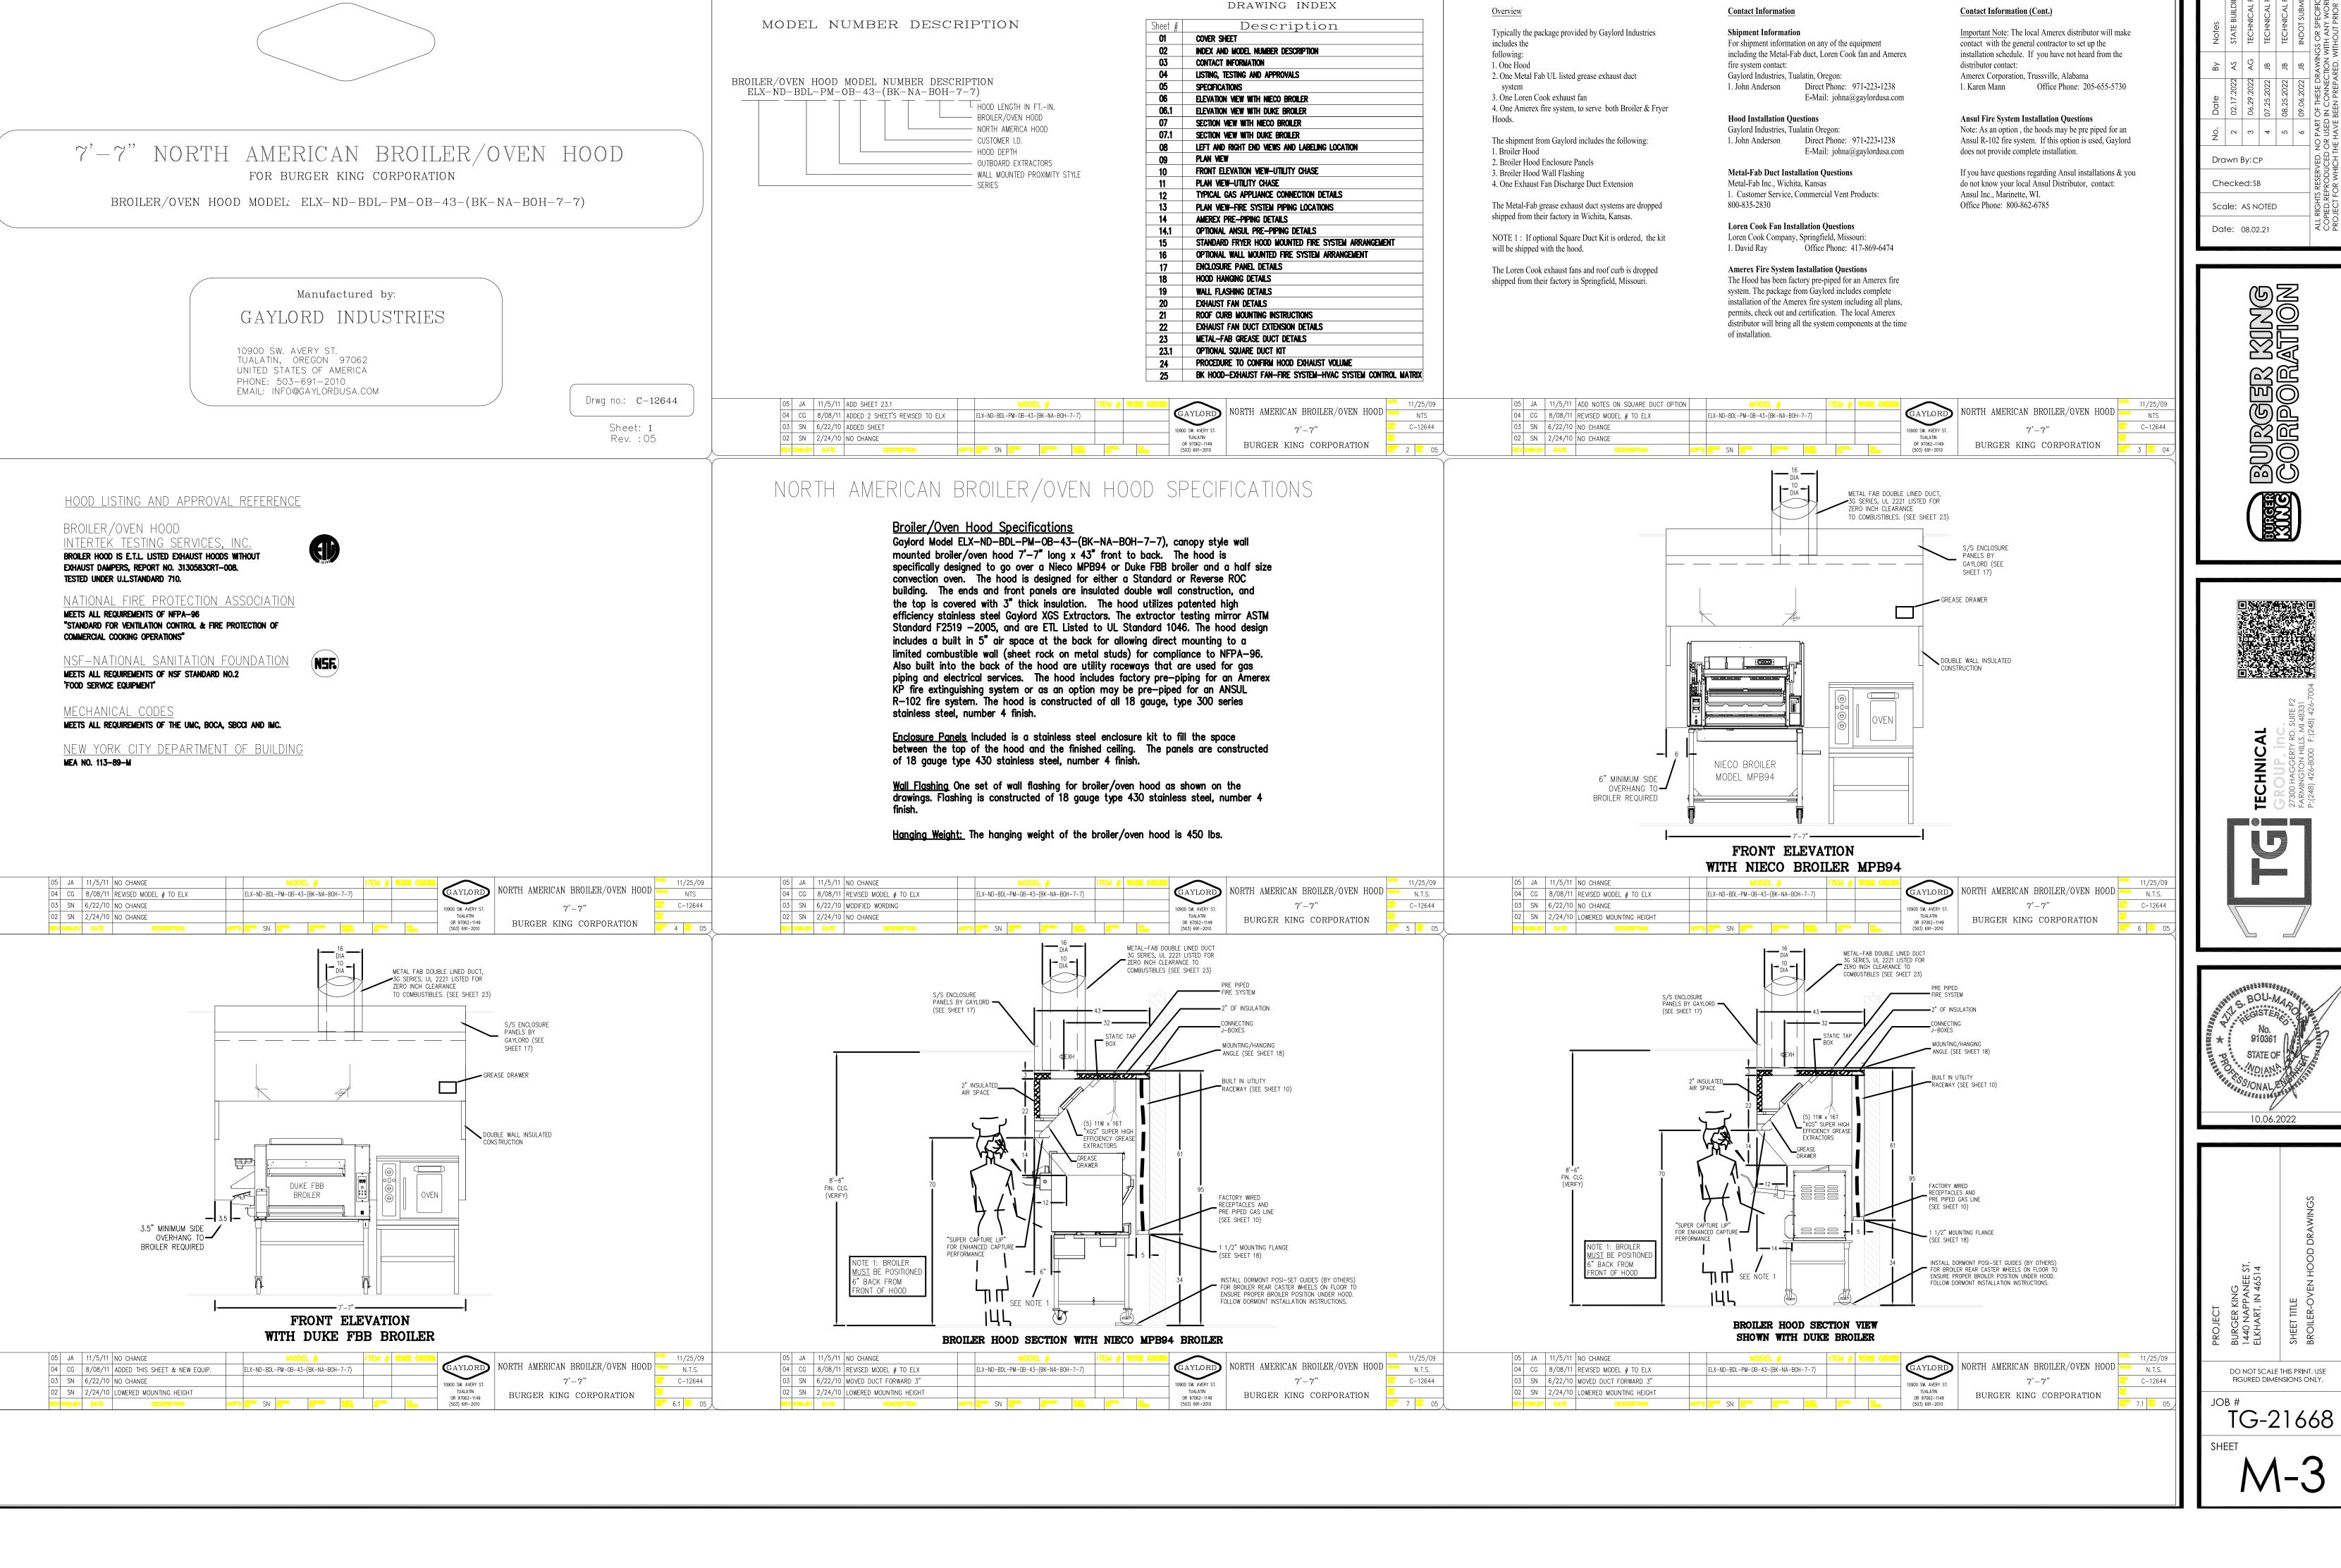















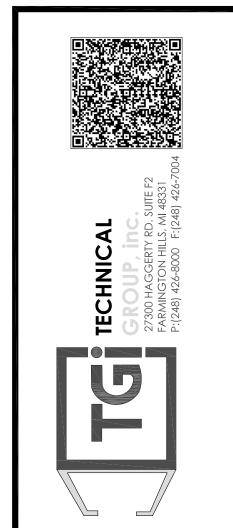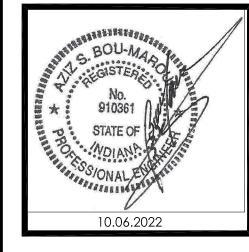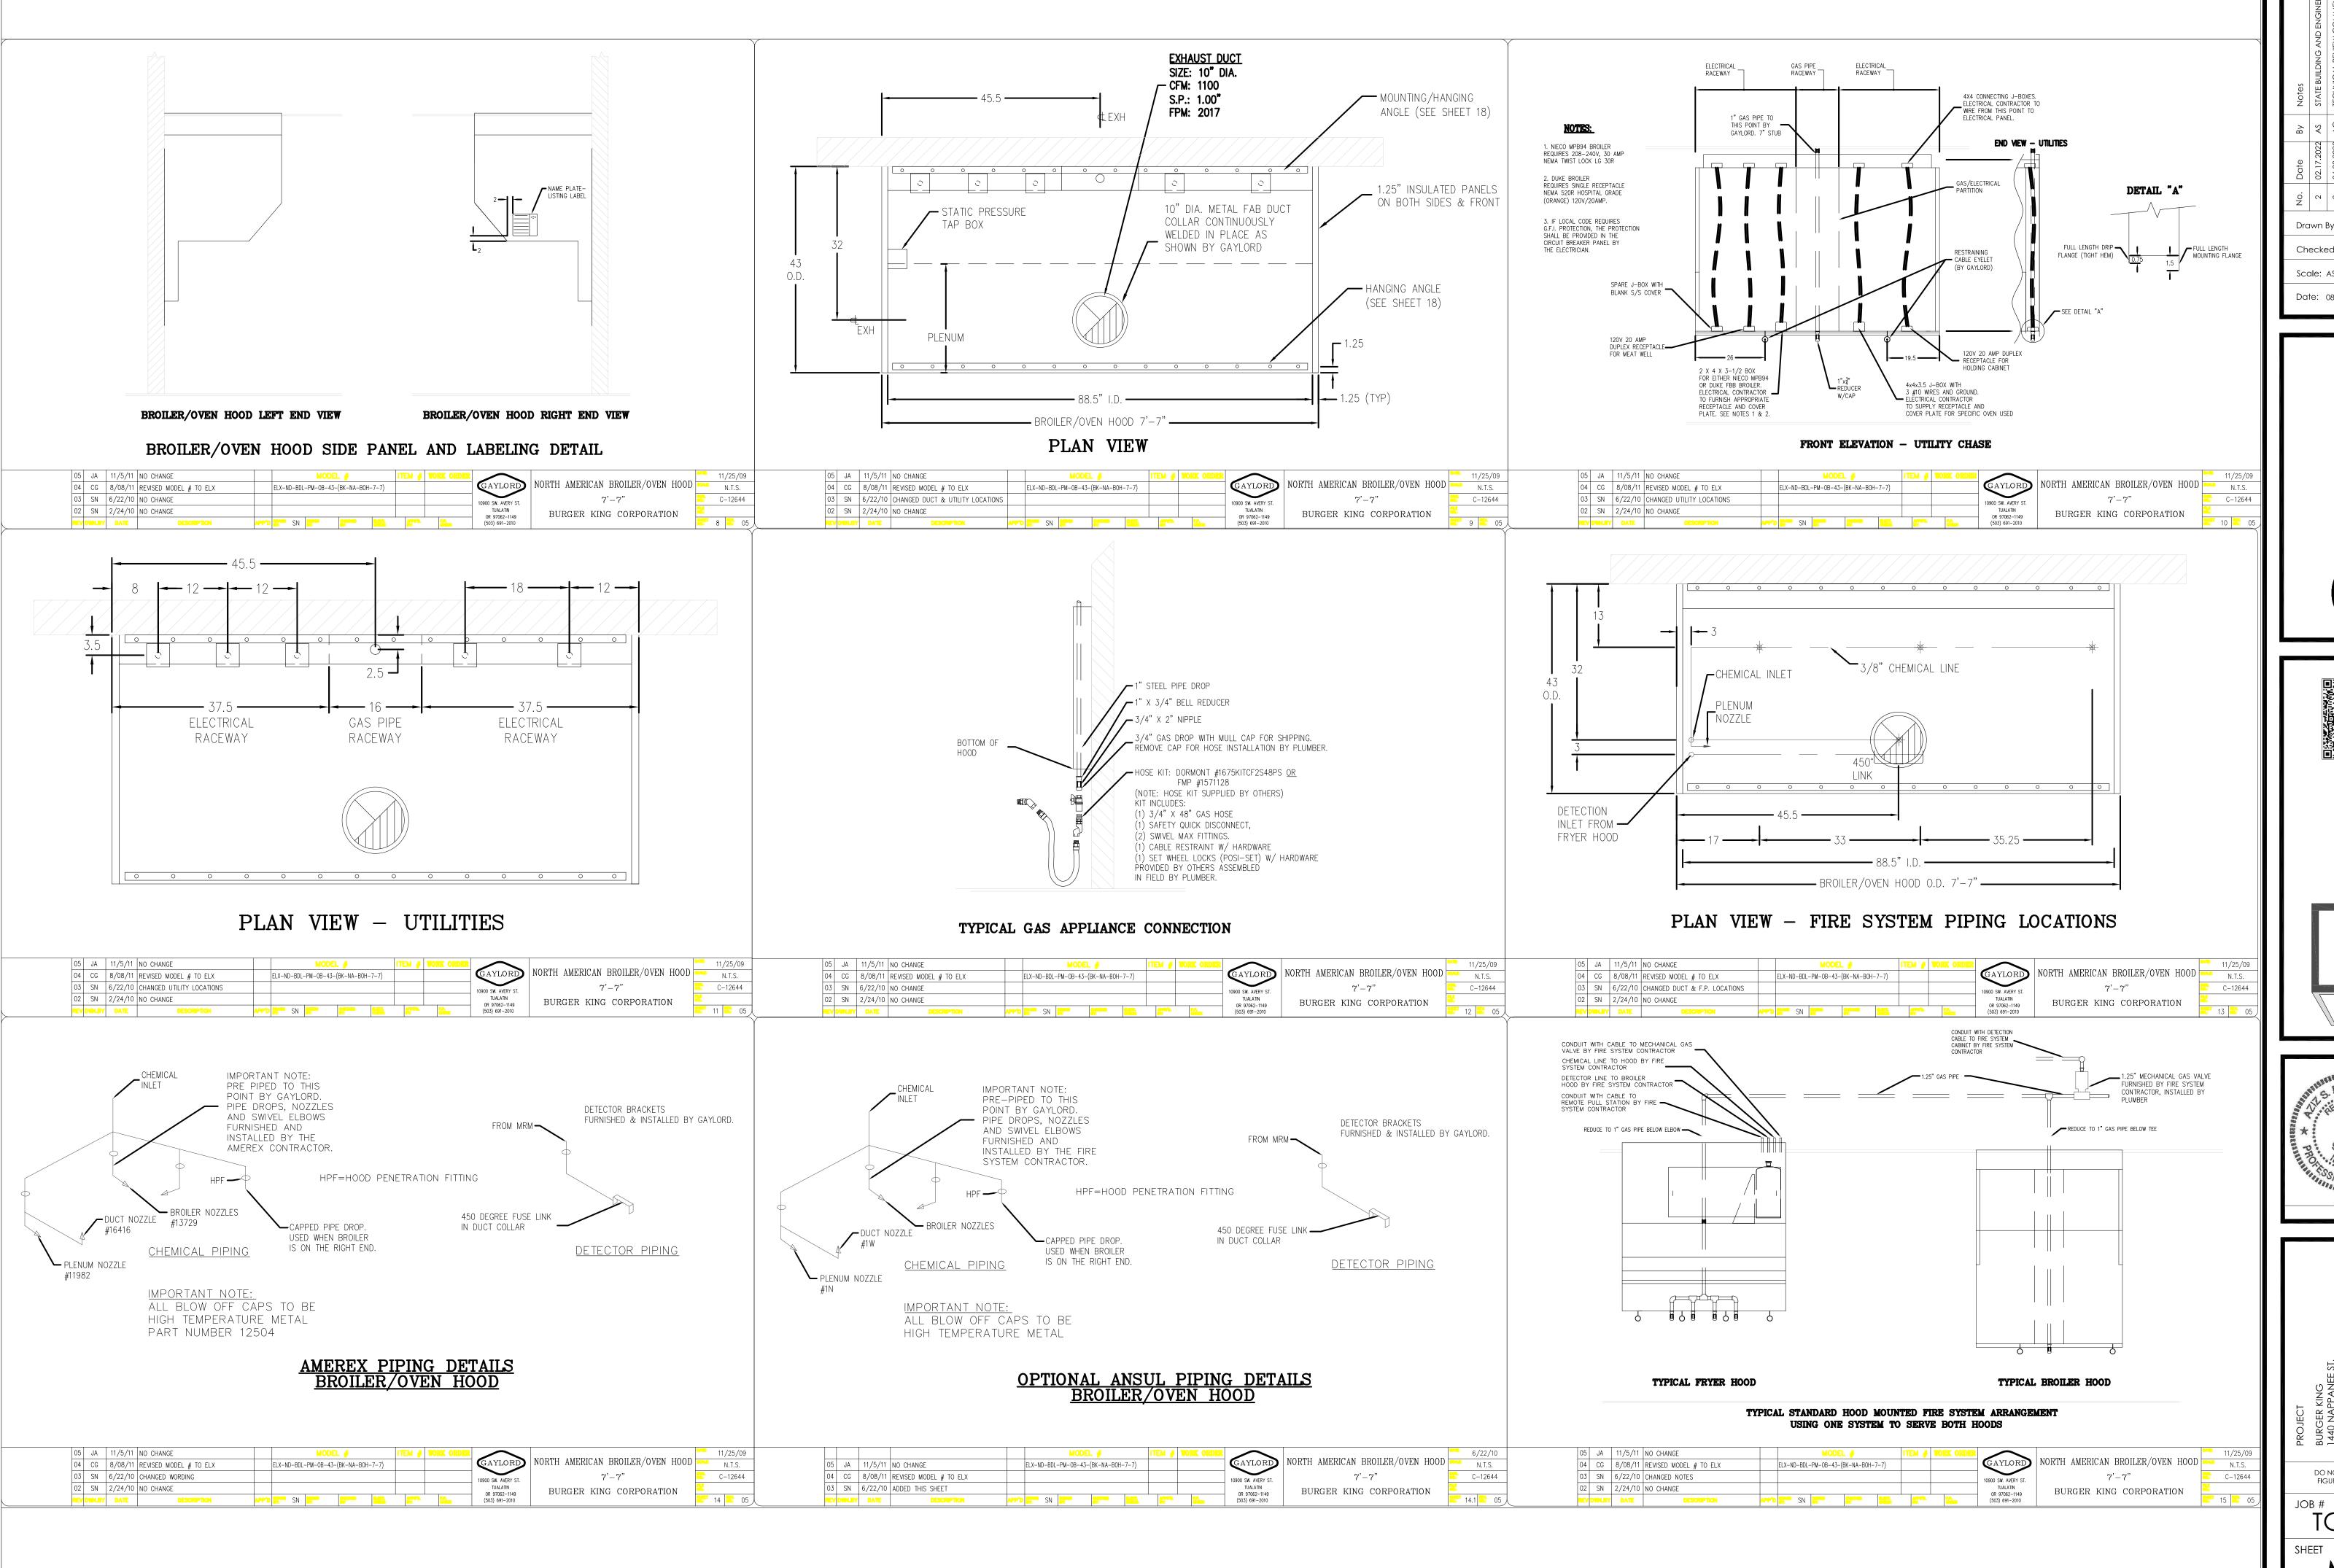Contact Information for the Job Site Contractor







Drawn By:CP Checked:SB Scale: AS NOTED Date: 08.02.21








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TG-21668

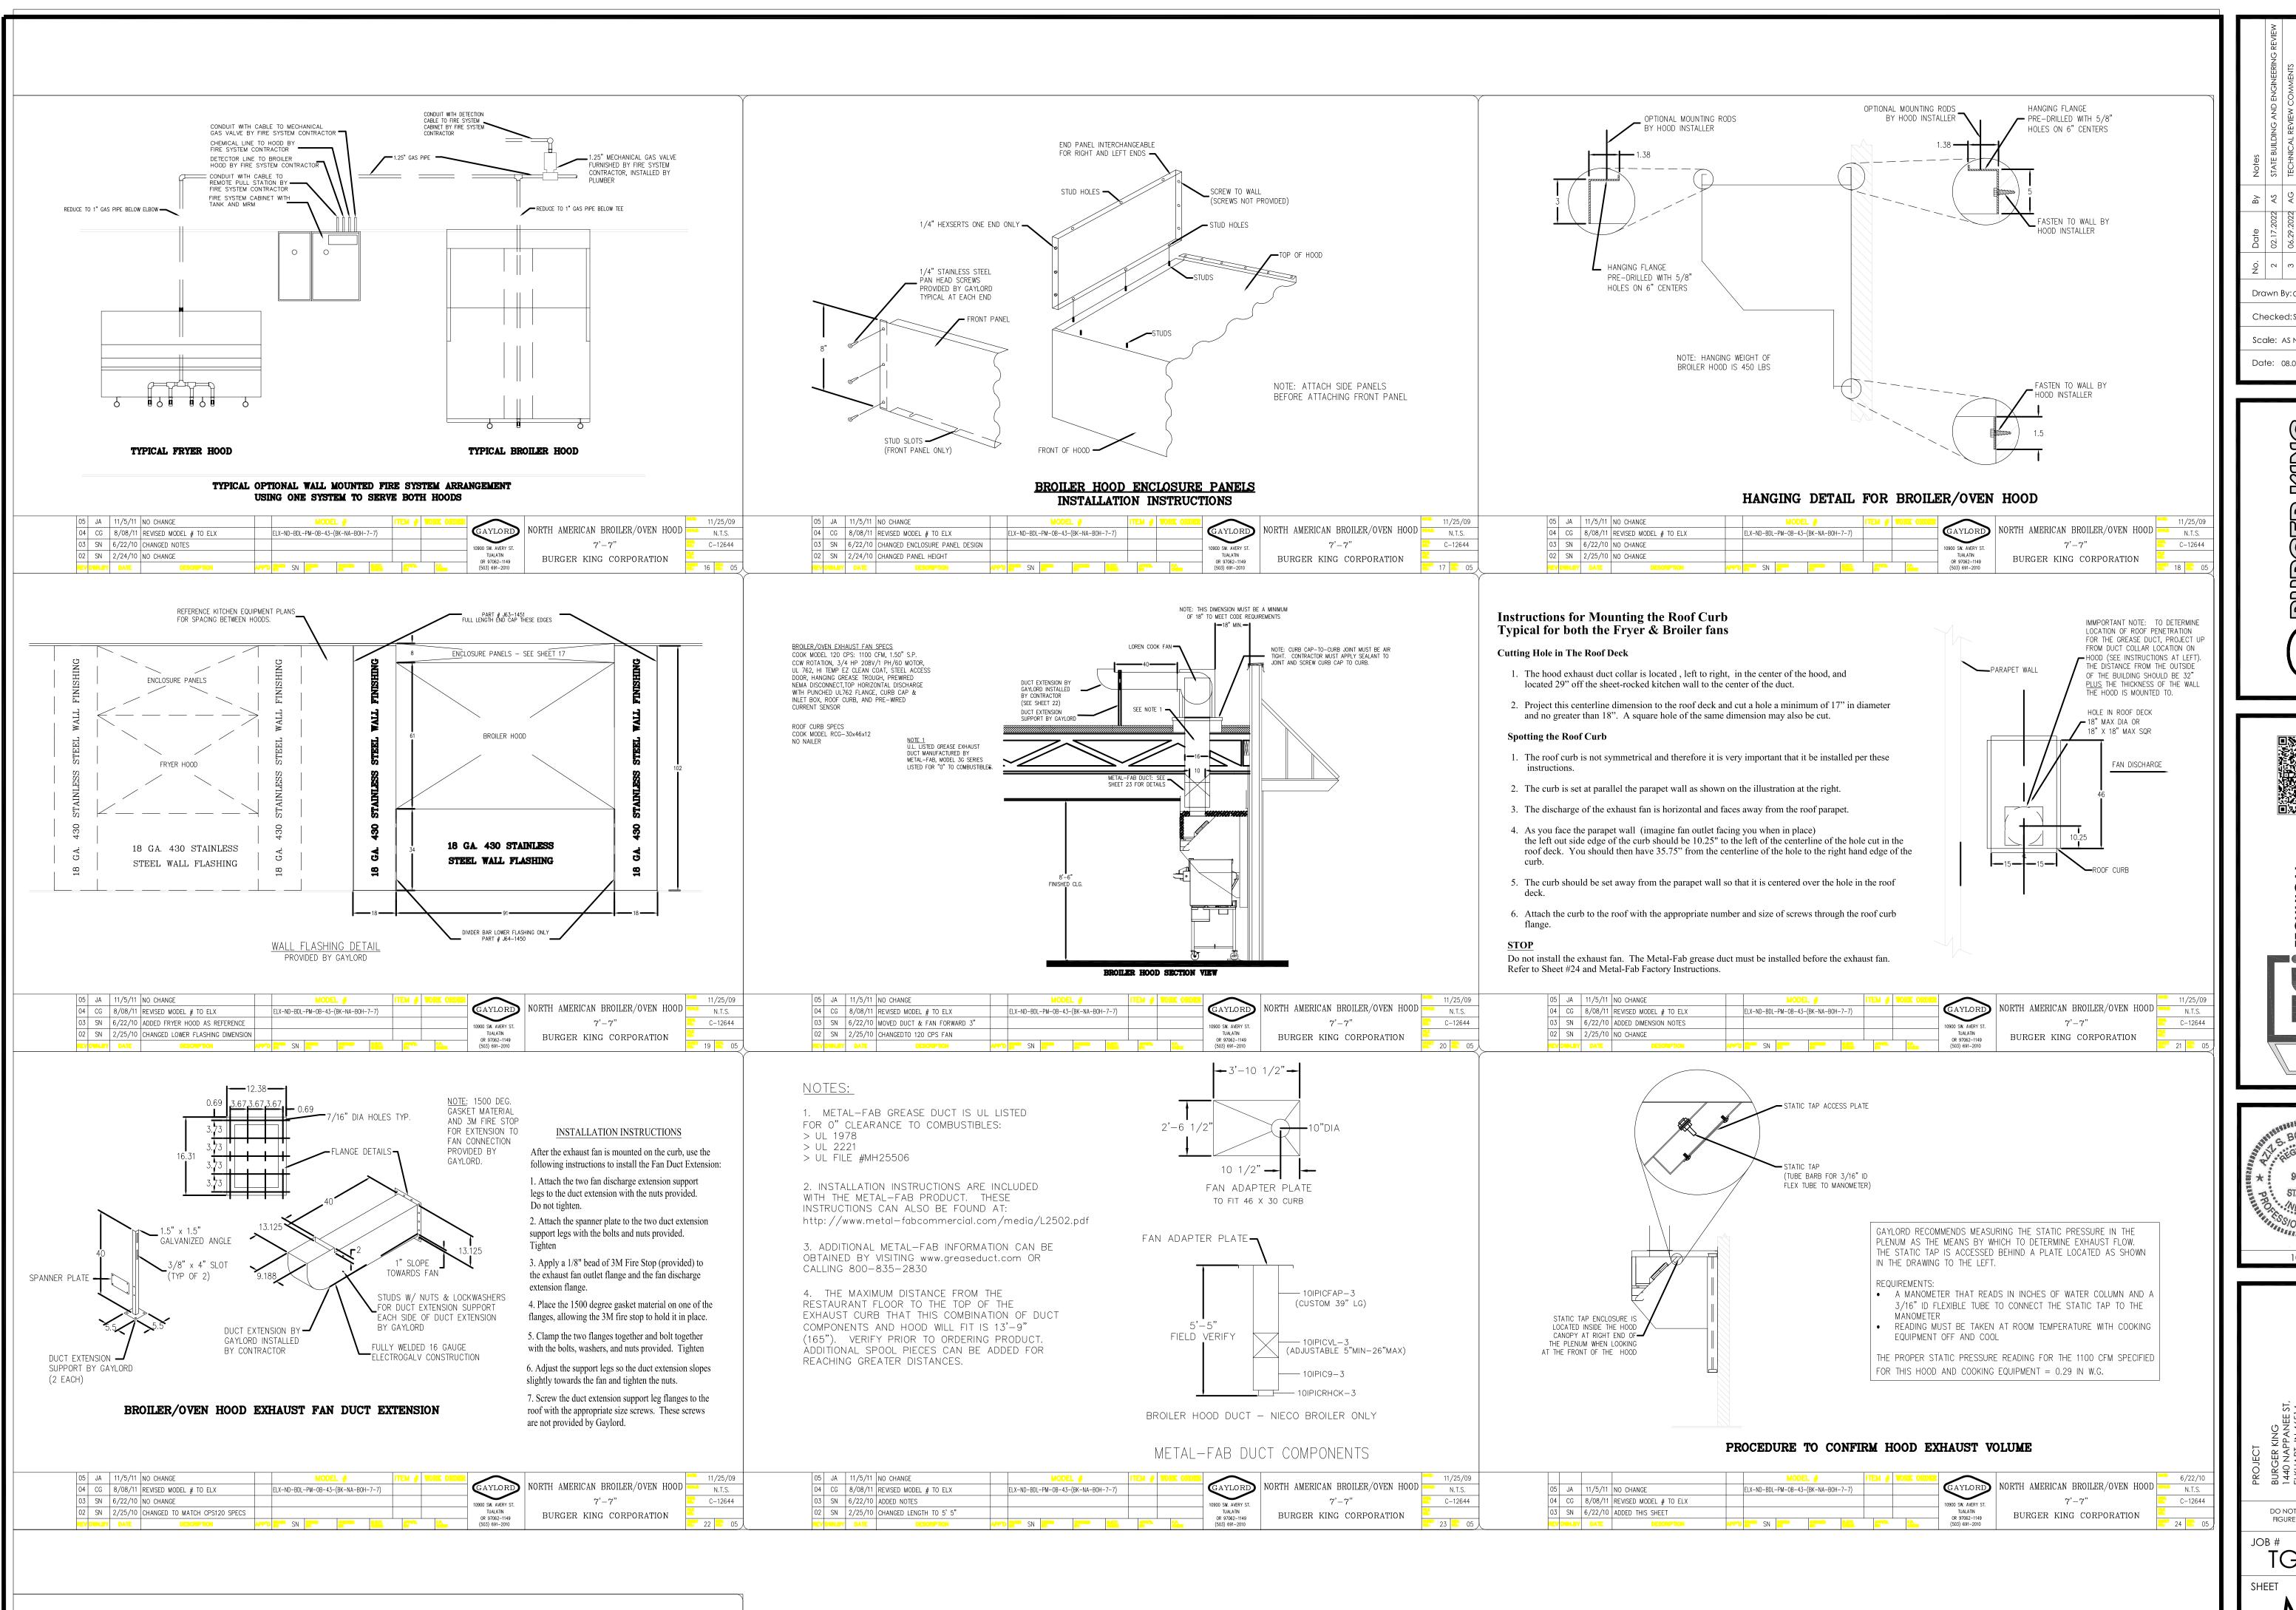

DD STATE BUILDING AND ENGINEERING REVIEW

SO STATE BUILDING AND ENGINE REVIEW

SO STATE BUILDING AND ENGINE REVIEW

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SO SO SO SPECIFICATIONS MAYBE

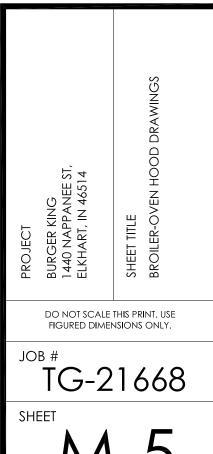
COPIED, REPODUCED OR USED IN CONNECTION WITH ANY WORK, OTHER THEN THE SPECIFIC

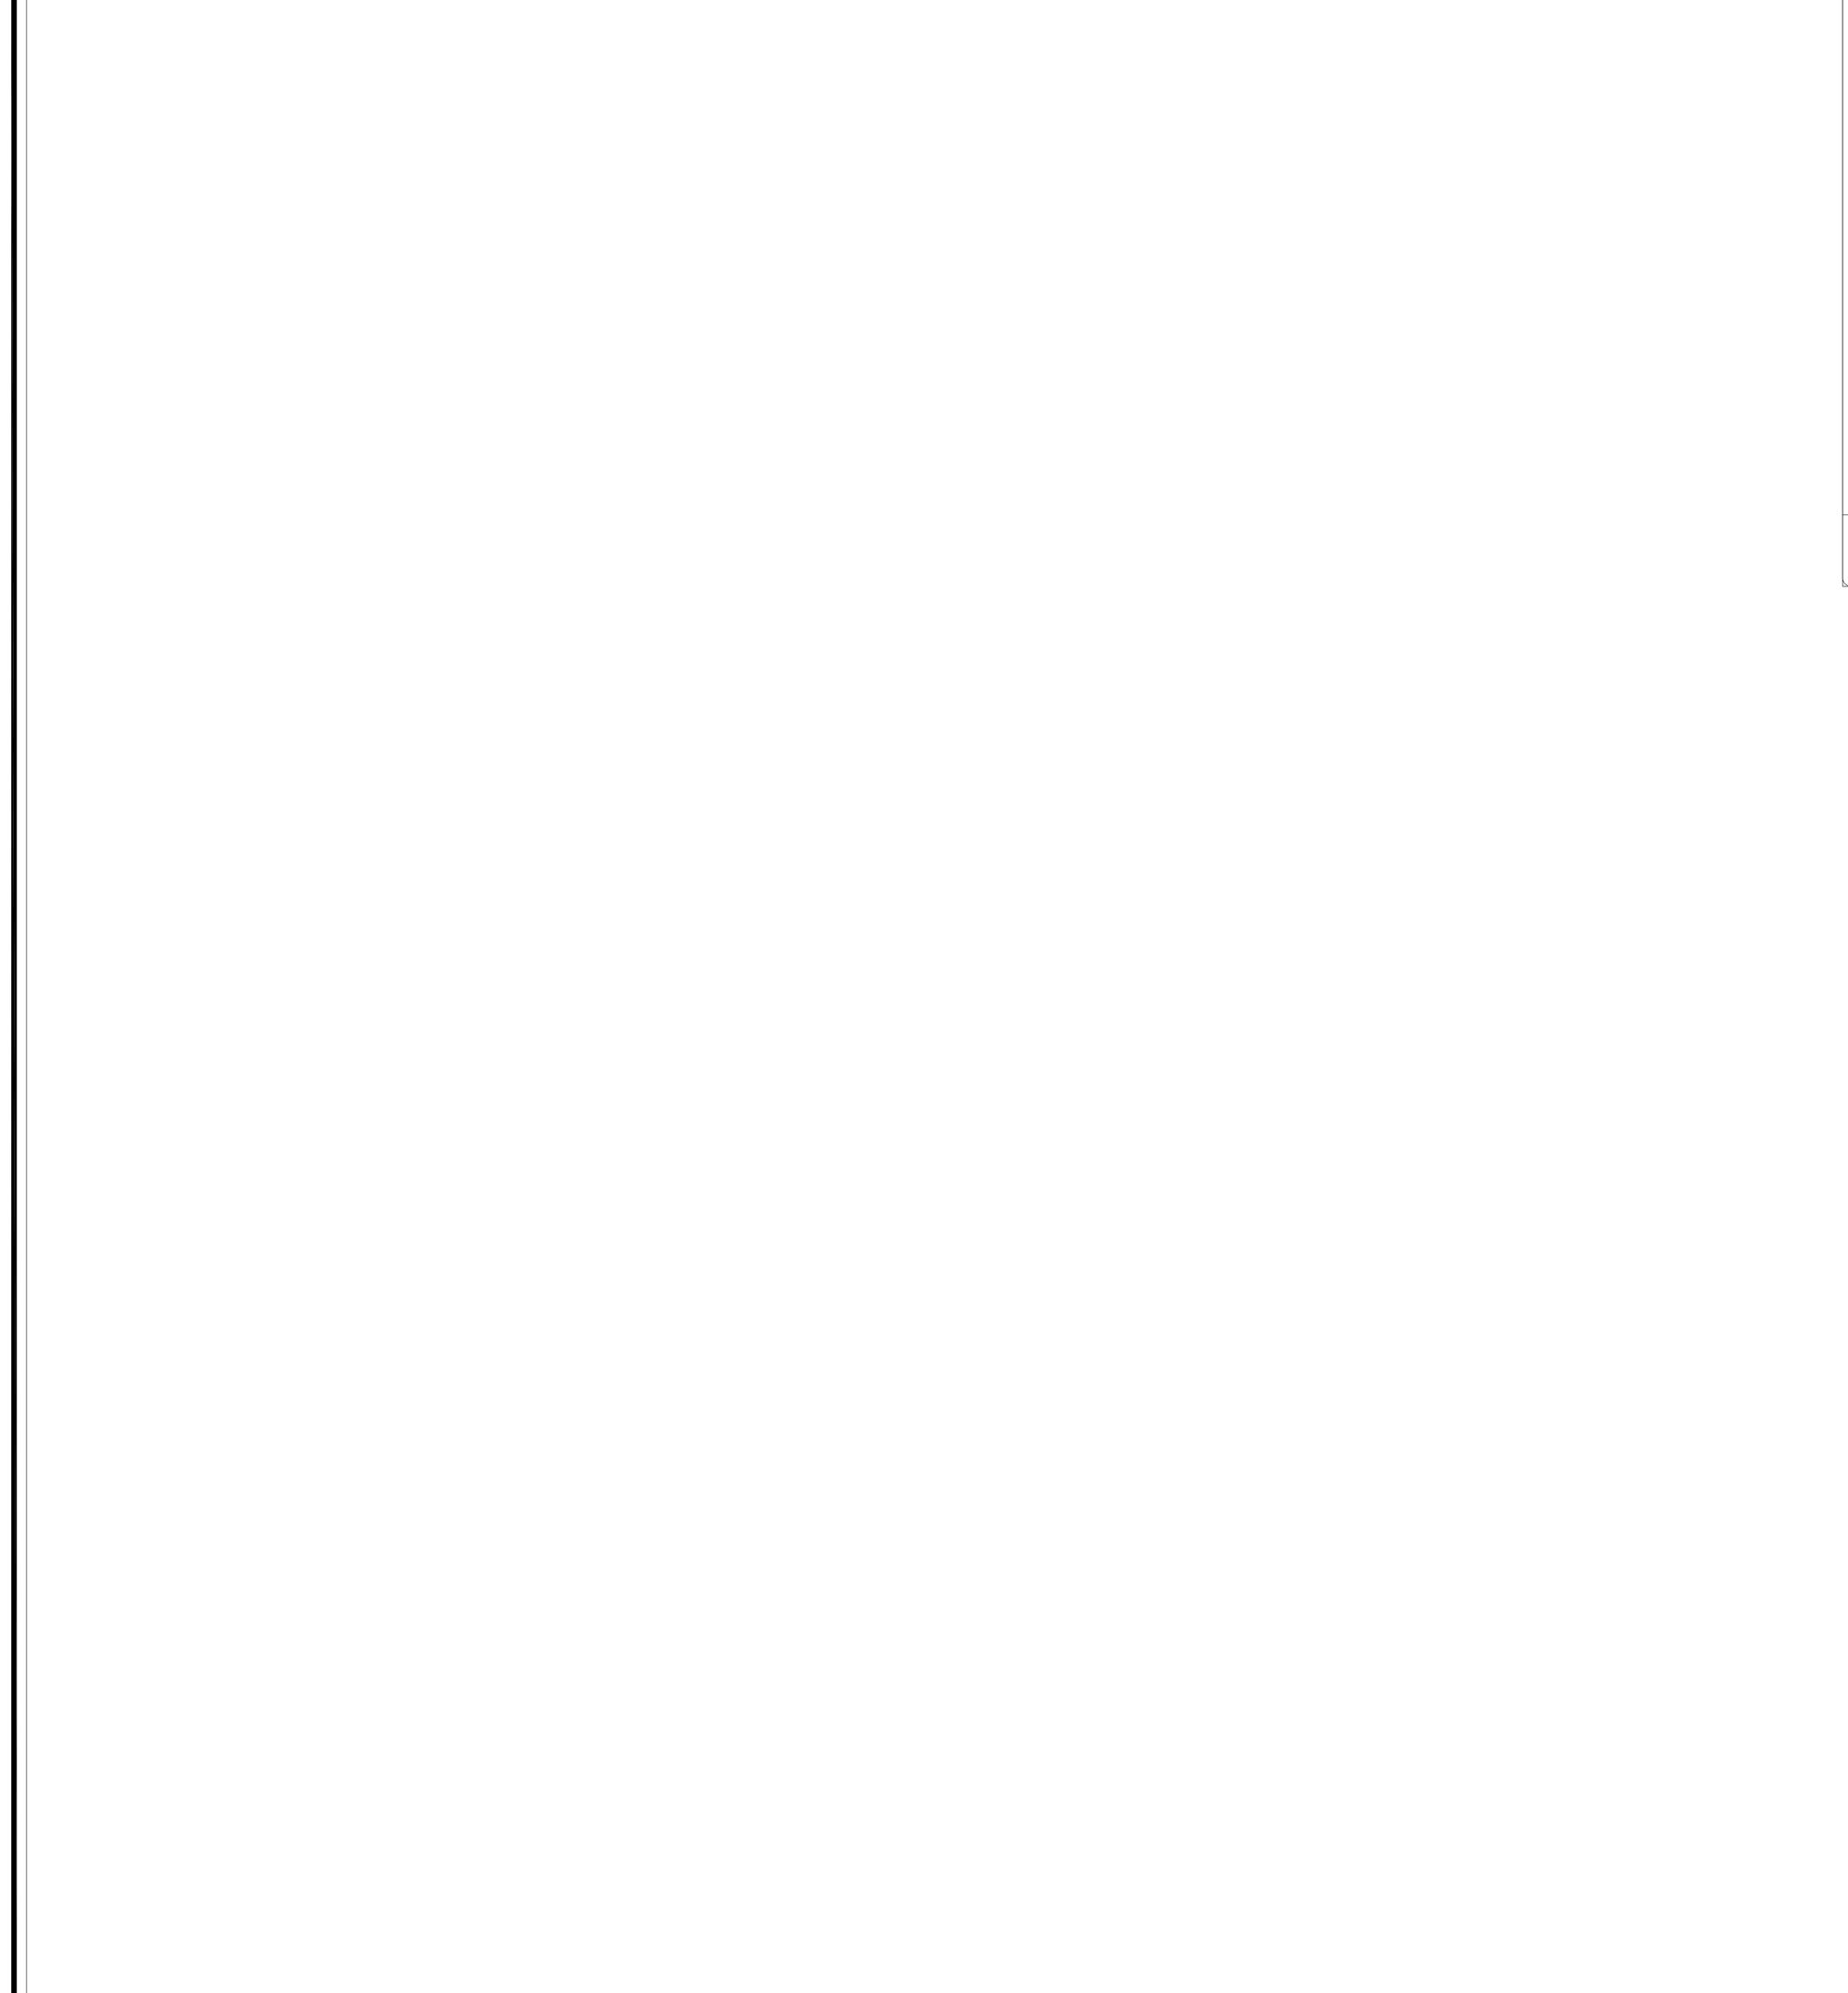
PROJECT FOR WHICH THE HAVE BEEN PREPARED, WITHOUT PRIOR WRITTEN AUTHORIZATION

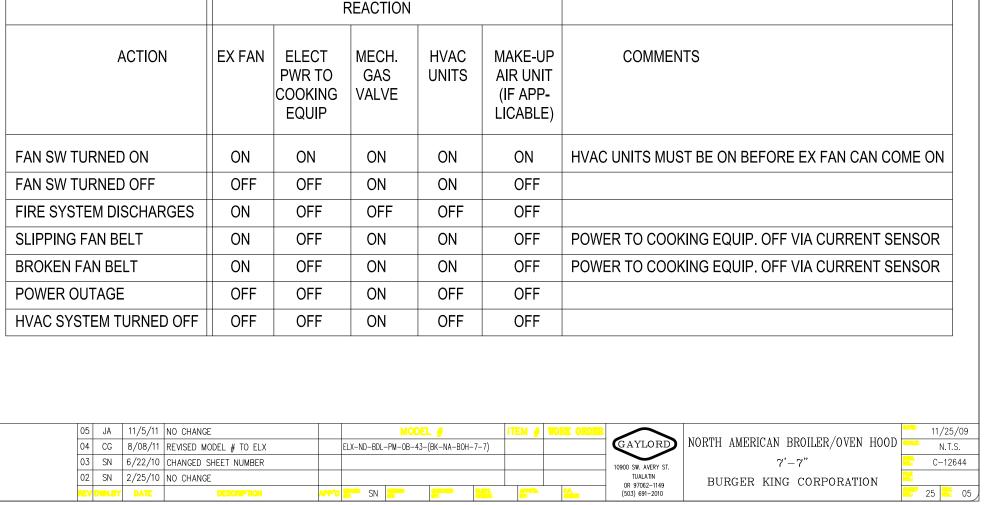













		F	REACTION			
ACTION	EX FAN	ELECT PWR TO COOKING EQUIP	MECH. GAS VALVE	HVAC UNITS	MAKE-UP AIR UNIT (IF APP- LICABLE)	COMMENTS
FAN SW TURNED ON	ON	ON	ON	ON	ON	HVAC UNITS MUST BE ON BEFORE EX FAN CAN COME ON
FAN SW TURNED OFF	OFF	OFF	ON	ON	OFF	
FIRE SYSTEM DISCHARGES	ON	OFF	OFF	OFF	OFF	
SLIPPING FAN BELT	ON	OFF	ON	ON	OFF	POWER TO COOKING EQUIP. OFF VIA CURRENT SENSOR
BROKEN FAN BELT	ON	OFF	ON	ON	OFF	POWER TO COOKING EQUIP. OFF VIA CURRENT SENSOR
POWER OUTAGE	OFF	OFF	ON	OFF	OFF	
HVAC SYSTEM TURNED OFF	OFF	OFF	ON	OFF	OFF	

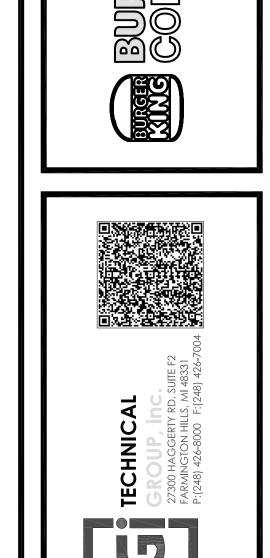





10.06.2022

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TG-21668



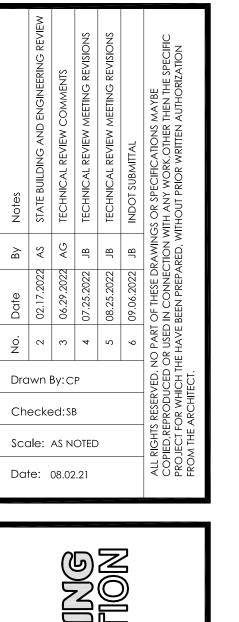

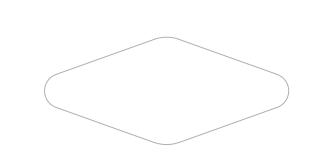5'-7" NORTH AMERICAN FRYER HOOD

FOR BURGER KING CORPORATION

FRYER HOOD MODEL: ELX-ND-BD-38-(BK-NAFH-5-7)

Manufactured by: GAYLORD INDUSTRIES

10900 SW. AVERY ST. TUALATIN, OREGON 97062 UNITED STATES OF AMERICA PHONE: (503) 691-2010 EMAIL: INFO@GAYLORDUSA.COM

Drwg no.: C-12634

NORTH AMERICA FRYER HOOD

FOR BURGER KING CORP.

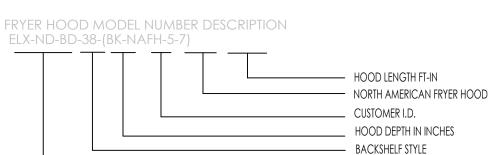
11-08-10

C-12634

07

Rev.:07

MODEL NUMBER DESCRIPTION



Sheet #	Description	
01	COVER SHEET	
01.1	MODEL # & INDEX	
02	CONTROL CONTACT SHEET	
03	SPECIFICATIONS	
03.1	HOOD LISTING & APPROVAL REFORENCES	
04	FRYER HOOD OVERVIEW	
05	FRONT ELEVATION	
06	FRYER HOOD SECTION VIEW	
07	FRYER HOOD RIGHT END VIEW- HOOD LABLE & POSI-SET LOCATION	
08	PLAN VIEW	
09	FRONT ELEVATION-UTILITIES	
10	FRONT ELEVATION - PLAN VIEW - UTILITIES	
11	TYPICAL GAS APPLIANCE CONNECTION DETAIL	
12	PLAN VIEW - FIRE SYSTEM PIPING LOCATIONS	
13	HOOD MOUNTED FIRE SYSTEM DETAIL	
14	AMEREX PRE-PIPING DETAILS - FRYER HOOD	
15	AMEREX PRE-PIPING DETAILS - FRYER HOOD	
16	OPTIONAL ANSUL PREPIPING DETAILS - FRYER HOOD	
17	HOOD MOUNTED FIRE SYSTEM ARRANGEMENT - FRYER HOOD	
18	OPTIONAL WALL MOUNTED FIRE SYSTEM ARRANGEMENT - FRYER HOOD	
19	FRYER HOOD EXHAUST DUCT EXTENSION DETAIL	
20	FRYER HOOD ENCLOSURE PANELING DETAIL	
21	HANGING DETAIL FOR FRYER HOOD	
22	WALL FLASHING DETAIL	
23	FRYER HOOD SECTION DETAIL	
24	ROOF CURB MOUNTING DETAIL	
25	EXHAUST FAN DUCT EXTENTION DETAILS	
26	METAL-FAB GREASE DUCT DETAILS	
26.1	OPTIONAL SQUARE DUCT KIT	
27	PROCEDURE TO CONFIRM HOOD EXHAUST VLUME	
28	BK HOOD-FAN FIRE SYSTEM-HVAC CONTROL MATRIX	

Contact Information for the Job Site Contractor

Contact Information

Shipment Information For shipment information on any of the equipment including the Metal-Fab duct, Loren Cook fan and Amerex fire system Gaylord Industries, Tualatin, Oregon: 1. John Anderson Direct Phone:

E-Mail: johna@gaylordusa.com

971-223-1238

Hood Installation Questions Gaylord Industries, Tualatin Oregon: 1. John Anderson Direct Phone: 971-223-1238

johna@gaylordusa.com

Metal-Fab Duct Installation Questions The Metal-Fab grease exhaust duct systems Metal-Fab Inc., Wichita, Kansas are dropped shipped from their factory in 1. Customer Service, Commercial Vent Products: 800-835-2830

ordered, the kit will be shipped with the hood. The Loren Cook exhaust fans and roof curb is dropped shipped from their factory in

Loren Cook Fan Installation Questions Loren Cook Company, Springfield, Missouri: 1. David Ray Office Phone: 417-869-6474

Amerex Fire System Installation Questions The Hood has been factory pre-piped for an ELX-ND-BD-38-(BK-NA-FH-5-7) Amerex fire system. The package from Gaylord includes complete installation of the Amerex fire system including all plans, permits, check out and certification. The local

Amerex distributor will bring all the system

NORTH AMERICA FRYER HOOD 5'-7'' FOR BURGER KING CORP.

Contact Information (Cont.) Important Note: The local Amerex distributor

will make contact with the general contractor to set up the installation schedule. If you have not heard from the distributor contact: Amerex Corporation, Trussville, Alabama Office Phone: Karen Mann 205-655-5730

Ansul Fire System Installation Questions Note: As an option, the hoods may be pre piped for an Ansul R-102 fire system. If this option is used, Gaylord does not provide complete installation.

If you have questions regarding Ansul installations & you do not know your local Ansul Distributor, contact: Ansul Inc., Marinette, WI. Office Phone: 800-862-6785

X

11-08-10

C-12634

Drawn By:CP

Checked:SB

Scale: AS NOTED

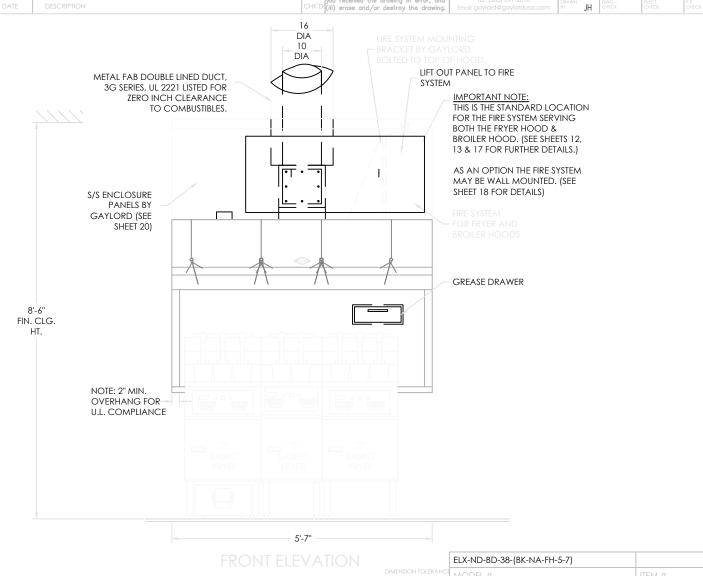
Date: 08.02.21

NORTH AMERICA 5' - 7" FRYER HOOD SPECIFICATIONS

07 JFA 04/11/13 No Change

06 JFA 11/5/11 MOVE C-12680 REV 01 TO C-12634 REV 6 BK APROVED #

ELX-ND-BD-38-(BK-NA-FH-5-7) NORTH AMERICA FRYER HOOD 11-08-10 C-12634 07 JFA 04/11/13 No Change 07 FOR BURGER KING CORP. 06 JFA 11/5/11 MOVE C-12680 REV 01 TO C-12634 REV 6 BK APROVED #



07	JFA	04/11/13	No Change
06	JFA	11/5/11	MOVE C-12680 REV 01 TO C-12634 REV 6 BK APROVED
DEV	DWAL BY	DATE	DECORIDATION

07 JFA 04/11/13 No Change

07 JFA 04/11/13 No Change

06 JFA 11/5/11 MOVE C-12680 REV 01 TO C-12634 REV 6 BK APROVED #

06 JFA 11/5/11 MOVE C-12680 REV 01 TO C-12634 REV 6 BK APROVED #

HOOD LISTING AND APPROVAL REFERENCE

	± 1/4" (6mm)	MODEL :
	ATTENTION — This plan is the property of Gaylord Industries and is confidential	GA
	and proprietary. It is not to be copied, reproduced, or distributed, in whole or part, nor be used in anyway	INDL
	detrimental to Gaylord Industries. If you have received this plan without	
	Gaylord's permission, please (i) do not read it, (ii) reply to the sender that	
CHK'D	you received the drawing in error, and (iii) erase and/or destroy the drawing.	TEL: Email: gayle

4	GAYLORD _o	NORTH AMERICA FRYER HOOD					
	INDUSTRIES			5'-7"			1
	GAYLORD TUALATIN, OR	F	OR BURG	SER KING	G CORP	•	1
	TEL: (503) 691-2010 Email: gaylord@gaylordusa.com	DRAWN BY:	JH DWG. CHECK	ELECT. CHECK:	F.P. CHECK:	S.E. APPROVAL:	- 5

11-08-10 C-12634

NORTH AMERICA FRYER HOOD

FOR BURGER KING CORP.

5'-7''

Overview

following:

following:

1. Broiler Hood

Wichita, Kansas.

Springfield, Missouri.

1. One Hood

Industries includes the

Broiler & Fryer Hoods.

Typically the package provided by Gaylord

2. One Metal Fab UL listed grease exhaust

4. One Amerex fire system, to serve both

The shipment from Gaylord includes the

4. One Exhaust Fan Discharge Duct Extension

NOTE 1: If optional Square Duct Kit is

07 JFA 04/11/13 No Change

IMPORTANT NOTE:

07 JFA 04/11/13 No Change


3. One Loren Cook exhaust fan


2. Broiler Hood Enclosure Panels

3. Broiler Hood Wall Flashing


This drawing depicts two basic fryer configurations approved by Burger King Corporation.

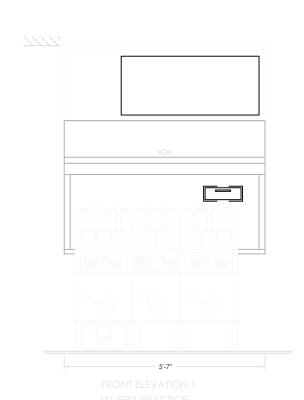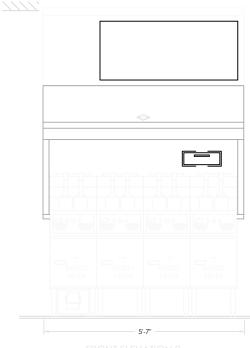06 JFA 11/5/11 MOVE C-12680 REV 01 TO C-12634 REV 6 BK APROVED # components at the time of installation, that






	ELX-ND-BD-38-(BK-NA-FH-	5-7)					
DIMENSION TOLERANCE ± 1/4" (6mm)	MODEL #		ITEM #		WO	rk or	DER #
ATTENTION — This plan is the property of Gaylord Industries and is confidential and proprietary. It is not to be	GATLORD	NORTH AMER	RICA FRY	ER HOOI	2	DATE:	11-08-10
copied, reproduced, or distributed, in whole or part, nor be used in anyway detrimental to Gaylord Industries. If	INDUSTRIES		5'-7"			DRAWING NO.:	C-12634
you have received this plan without Gaylord's permission, please (i) do not read it, (ii) reply to the sender that	(GAYLORD) TUALATIN, OR	FOR BURG	ER KING	CORP.		REV. NO.:	07
you received the drawing in error, and (iii) erase and/or destroy the drawing.	TEL: (503) 691-2010 Email: gaylord@gaylordusa.com	DRAWN BY: JH DWG. CHECK	ELECT. CHECK:	F.P. CHECK:	S.E. APPROVAL:	SHEET NO.:	04

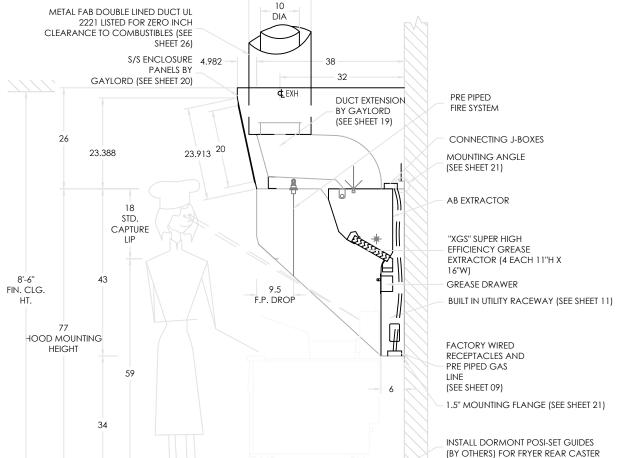

(BY OTHERS) FOR FRYER REAR CASTER WHEELS ON FLOOR TO ENSURE PROPER FRYER POSITION UNDER HOOD.

ELX-ND-BD-38-(BK-NA-FH-5-7)

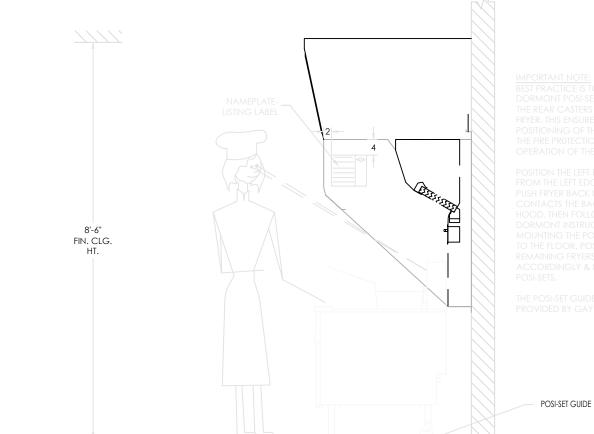ELX-ND-BD-38-(BK-NA-FH-5-7) NORTH AMERICA FRYER HOOD 11-08-10 5'-7'' C-12634



	ELX-ND-BD-38-(BK-NA-FH-	5-7)		
DIMENSION TOLERANCE ± 1/4" (6mm)	MODEL #	ITEM #	WOR	RK ORDER #
nis plan is the property stries and is confidential It is not to be	GAYLORD _o	NORTH AMERICA FRYER HOOD		11-08-10
ced, or distributed, in nor be used in anyway Gaylord Industries. If	INDUSTRIES	5'-7"		DRAWING NO.: C-12634
ed this plan without sion, please (i) do not	(GAYLORD)	FOR BURGER KING CORP.		REV. NO.: 07

POSI-SET GUIDE

FOR BURGER KING CORP.

07

11-08-10

C-12634

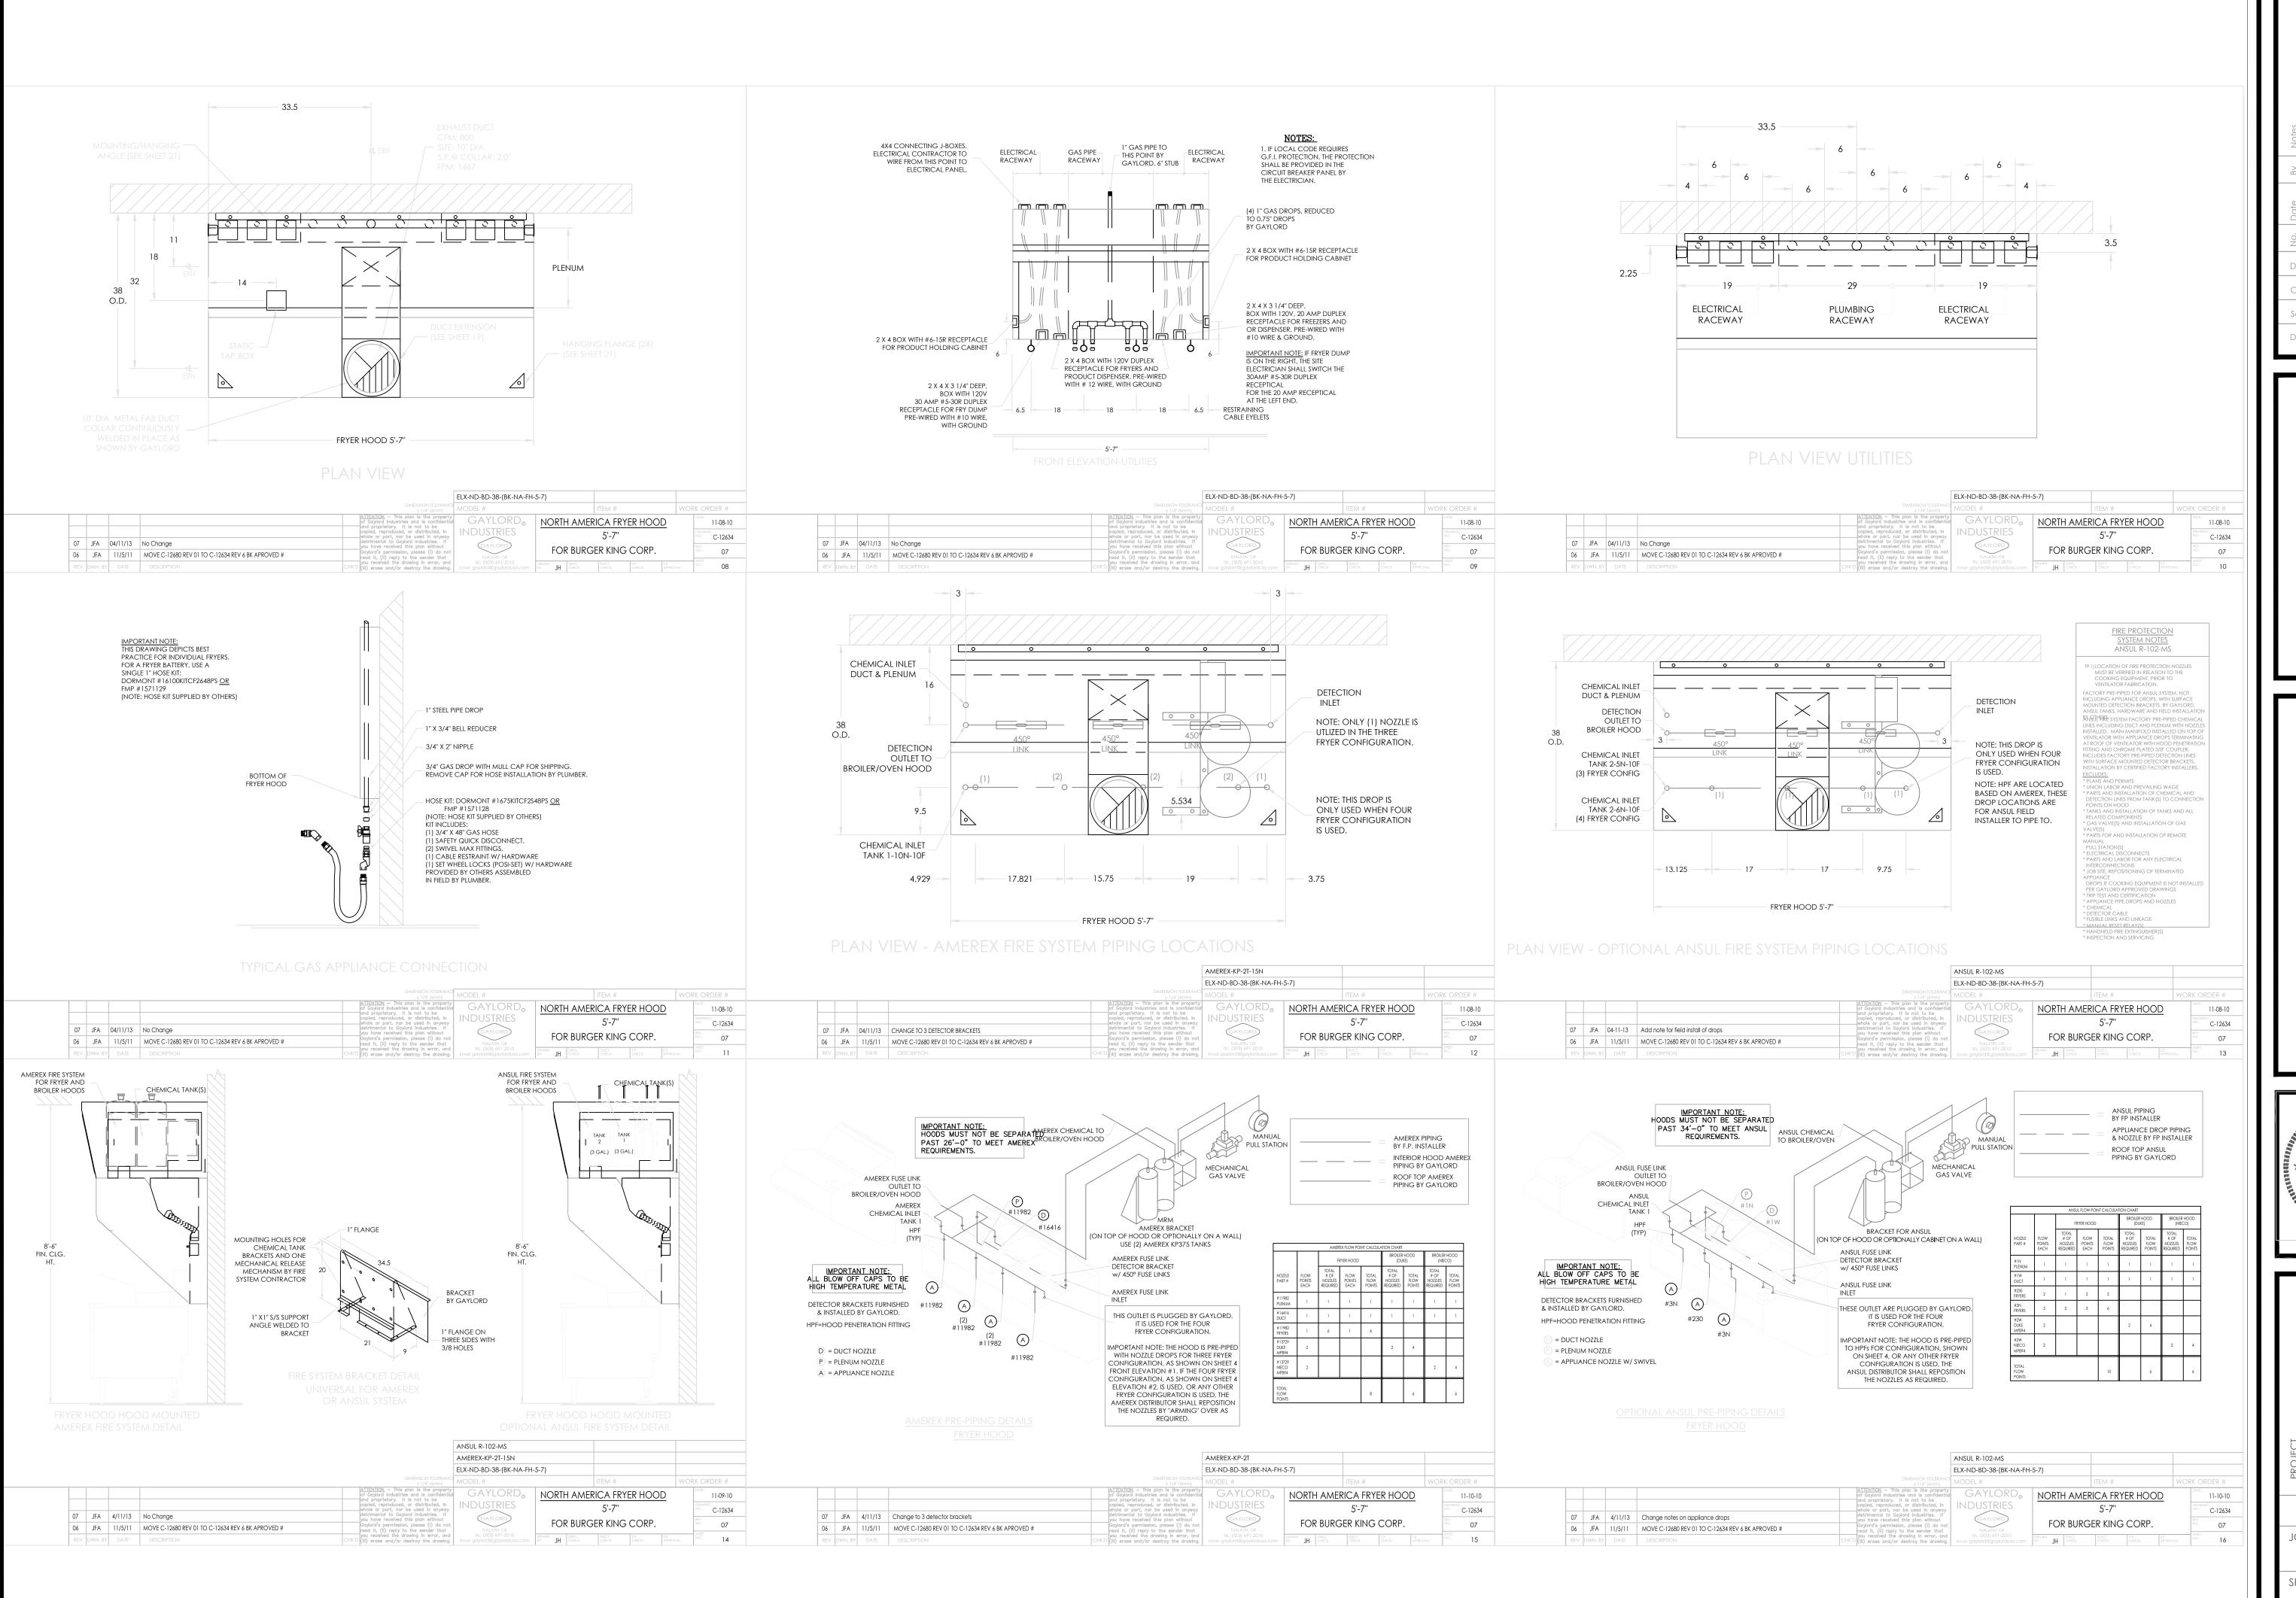
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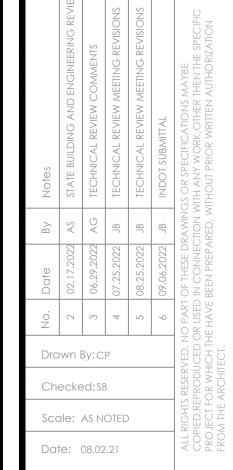
07 JFA 04/11/13 No Change

06 JFA 11/5/11 MOVE C-12680 REV 01 TO C-12634 REV 6 BK APROVED #

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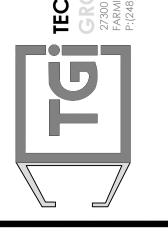
FIGURED DIMENSIONS ONLY.

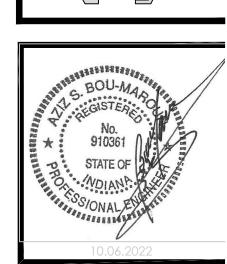














SHEET TITLE FRYER HOOD DRAWINGS	SHEET TITLE FRYER HOOD DRAWINGS	SHEET TITLE FRYER HOOD DRAWINGS
FRYER HOOD DRAWINGS	FRYER HOOD DRAWINGS	FRYER HOOD DRAWINGS

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SHEET A A - 8



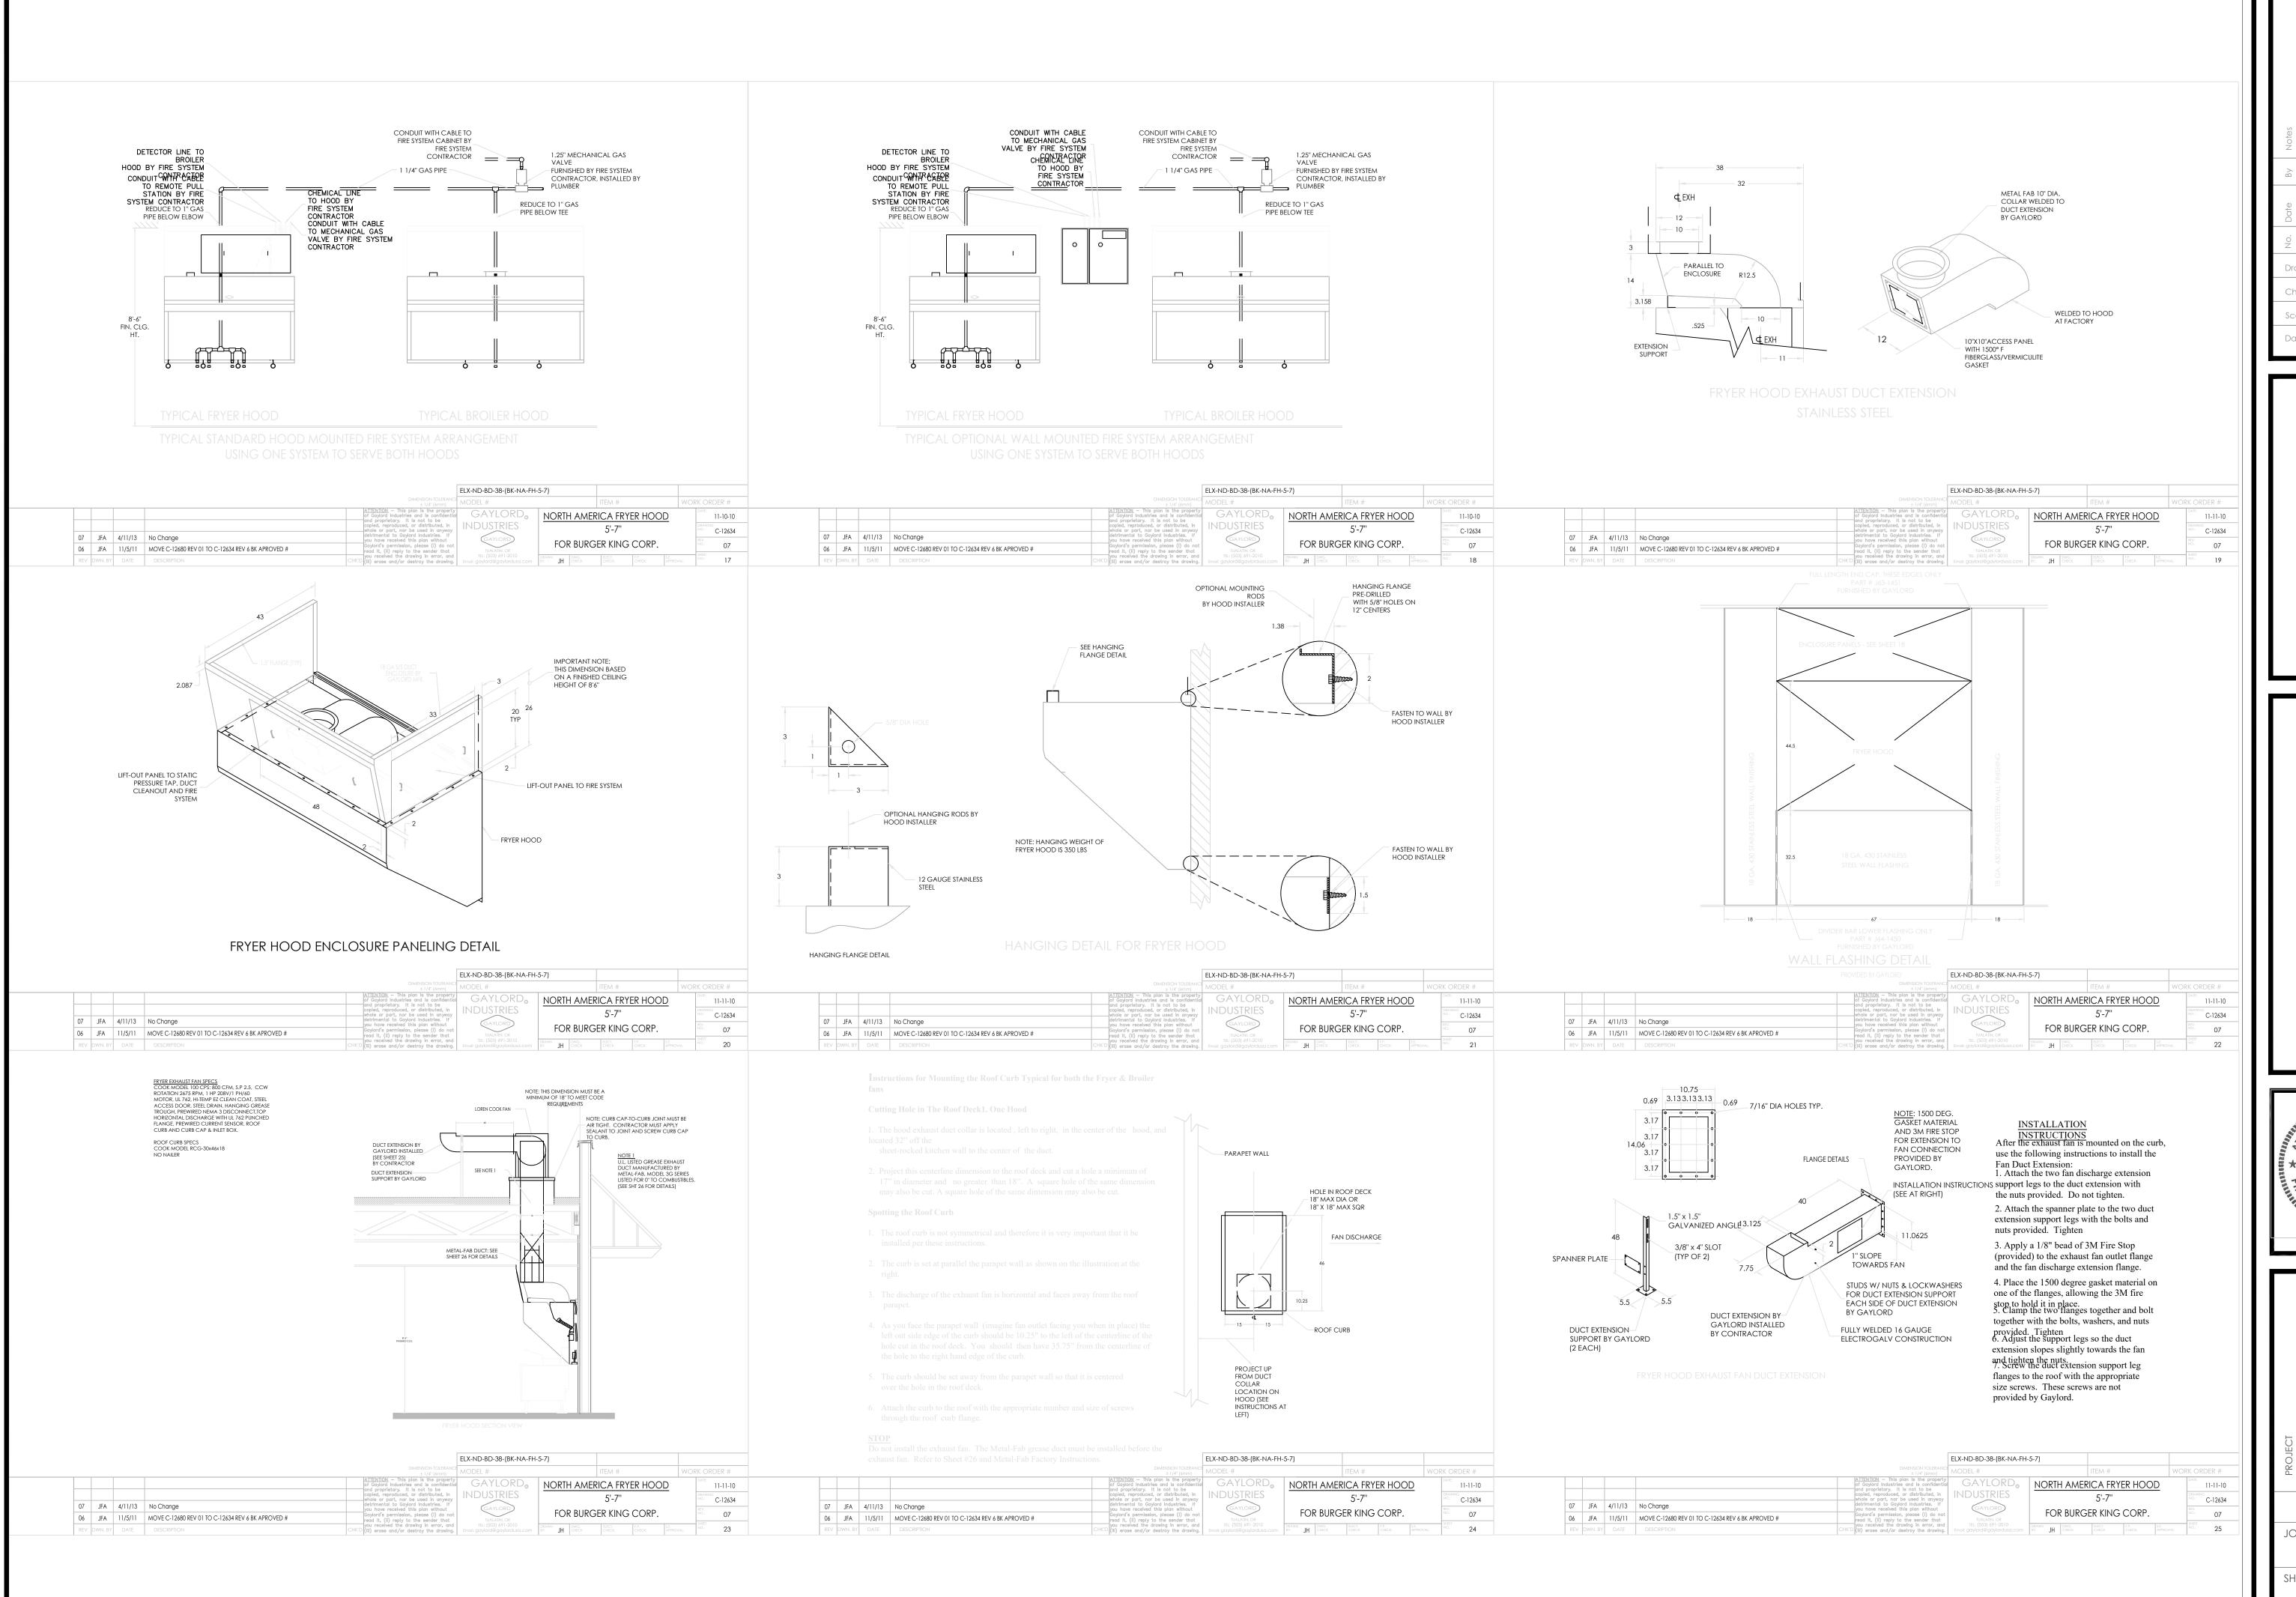

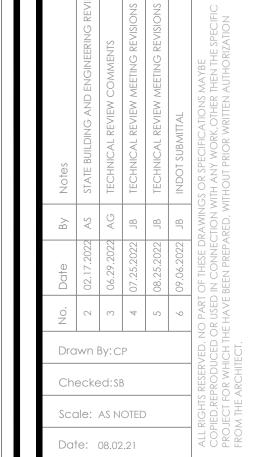BURGER KING

KING

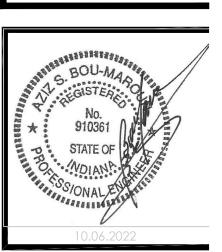
CORPORATION



TECHNICAL

GROUP, inc.
27300 HAGGERTY RD. SUITE F2
FARMINGTON HILLS, MI 48331
P:(248) 426-8000 F:(248) 426-7004





BURGER KING 1440 NAPPANEE ST, ELKHART, IN 46514	SHEET TITLE FRYER HOOD DRAWINGS
BURGE 1440 N ELKHA	SHEET

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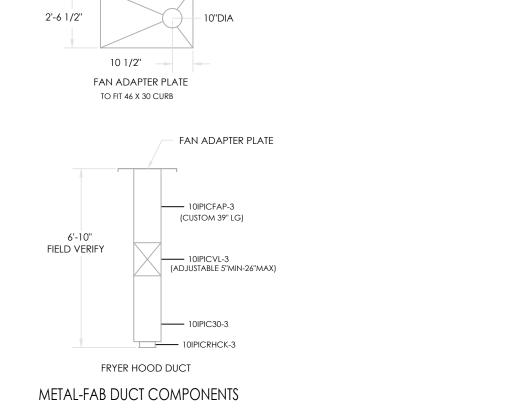
TG-21668
SHEET

1. METAL-FAB GREASE DUCT IS UL LISTED FOR 0" CLEARANCE TO COMBUSTIBLES: > UL 1978 > UL 2221 > UL FILE #MH25506

2. INSTALLATION INSTRUCTIONS ARE INCLUDED WITH THE METAL-FAB PRODUCT. THESE INSTRUCTIONS CAN ALSO BE FOUND AT: http://www.metal-fabcommercial.com/media/L2502.pdf

3. ADDITIONAL METAL-FAB INFORMATION CAN BE OBTAINED BY VISITING www.greaseduct.com OR CALLING 800-835-2830

4. THE MAXIMUM DISTANCE FROM THE RESTAURANT FLOOR TO THE TOP OF THE ROOF DECK THAT THIS COMBINATION OF DUCT COMPONENTS AND HOOD WILL FIT IS 13'-10" (166"). VERIFY PRIOR TO ORDERING PRODUCT. THIS COMBINATION WILL FIT PROTOTYPICAL ROC AND ROC 20/20 ROOF DECK HEIGHTS. IF THE BUILDING IS A 20/20 EDGE OR A NON-STANDARD ROC BUILDING, ADDITIONAL SPOOLS MAY BE NECESSARY FOR ADDITIONAL COST. CONTACT GAYLORD FOR INFORMATION.




3'-10 1/2"

						ELX-ND-BD-38-(BK-NA-FH	-5-7)				
					DIMENSION TOLERANCE ± 1/4" (6mm)	MODEL #		ITEM #	WO	rk or	DER #
					ATTENTION — This plan is the property of Gaylord Industries and is confidential and proprietary. It is not to be	GATLORD _o	NORTH AMER	RICA FRYER HOOD		DATE	11-11-10
					copied, reproduced, or distributed, in whole or part, nor be used in anyway	INDUSTRIES		5'-7"		DRAWING NO.:	C-12634
07	JFA	4/11/13	No Change		detrimental to Gaylord Industries. If you have received this plan without	(GAYLORD)	FOR BUIDO			REV.	
06	JFA	11/5/11	MOVE C-12680 REV 01 TO C-12634 REV 6 BK APROVED #		Gaylord's permission, please (i) do not read it, (ii) reply to the sender that	TUALATIN, OR	FOR BURG	ER KING CORP.		NO.:	07
REV	DWN. BY	DATE	DESCRIPTION	CHK'E	you received the drawing in error, and (iii) erase and/or destroy the drawing.	TEL: (503) 691-2010 Email: gaylord@gaylordusa.com	DRAWN BY: JH DWG. CHECK	ELECT. F.P. S.E. APPR	ROVAL:	NO.:	26

BK ROC HOOD / EX. FAN / FIRE SYSTEM / HVAC CONTROL MATRIX AS OF 10-14-09						
		R	EACTION			
ACTION	EX FAN	ELECT PWR TO COOKING EQUIP	MECH. GAS VALVE	HVAC UNITS	MAKE-UP AIR UNIT (IF APP- LICABLE)	COMMENTS
FAN SW TURNED ON	ON	ON	ON	ON	ON	HVAC UNITS MUST BE ON BEFORE EX FAN CAN COME ON
FAN SW TURNED OFF	OFF	OFF	ON	ON	OFF	
FIRE SYSTEM DISCHARGES	ON	OFF	OFF	OFF	OFF	
SLIPPING FAN BELT	ON	OFF	ON	ON	OFF	POWER TO COOKING EQUIP. OFF VIA CURRENT SENSOR
BROKEN FAN BELT	ON	OFF	ON	ON	OFF	POWER TO COOKING EQUIP. OFF VIA CURRENT SENSOR
POWER OUTAGE	OFF	OFF	ON	OFF	OFF	
HVAC SYSTEM TURNED OFF	OFF	OFF	ON	OFF	OFF	

ELX-ND-BD-38-(BK-NA-FH-5-7

					ATTENTION — This plan is the property of Gaylord Industries and is confidential and proprietary. It is not to be	GAYLORD _®	NORTH	1 AMERI	ICA FRY	ER HOO	D	DATE:	1-11-10
					copied, reproduced, or distributed, in whole or part, nor be used in anyway	INDUSTRIES			5'-7''		_	DRAWING NO.:	C-12634
07	JFA	4/11/13	No Change		detrimental to Gaylord Industries. If you have received this plan without	(GAYLORD)	F01		-D KINIO	0000		REV.	
06	JA	11/5/11	MOVE C-12680 REV 01 TO C-12634 REV 6 BK APROVED #		Gaylord's permission, please (i) do not read it, (ii) reply to the sender that	TUALATIN, OR	FOR	K BUKGE	ER KING	CORP.		NO.:	07
REV	DWN. BY	DATE	DESCRIPTION	CHK'E	you received the drawing in error, and (iii) erase and/or destroy the drawing.	TEL: (503) 691-2010 Email: gaylord@gaylordusa.com	DRAWN BY: JH	DWG. CHECK	ELECT. CHECK:	F.P. CHECK:	S.E. APPROVAL:	NO.:	28

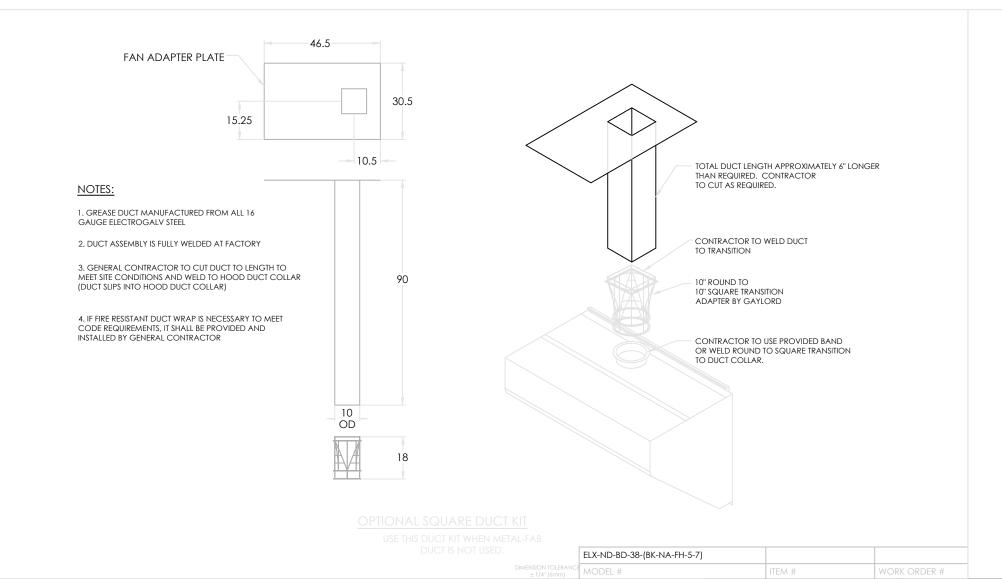

07 JFA 4/11/13 No Change

06 JFA 11/5/11 ADD THIS SHEET

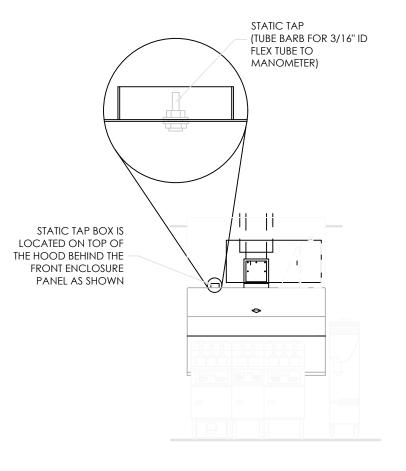
NORTH AMERICA FRYER HOOD

FOR BURGER KING CORP.

5'-7''

11-11-10

C-12634




GAYLORD RECOMMENDS MEASURING THE STATIC PRESSURE IN THE PLENUM AS THE MEANS BY WHICH TO DETERMINE EXHAUST FLOW. THE STATIC TAP IS ACCESSED BEHIND A PLATE LOCATED AS SHOWN IN THE DRAWING TO THE LEFT.

REQUIREMENTS:

- A MANOMETER THAT READS IN INCHES OF WATER COLUMN AND A 3/16" ID FLEXIBLE TUBE TO CONNECT THE STATIC TAP TO THE MANOMETER READING MUST BE TAKEN AT ROOM TEMPERATURE WITH
- COOKING EQUIPMENT OFF AND COOL

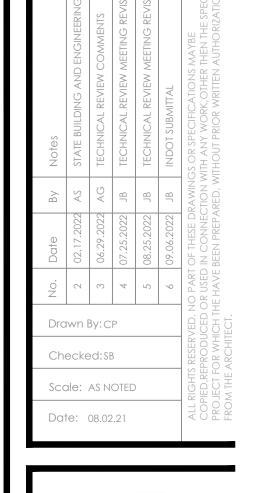THE PROPER STATIC PRESSURE READING FOR THE 850 CFM SPECIFIED FOR THIS HOOD AND COOKING EQUIPMENT = 0.37 IN

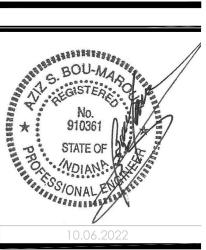
					ELX-ND-BD-38-(BK-NA-FH-5-7)		
					DIMENSION TOLERANCE # MODEL # ITEM #	WORK ORDER #	#
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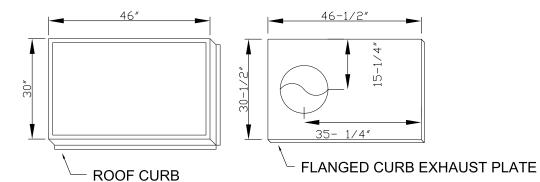


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STEP-1

- A. COORDINATE WITH THE LATEST KITCHEN EQUIPMENT PLANS PRIOR TO INSTALLATION OF CURB. VERIFY WITH GENERAL CONTRACTOR.
- B. MARK AND PLUMBOB THE LOCATION OF THE ROUND OPENING FROM FLOOR
- C. PLACE CURB OVER OPENING BY USING DIMENSION GIVEN BELOW. D. WHEN GREASE FLANGE ARRIVES PLACE ON CURB WITH ROUND OVER
- HVAC CONTRACTOR SHALL NOT DISASSEMBLE THE EXHAUST FAN TO



ROOF CURB

- METAL-FAB

OUTLET COLLAR

= MEASURE DISTANCE (SHOULD BE APPROX. 58")

LOCATE THE METAL-FAB

OUTLET COLLAR POSITIONED

MEASURE DISTANCE FROM TOP OF HOOD OUTLET

COLLAR TO TOP OF ROOF CURB

LENGTH (VL) DUCT.

ON TOP OF THE GAYLORD

EXHAUST HOOD.

PLAN VIEW OF ROOF CURBS

STEP-2 BROILER HOOD

BROILER

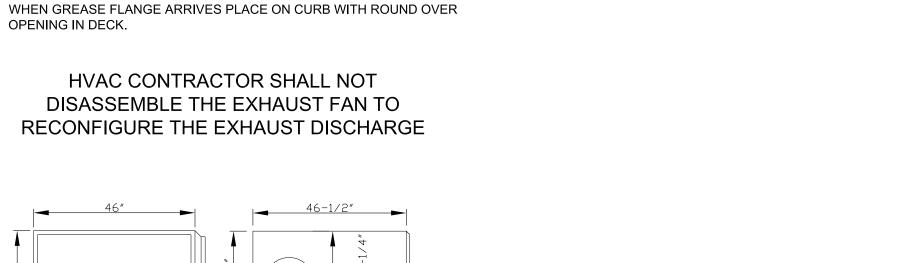
STEP-3

VL COLLAR-

INNER DUCT-

NOT SHOWN)

(OUTER CASING



APPROX. 61

I. 16 GAUGE SQUARE OFFSET

SQUARE OFFSET.

CURB AS SHOWN.

WELDED TO DISCHARGE COLLAR

AT THE FACTORY, ON TOP OF

THE GAYLORD EXHAUST HOOD. METAL-FAB OUTLET COLLAR COMES FROM FACTORY WELDED INTO CAP WITH CAP WELDED ONTO TOP OF

2. MEASURE DISTANCE FROM TOP OF

OUTLET COLLAR TO TOP OF ROOF

- FACTORY WELDED OFFSET TO HOOD DISCHARGE COLLAR

- METAL-FAB

OUTLET COLLAR

STEP-2 (FRYER HOOD)

FRYER

REMOVE THE OUTER CASING & INSULATION FROM THE VARIABLE

(DO NOT DISCARD INSULATION OR CASING. IT WILL BE USED LATER).

PLACE THE "TRANSITION DUCT/FAN ADAPTER PLATE" UPSIDE DOWN

ON THE ROOF (FAN ADAPTER PLATE AGAINST ROOF).

VL COLLAR INNER DUCT "H"+1" MIN "H"+3" MAX. TRANSITION DUCT -FAN ADAPTER PLATE

STEP-4

LOOSEN AND RELOCATE VL COLLAR TO "H" DIMENSION AS MEASURED IN STEP 1. RETIGHTEN SCREWS ON COLLAR. (DO NOT REMOVE COLLAR FROM PIPE SECTION.)

IF NEEDED, TRIM EXCESS DUCT LENGTH TO FINISHED LENGTH OF "H"+3 USING "H" LENGTH MEASURED IN STEP 2.

NOTE: FINISHED LENGTH OF "H"+1" (MINIMUM) UP TO "H+3" (MAXIMUM) IS ACCEPTABLE.





IPIC-3G Factory-Built Grease Duct Installation Instructions Specific for Burger King Restaurant Installation (Forward Discharge Assembly)

Note: These instructions have been developed in coordination for use with kitchen exhaust hood manufactured by Gaylord Industries.

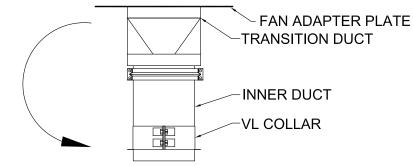
GENERAL INFORMATION

Metal—Fab Model IPIC—3G grease duct is "Listed" by Underwriters Laboratories for kitchen exhaust duct applications for continuous operations at 500° F and intermittent operation at 2000° F. IPIC - 3G is further "Classified" by Underwriters Laboratories as equivalent to a 2-hr. fire rated grease duct enclosure as per l 2221 test standard and listed for Zero inch clearance to combustibles for sizes up to and including 24—inch inside diameter.

Warning: During this installation, field application of factory—supplied insulation must be installed at joints and on Variable Length / Adjustable Length components. Do not substitute insulation with other makes or brands. Upon completion of installation, 2 layers of 1.5—inch insulation (supplied by manufacturer) must be applied directly around the inner duct as described in these instructions in order to maintain the Zero-inch clearance to combustibles rating as per the manufacturer's UL listing.

FOR QUESTIONS CALL METAL-FAB @ 1-800-835-2830 X 4165

STEP-4b Rotate duct 180°



THE FOLLOWING INSTRUCTIONS ARE STEP-5 (BROILER) USED TO ALIGN THE GREASE DUCT TO THE HOOD OUTLET COLLAR. 1. TURN THE DUCT ASSEMBLY OVER & CAREFULLY SLIDE THROUGH THE FAN

COLLAR

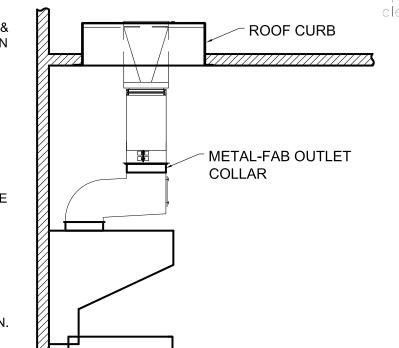
2. CONTINUE LOWERING THE ASSEMBLY, AS IT APPROACHES THE HOOD, ALIGN THE OUTLET COLLAR & SLIP THE ASSEMBLY INTO THE COLLAR. ─ METAL-FAB OUTLET

3. CHECK THE FAN ADAPTER PLATE FOR PROPER POSITION. THE OUTSIDE EDGE OF THE FAN ADAPTER PLATE SHOULD BE APPROXIMATELY 1/4" FROM EDGE OF ROOF CURB. 4. NOTE: IF THE FAN CURB IS NOT


PROPERLY ALIGNED TO THE HOOD OUTLET COLLAR, THE FAN ADAPTOR PLATE CAN BE TRIMMED TO RE-ALIGN. ONCE ALIGNMENT IS ESTABLISHED

ASSEMBLE GREASE DUCT TO

EXHAUST HOOD.




STEP-5 (FRYER)

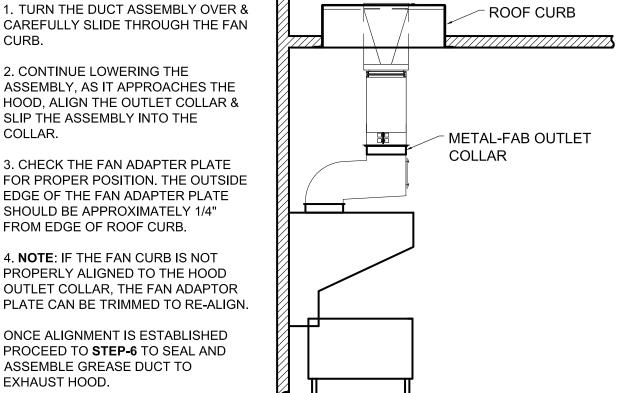


NOTE: ALL REMAINING INSTRUCTIONS PERTAIN TO BOTH BROILER EXHAUST HOOD AND FRYER EXHAUST HOOD, AS IN STEP-5.

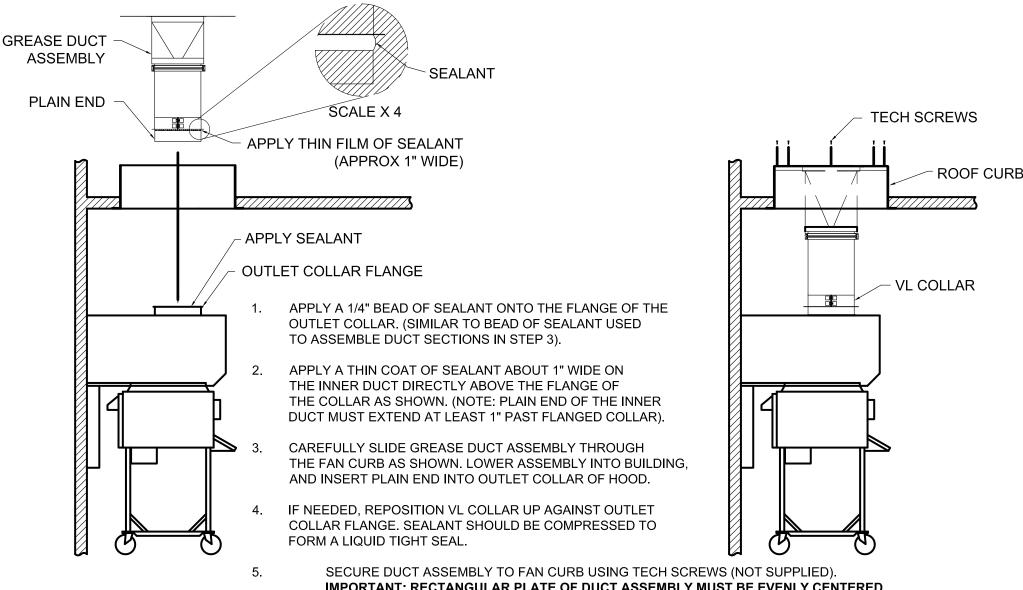STEP-6




STEP-7

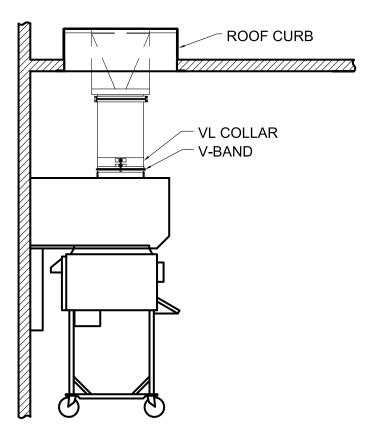

- APPLY A BEAD OF SEALANT TO V-BAND CLAMP AND ATTACH TO JOINT AS SHOWN. REF. TO STEP 3.
- 2. TIGHTEN SCREWS ON VL COLLAR. (FOR MORE POSITIVE SEAL, APPLY SEALANT TO VL COLLAR SLOT AND FLARED OUT END OF COLLAR PRIOR TO TIGHTENING SCREWS.)

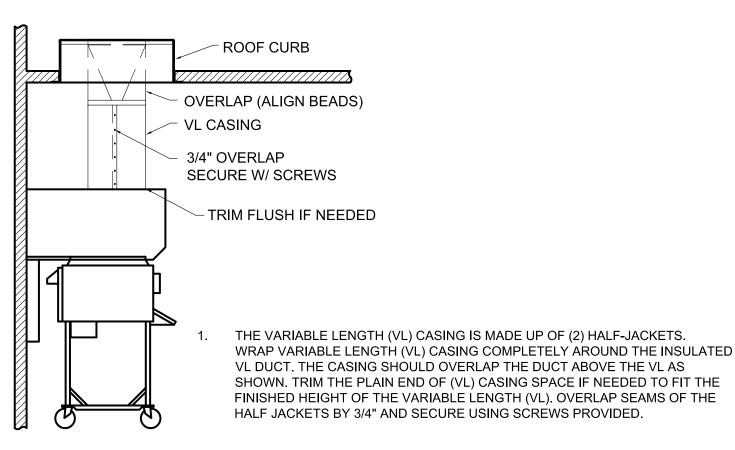STEP-8



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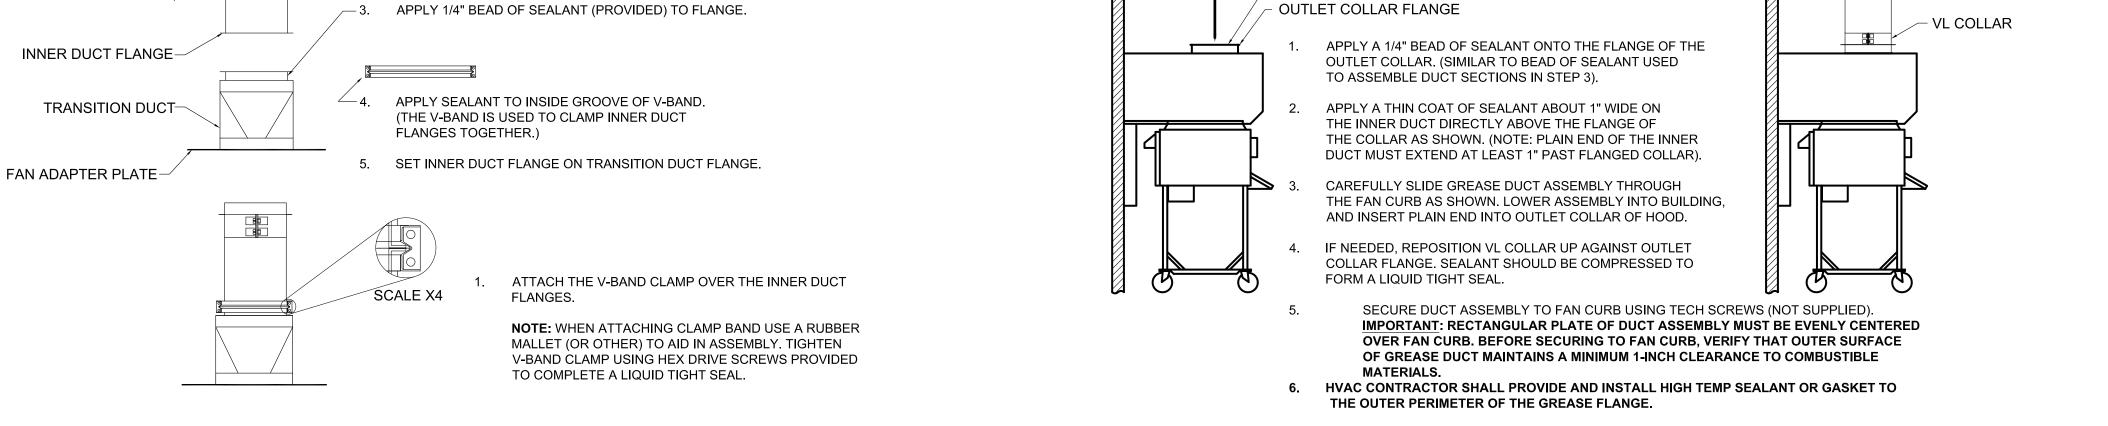
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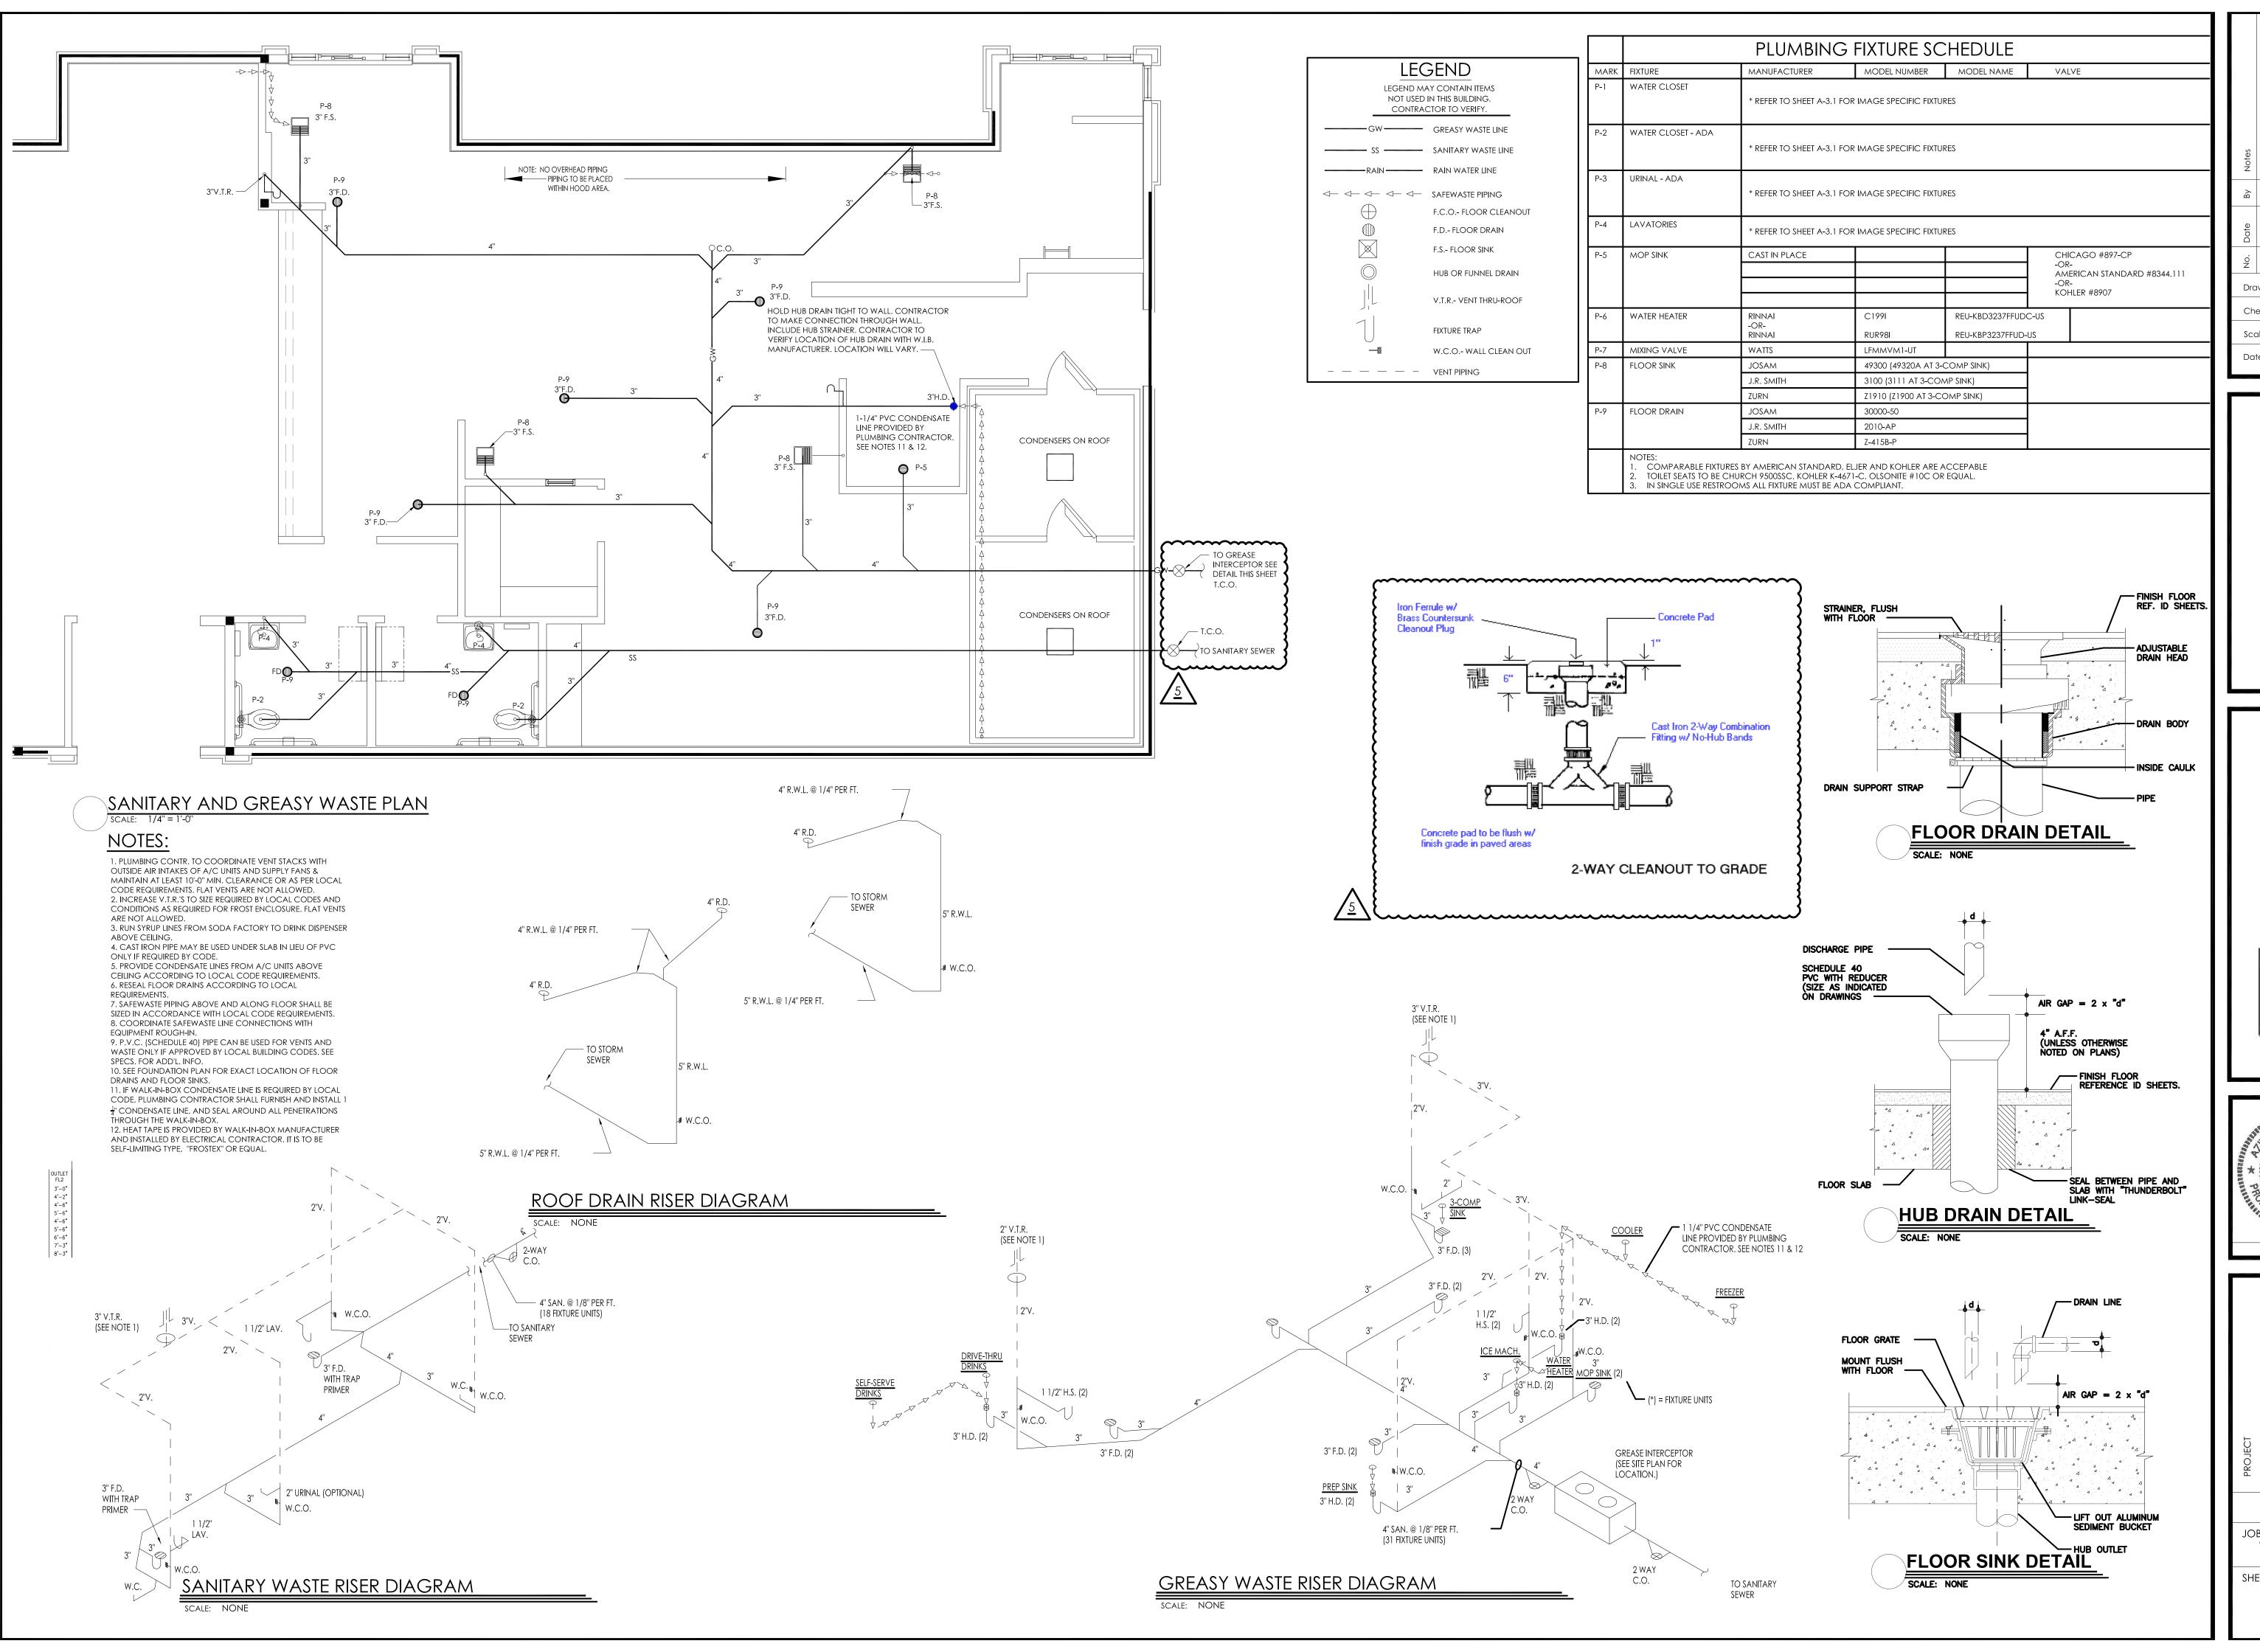






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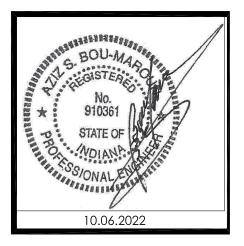




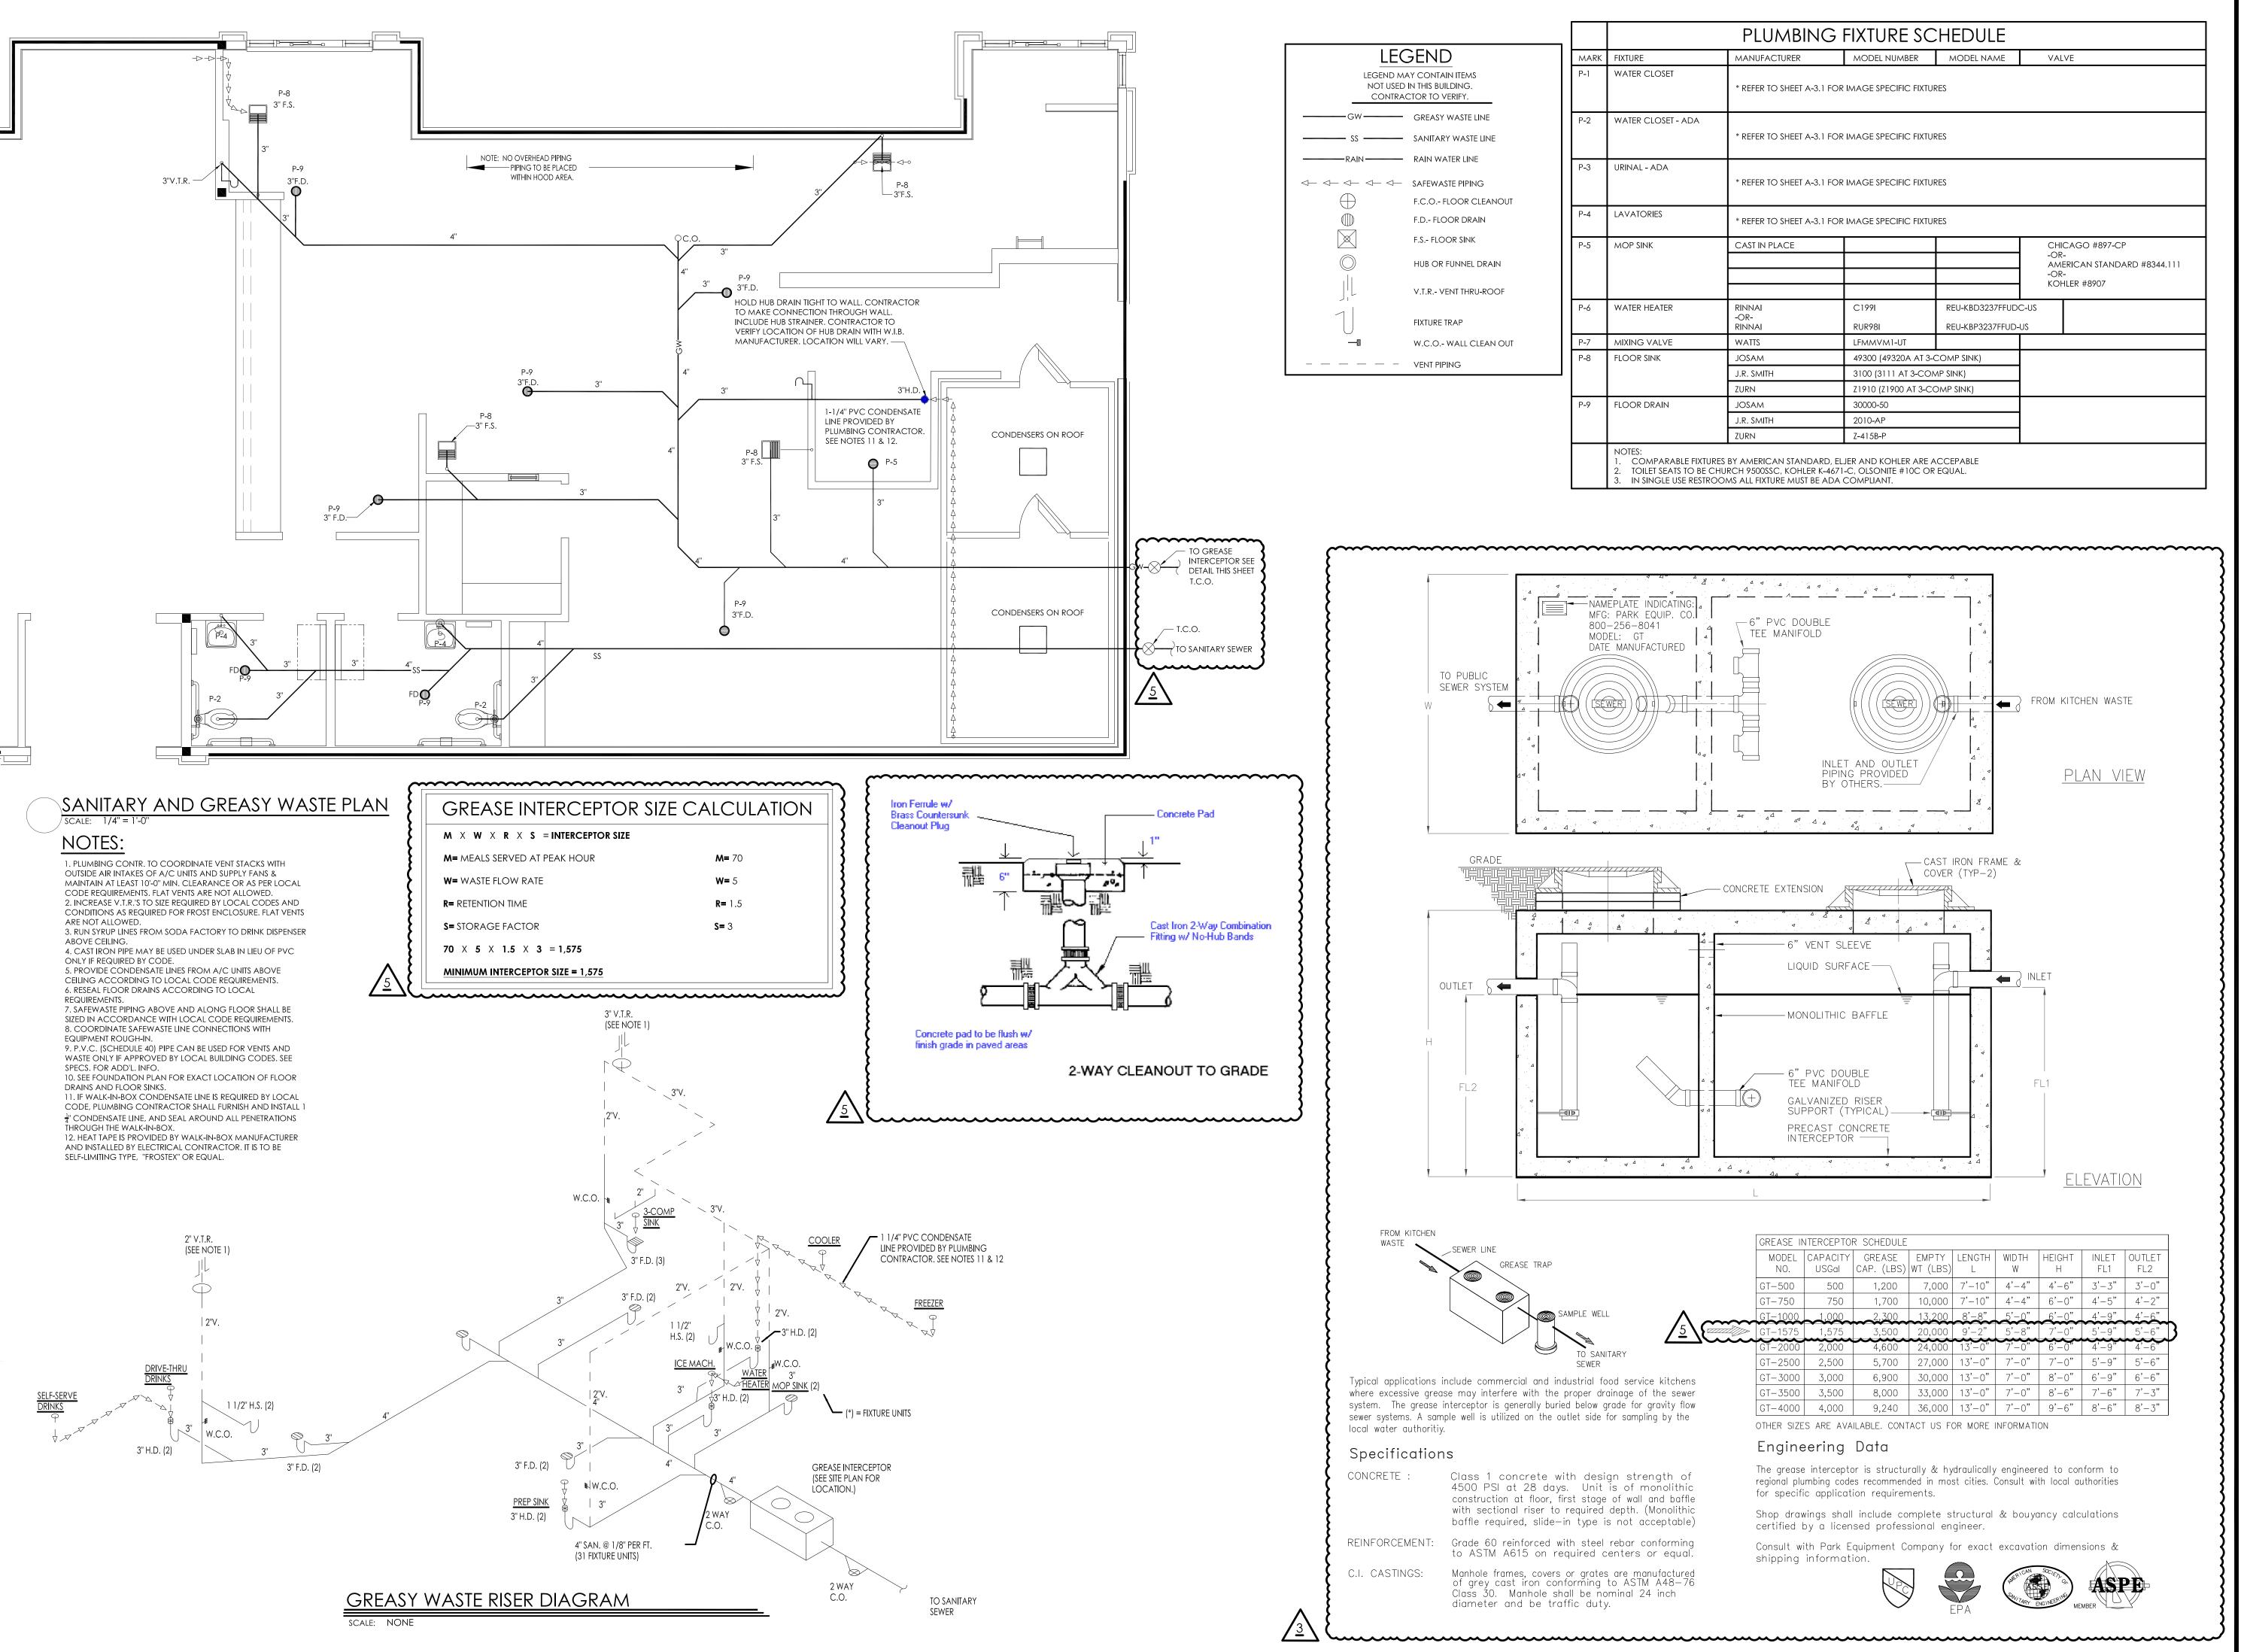
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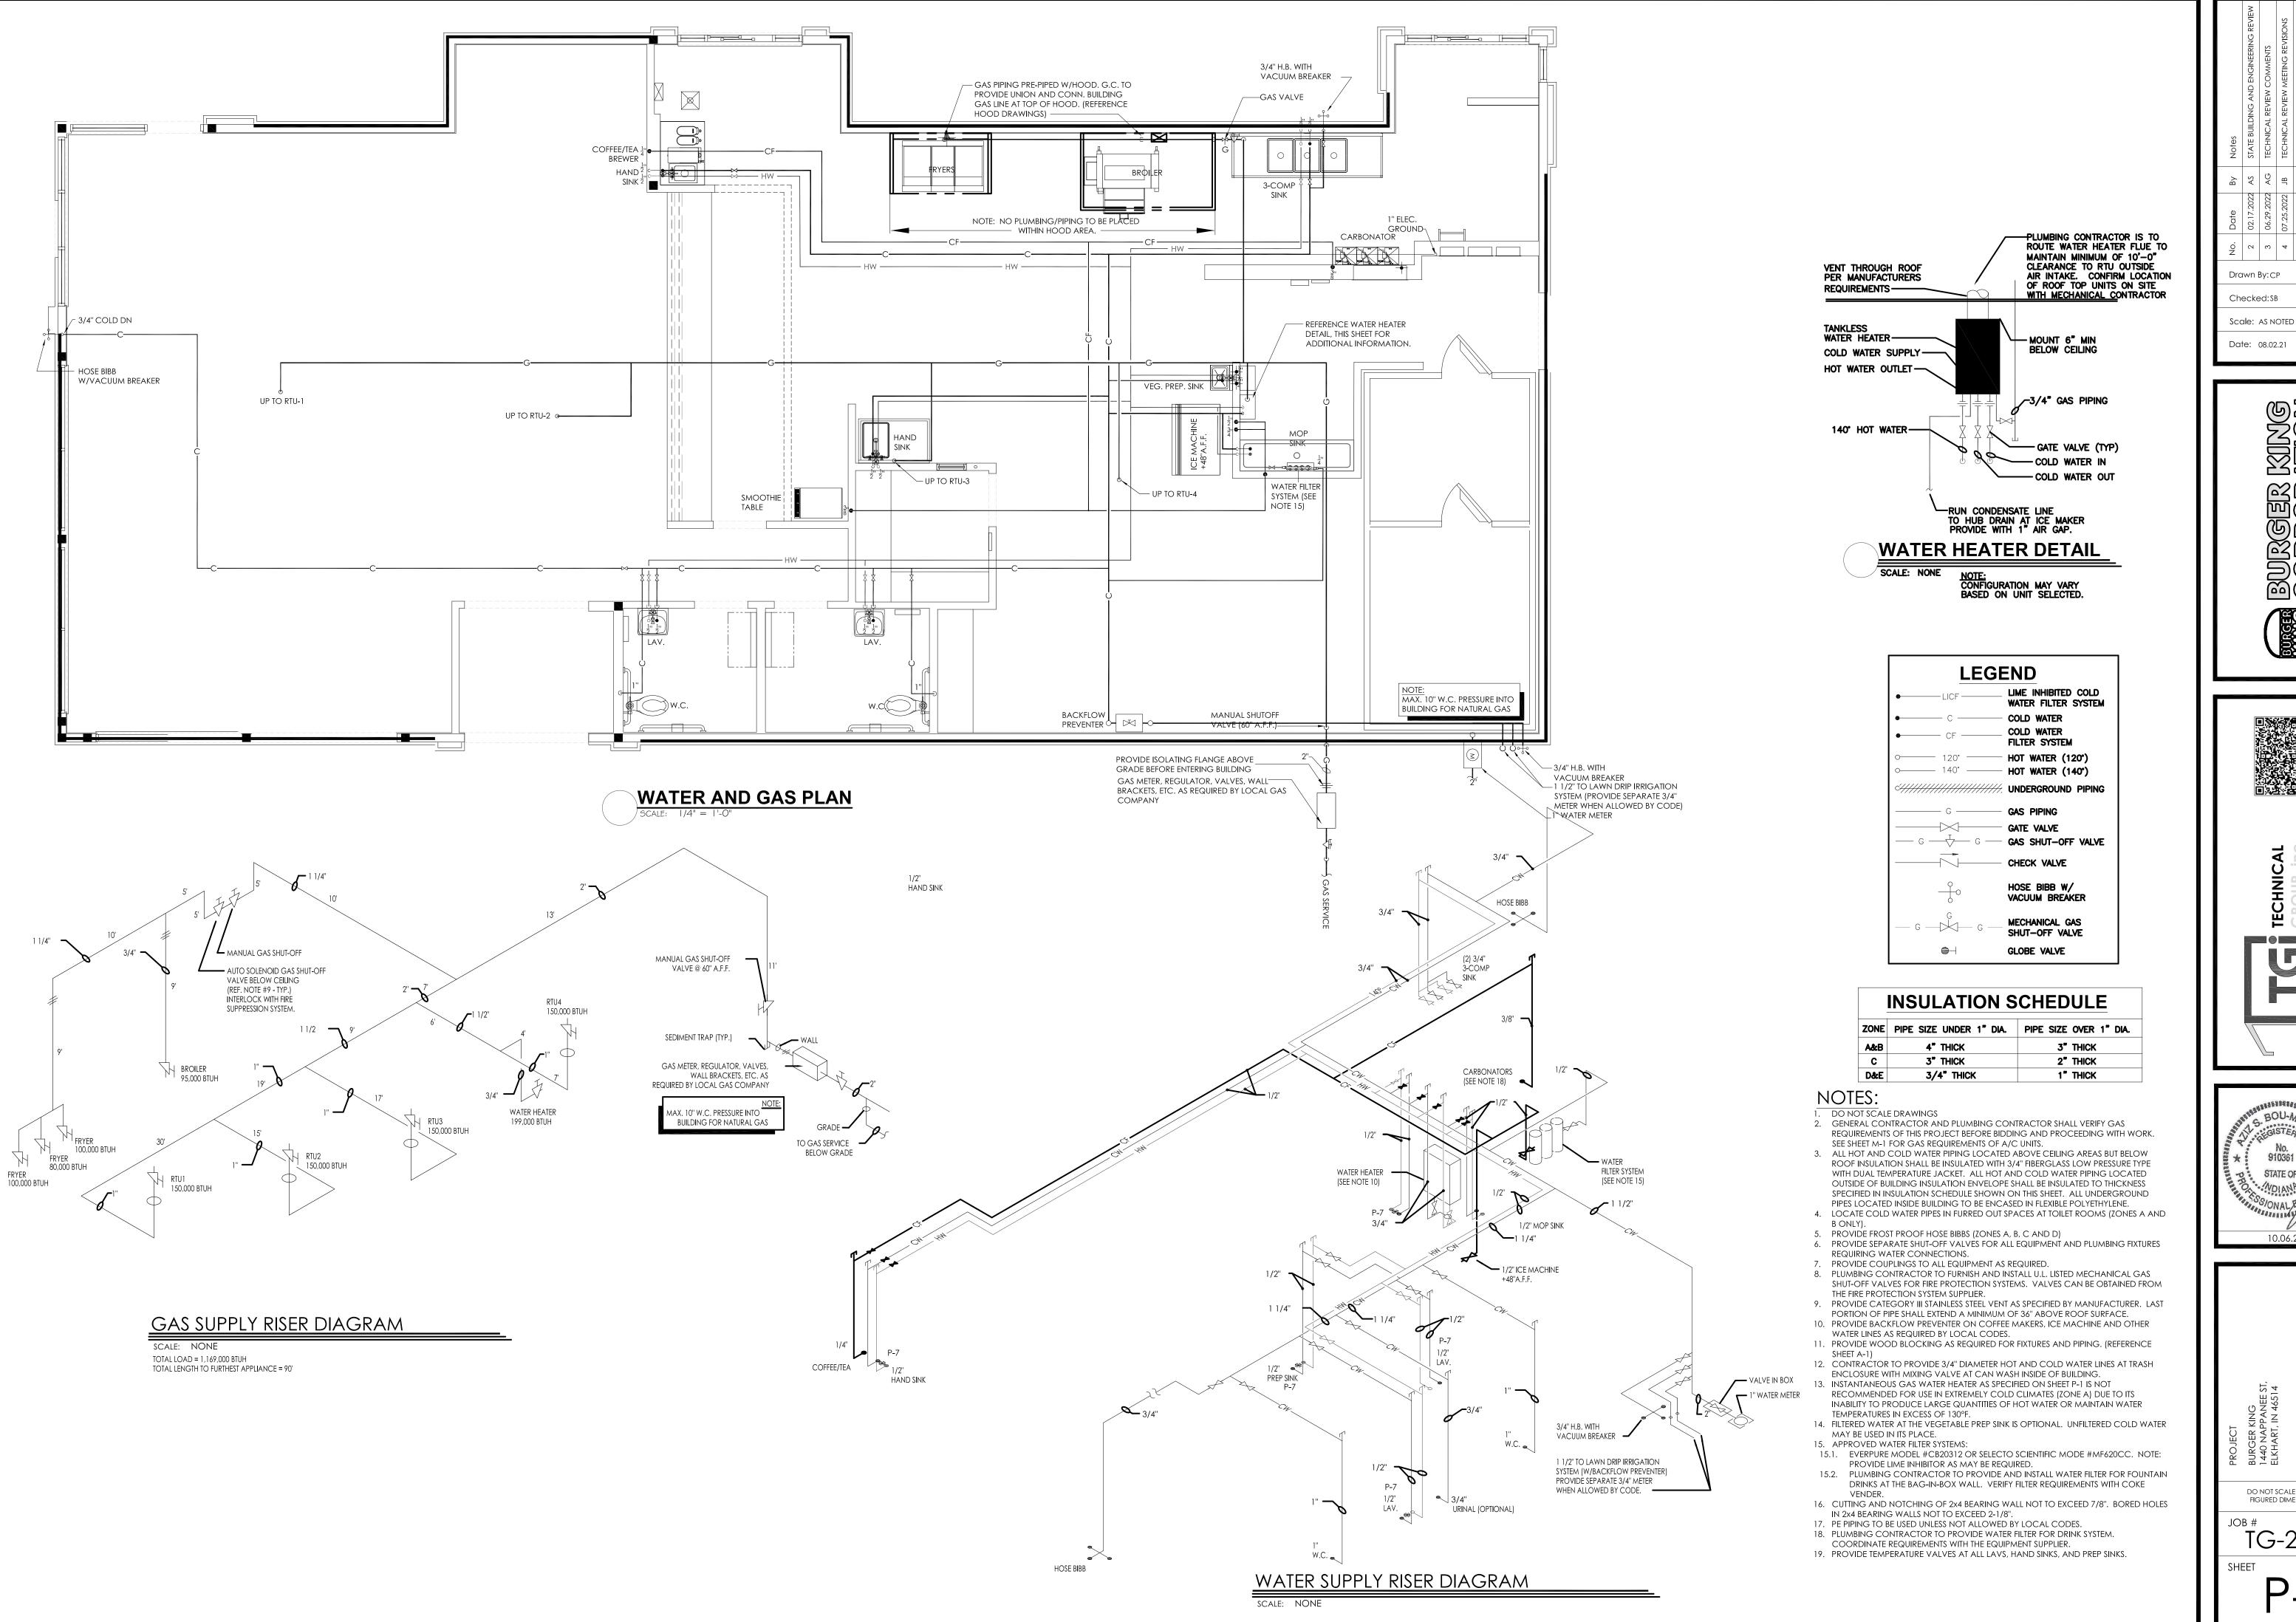


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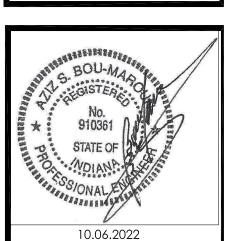
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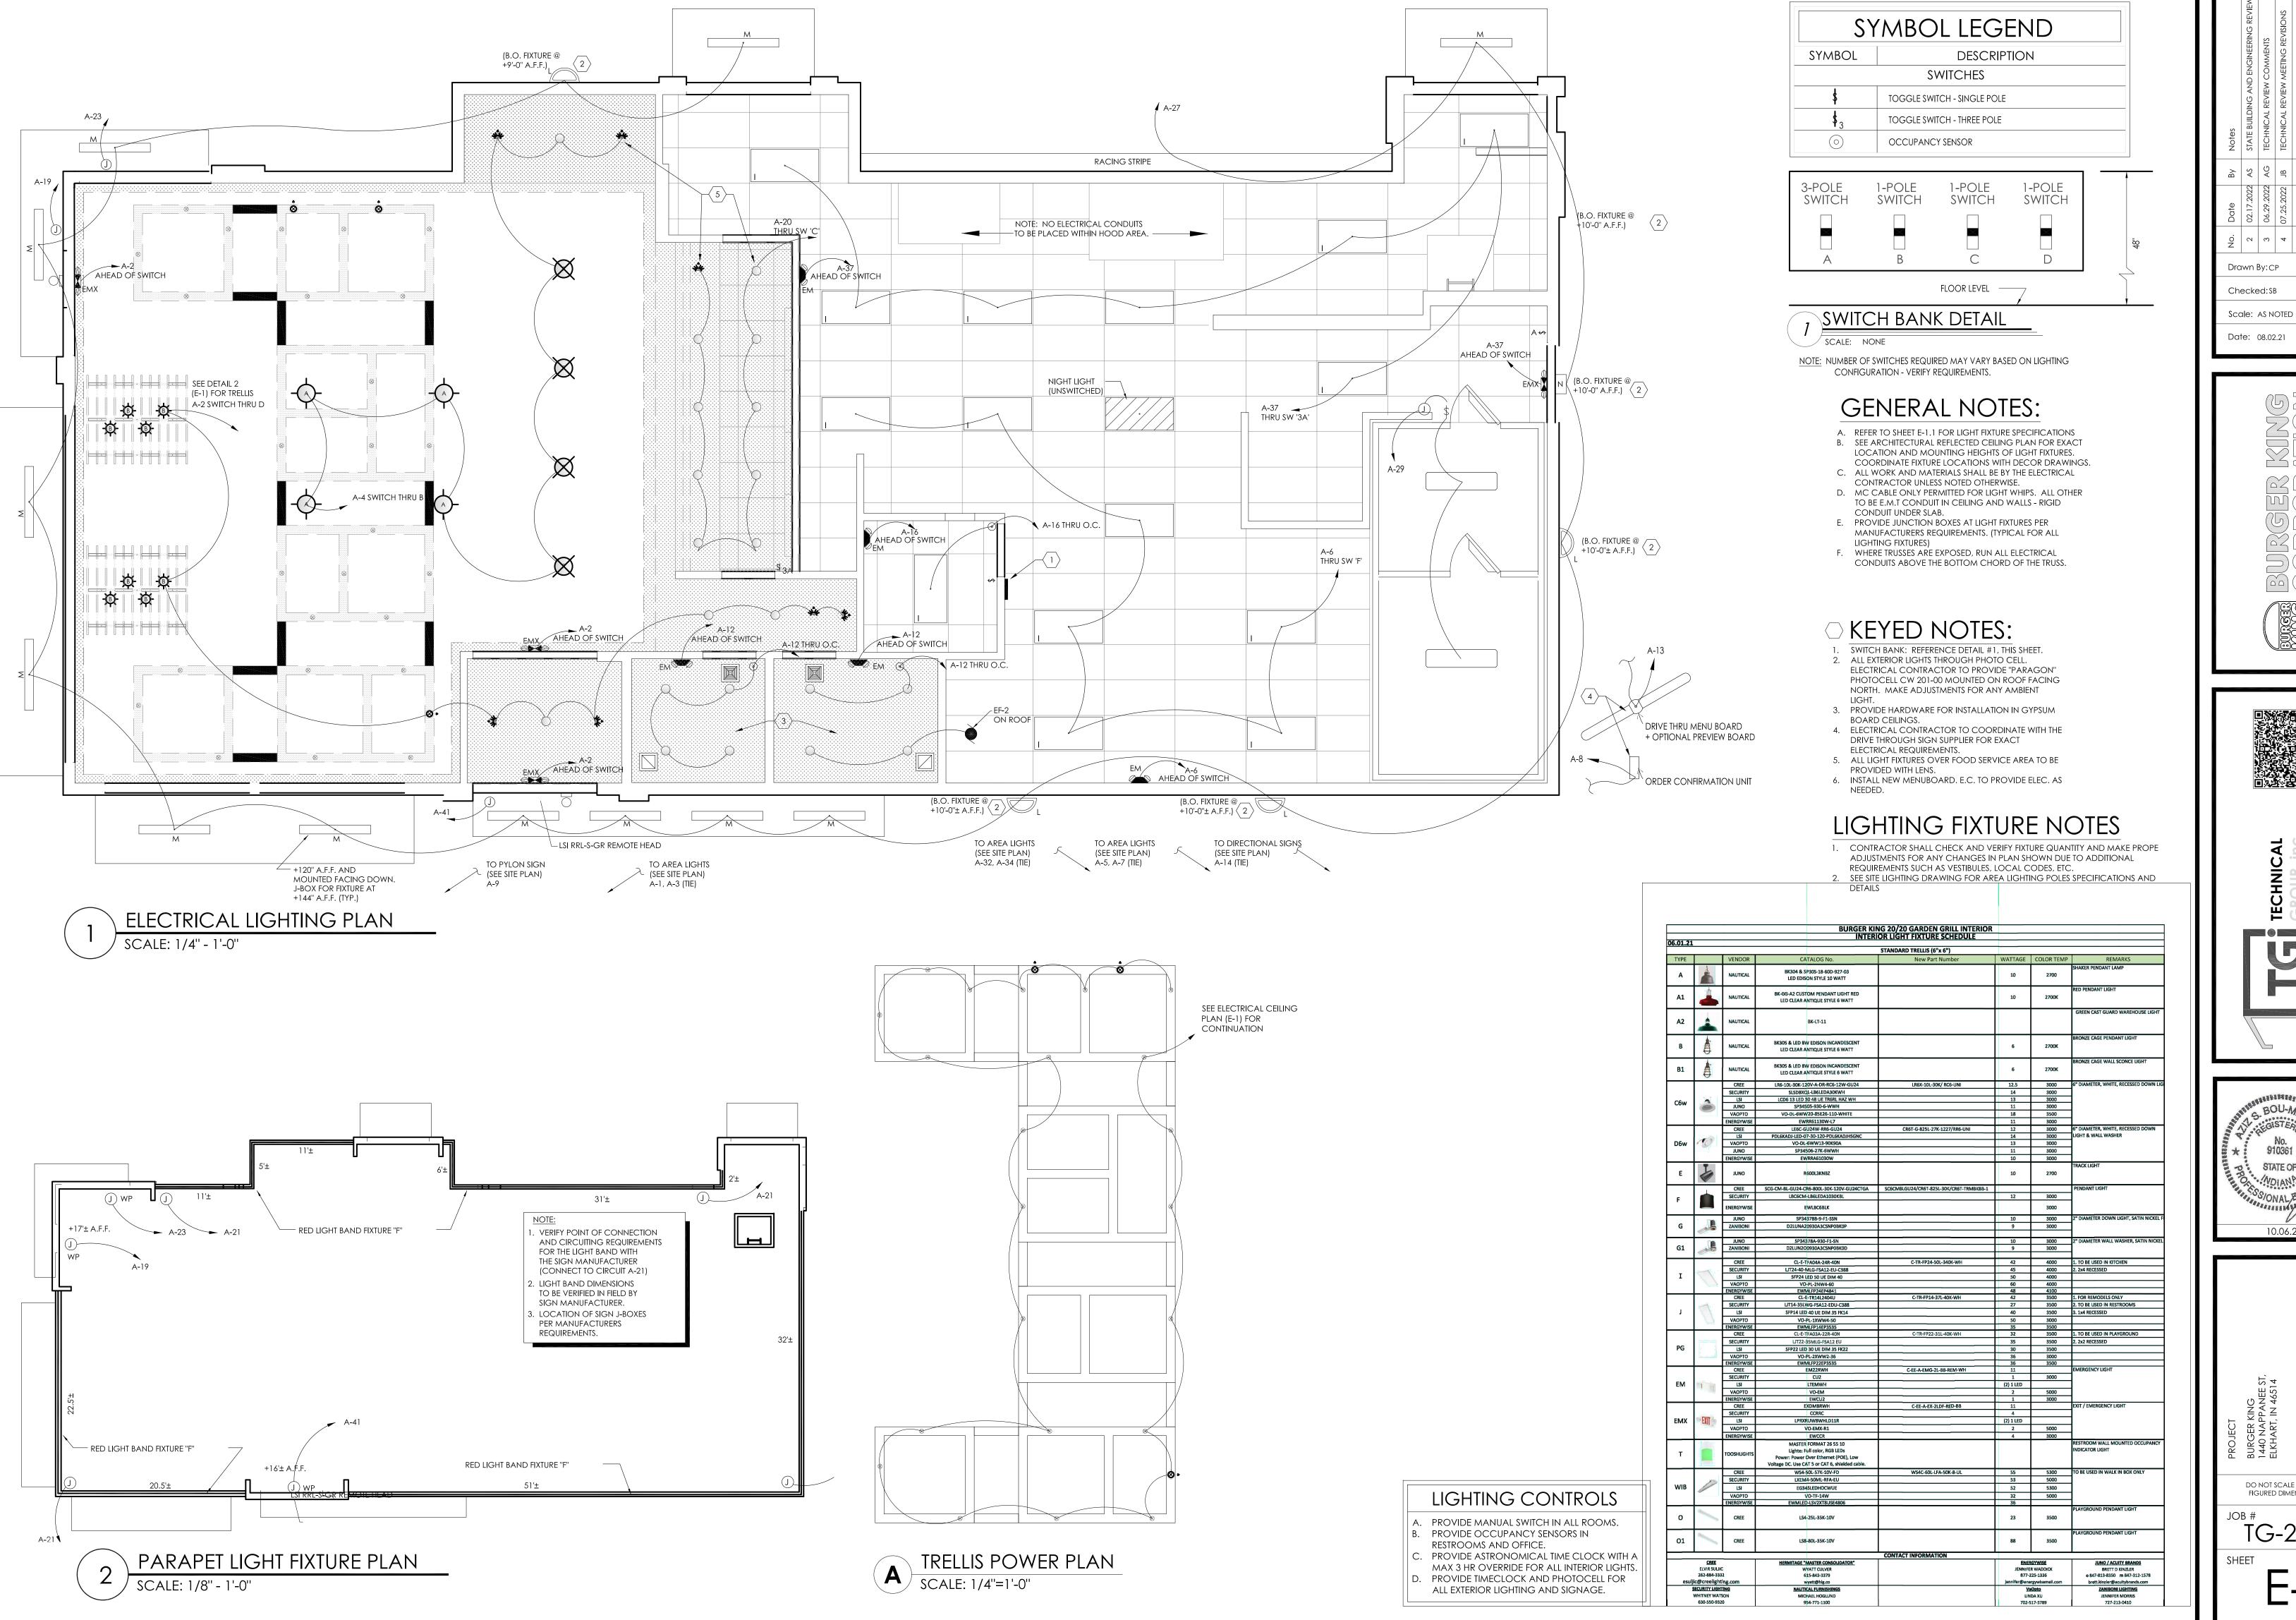




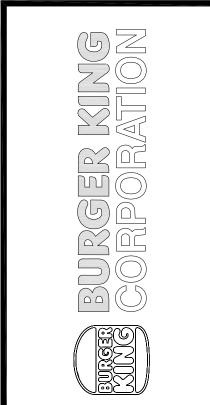


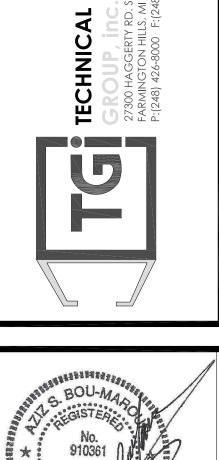
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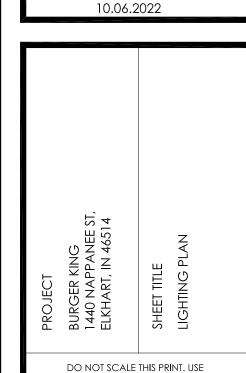
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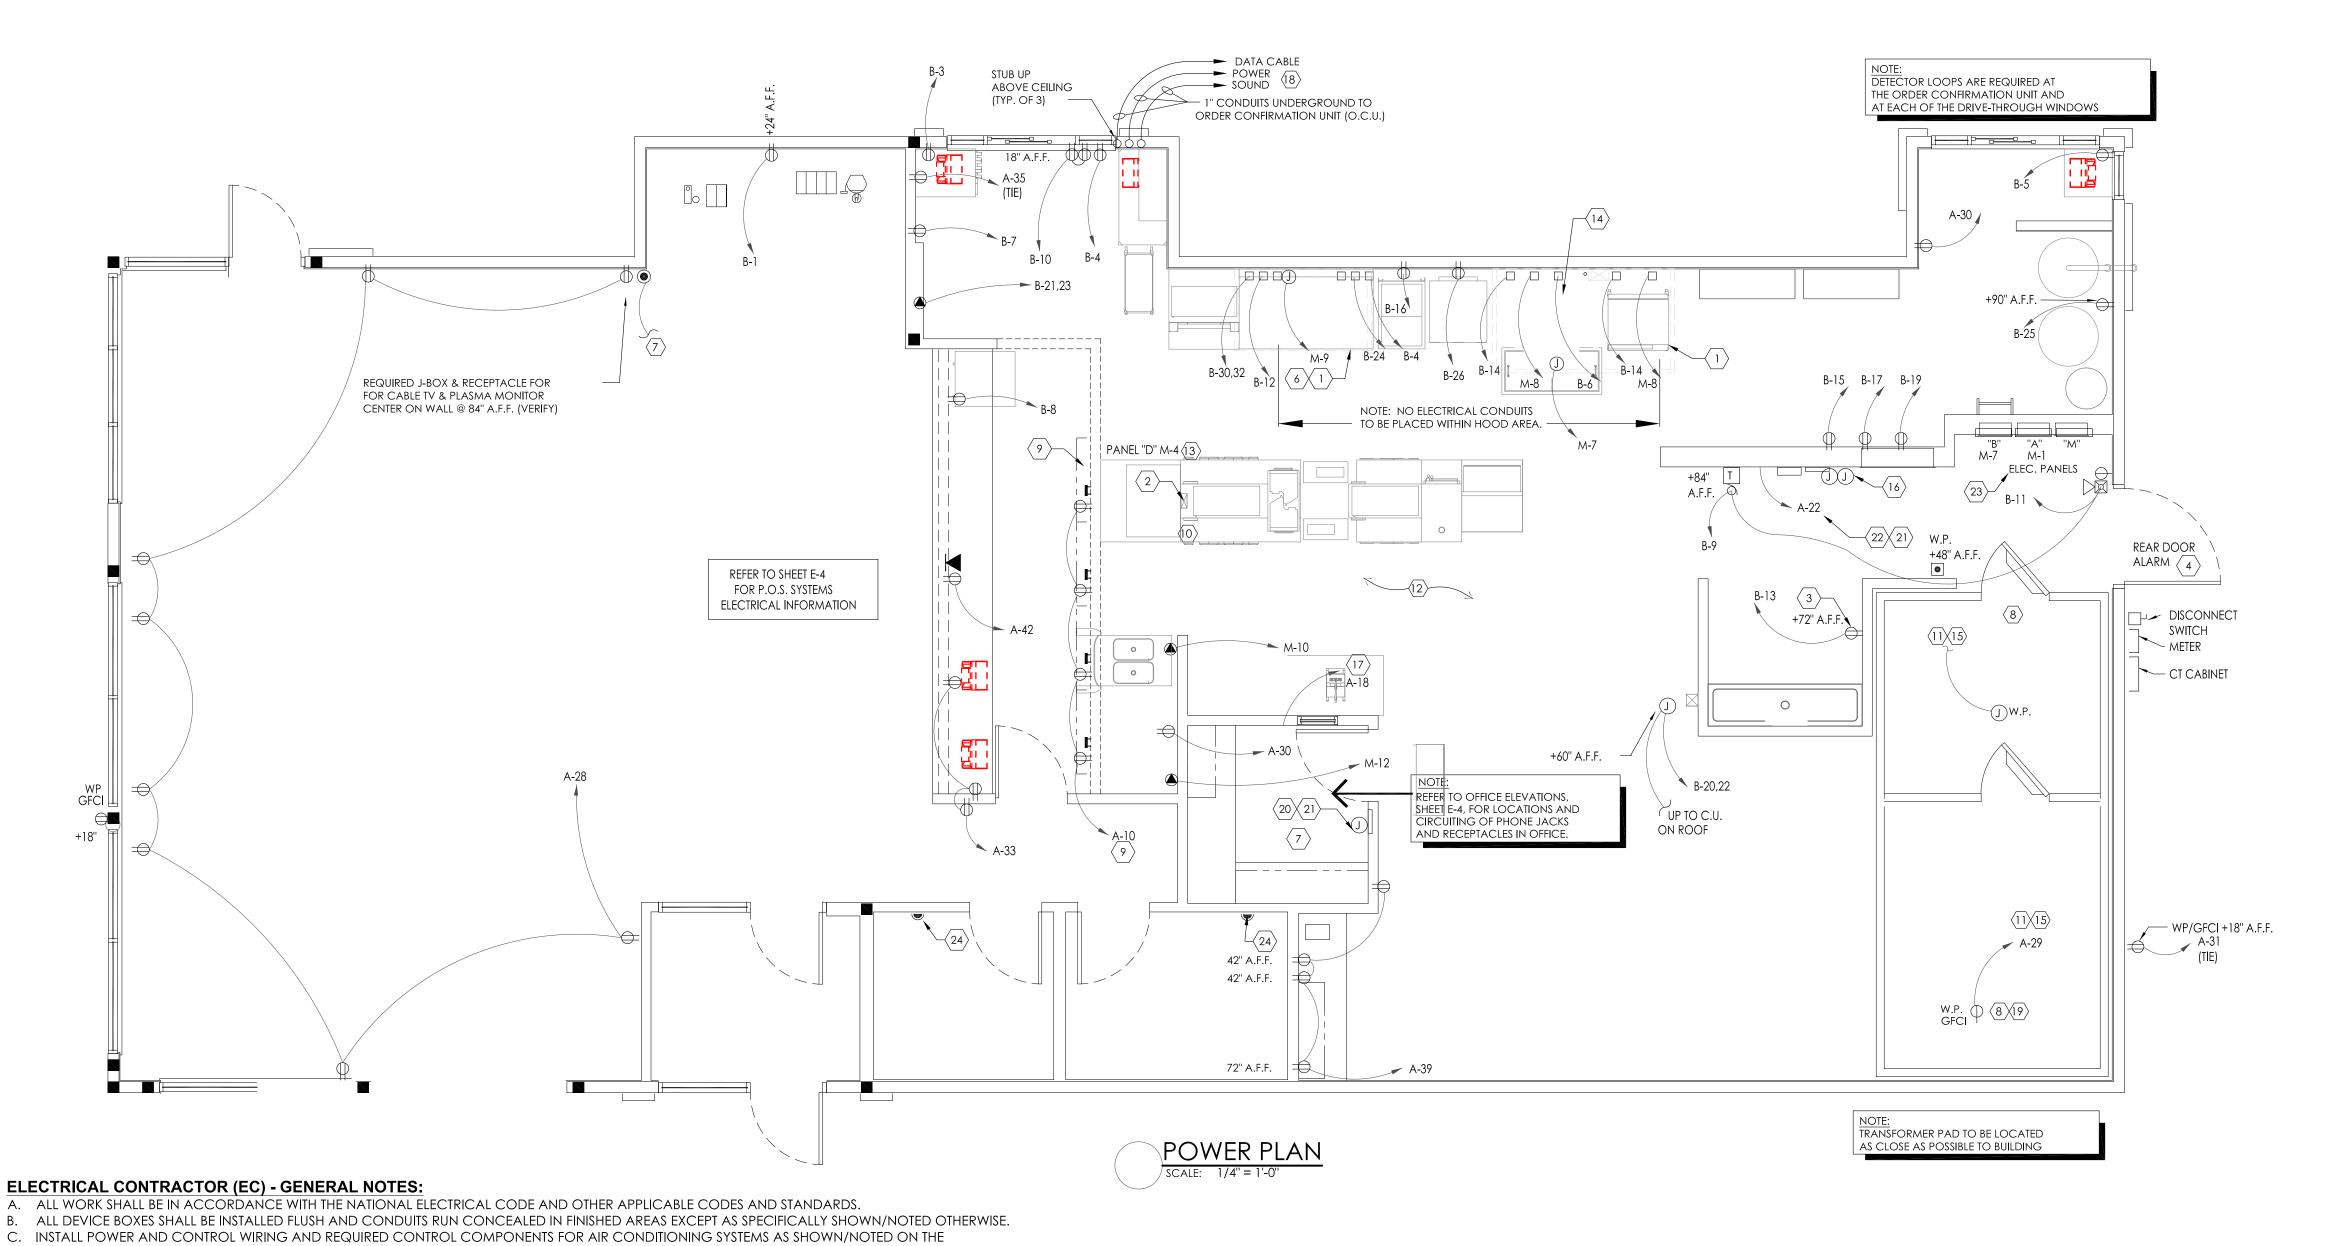




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SYMBOL LEGEND DETAIL **DESCRIPTION** TOGGLE SWITCH - SINGLE POLE HUBBELL #1221-I USHBUTTON SWITCH SINGLE RECEPTACLE HUBBELL #5361-I DUPLEX RECEPTACLE HUBBELL #5362-I 208V RECEPTACLE HUBBELL TELEPHONE OUTLET WITH BUSHED HOLE COVERPLATE JUNCTION OR GANG BOX CABLE TELEVISION OUTLET BUZZER / BELL REAR DOOR ALARM TRANSFORMER


	ABBREVIATIONS
A-3	CONDUIT RUN WITH ARROW DENOTING HOMERUN. SUBSCRIPT INDICATES PANEL AND CIRCUIT NO. GROUND CONDUCTOR REQUIRED IN ALL CONDUITS BUT NOT INDICATED
GFCI	GROUND FAULT CIRCUIT INTERRUPTING
W.P.	WEATHERPROOF
A.F.F.	ABOVE FINISHED FLOOR.
I.G.	ISOLATED GROUND

- 1. FRYER HOOD: PRE-WIRED (WITH RECEPTACLES BY HOOD MANUFACTURER. ELECTRICAL CONTRACTOR TO MAKE CONNECTION AT JUNCTION BOX AT THE TOP OF THE HOOD. BROILER HOOD: PRE-WIRED (WITH DUPLEX RECEPTACLES) BY HOOD MANUFACTURER. ELECTRICAL CONTRACTOR TO MAKE CONNECTION AT JUNCTION BOX AT THE TOP OF THE HOOD. ELECTRICAL
- 2. ELECTRICAL CONTRACTOR TO RUN CONDUITS AND WIRE THROUGH THE EQUIPMENT CHASE AND
- VERIFY POWER REQUIREMENTS FOR SELECTED WATER HEATER. 4. REAR DOOR ALARM: "MONITOR 4000" BY SECURITY PRODUCTS, INC. OR APPROVED EQUAL. MOUNT
- SIMPLEX RECEPTACLE FOR POWER SUPPLY 6" ABOVE CEILING PERMANENTLY CONNECTED KITCHEN EQUIPMENT NOT SUPPLIED WITH ON/OFF UNIT SWITCH (WHICH IS PART OF THE APPLIANCE) TO SERVE AS A DISCONNECTING MEANS. UNIT SHALL BE SUPPLIED WITH A
- DISCONNECT AS PER N.E.C., FURNISHED BY THE ELECTRICAL CONTRACTOR. 6. G.C. TO VERIFY ELECTRICAL REQUIREMENTS FOR FIRE SUPPRESSION SYSTEM AND AUTO-SELENOID GAS
- 9. DIGITAL MENU BOARDS (VERIFY 3 OR 4 BOARD INSTALLATION): PROVIDE (1) DUPLEX RECEPTACLE FOR 120V CIRCUIT AND (1) P-RING FOR DATA CABLE AT EACH MENU BOARD SCREEN. REFER TO DETAIL,
- 10. STAINLESS STEEL SERVICE CHASE TO CEILING FURNISHED BY THE EQUIPMENT MANUFACTURER. 11. CONTRACTOR SHALL OBTAIN WIRING DIAGRAM FROM THE WALK-IN BOX MANUFACTURER AND
- MANUFACTURER'S INSTALLATION PERSONNEL
- 14. ELECTRICAL CONTRACTOR TO PROVIDE CORD AND PLUG AND WIRE TO BROILER BASED ON
- 15. CONTRACTOR SHALL COORDINATE CONDUIT RUN BETWEEN FREEZER/COOLER EVAPORATORS AND ROOF-TOP REFRIGERATION UNIT WITH THE MANUFACTURER'S FURNISHED WIRING HARNESS.
- CEILING FOR AMEREX PULL STATION AS REQUIRED BY EQUIPMENT SUPPLIER.
- 18. (3) 1"Ø CONDUIT TO BASE OF DRIVE-THROUGH ORDER STATION FOR DRIVE-THROUGH
- 19. 6" BELOW CEILING FOR CONDENSATE DRAIN LINE TAPE HEATER.
- 20. TO MASTER RELAY PANEL. REFER TO SHEET E-5
- 22. MASTER CONTACTOR PANEL. REFER TO SHEET E-5 AND NOTE #23, BELOW.
- 23. SWITCH GEAR OPTION #1:
- HILL PHOENIX INTEGRATED WALL UNIT INCLUDES PANELS 'A', 'B', 'M' AND MASTER CONTACTOR PANEL IN ONE CABINET. UNIT TO BE SURFACE MOUNTED ON 4" HIGH CONCRETE CURB. REFERENCE SHEET E-3
- AND E-5 FOR ADDITIONAL INFORMATION. 24. PROVIDE VISUAL STROBE ALARM MOUNTED AT 80" A.F.F. TIE TO H.V.A.C. SMOKE ALARM SYSTEM.


- CONTRACTOR TO PROVIDE RECEPTACLE AND COVER PLATE FOR THE OVEN AND BROILER BASED ON
- CONNECT TO CIRCUITS PROVIDED IN THE JUNCTION BOX BY EQUIPMENT MANUFACTURER.
- 7. RUN 2" CONDUIT TO MANAGERS OFFICE FOR CABLE TV.
- 8. HEAT TAPE IS PROVIDED BY THE WALK-IN BOX MANUFACTURER AND INSTALLED BY THE ELECTRICAL CONTRACTOR. CONTRACTOR SHALL COORDINATE INSTALLATION AND SUPPLY 120V CIRCUIT AND RECEPTACLE AS DIRECTED BY BOX MANUFACTURER.
- **INSTALL AS DIRECTED** 12. CONTRACTOR SHALL COORDINATED EQUIPMENT INSTALLATION WITH THE EQUIPMENT
- 13. PRE-WIRED BRANCH CIRCUITS DISCONNECTED FOR SHIPMENT TO BE RE-CONNECTED BY GC PER MANUFACTURER'S INSTALLATION SPECIFICATIONS.
- 17. SMOKE DETECTOR ALARM PANEL: REFER TO SHEET M-1 FOR LOCATION OF A/C UNITS SMOKE
- COMMUNICATIONS SYSTEM, SOUND, DATA AND POWER.
- 21. MANUAL ON-OFF CONTROL PANEL. REFER TO SHEET E-5
- RECESS ELECTRICAL CONTACTOR PANEL & PANELS 'A', 'B', & 'M' IN FURRED OUT WALL ADJACENT TO EXTERIOR FRAMING. G.C. TO VERIFY PANEL SIZES PRIOR TO FURR-OUT TO INSURE ADEQUATE SPACE.

KEYED NOTE - ROOF:

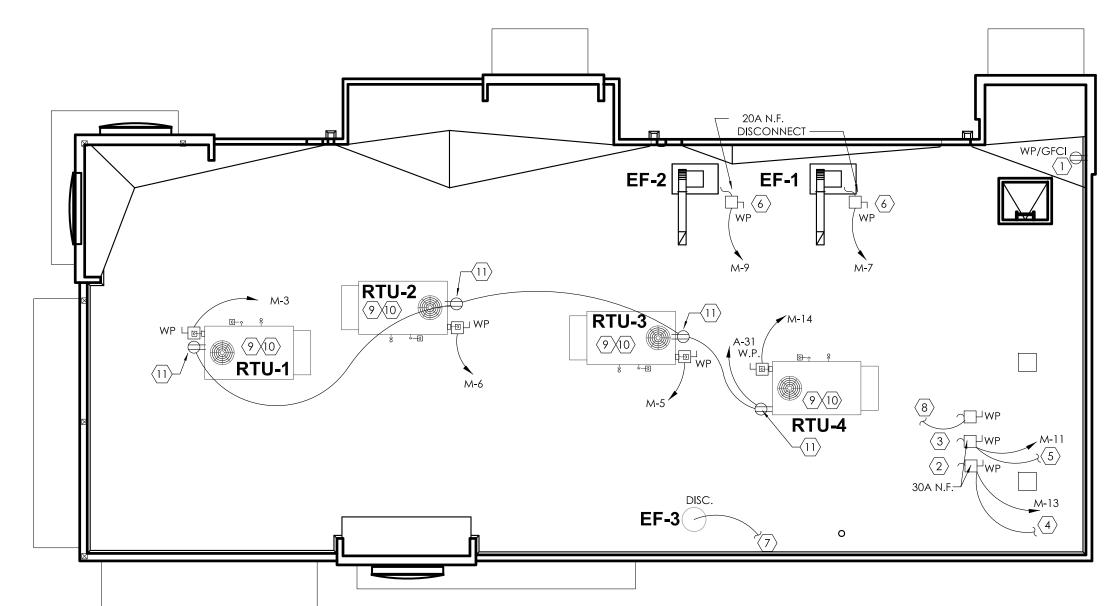- (1) OPTIONAL WEATHERPROOF OUTLET 30" A.F.R. FOR TV VIDEO CAMERA. RUN CONDUIT TO BLDG. INT., VERIFY SIZE AND LOCATION WITH OWNER.
- REMOTE COOLER COMPRESSOR CONDENSING UNIT.
- TO FREEZER EVAPORATOR.
- STUB-UP CONDUIT ADJ. TO ROOF CURB AND PROVIDE SEAL TIGHT CONNECTION TO DISCONNECT WITH SUFFICIENT SLACK TO ALLOW REMOVAL OF FAN FOR SERVICING.
- \langle 7 \rangle for continuation, see lighting plan, sheet e-1.
- SEE ELECTRICAL RISER SHEET E-3 FOR ELECTRICAL REQUIREMENTS TO MECHANICAL EQUIPMENT
- CONTROL PANEL. SEE SHEET E-5.
- ELECTRICAL CONTRACTOR.



ELECTRICAL ROOF POWER PLAN

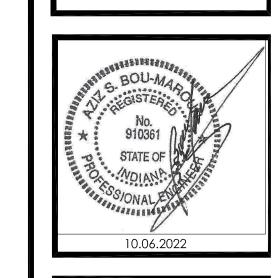

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- REMOTE FREEZER COMPRESSOR CONDENSING UNIT.
- TO COOLER EVAPORATOR.
- \langle 8 \rangle DOWN TO ICE MACHINE.
- $\langle 10 \rangle$ Run Control wires via master relay
- (11) 120V/1Ø WATER PROOF, GFCI RECEPTACLE BY

A. EC TO PROVIDE AND INSTALL A HEATING ELEMENT ON THE COOLER AND FREEZER CONDENSATE DRAIN LINES. B. EC TO CONNECT THE PRIMARY ELECTRICAL SERVICE TO THE CONDENSING UNITS AND INTER-WIRE TO THE EVAPORATOR COIL(S), CONTROLS, LIGHTING FIXTURES AND DOOR PERIMETER HEATERS.

DRAWINGS AND PER OTHER APPLICABLE DRAWINGS/INSTRUCTIONS. REFERENCE MECHANICAL DRAWINGS.

G. ALL CONDUCTORS SHALL BE RUN IN CONDUIT, EXCEPT LOW VOLTAGE CONTROL AND COMMUNICATIONS CABLES.

M. NEW TYPEWRITTEN PANEL DIRECTORY SHALL BE FURNISHED AFTER JOB IS COMPLETED REFLECTING ALL AS BUILT CONDITIONS.

S. EC TO COORDINATED ROUGHING-IN TO ALL EQUIPMENT WITH EQUIPMENT SUPPLIER PRIOR TO INSTALLING CONDUITS.

U. MAINTAIN 12" CLEARANCE BETWEEN P.O.S. COMMUNICATION CONDUITS AND LIGHTING FIXTURES AS WELL AS POWER CONDUITS...

SHALL BE THW, UNLESS NOTED OTHERWISE.

F. ALL CONDUCTORS SHALL BE COPPER.

H. ALL MATERIALS SHALL BE UL APPROVED.

E. WIRE (CONDUCTOR) COLORS SHALL BE AS PER APPLICABLE CODES.

J. PVC (SCHEDULE 40) PERMITTED BELOW SLAB AND BELOW GRADE ONLY.

P. FUSES SHALL BE DUAL ELEMENT, TIME DELAY TYPE UNLESS OTHERWISE NOTED.

T. ALL CONDUIT RUNS TO KITCHEN EQUIPMENT SHALL BE RUN ABOVE CEILING.

C. EC SHALL FURNISH AND INSTALL DISCONNECTS FOR AIR CONDITIONING UNITS.

ELECTRICAL CONTRACTOR (EC) - KITCHEN EQUIPMENT:

ELECTRICAL CONTRACTOR (EC) - WALK-IN COOLER/FREEZER:

FROM CURBS AND PLACED ON ROOF FOR CLEANING EXHAUST DUCTWORK.

Q. EC SHALL VERIFY INTERIOR DECOR THEME TO BE USED AND COORDINATE WITH SAID THEME.

L. ALL EMPTY CONDUITS TO BE PROVIDED WITH NYLON PULL STRING.

N. ALL BRANCH CIRCUITS SHALL BE PROPERLY PHASE BALANCED.

R. EC SHALL INSTALL AND CONNECT WIRING TO ALL SIGNS.

X. ALL P.O.S. OUTLETS TO BE DEDICATED CIRCUITS (ORANGE).

W. ALL B.O.H. & SERVICE AREA OUTLETS TO BE G.F.C.I.

ELECTRICAL CONTRACTOR (EC) - H.V.A.C.:

BE SUPPLIED AND COMPLETED BY THE EC.

SERVICE CHASE PROVIDE WITH THE EQUIPMENT.

MANUFACTURER'S INSTRUCTIONS.

WITH THESE DRAWINGS.

OF AIR CONDITIONING UNITS.

ELECTRICAL PLANS.

GROUNDING CONDUCTOR SIZED AS PER NEC 250-122.

D. WIRE SIZE SHALL BE #12 (MINIMUM) UNLESS OTHERWISE NOTED. WIRE SIZES SMALLER THAN #6 AWG SHALL BE THHN/THWN. #6 AWG WIRE AND LARGER

I. ALL BRANCH CIRCUITS, EXCEPT INTERIOR LIGHTING, EXTERIOR BUILDING SIGNS, PARAPET LIGHTING AND SOFFIT LIGHTING TO HAVE A GREEN EQUIPMENT

K. IT IS INTENDED THAT AN EQUIPMENT GROUND CONDUCTOR (GREEN) SHALL BE RUN IN POWER CIRCUIT CONDUITS WHETHER OR NOT THE CONDUIT IS PVC.

O. ALL DATA EQUIPMENT TO BE FED BY A DEDICATED CIRCUIT WHICH CONSISTS OF A POWER CIRCUIT THAT FEEDS THIS TYPE OF EQUIPMENT ONLY WITH A

V. CUTTING AND NOTCHING OF 2x4 BEARING WALL FRAMING NOT TO EXCEED 7/8". BORING HOLES IN 2x4 BEARING WALL FRAMING NOT TO EXCEED 2 1/8".

A. THE EC SHALL FURNISH AND INSTALL PITCH PANS FOR POWER AND CONTROL WIRING AND TO MAINTAIN 12" MINIMUM CLEARANCE FROM BACK PANEL

D. EC SHALL USE A MINIMUM OF 4'-6" SEALTITE FLEXIBLE CONDUIT WHEN WIRING KITCHEN HOOD EXHAUST FANS ON ROOF SO THAT FANS MY BE REMOVED

E. IF REQUIRED BY LOCAL CODE, EC SHALL PROVIDE COMPONENTS - AUDIBLE AND VISUAL ANNUNCIATORS AND SINGLE-GANG RECEPTACLES TEST STATIONS

WITH GREEN AND RED LIGHT INDICATORS. EACH KITCHEN UNIT WILL BE EQUIPPED AND THE FIRE AND MECHANICAL INSPECTORS WILL DETERMINE SUITABLE

LOCATION FOR TEST STATIONS. ANNUNCIATORS AND TEST STATION WILL BE LOOPED IN THE CIRCUITRY OF THE SMOKE DETECTION DEVICES. WIRING WILL

B. EC SHALL INSTALL ALL LOW-VOLTAGE CONTROL WIRING FOR ALL AIR CONDITIONING UNITS AND FANS. COORDINATE AIR CONDITIONING AND

A. EC TO PROVIDE AND INSTALL RECEPTACLES, CAPS AND CORDS AS REQUIRED. CAPS AND CORDS ARE TO BE INSTALLED ACCORDING TO THE

F. KITCHEN EQUIPMENT SUPPLIER DRAWINGS INCLUDE ONLY THOSE RECEPTACLES REQUIRED FOR SPECIFIC KITCHEN EQUIPMENT. REFER TO THE

E. WHERE RECEPTACLES ARE PROVIDED WITH THE EQUIPMENT, EC TO PROVIDE AND INSTALL ELECTRICAL SERVICE DOWN FROM ABOVE THROUGH THE

H. ALL PORTIONS OF WORK SHALL BE DONE IN ACCORDANCE WITH APPLICABLE LOCAL, STATE AND NATIONAL CODES, ORDINANCES AND STANDARDS.

NOTIFY THE KITCHEN EQUIPMENT SUPPLIER PROJECT MANAGER IMMEDIATELY OF COMPLIANCE WITH A LOCAL, STATE OR NATIONAL CODE IS IN CONFLICT

B. EC TO CONNECT ELECTRICAL SERVICE DIRECTLY TO EQUIPMENT ACCORDING TO THE MANUFACTURERS'S INSTRUCTIONS.

ARCHITECTS/ENGINEERS ELECTRICAL DRAWINGS FOR LOCATIONS OF UTILITY AND GENERAL PURPOSE RECEPTACLES.

D. WHERE EQUIPMENT IS NOT PRE-WIRED, EC TO CONNECT THE ELECTRICAL SERVICE AND PROVIDE INTER-WIRING AS REQUIRED.

C. EC TO RECONNECT ELECTRICAL CIRCUITS ON PRE-WIRED EQUIPMENT DISASSEMBLED FOR SHIPMENT.

G. EC TO VERIFY THE UTILITY REQUIREMENTS FOR ITEMS NOT PROVIDED BY THE KITCHEN EQUIPMENT SUPPLIER.

SEPARATE GREEN GROUNDING CONDUCTOR CARRIED ALL THE WAY BACK TO THE PANEL TO BE CONNECTED TO THE GROUNDING SYSTEM.

PANEL: A		9	SERVIC	E: 120	0/208V,	3P, 4V	/ +	GND	FEEDE	ERS: SEE ON	NE LINE D	AGRAM
PANEL TYPE: SQ-D "NQOD" OR	EQUAL	E	BUS R	ATING:	200	A M.L.O).		MOUN	ITING: NEM/	A-1 RECES	SSED
LOAD DESCRIPTION	NOTE	LOAD VOLT-AMP	WIRE	СВ/Р	A	ВС		CB/P	WIRE	LOAD VOLT-AMP	NOTE	LOAD DESCRIPTION
AREA LIGHTS **		1080	10	20/2	1		\sim	2 20/1	12	750		DINING RM. LIGHTS
		1080	10		3			4 20/1	12	810		DINING RM. LIGHTS
AREA LIGHTS **		1080	10	20/2	5			6 20/1	12	1500		KITCHEN AREA LIGHTS
		1080	10	1 1	7		<u></u>	B 20/1	12	720		OCU / CREDIT CARD SWIPE
PYLON SIGNS * **		1200	12	20/1	9		\sim 1	0 20/1	12	900		DIGITAL MENU BOARD #94A
SPARE					11			2 20/1	12	400		RESTROOM LIGHTS/EF-2
DRIVE-THRU MENU SIGNS		720	12	20/1	13			4 20/1	12	720		DIRECTIONAL SIGNS
SPARE				20/1			\sim 1	6 20/1	12	45		OFFICE LIGHTS
SPARE				20/1				8 20/1	12	360		SMOKE DETECTOR ALARM PANEL
_OGO **		1200	12	20/1	19			20/1	12	130		SERVICE AREA LIGHTS
PARAPET LIGHT BAND **		240	10	20/1	21			2 20/1	12	720		RELAY PANEL
CHANNEL LETTERS / LOGO **		1200	12	20/1				24				SPARE
SPARE				20/1				26 20/1	12	180		TELEPHONE REC.
EXTERIOR BUILDING LIGHTS **		1475	12	20/1	27			20/1	12	660		DINING RECEPTACLE
COOL/FRZR LIGHTS/DOOR HTR/HE.		400	12	20/1	29			20/1	12	360		KITCHEN RECEPTACLES
ROOF/EXTERIOR RECEPTACLES		720	12	20/1	31			20/2		1080		AREA LIGHTS **
SPARE SPARE				20/1				34		1080		
D/T SPEED/SERVICE #90C CAMERA		540	12	20/1	35			36 20/1	12	720		OFFICE RECEPTACLES
KITCHEN AREA LIGHTS		1200	12	20/1				8 20/2	12	1500		VESTIBULE DUCT HEATER ***
CREW/STORAGE RECEPTACLES		540	12	20/1	39			Ю	12	1500		
LOGO **		1200	12	20/1	41			2 20/1	12	300		SAFE #70
TOTAL CONNECTED LOAD: TOTAL CONNECTED AMPS:	29,390 81.6 A		PHASE PHASE		11080 10250	V A -	NOTE	(i	HACR) = LO) =	WIRE THROUGH HACR TYPE LOCKED BREE CROUND FAL	BREAKER. AKER	CTOR. T INTERRUPTER
PANEL 'A' NOTES: 1. ** ELECTRICAL CONTRACTOR TO V 2. ALL BREAKERS SHALL BE RATED 3. * VERIFY CIRCUIT REQUIREMENTS	FOR SWIT	E CIRCUITS T	PHASE HRU MA	C': STER C	8060 CONTACTO	VA OR PAN	EL.			* WIRE SEPARATION DIAGRAMS	ATE TO ISO S SHEET E	DLATED GROUND BUS. -5.

PANEL: B			SERVIC		·	′208V,	3P, 4	W +	GND		ERS: SEE 0		
PANEL TYPE: SQ-D "NQOD	OR EQUA	L :	SIZE:	200 A	MP	MLO				MOUN	NTING: NEI	MA-1 RECI	ESSED
LOAD DESCRIPTION	NOTE	LOAD VOLT-AMP	WIRE	CB/F		A	ВС		CB/P	WIRE	LOAD VOLT-AMP	NOTE	LOAD DESCRIPTION
SELF-SERVE DRINK DISPENSER #10		600	12	20/1	1	\frown	++		20/1				SPARE
P.O.S. RECEPTACLES	IG/LO	1320	12	20/1	1 - 1		+ + ′		20/1				SPARE
P.O.S. RECEPTACLES	IG/LO	1320	12	20/1	5	$ \leftarrow $	+ + -		20/1	12	400		BROILER
DRIVE-THRU DRINK DISPENSER #11		600	12	20/1	7	$\sim \downarrow$	++-	─ [8	20/1	12	1200		U/C REFRIGERATOR #53
REAR DOOR BUZZER		720	12	20/1	9	$ \leftarrow $	+ + ′	1	0 20/1	12	576		SERVICE CTR/D.T. RECEPT.
DOOR ALARM		720	12	20/1	11	$\overline{}$	+ + ′	1	2 30/1	12	2400		FRY HOLD STATION #30
WATER HEATER		300	12	20/1	13	\uparrow		1	4 20/1	12	700		MEAT FREEZER #25
CARBONATOR		744	12	20/1	15	\leftarrow		1	6 20/1	12	552		FRY FREEZER #32
CARBONATOR		744	12	20/1	17	1	++-	1	B 20/1				SPARE
CARBONATOR		744	12	20/1	19		++-	<u> 2</u>	0 20/2	12	1300	HACR	ICE MACHINE
COFFEE/TEA BREWER #17		1820	12	20/2	2 21	<u> </u>	 	<u></u>	2	12	1300		
		1820	12	1	23	4	+ + -	<u> </u>	4 20/1	12	1344		FRYER CONTROLS #31 *
SHORTENING STORAGE UNIT #31B		500	12	20/1	25	$ \frown $	++-	<u> 2</u>	6 20/1				SPARE
SPARE				20/1	27	\sim +		<u> </u>	B 20/1				SPARE
SPARE				20/1	29	\sim +	++-	 3	0 20/2	12	1650		PRODUCT HOLDING UNIT #51
SPARE				20/1	31	$ \frown $	++-	7 3	2	12	1650		
SPARE				20/1	33	\frown	 '	— 3	4 20/1				SPARE
SPARE				20/1	35	$\overline{}$	+ +	- 3	6 20/1				SPARE
SPARE				20/1	37	$ \frown \downarrow $	++	3	B 20/1				SPARE
SPARE				20/1	39	$ \leftarrow + $	 '	4	0 20/1				SPARE
SPARE				20/1	41	$\overline{}$	+ + -	4	2 20/1				SPARE
TOTAL CONNECTED LOAD:	25,024	VA	PHASE	•		′594 \	/A			٠.	WIRE THROUG	H CONTAC	TOR.
	•								(H	ACR) =	HACR TYPE E	BREAKER.	
TOTAL CONNECTED AMPS:	69.5 A	MP	PHASE	'B':	7	032 \	/A				LOCKED BREA		
			PHASE	101.	. 4	0398 \	,		(G	FČI) =	GROUND FAU WIRE SEPARA	LT CIRCUIT	INTERRUPTER

PANEL: D			SER	WICE:	120/20	8/240V, 3	P, 4W -	+ GNDFEE	DERS : SEE ON	E LINE D	NAGRAM
			BUS	RATII	VG : 15	0A M.L.O.		MOL	JNTING: FURN	ISHED BY	' EQUIPMENT SUPPLIER
LOAD DESCRIPTION	NOTE	LOAD VOLT-AMP	WIRE	CB/P	A	ВС	CB/	P WIRE	LOAD VOLT-AMP	NOTE	LOAD DESCRIPTION
PHU/MICROWAVE		1920	12	20/2		++1	2 20/	'2 12	1920		PHU
·		1920	12		5	+	4	12	1920		-
PHU/MICROWAVE		1920	12	20/2	5	++	6 20/	2 12	1920		PHU
		1920	12		7	+++	8	12	1920		
SPACE				20/2			10 20/	2 12	1920		EGG COOKER
SPACE				1	1	+	12	12	1920		
BUN TOASTER		2880	10	30/2 1	3	++	14 20/	1 12	1920		SPARE
		2880	10	1		+	16 20/	1 12	1920		SANDWICH STATION
SPACE				1	7		18 30/	2 10	2880		VERTICAL TOASTER
SPACE				1	9	++	20		2880		
SPACE				2			22 20/	1 12	360		REFRIGERATOR (32.58)
SPACE				2	3 -^-+		24				SPACE

ELECTRICAL PANEL SCHEDULE A.I.C. RATING: 42,000 SERVICE: 120/208V, 3P, 4W + GND FEEDERS: SEE ONE LINE DIAGRAM PANEL: M PANEL TYPE: SQ-D "I-LINE" OR EQUAL MOUNTING: NEMA-1 RECESSED SIZE: 600 AMP MCB NOTE LOAD DESCRIPTION LOAD DESCRIPTION NOTE 2 200/3 3/0 PANEL A PANEL B 11080 3/0 200/3 1 10250 8060 10398 RTU-1 HACR 4 100/3 1/0 15360 3140 #8 50/3 **3** PANEL D 3140 13440 3140 8040 RTU-3 HACR 3140 #8 | 50/3 | **5** | **6** 50/3 #8 3140 3140 3140 EF-1 #23A BISCUIT OVEN #36 350 #12 | 20/2 **7** 8 30/3 #10 3240 3240 EF-2 #33A #12 20/2 **9** 10 45/3 #8 SHAKE MACHINE 7280 WALK-IN BOX COOLER FROZEN COKE MACHINE #14 **12** 30/3 #10 1700 #12 | 20/2 | **11** | CONDENSER #40 WALK-IN BOX FREEZER 3024 #10 |30/3|**13**|-**⊣14** | 50/3 | CONDENSER #40 3024 3024 3140 NOTES: (TC) = WIRE THROUGH CONTACTOR. (HACR) = HACR TYPE BREAKER. (LO) = LOCKED BREAKER (GFCI) = GROUND FAULT CIRCUIT INTERRUPTOR (IG) = WIRE SEPARATE TO ISOLATED OPENING. TOTAL CONNECTED LOAD: PHASE 'A': 63003 VA PHASE 'B': 59651 VA TOTAL CONNECTED AMPS: PHASE 'C': 43243 VA = WIRE SEPARATE TO ISOLATED GROUND BUS.

RISER NOTES:

2. REFER TO PANEL NOTES.

CONTACTOR PANEL

SERVICE GROUND POINT.

8566 115TH AVENUE NORTH LARGO, FLOR**I**DA 34643 PHONE (877) 544-6679

1. ALL FUSED DISCONNECT SWITCHES

TO BE PROVIDED BY CONTRACTOR.

4. "T.C." INDICATES TIME CLOCK (OR TIME SWITCH)

ARE CONTROLLED THROUGH THE MASTER

6. PROVIDE AN ISOLATED GROUND BUS IN PANEL & RUN CIRCUIT GROUND WIRE TO THIS BUS. RUN A

#6 GREEN GROUND FROM THIS BUS TO MAIN

7. MASTER CONTACTOR PANEL AND MANUAL ON-OF

ELECTRICAL DISTRIBUTION PANELS, MASTER CONTACTOR PANEL AND MANUAL

ON/OFF PANEL MAY BE PURCHASED AS A LOOSE GEAR PACKAGE THROUGH:

SUNCOAST ENVIRONMENTAL CONTROLS, INC.

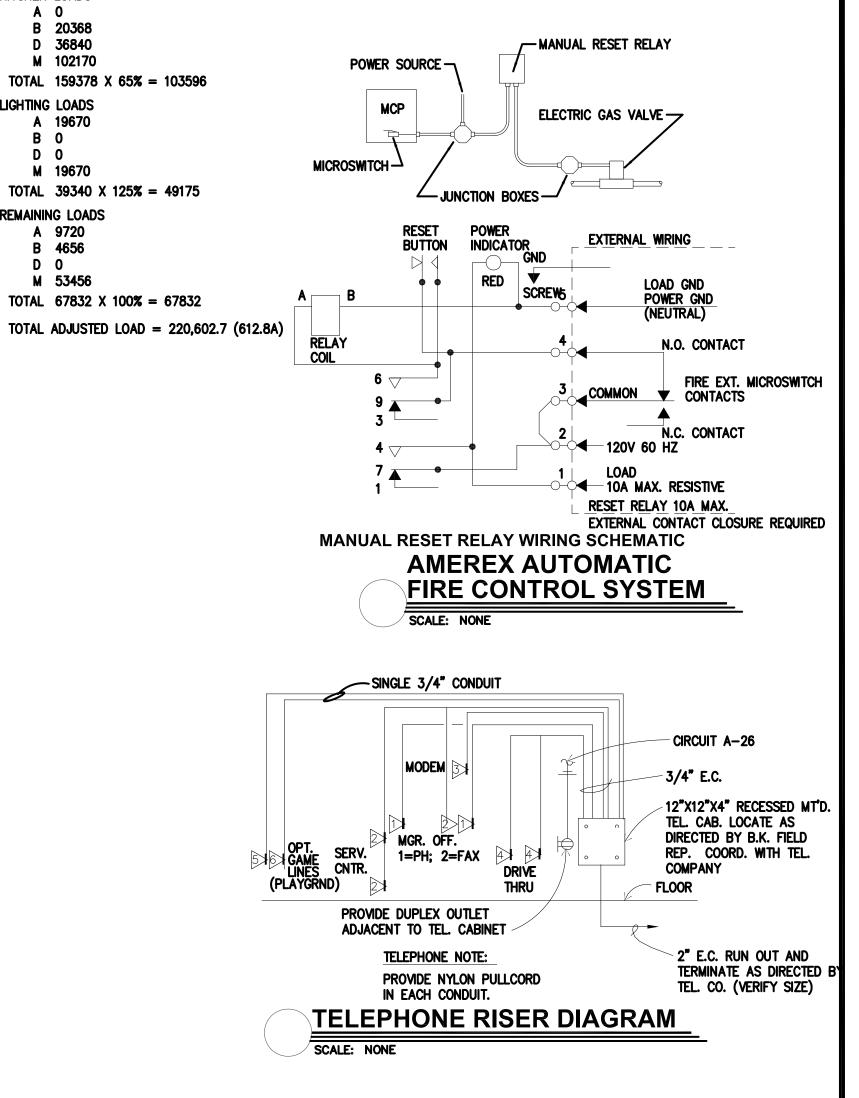
PANEL TO BE INCLUDED IN ELECTRICAL

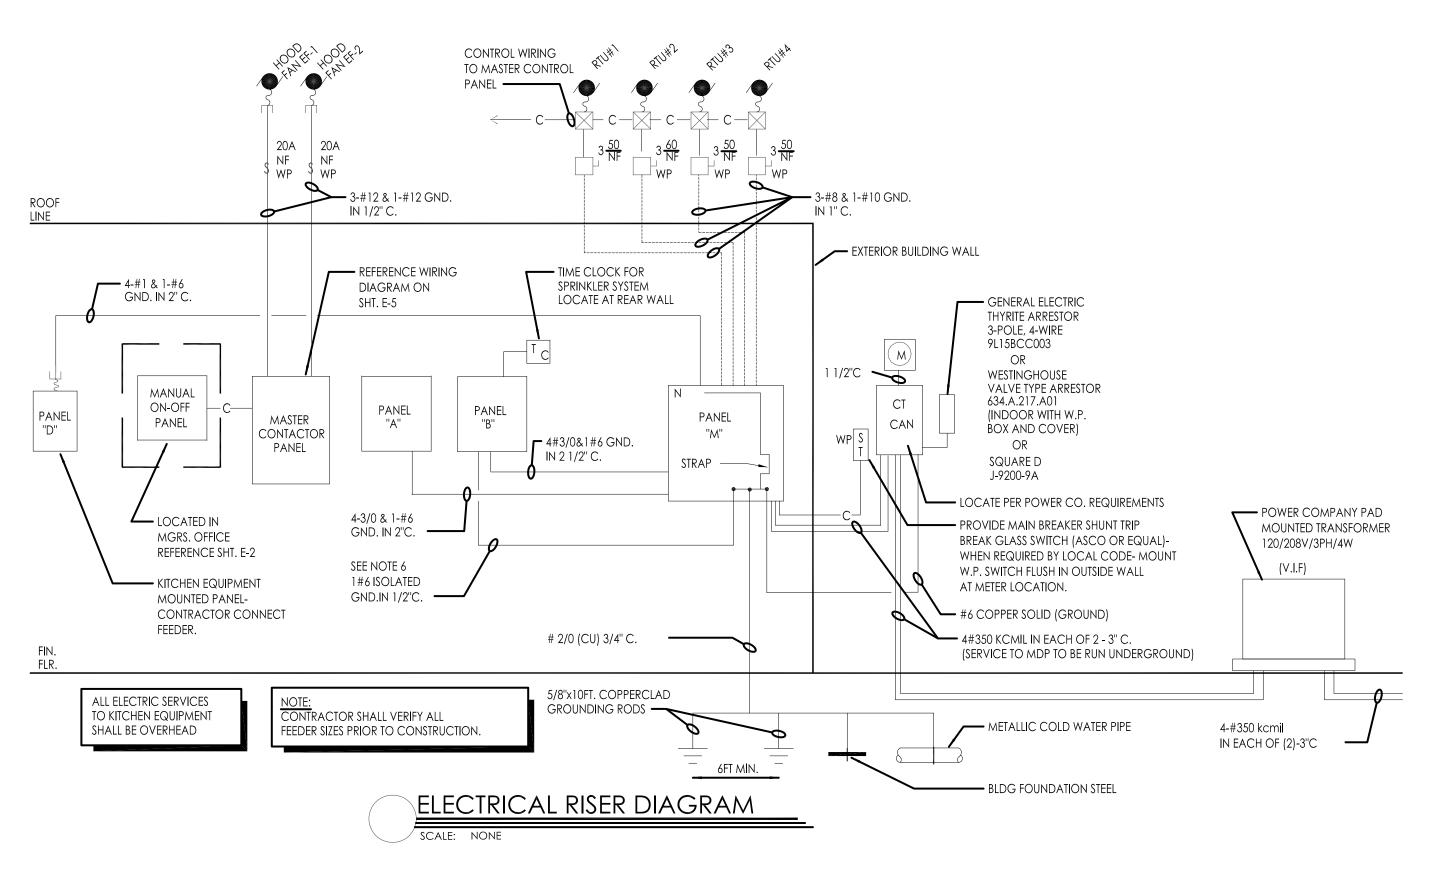
CONTRACTORS SCOPE OF WORK.

5. SEE MASTER CONTACTOR PANEL WIRING DIAGRAM

FOR ADDITIONAL CIRCUITS FROM PANELS THAT

3. REFER TO GENERAL NOTES, SHEET E-2





LOAD SUMMARY

KITCHEN LOADS A 0

B 20368

D 36840

M 102170

A 19670

M 19670

REMAINING LOADS

A 9720

B 4656

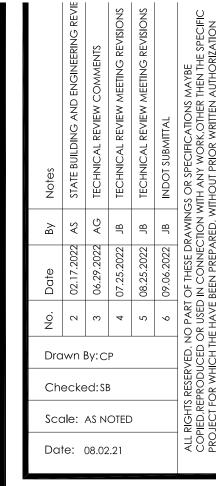
M 53456

D 0

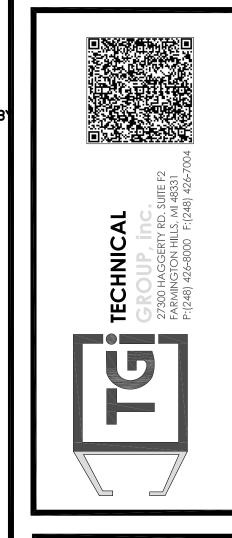
LIGHTING LOADS

B 0

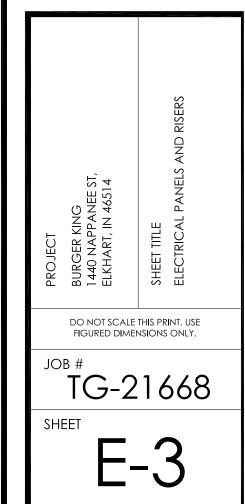
D 0

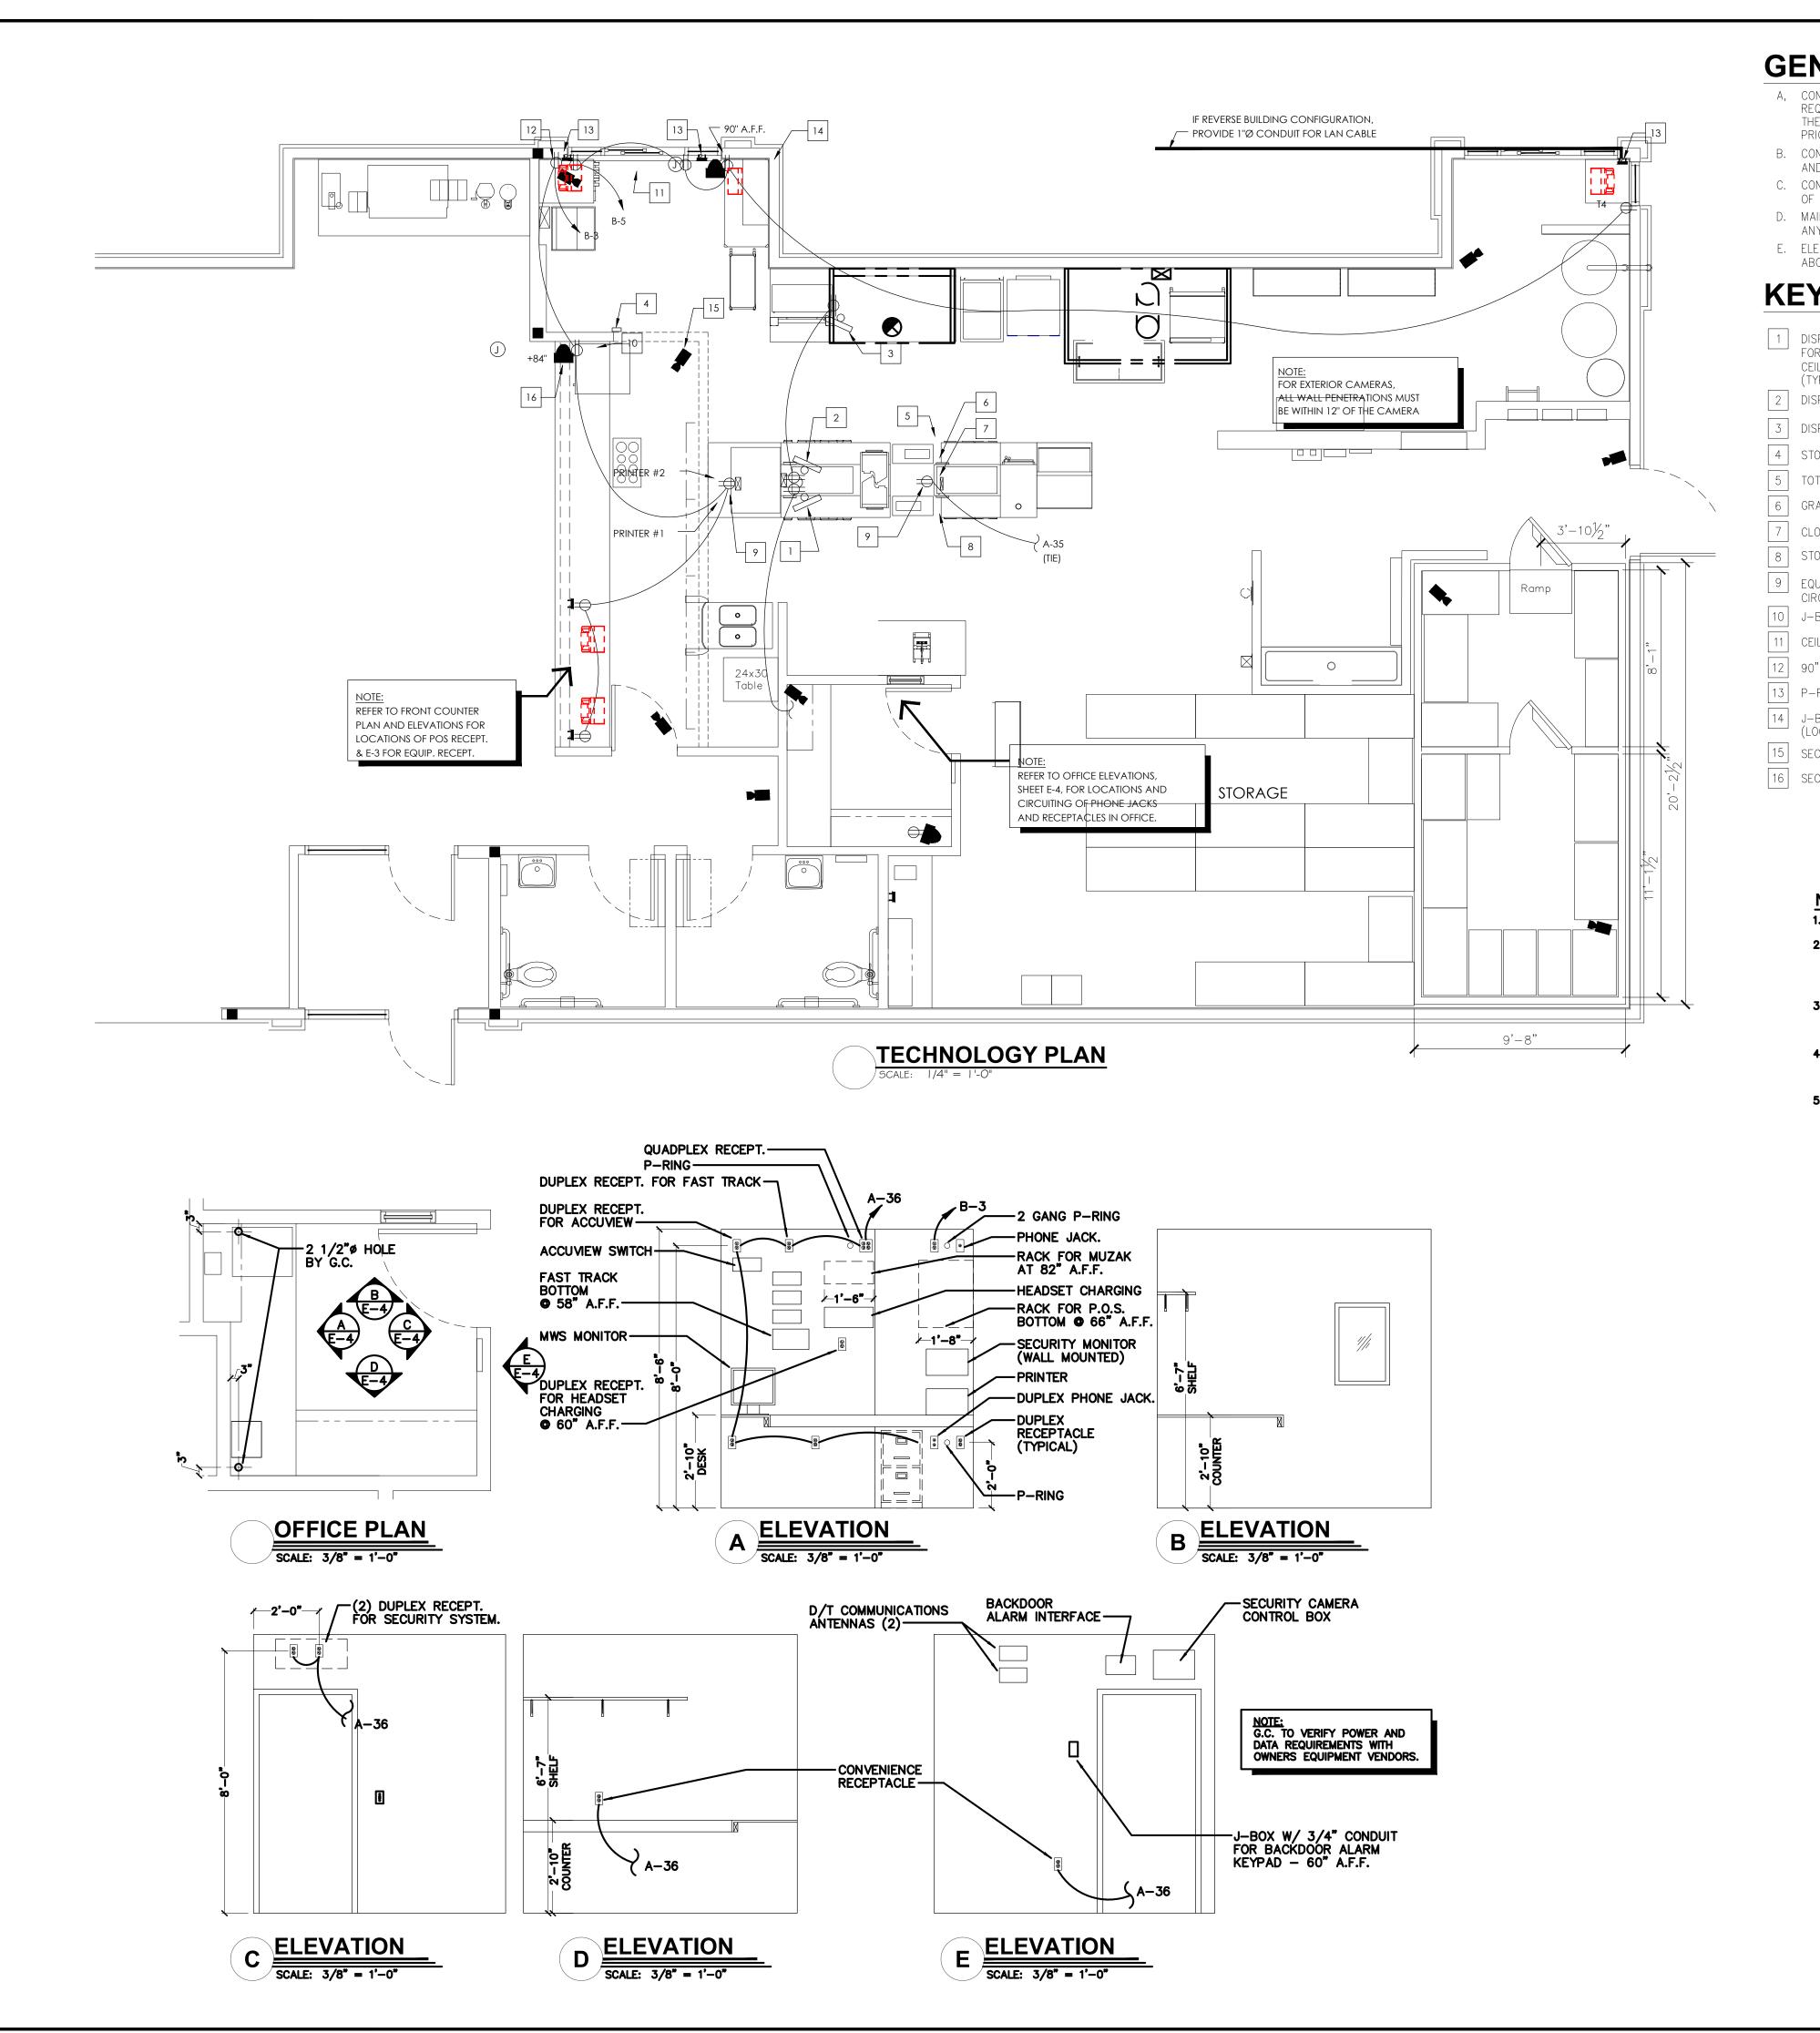












GENERAL NOTES:

- A, CONTRACTOR TO VERIFY WHICH SYSTEM IS TO BE INSTALLED.
 REQUIREMENTS CAN VARY DEPENDING ON MANUFACTURER.
 THE CONTRACTOR IS CAUTIONED TO VERIFY ALL REQUIREMENTS
 PRIOR TO CONSTRUCTION.
- B. CONTRACTOR TO PROVIDE ALL RECEPTACLE OUTLETS, CONDUITS AND J-BOXES AS INDICATED ON PLAN.
- C. CONTRACTOR TO VERIFY AND COORDINATE LOCATION OF VIDEO DISPLAY DEVICES W/ BURGER KING REPRESENTATIVE.
- OF VIDEO DISPLAY DEVICES W/ BURGER KING REPRESENTATI
 D. MAINTAIN P.O.S. CABLES A MIN. OF 12" AWAY FROM
- ANY FLUORESCENT LIGHT SOURCES ABOVE CEILING.

 E. ELECTRICAL CONTRACTOR TO IDENTIFY P.O.S. JUNCTION BOXES ABOVE CEILING "GROUND P.O.S. ONLY".

KEYED PLAN NOTES:

- DISPLAY #1 AND BUMB BAR. PROVIDE 4"Ø CONDUIT FOR VIDEO, BUMP BAR AND PRINTERS. PROVIDE CEILING MOUNTED RECEPTACLES. (TYPICAL FOR DISPLAY #1, #2 AND #3)
- 2 DISPLAY #2 AND BUMP BAR
- 3 DISPLAY #3 AND BUMP BAR
- 4 STOCK LEVEL LIGHT CONTROLLER @ 60" A.F.F.
- 5 TOTAL SERVICE TIME DISPLAY
- 6 GRADE DISPLAY
- 7 CLOCK-RECEPT. IN CHASE
- 8 STOCK LEVEL DISPLAY RECEPT. IN CHASE
- 9 EQUIPMENT MOUNTED RECEPTACLES BY K.E.S. CIRCUITING RUNS BY E.C.
- 10 J-BOX W/ 3/4" CONDUIT @ 84" A.F.F.
- 11 CEILING MOUNTED D/T TIMER WINDOW TIME DISPLAY
- 90" A.F.F. FOR D/T LAND MONITOR.
- 13 P-RING @ 24" A.F.F. W/ 1" CONDUIT TO ABOVE CLG.
- J-BOX W/1" CONDUIT TO CLG. FOR PHU DATA CABLE. (LOCATE NEXT TO PHU RECEPT.)
- 15 SECURITY CAMERA (TYPICAL)
- 16 SECURITY MONITOR (TYPICAL)

	SYMBOL LEGEND
DETAIL	DESCRIPTION
e	DUPLEX 125V-20A-2 POLE-3 WIRE STRAIGHT BLADE RECEPTACLE OUTLET - WALL MTD. (24" A.F.F., - U.O.N.
0	SINGLE 125V-20A-2 POLE-3 WIRE STRAIGHT BLADE RECEPTACLE OUTLET - WALL MTD. (24" A.F.F., - U.O.N.
1	DRYWALL P-RING

) TELEPHONE BACKBOARD) MOUNT 96" A.F.F.

B B BUMP-BAR

TELEPHONE OUTLET FOR P.O.S. MODEM
(ALL OUTLETS HOMERUN IN 3/4" CONDUIT

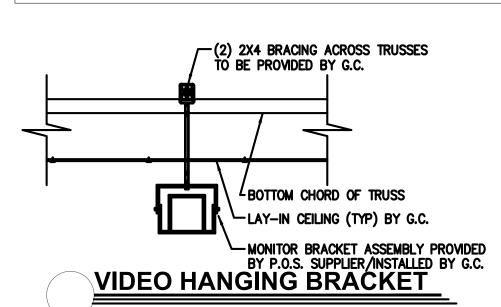
P.O.S. PRINTER DEVICE

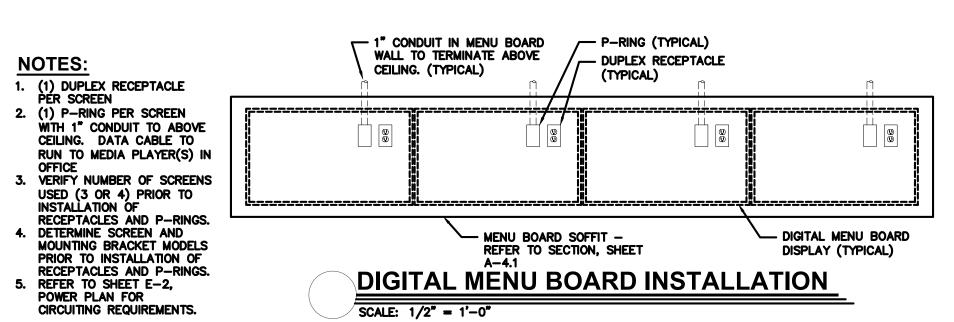
P.O.S. REGISTER DEVICE

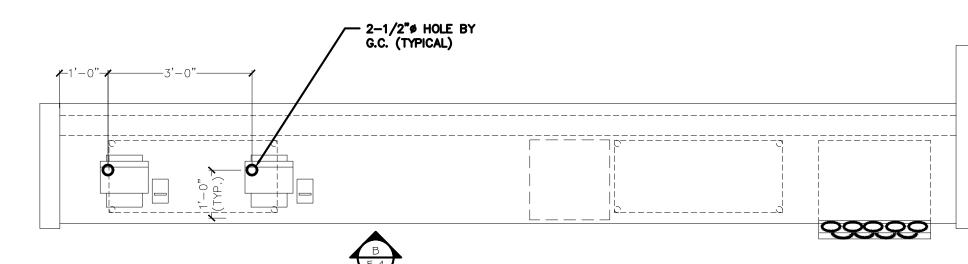
VIDEO DISPLAY DEVICE (CEILING MTD.)

SECURITY CAMERA BY "PRIVID-EYE"
CONTACT: LARRY SATTLER, 954-581-1756


SECURITY MONITOR BY "PRIVID-EYE"
PROVIDE DUPLEX RECEPTACLE @ 84" A.F.F. (VERIFY)
CONNECT TO P.O.S. CIRCUIT








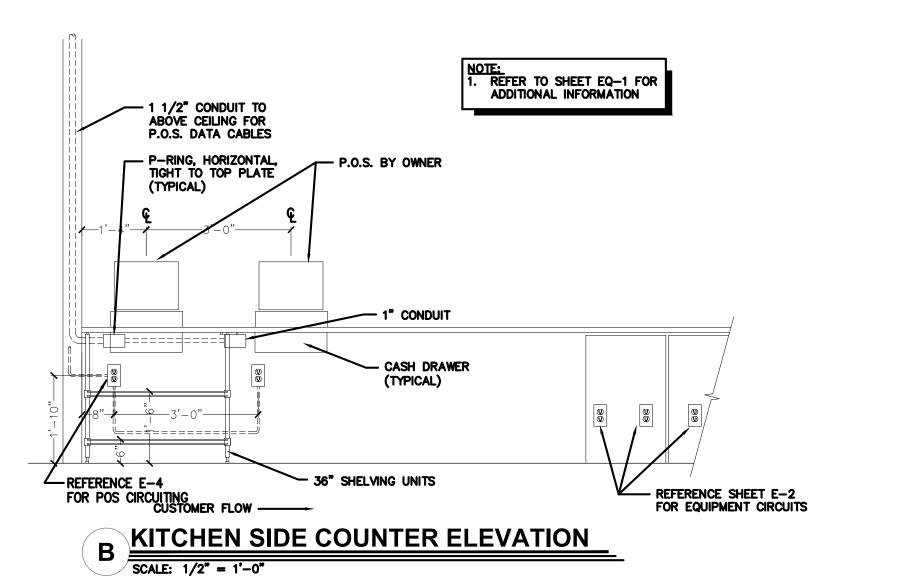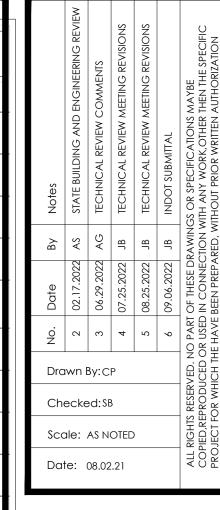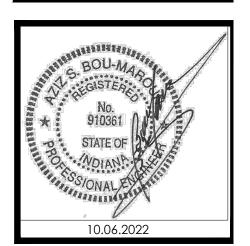
SERVICE COUNTER PLAN SCALE: 1/2" = 1'-0"

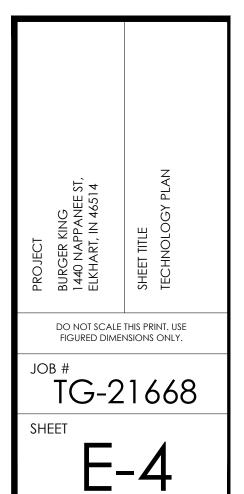












"MORNING ARRIVAL"

<u>STEP 1</u>

TURN THE KITCHEN UNOCCUPIED-OCCUPIED SWITCH TO THE THE OCCUPIED POSITION. THE KITCHENS AIR CONDITIONING SYSTEM WILL GO FROM NIGHT SETBACK MODE TO THE THERMOSTAT SET POINT.

NOTE: THE AIR CONDITIONING FAN WILL START AND RUN CONTINUOUSLY. EXHAUST FAN WILL NOT RUN UNTIL THIS SWITCH IS IN THE OCCUPIED POSITION.

STEP 2

TURN ON THE EXHAUST FAN SWITCH TO THE ON POSITION THIS WILL ALLOW YOU TO TURN ON THE FRYERS AND BROILER.

"RESTAURANT OPEN FOR BUSINESS^{*}

STEP 1

TURN THE DINING UNOCCUPIED-OCCUPIED SWITCH TO THE THE OCCUPIED POSITION. THE DINING AIR CONDITIONING SYSTEM WILL GO FROM NIGHT SETBACK MODE TO THE THERMOSTAT SET POINT.

TURN THE SIGN AND PARKING LOT LIGHTING SWITCHES TO THE AUTO POSITION, THIS WILL ENGAGE THE LIGHTING PHOTOCELLS SO THAT THE LIGHTS WILL AUTOMATICALLY COME ON AFTER DARK. TURN THE SWITCH TO THE ON POSITION TO OVER RIDE THE PHOTOCELLS AT ANY TIME THE LIGHTING MUST REMAIN ON.

"RESTAURANT CLOSE FOR BUSINESS'

TURN THE DINING UNOCCUPIED-OCCUPIED SWITCH TO THE UNOCCUPIED POSITION. THE DINING AIR CONDITIONING SYSTEM WILL GO FROM THE THERMOSTAT SET POINT TO THE NIGHT SET BACK MODE.

STEP 2

TURN THE SIGN AND PARKING LOT LIGHTING SWITCHES TO THE OFF POSITION, THIS WILL DISENGAGE THE LIGHTING PHOTOCELLS.

STEP 3

TURN THE EXHAUST FAN SWITCH TO THE OFF POSITION THE BROILERS EXHAUST FAN WILL CONTINUE TO RUN FOR 15 MINUTES FOR A COOL DOWN CYCLE, AND THEN SHUT OFF AUTOMATICALLY.

NOTE: THE FRYERS AND BROILER SHOULD BE TURNED OFF AND ALLOWED TO COOL DOWN BEFORE TURNING THE HOOD OFF. TO PREVENT ACCIDENTAL ANSUL DISCHARGE, THE BROILERS HOOD WILL ALWAYS RUN 15 MINUTES AFTER THE EXHAUST FAN SWITCH IS TURNED TO THE

<u>"employees leaving the</u> <u>BUILDING"</u>

OFF POSITION.

WHEN READY TO EXIT THE BUILDING PUSH THE SECURITY DEPARTURES SWITCH. THE PARKING LOT LIGHTS WILL COME BACK ON FOR 15 MINUTES THEN SHUT OFF AUTOMATICALLY.

LEAVING THE BUILDING'

<u>STEP 1</u>

TURN THE KITCHEN UNOCCUPIED-OCCUPIED SWITCH TO THE UNOCCUPIED POSITION. THE KITCHENS AIR CONDITIONING SYSTEM WILL GO FROM THE THERMOSTAT SET POINT TO THE NIGHT SET BACK MODE.

WHEN READY TO EXIT THE BUILDING PUSH THE SECURITY DEPARTURE SWITCH. THE PARKING LOT LIGHTS WILL COME BACK ON FOR 15 MINUTES THEN SHUT OFF AUTOMATICALLY.

'HOOD VENTILATION SYSTEM

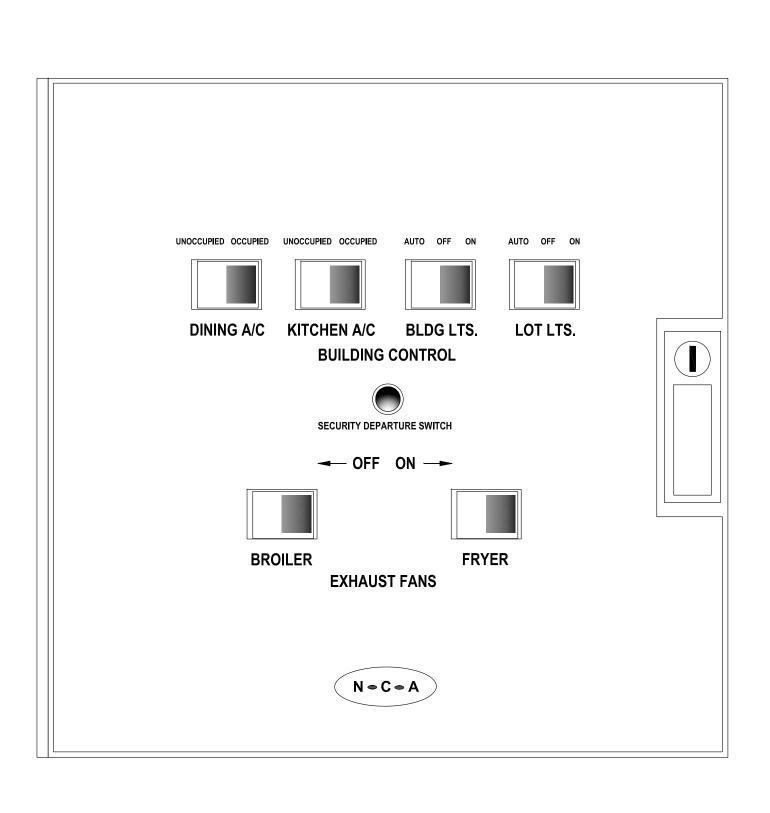
WHEN THE HOOD EXHAUST FAN CURRENT SENSOR DETECTS A DROP IN AMPERAGE (SUCH AS A BELT BREAKING) IT WILL DISABLE THE LINE VOLTAGE TO THE EXHAUST FAN(S), FRYER AND BROILER APPLIANCES. THE EXHAUST FAN SWITCH SHOULD BE PLACED IN THE OFF POSITION AND THE FAN SHOULD BE CHECKED AND/OR REPAIRED BEFORE TURNING THE SWITCH TO THE ON POSITION.

"PARKING LOT LIGHTING NOTE"


WHEN THE PARKING LOT LIGHTS ARE TURNED OFF, THEY MUST COOL DOWN FOR ABOUT 10

MINUTES BEFORE THEY WILL COME BACK ON. *NOTE: IF IT IS NECESSARY TO ADJUST THE AMPERAGE OF THE BROILER EXHAUST HOOD FAN MOTOR, THE FAN MOTOR CURRENT SENSOR MUST BE RESET AS FOLLOWS: ADJUST UNDERCURRENT POTENTIOMETER TO MAXIMUM (CLOCKWISE IS MAXIMUM.) APPLY CURRENT. ONCE CURRENT IS STABILIZED, DECREASE UNDERCURRENT POT UNTIL RED LIGHT TURNS OFF. WITHIN SEVEN SECONDS TURN UP UNTIL RED LIGHT TURNS ON. IF A LIGHT REMAINS OFF FOR MORE THEN TEN SECONDS, DISCONNECT SUPPLY VOLTAGE TO RESET. SEE INSTALLATION INSTRUCTIONS

PN MRP COVER.



Underwriters Laboratories, Inc.

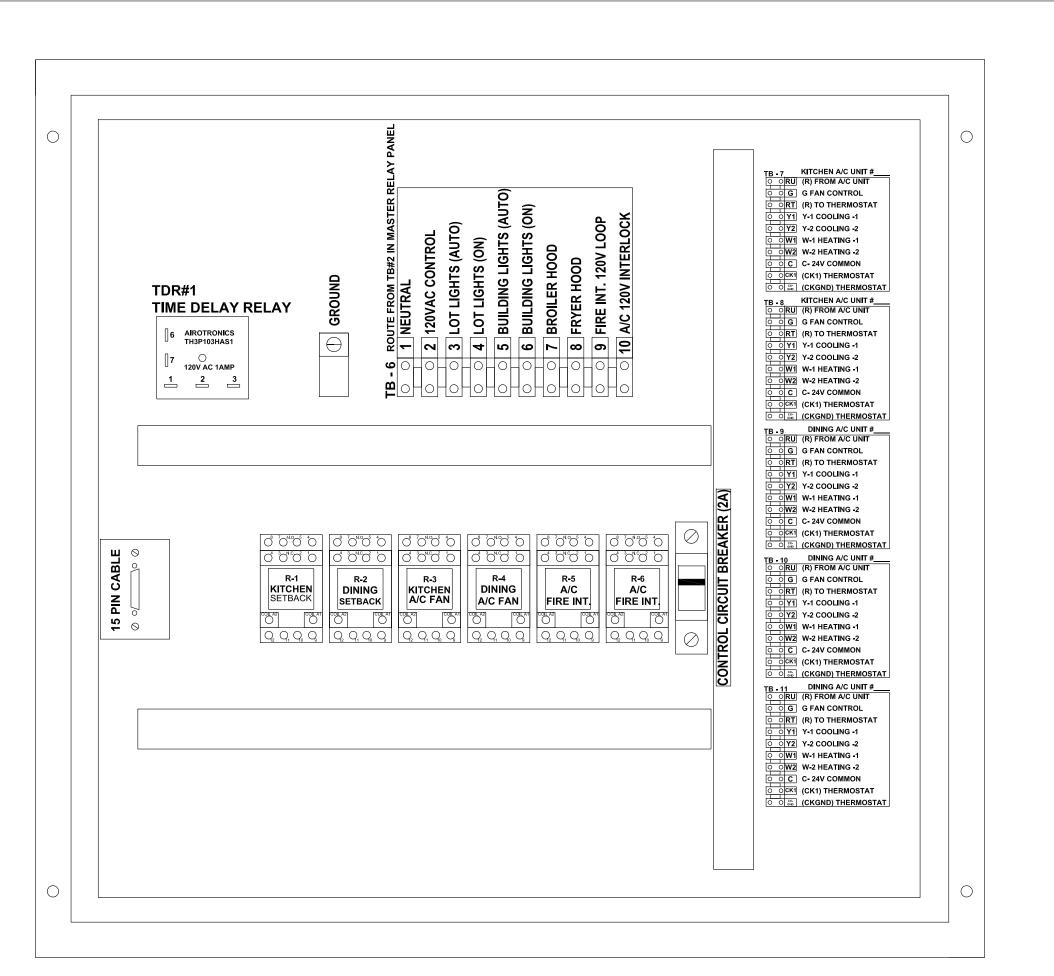

SEQUENCE OF OPERATION

MANUAL CONTROL SYSTEM

- THE A/C UNITS UNOCCUPIED-OCCUPIED SWITCH IS USED TO: TURN THE STORE ON IN THE MORNING AND OFF IN THE EVENING.
- WHEN A/C UNIT UNOCCUPIED-OCCUPIED SWITCH IS TURNED TO THE ON POSITION: THE AIR CONDITIONING SYSTEM WILL GO FROM NIGHT MODE TO SYSTEM ON.
- THE AIR CONDITIONING FANS WILL START AND RUN CONTINUOUSLY
- THE OUTDOOR DAMPERS WILL OPEN TO A PRESET POSITION. (OPTIONAL)
- DAMPERS WILL NOT OPEN DURING NIGHT SET BACK MODE. (OPTIONAL)
- THE AIR CONDITIONERS WILL BEGIN TO COOL OR HEAT AT THE OCCUPIED TEMPERATURE SETPOINT,
- THE COOKING EQUIPMENT AND EXHAUST FANS CAN NOW BE TURNED ON WHEN NEEDED.
- WHEN A/C UNOCCUPIED-OCCUPIED SWITCH IS TURNED TO THE OFF POSITION: EXHAUST FANS, SUPPLY FANS, AND EVAPORATOR BLOWERS WILL SHUT DOWN.
- THE HEATING AND COOLING OPERATION SHALL REVERT TO SYSTEM NIGHT SET BACK MODE.
- THE COOKING EQUIPMENT SHALL BE DISABLED.

MIN AFTER THE SECURITY DEPARTURE SWITCH IS ACTIVATED.

- THE SIGNAGE LIGHTING & LOT LIGHTING SHALL BE DISABLED IF SWITCHES ARE IN THE OFF POSITION.
- THE PARKING LOT POLE LIGHTS & SECURITY LIGHTS SHALL REMAIN ON FOR 15
- WHEN THE HOOD EXHAUST FAN CURRENT SENSOR DETECTS A DROP IN AMPERAGE IT WILL DISABLE THE LINE VOLTAGE TO THE FRYER AND BROILER APPLIANCES.

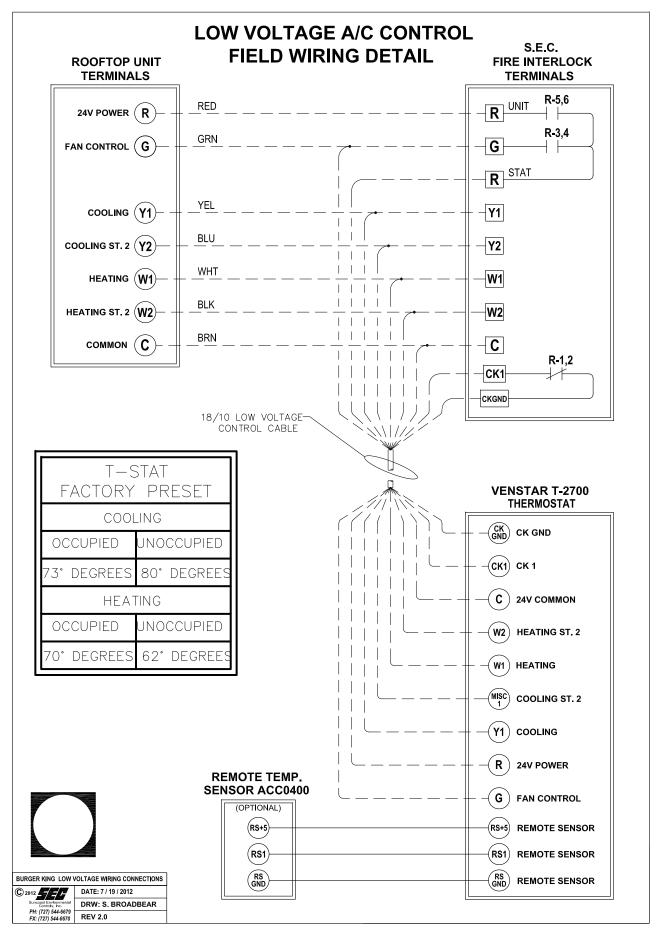
HOOD VENTILATION SYSTEM

- IF THE HOOD VENTILATION SWITCH IS IN THE OPEN POSITION, THE HOOD VENTILATION SYSTEM CAN BE STARTED.
- THE BROILER SYSTEM AND THE FRYER SYSTEM SHALL BE STARTED BY MOVING THE ON/OFF SWITCH TO THE ON POSITION. IF EITHER THE BROILER OR FRYER SWITCH IS IN THE ON POSITION, THE MAKE-UP AIR UNIT (IF APPLICABLE) SHALL START AUTOMATICALLY.
- ACTIVATION OF THE HOOD FIRE SUPPRESSION SYSTEM SHALL DE-ENERGIZE THE MAKE UP AIR UNIT, ALL A/C UNITS, AND THE CONTROLLED COOKING EQUIPMENT. THE BROILER AND THE FRYER EXHAUST SYSTEM SHALL CONTINUE TO OPERATE. THE FIRE SUPPRESSION SYSTEM SHALL BE MANUALLY RESET.

EXTERIOR LIGHTING CONTROL

- ALL OF THE EXTERIOR LIGHTING SHALL BE CONTROLLED, WITH THE EXCEPTION OF THE SECURITY LIGHTS WHICH SHALL BE OPERATED BY ITS OWN PHOTOCELL. SECURITY LIGHTING IS OPTIONAL.
- THE SIGNAGE SELECTOR SWITCH (3-POS.) CONTROLS THE PRIME SIGN, ALL MARQUEE SIGNS, AND BUILDING ACCENT LIGHTING.
- ON POSITION: LIGHTING SHALL BE ON PERMANENTLY.
- OFF POSITION: LIGHTING SHALL BE OFF PERMANENTLY
- AUTO POSITION: LIGHTING SHALL BE CONTROLLED BY THE PHOTO CELL
- THE LOT LIGHTS THREE POSITION SWITCH WORKS THE SAME AS THE SIGNAGE SWITCH.


NOTE: UNOCCUPIED-OCCUPIED / MASTER RELAY PANEL SHALL BE COMPLETE WHEN SHIPPED TO THE JOB SITE. NO INTERNAL WIRING SHALL BE REQUIRED. MAKE ALL EXTERNAL WIRING CONNECTIONS AS REQUIRED.




ELECTRICAL CONTRACTOR NOTES:

- 1. RUN 0NE (10) CONDUCTOR 18 GAUGE THERMOSTAT CABLE FROM THE ROOFTOP
- DONE BY THE MECHANICAL CONTRACTOR. AIR CONDITIONING UNIT TO THE "UNOCCUPIED-OCCUPIED" PANEL.
- 2. RUN ONE (10) CONDUCTOR 18 GAUGE THERMOSTAT CABLE FROM THE "UNOCCUPIED-OCCUPIED" PANEL TO THE THERMOSTAT LOCATION.
- 3. RUN ONE (10) CONDUCTOR 18 GAUGE THERMOSTAT CABLE FROM THE ROOFTOP AIR CONDITIONING UNIT TO THE NIGHT SETBACK THERMOSTAT LOCATION, IF NOT CONTROLLED WITH P-374-2700 T-STAT. REFER TO SHEET M-1
- 4. TERMINATION OF ALL 24 VOLT AIR CONDITIONING CONTROL WIRING SHALL BE
- 5. ELECTRICAL CONTRACTOR SHALL RUN LINE VOLTAGE FROM THE CURRENT SENSOR LOCATED IN THE BROILER HOOD EXHAUST FAN TO THE CONTACTOR PANEL LOCATED BY THE SWITCHGEAR.

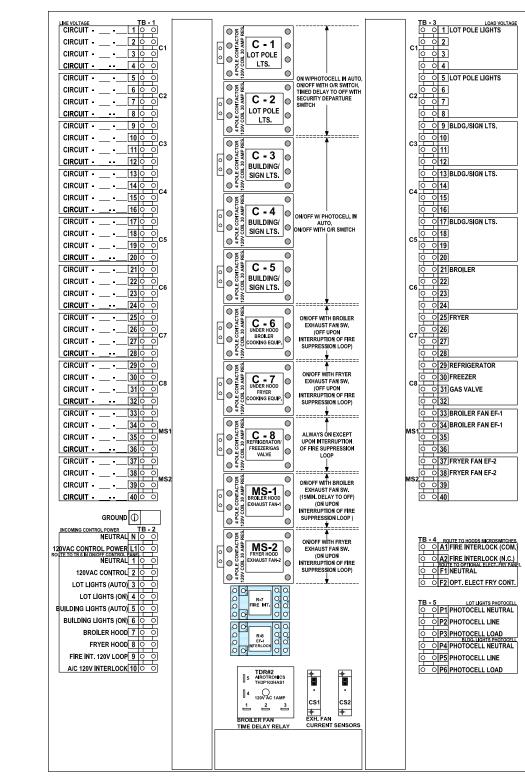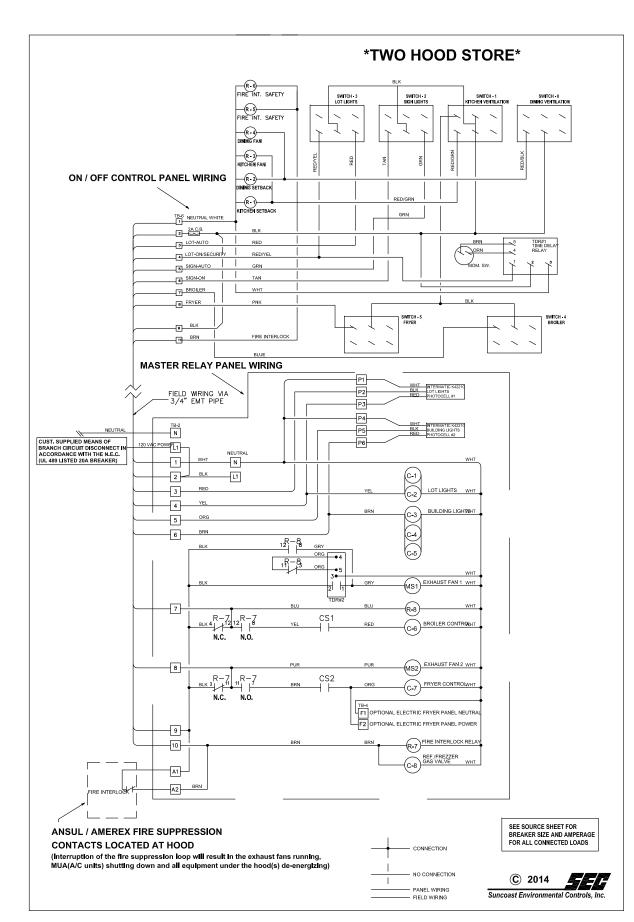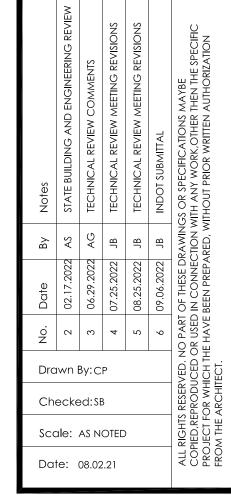
HVAC SYSTEM CONSULTANTS/GROUP NATIONAL CORPORATE ACCOUNT SERVICES, INC DRAWINGS SHOWN ARE FOR PROTOTYPICAL CONSIDERATIONS ONLY. SITE—SPECIFIC DESIGN IS REQUIRED BY BURGER KING CORPORATION. AS A COURTESY, NCA CONSULTANTS PROVIDES SITE—SPECIFIC DESIGN WITH SITE—SPECIFIC PROFESSIONAL ENGINEER SEAL UNDER AN AGREEMENT BETWEEN NCA CONSULTANTS AND BURGER KING CORPORATION. FOR SITE—SPECIFIC DESIGN, ARCHITECTS EMAIL REFLECTED CEILING PLAN, ELEVATIONS, KITCHEN PLANS, FLOOR PLAN, SITE PLAN, EXTERIOR ELEVATIONS, AND ROOF STRUCTURAL PLAN TO TO CONTACT THE NCA CONSULTANTS BY PHONE, CALL TOLL-FREE (877) 530-0078.





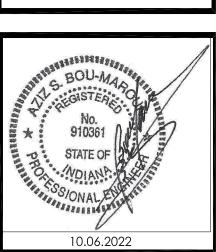


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