
OPTIONS LIST	OPTION NOT INCLUDED IN SET	■ = OPTION INCL	LUDED IN SET										
INTERIOR OPTIONS							EXTERIOR OPTIONS	OPTIONS PER PLAN					<u></u>
DESCRIPTION	DESCRIPTION		DESCRIPTION		DESCRIPTI	ON	DESCRIPTION	DESCRIPTION		DESCRIPTION		DESCRIPTION	
	NEW CEILING TILES NEW CEILING GRID		MUSIC W/ CEILING MOUNTE SEPARATE ORDER/PAY FRO	, ,	FREESTAN WINDOW S	DING FIREPLACE	■ NEW BUILDING SIGNAGE ■ REMOVE DIRECTIONALS	□ NEW PICK-UP WINDOW ■ F.A.R ITEMS (PARTIAL)					-
	NEW PENDANT LIGHTS		☐ REPLACE WINDOW SILLS W		WIFI BAR (F		LANDSCAPING	NEW PICK-UP WINDOW AWNING (S	OFT)				
	REPLACE SERVICE COUNTE	ER BACK WALL FINISHES	CARPET		□ NEW GREA		■ FLAG BLADE	☐ NEW ORDER STATION CANOPY					
	ARTPACK WIFI SERVICE		REPLACE RESTROOM FINIS ONE BEVARITY IN DT	HES & FIXTURES	F.A.R ITEM:	· ,	■ NEW CORRUGATED PANELS □ PAINT (E) WALL SCONCES						-
	ALL WOOD LOOK PORCELA	IN PLANK TILE	(1) - 55" TV				☐ PAINT (E) STOREFRONT						
GENERAL NOTES		ABBREVIAT	ΓIONS		•	CODE DATA AND S	SQUARE FOOTAGE	SHEET INDEX			•		SITE NUMBER: 07588
		, (33) (21), (1)						3112111121					SITE NUMBER: 07588 BASE MODEL: CONVERSION
 DISCREPANCIES BETWEEN THESE DOCUMENTS A CONDITIONS SHALL BE BROUGHT TO THE ATTENT 		© CENTERLIN ACM ALUMINUM	NE I.D. I COMPOSITE PANEL INSI	INSIDE DIAMETER JL. INSULATION	₹	STORE TYPE: CONVERSION	N						ASSET TYPE: FRANCHISE
ARCHITECT BEFORE PROCEEDING WITH WORK.			AL CEILING TILE JT.	JOINT KITCHEN EQUIPM	MENT SUPPLIER	LOCATION: 747 SOUTH STA	TATE ROAD 135, GREENWOOD, IN 46143						CLASSIFICATION: REFRESH
REVIEW DOCUMENTS AND VERIFY DIMENSIONS A CONDITIONS AND CONFIRM THAT WORK IS CONST	STRUCTIBLE AS	A.F.F. ABOVE FIN	IISH FLOOR LAM Y HAVING JURISDICTION LB(S			BUILDING LEVEL: 1 OF 1		G1.1 COVER SHEET					OWNER: JARO FOODS BASE VERSION: 2016 JAN 05
SHOWN. CONFLICTS OR OMISSIONS, ETC., SHALL REPORTED TO THE ARCHITECT FOR CLARIFICATION		ALUM. ALUMINUM	T OF RECORD MEC	Ć. MAXIMÙM			2012 INTERNATIONAL BUILDING CODE w/ INDIANA						UPGRADE CLASSIFICATION:
PERFORMANCE OF WORK IN QUESTION.		ARCH. ARCHITECTED BD. BOARD		R. MANUFACTURER			2006 INTERNATIONAL PLUMBING CODE w/ INDIANA	AS1.1 SITE PLAN					STANDARD
3. DO NOT SCALE DRAWINGS. WRITTEN DIMENSIONS LOCATIONS. IN CASE OF CONFLICT, NOTIFY THE A	ARCHITECT OF	BLDG. BUILDING BLKG. BLOCKING	MIN MIS	. MINIMUM			2008 NATIONAL ELECTRIC CODE w/ INDIANA						PROJECT YEAR: 2016
RECORD. FLOOR PLAN BY ARCHITECT OF RECORI OTHER PLANS. DIMENSIONS MARKED "CLEAR" SHA	HALL BE MAINTAINED	BM. BEAM BOT. BOTTOM	MTL N	METAL NORTH	•		2012 INTERNATIONAL MECHANICAL CODE w/	D1.1 DEMOLITION FLOO					FURNITURE PACKAGE: 2015 DESIGN BULLETINS:
AND SHALL ALLOW FOR THICKNESS OF FINISHES I PAD, CERAMIC TILE, V.C.T., ETC.	SINCLUDING CARPET,	CAB. CABINET CER. CERAMIC	N.I.(N.T.	C. NOT IN CONTRAC	T	INDIANA AMME ENERGY:	ENDMENTS ASHRAE 90.1 2007 w/ INDIANA AMMENDMENTS	D2.1 DEMOLITION CEILING D3.1 DEMOLITION ELEVA					
 INTERIOR DIMENSIONS ARE TO THE FACE OF NEW NOTED OTHERWISE. 	W STUD, UNLESS	CLG. CEILING	(N) NO.	NEW			Y CODE: 2012 INTERNATIONAL BUILDING CODE						Wallin - Gomez
5. COLUMN CENTER LINE (OR GRID LINES) ARE SHOW		CLKG. CAULKING CLR. CLEAR COLUMN	NON		-ED	(ANSI A117.1-20		A1.1 FLOOR & FINISH PL					Architects, Ltd. 711 South Dearborn Street
DIMENSIONING. VERIFY EXACT LOCATIONS IN FIEL 6. MARK LOCATIONS OF PARTITIONS AND DOORS FO		COL. COLUMN CONC. CONCRETE		NG. OPENING	ER	AMMENDMENT		A2.1 EXTERIOR ELEVAT					Suite 606 Chicago, IL 60605
OWNER'S REPRESENTATIVE PRIOR TO INSTALLAT	TION. REVIEW WILL BE	CONT. CONTINUO COORD. COORDINA		AM. PLASTIC LAMINAT	ТЕ			A2.2 EXTERIOR ELEVAT	ONS				Tel: 312-427-4702
FOR DESIGN INTENT. COORDINATE AND VERIFY CO ENSURE PROPER FIT.	CONDITIONS TO	DBL. DOUBLE DET. DETAIL	PL. PLA			OCCUPANCY CLASSIFICAITON A-2 (RESTAUR	RANT)	A3.1 WALL SECTIONS &					Fax: 312-427-6611 e-mail: admin@wgaltd.com
 CONTRACTOR IS REQUIRED TO SCHEDULE A PRE- MEETING WITH THE OWNER'S REPRESENTATIVE T 		DIA. DIAMETER DIM. DIMENSION	l PR.	WD. PLYWOOD PAIR		EXISTING CONSTRUCTION III B		A3.2 WALL SECTIONS &	DETAILS				
REQUIREMENTS. CONTRACTOR IS RESPONSIBLE TO WENDY'S COMPANY RULES AND REGULATIONS.		DND DO NOT DIS	P.T.	POINT PRESSURE-TREA		TYPE:		A5.1 FINISH DETAILS A6.1 FINISH SCHEDULES	<u> </u>				
8. WHEN CONTRACTOR ACCEPTS DELIVERY OF ALL		DS. DOWNSPO	RAD). RADIUS	V	DUIL DING CUMMADY.		A6.2 APPROVED SUPPL					135
PLANS WHETHER IN CONTRACT OR NOT IN CONTR RESPONSIBLE FOR LOSS AND/OR DAMAGE TO THE	*	(E) EXISTING EA. EACH	REF REC			BUILDING SUMMARY: EXISTING: 3,6		A7.1 INTERIOR ELEVATION					
9. THE CONTRACTOR SHALL MAINTAIN, FOR THE ENT THE WORK, ALL EXITS, EXIT/ EGRESS LIGHTING, FI		ELEV. ELEVATION ELEC. ELECTRICA	AL RM.	ROOM		FLAG BLADE ADDITION: 5 S REVISED TOTAL: 3,6		A7.2 INTERIOR ELEVATION	ONS - RESTROOMS				S S
DEVICES AND ALARMS IN CONFORMANCE WITH AL		EMER. EMERGENO EQ. EQUAL	S.C	SOUTH SOLID CORE		, , , , , , , , , , , , , , , , , , , ,		EQ1.1 EQUIPMENT PLAN	& SCHEDULE				
CODES AND ORDINANCES. 10. EXISTING WORK: WITH PRIOR APPROVAL OF THE	E OWNER'S	F/MAS FACE OF M F.D. FLOOR DR/	AIN S.S.	SQUARE FOOT STAINLESS STEE	L	OCCUP	PANCY CALCULATIONS:	P1.1 PLUMBING PLAN &					
REPRESENTATIVE AND RETURN OF PROPER CREE WHICH FITS THE SCHEME MAY BE RE-USED.		F.E. FIRE EXTIN F.O. FACE OF	SHT	. SHEET			SQUARE LOAD NUMBER OF NUMBER	E1.1 REFLECTED CEILIN					
11. DEMOLITION: REMOVE INTERIOR PARTITIONS, CAS	<i>'</i>	F.O.F. FACE OF FI F.O.S. FACE OF S		. SIMILAR .W. SCOPE OF WORK	<		OOTAGE FACTOR OCCUPANTS OF SEATS	E2.1 ELECTRICAL PLAN					000D,
STOREFRONTS, CEILING, FINISHED FLOORING AND USED IN NEW SCHEME. REMOVE UTILITIES, ELECT		F/F FINISH TO I F.R. FIRE RETAI		C. SPECIFICATION SQUARE		1 OF: 1 DINING 122	24 SQ.FT. 1:15 82 66	SP1 SPECIFICATIONS					1
PIPING AS REQUIRED BACK TO EXISTING CONSTRI TERMINATE AND/OR CAP AS REQUIRED BY LOCAL		FIN. FINISH FL. FLOOR	STE STL). STANDARD . STEEL			1,602 SQ.FT. 1:200 8 -	SP2 SPECIFICATIONS					ORE SOL
12. SAW CUTTING AND CORING LOCATIONS SHALL BE		FLUOR. FLUORESC FT. FOOT, FEE		PR. STORAGE SP. SUSPENDED			71 SQ.FT	SP3 SPECIFICATIONS					TC 47
AND COORDINATED WITH THE OWNER'S REPRESE CUTTING/CORING.	BENTATIVE PRIOR TO	F.V. FIELD VERI G.B. GRAB BAR		TIME CLOCK TOP OF		AREAS*	55 SQ.FT						
13. DURING ALL PHASES OF WORK, DO NOT DISTURB FUNCTIONS OF ADJACENT AND NEIGHBORING TEN	_	G.C. GENERAL (GA. GAUGE	CONTRACTOR TEL THE	. TELEPHONE (. THICK			MBER OF OCCUPANTS: 90 - COOLER, WALLS, CLOSET, RESTROOMS, AND VESTIBULE						REV. DATE DESCRIPTION 01-08-16 ISSUED FOR PERMIT & BID
14. 'TYP.' MEANS THAT THE CONDITION IS REPRESEN		GL. GLASS GYP. GYPSUM	TYF U.N	P. TYPICAL O. UNLESS NOTED (OTHERWISE	** BOOTH (FIXED SEATING CALCULATIONS B	BASED ON LENGTH OF BOOTHS: 1 PER 24" OF BOOTH LENGTH.	-					01-08-16 ISSUED FOR PERMIT & BID 01-19-16 OWNER REVISIONS
CONDITIONS THROUGHOUT, UNLESS OTHERWISE 15. PROVIDE PORTABLE FIRE EXTINGUISHER(S) IN AC		H. HIGH H.C. HOLLOW C	VEF ORE V.I.I				TOTAL INCH PER WIDITH WIDTH						
NFPA 10, WITH U.L. LABEL AND A RATING OF NOT L 75 FT. TRAVEL DISTANCE TO ALL POSITIONS OF RE	LESS THAN 2-A WITH	H.M. HOLLOW M HC. HANDICAPI		WEST WITH		EGRESS CALCULATION: OC	REQUIRED: PROVIDED:						
DIRECTED BY THE FIRE DEPARTMENT FIELD INSPE CLASS K FIRE EXTINGUISHER WITHIN 30 FT. OF CO	PECTOR. PROVIDE	HDWD. HARDWOO HORIZ. HORIZONTA		WATER CLOSET WITHOUT			90 0.20" 18" 108" TOTAL	-					PLOT DATE 1/19/2016
HEAT-PROCESSING EQUIPMENT.	OWNINE ROINE 1 GOD	HGT. HEIGHT H.T. HANGER-TI	W/R IGHT UNIT WD	WATER RESISTAI WOOD	NT	TOTAL EXITS REQUIRED:	2 TOTAL EXITS PROVIDED: 3 EGRESS WIDTH PROVIDED PER EXIT: 36"	-					PROJECT NUMBER 15130
16. EXTERIOR BUILDING SIGNS SHALL BE SUBMITTED PERMIT APPLICATION FOR REVIEW AND APPROVA			/ENTILATION,			THE LOSS OF ONE REQUIRED MEANS OF E	EGRESS SHALL NOT REDUCE THE EGRESS CAPACITY TO LESS HAN 50% OF REQUIRED.						DRAWN BY CL/KH CHECKED BY DJW
LOCAL AUTHORITIES. EXTERIOR SIGNS ARE NOT V BUILDING DEPARTMENT APPROVAL.	WITHIN THE SCOPE OF							_					NOTICE: THIS DOCUMENT CONTAINS PROPRIETARY INFORMATION. IT SHALL NOT
17. PRIOR TO COMMENCEMENT OF WORK, AS REQUIR						FIDE DECICTIVE	TERIOR BEARING WALL(0 HOUR) (EXISTING) OF CONSTRUCTION(0 HOUR)	-					BE USED OR REPRODUCED OR ITS CONTENTS DISCLOSED , IN WHOLE OR IN PART WITHOUT THE PRIOR WRITTEN CONSENT OF WALLIN /
JURISDICTION, OBTAIN A COPY OF THE BUILDING OPERMIT FROM THE AUTHORITY HAVING JURISDICT	CTION (AHJ) AND A					REQUIREMENTS:	EILING(0 HOUR)	-					GOMEZ ARCHITECTS, LTD. THESE DRAWINGS HAVE BEEN PREPARED AT
COPY OF THE SET OF CONSTRUCTION DOCUMENT SEALED BY A LICENSED DESIGN PROFESSIONAL F	FOR ALL DISCIPLINES						ONE REQUIRED						AND / OR UNDER MY SUPERVISION AND TO THE BEST OF MY KNOWLEDGE AND BELIEF
AS REQUIRED AND USED TO OBTAIN THE BUILDING	NG PERMIT.					MAY TRAVEL BIOTANOS							CONFORM AND COMPLY WITH THE REQUIREMENTS OF THE DEPARTMENT OF BUILDING AND CODES HAVING JURISDICTION.
						MAX. TRAVEL DISTANCE: 200	0'-0" ATER CLOSETS: 1 REQUIRED FOR MALE, 1	-					STATE OF INDIANA AR19500067
DESCRIPTIVE SUMMARY OF WOR	RK	SYMBOLS L	LEGEND			RE	QUIRED FOR FEMALE (2 PROVIDED) VATORIES: 1 REQUIRED FOR MALE, 1 REQUIRED	-			VICINITY MAP	PROJECT SITE	REGISTERED ARCHITECT DONALD J. WALLIN
				_		FO	R FEMALE	-		0			EXPIRATION DATE: 12/31/2017
THE WORK INCLUDES ALL LABOR, MATERIALS, AND REPLACE EXISTING PRE-FABRICATED FASCIA AND II		(X.X)— NEW GRII	D LINE	DETAIL REFER SHEET NUMBE			RINALS1 PROVIDED RINKING FOUNTAINSNOT REQUIRED	-			The state of		SEAL
A PROPOSED REFRESH OF AN EXISTING RESTAURA THE WORK SHALL INCLUDE ALL ITEMS REQUIRED AS		* DOOR MA		CITELI NOMBL	`	PU	IBLIC ACCESSPROVIDED			à.			
DRAWINGS. ALL ELECTRICAL SYSTEMS AND PLUMB INCLUDED FOR A COMPLETE OPERATING SYSTEM W	BING ARE TO BE		11 (6A) \12	ELEVATION NU DIRECTION	JMBER &	UN	IISEX IS PERMITTEDN/A	1				The second second	
AND INSTALLATION INCLUDED.	SSSRDIIWATION	(#) WINDOW	MARK " OF THE STATE OF THE STAT	SHEET NUMBE	ER					e i			A I
		⊗ KEY NOT		ELEVATION HE	IGHT TARGET								
		(VVV) FOLUENATION	+15'-9"_ T.O. PARAPE"	LOCATION IN S									
		EQUIPME	IN I INU I E	⊥ FINISH CODE (SEE					•	THE STATE OF THE S		SHEET NAME COVER SHEET
		ELEVATION SHEET N	ON REFERENCE FLOOR BA	SCHEDULE)	o LL						41 2 34 3		
			۵	REVISION SYM	IBOL						HIS TO THE REAL PROPERTY.	The state of the s	SHEET NUMBER
		SECTION SHEET N	DETAIL REFERENCE UMBER	REVISION CLO							1.00	The second secon	
		•			J <i>D</i>	I .		I			1 mile 1 1 1 1 1 1 1 1 1 1 1 1 1 1 1 1 1 1 1	NORTH	

ROOM NAME ROOM NUMBER

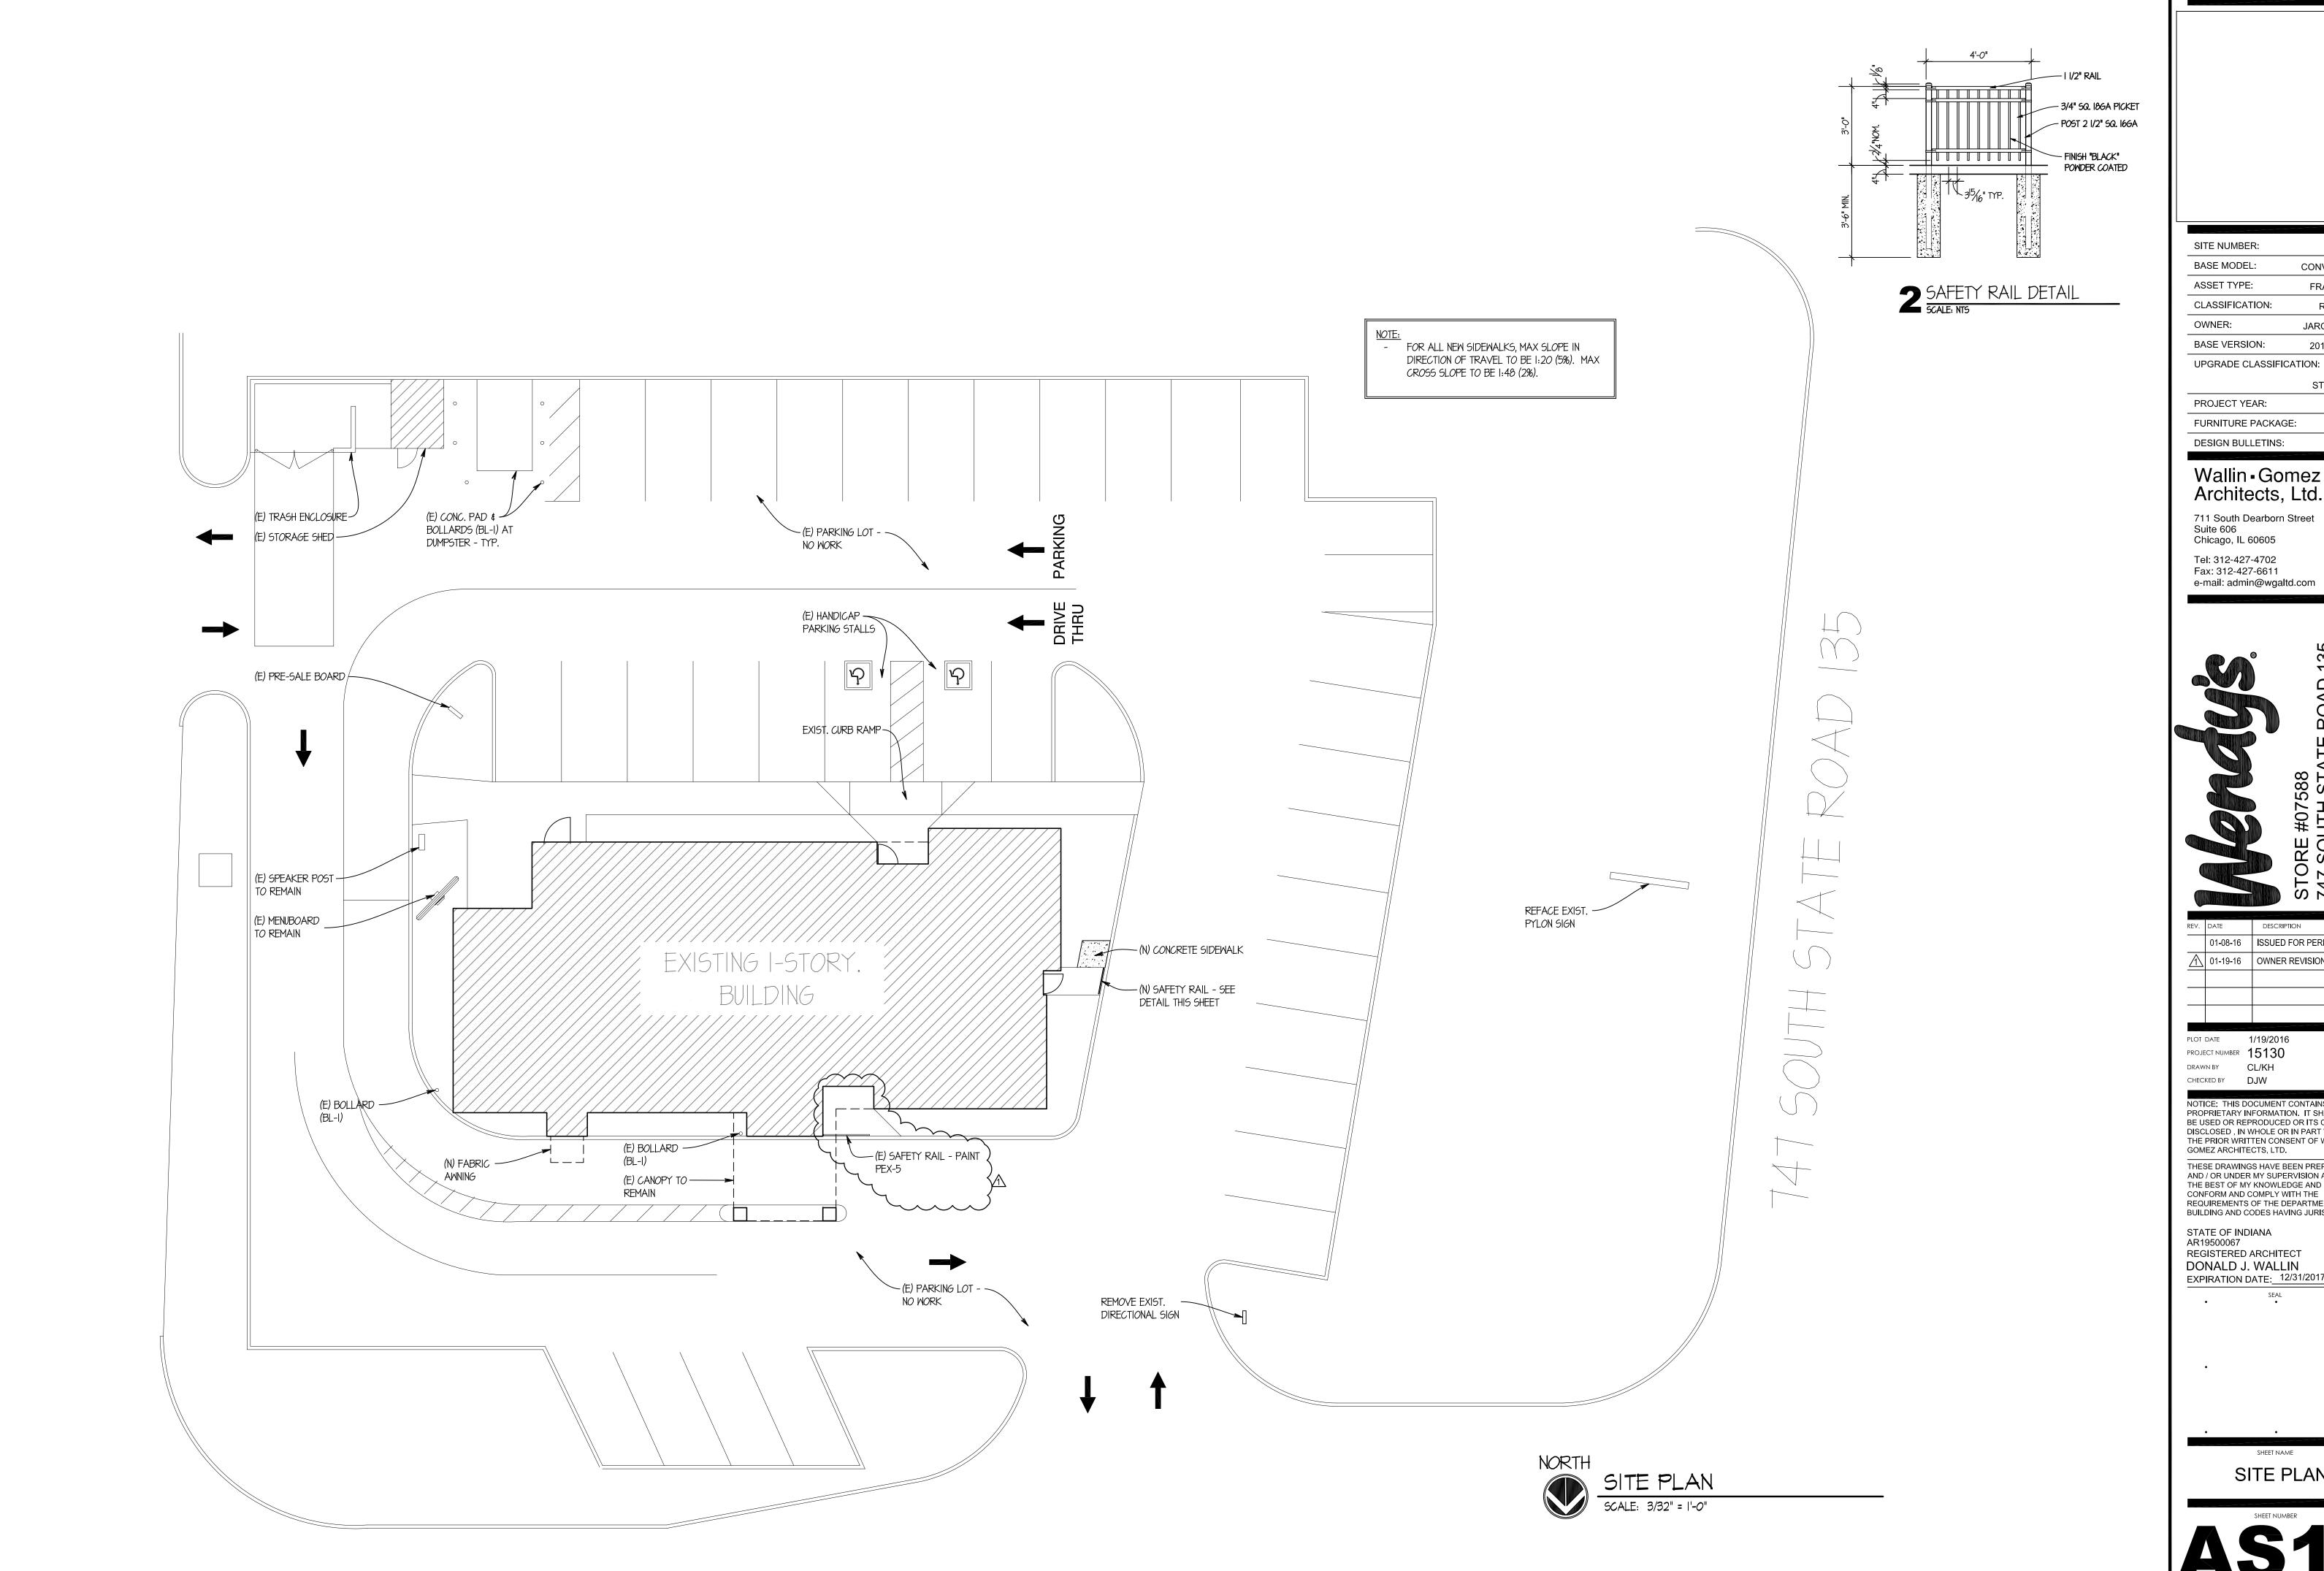

SITE NUMBER: 07588 BASE MODEL: CONVERSION ASSET TYPE: FRANCHISE CLASSIFICATION: REFRESH OWNER: JARO FOODS BASE VERSION: 2016 JAN 05

	STANDARD
PROJECT YEAR:	2016
FURNITURE PACKAGE:	2015

DESIGN BULLETINS:

Wallin - Gomez Architects, Ltd.

711 South Dearborn Street Suite 606 Chicago, IL 60605 Tel: 312-427-4702 Fax: 312-427-6611 e-mail: admin@wgaltd.com



V						
/.	DATE	DESCRIPTION				
	01-08-16	ISSUED FOR PERMIT & BID				
7	01-19-16	OWNER REVISIONS				

PROJECT NUMBER 15130 CHECKED BY DJW

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STATE OF INDIANA AR19500067 REGISTERED ARCHITECT


DONALD J. WALLIN


EXPIRATION DATE: 12/31/2017


SITE PLAN

<u>DEMOLITION GENERAL NOTES</u> THE GENERAL CONTRACTOR SHALL BE RESPONSIBLE FOR ALL DEMOLITION WORK REQUIRED TO IMPLEMENT NEW WORK, AS SHOWN ON OTHER DRAWINGS. THIS PLAN INDICATES ONLY THE APPROXIMATE DEMOLITION REQUIRED FOR COMPLETION OF THIS REMODEL. EXISTING CONDITIONS NOT SHOWN OR NOTED SHALL REMAIN UNCHANGED UNLESS APPROVED BY THE ARCHITECT OR OWNER'S REPRESENTATIVE. ALL EXISTING MATERIALS ADJACENT TO THE NEW CONSTRUCTION SHALL BE PATCHED, REPAIRED, AND FINISHED TO PROVIDE A SMOOTH, LEVEL AND UNNOTICEABLE TRANSITION BETWEEN NEW AND EXISTING FINISHES. CONTRACTOR SHALL VERIFY FIELD CONDITIONS AND NOTIFY WENDY'S REPRESENTATIVE AND ARCHITECT OF ALL DISCREPANCIES BEFORE PROCEEDING WITH WORK. PREVENT MOVEMENT OR SETTLEMENT OF STRUCTURE(S). PROVIDE AND PLACE BRACING OR SHORING TO ENSURE SAFETY AND SUPPORT OF STRUCTURE. G.C. TO ASSUME LIABILITY FOR SUCH MOVEMENT, DAMAGE, OR INJURY. CEASE OPERATIONS AND NOTIFY THE WENDY'S REPRESENTATIVE IMMEDIATELY IF SAFETY OF STRUCTURE APPEARS TO BE COMPROMISED. TAKE PRECAUTIONS TO PROPERLY SUPPORT STRUCTURE. DO NOT RESUME OPERATIONS UNTIL SAFETY IS RESTORED. PROVIDE, ERECT, AND MAINTAIN BARRICADES, LIGHTING, AND GUARD RAILS AS REQUIRED BY APPLICABLE CODES TO PROTECT OCCUPANTS OF BUILDING, WORKERS, AND PEDESTRIANS. BEFORE DISCONNECTING, REMOVING, AND CAPPING UTILITY SERVICES WITHIN AREAS OF DEMOLITION, NOTIFY THE LOCAL UTILITY COMPANY AND WENDY'S REPRESENTATIVE IN ADVANCE AND OBTAIN APPROVAL BEFORE STARTING THE WORK. HVAC SUBCONTRACTOR TO INSPECT EXISTING CONDITIONS PRIOR TO DEMOLITION, AND DETERMINE WHETHER ANY COMPRESSOR REFRIGERANT LINES ARE PRESENT THAT MUST BE PROPERLY DRAINED (TO E.P.A. STANDARDS) PRIOR TO DEMOLITION. PLACE MARKERS TO INDICATE LOCATION OF DISCONNECTED SERVICES. IDENTIFY SERVICE LINES AND CAPPING LOCATIONS ON PROJECT RECORD DOCUMENTS. EXCEPT WHERE NOTED OTHERWISE, MAINTAIN POSSESSION OF MATERIALS BEING DEMOLISHED. IMMEDIATELY REMOVE FROM 10. DEMOLISH IN AN ORDERLY AND CAREFUL MANNER AS REQUIRED TO ACCOMMODATE NEW WORK, INCLUDING THAT REQUIRED FOR CONNECTION TO THE EXISTING BUILDING. PROTECT EXISTING FOUNDATIONS AND SUPPORTING STRUCTURAL MEMBERS. PERFORM DEMOLITION IN ACCORDANCE WITH APPLICABLE AUTHORITIES HAVING JURISDICTION. 12. REPAIR ALL DEMOLITION PERFORMED IN EXCESS OF THAT REQUIRED, AT NO COST TO OWNER. 13. BURNING OF MATERIALS ON SITE IS NOT PERMITTED. 14. REMOVE DEMOLISHED MATERIALS, TOOLS, AND EQUIPMENT FROM SITE UPON COMPLETION OF WORK. LEAVE SITE IN CONDITION ACCEPTABLE TO WENDY'S REPRESENTATIVE. WENDY'S VENDOR TO REMOVE ALL F.F.&E. PRIOR TO G.C.'S DEMOLITION START. G.C. TO PROTECT AND SHRINK-WRAP REMAINING F.F.&E. NOT AFFECTED BY REMODEL WORK FOR DURATION OF REMODEL. G.C. TO COORDINATE WITH WENDY'S REPRESENTATIVE. PRIOR TO BID SUBMISSION, THE G.C. SHALL MAKE A SITE VISIT TO REVIEW THE DEMOLITION REQUIREMENTS INCLUDING, BUT NOT LIMITED TO SITE WORK, EXTERIOR & INTERIOR OF THE EXISTING STRUCTURE. REVIEW M.E.P. DRAWINGS FOR DEMOLITION REQUIREMENTS / UTILITY RELOCATIONS. COORDINATE ALL DEMOLITION WITH WENDY'S REPRESENTATIVE. REMOVE EXISTING FLOOR & WALL FINISHES AS NOTED AND AS REQUIRED FOR NEW FINISHES. CLEAN, PREP, AND REPAIR ALL SUBSTRATES TO SPECIFICATION REQUIREMENTS OF NEW SCHEDULE FINISHES. 18. DISCONNECT AND/OR REMOVE ALL UNUSED / ABANDONED ELECTRICAL CIRCUITS FROM ELECTRICAL SOURCE PER CODE. 19. CAP, DISCONNECT AND/OR REMOVE ALL PLUMBING LINES NOTED FOR DEMOLITION ACCORDANCE WITH CODE. 20. WHENEVER PRACTICAL TO DO SO AND/OR AS DIRECTED BY WENDY'S REPRESENTATIVE ALL UNUSED UTILITIES SHALL BE REMOVED IN THEIR ENTIRETY. REMOVE (E) FINISHES AND TRIM THROUGHOUT DINING ROOM, HALL, VESTIBULE & RESTROOMS AS REQUIRED FOR NEW WORK. EXISTING GYPSUM BOARD TO REMAIN IF POSSIBLE EXCEPT WHERE SPECIFICALLY NOTED OTHERWISE. 22. G.C. TO PHOTOGRAPH AND DOCUMENT THE LOCATION OF ALL KITCHEN AND SERVICE AREA EQUIPMENT PRIOR TO THE START OF CONSTRUCTION

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Wallin - Gomez Architects, Ltd

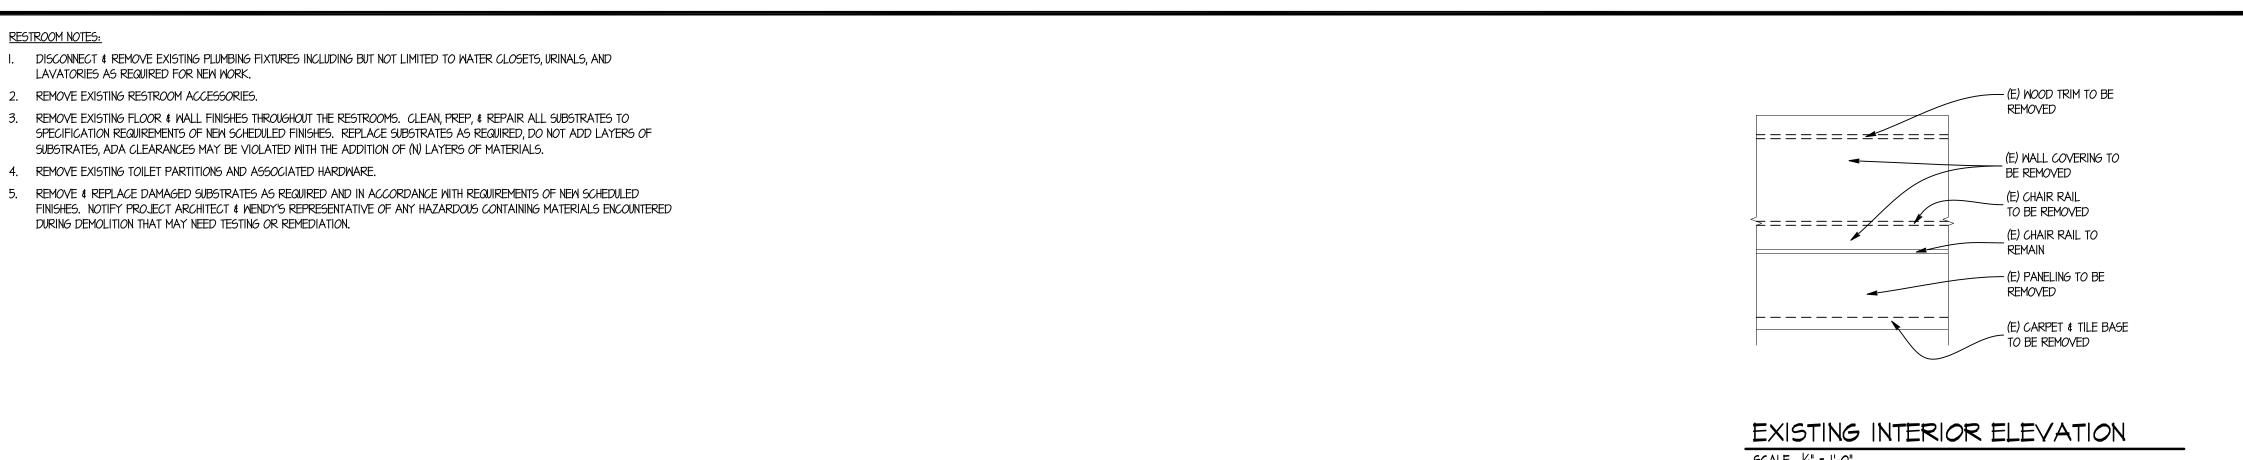711 South Dearborn Street Suite 606 Chicago, IL 60605 Tel: 312-427-4702

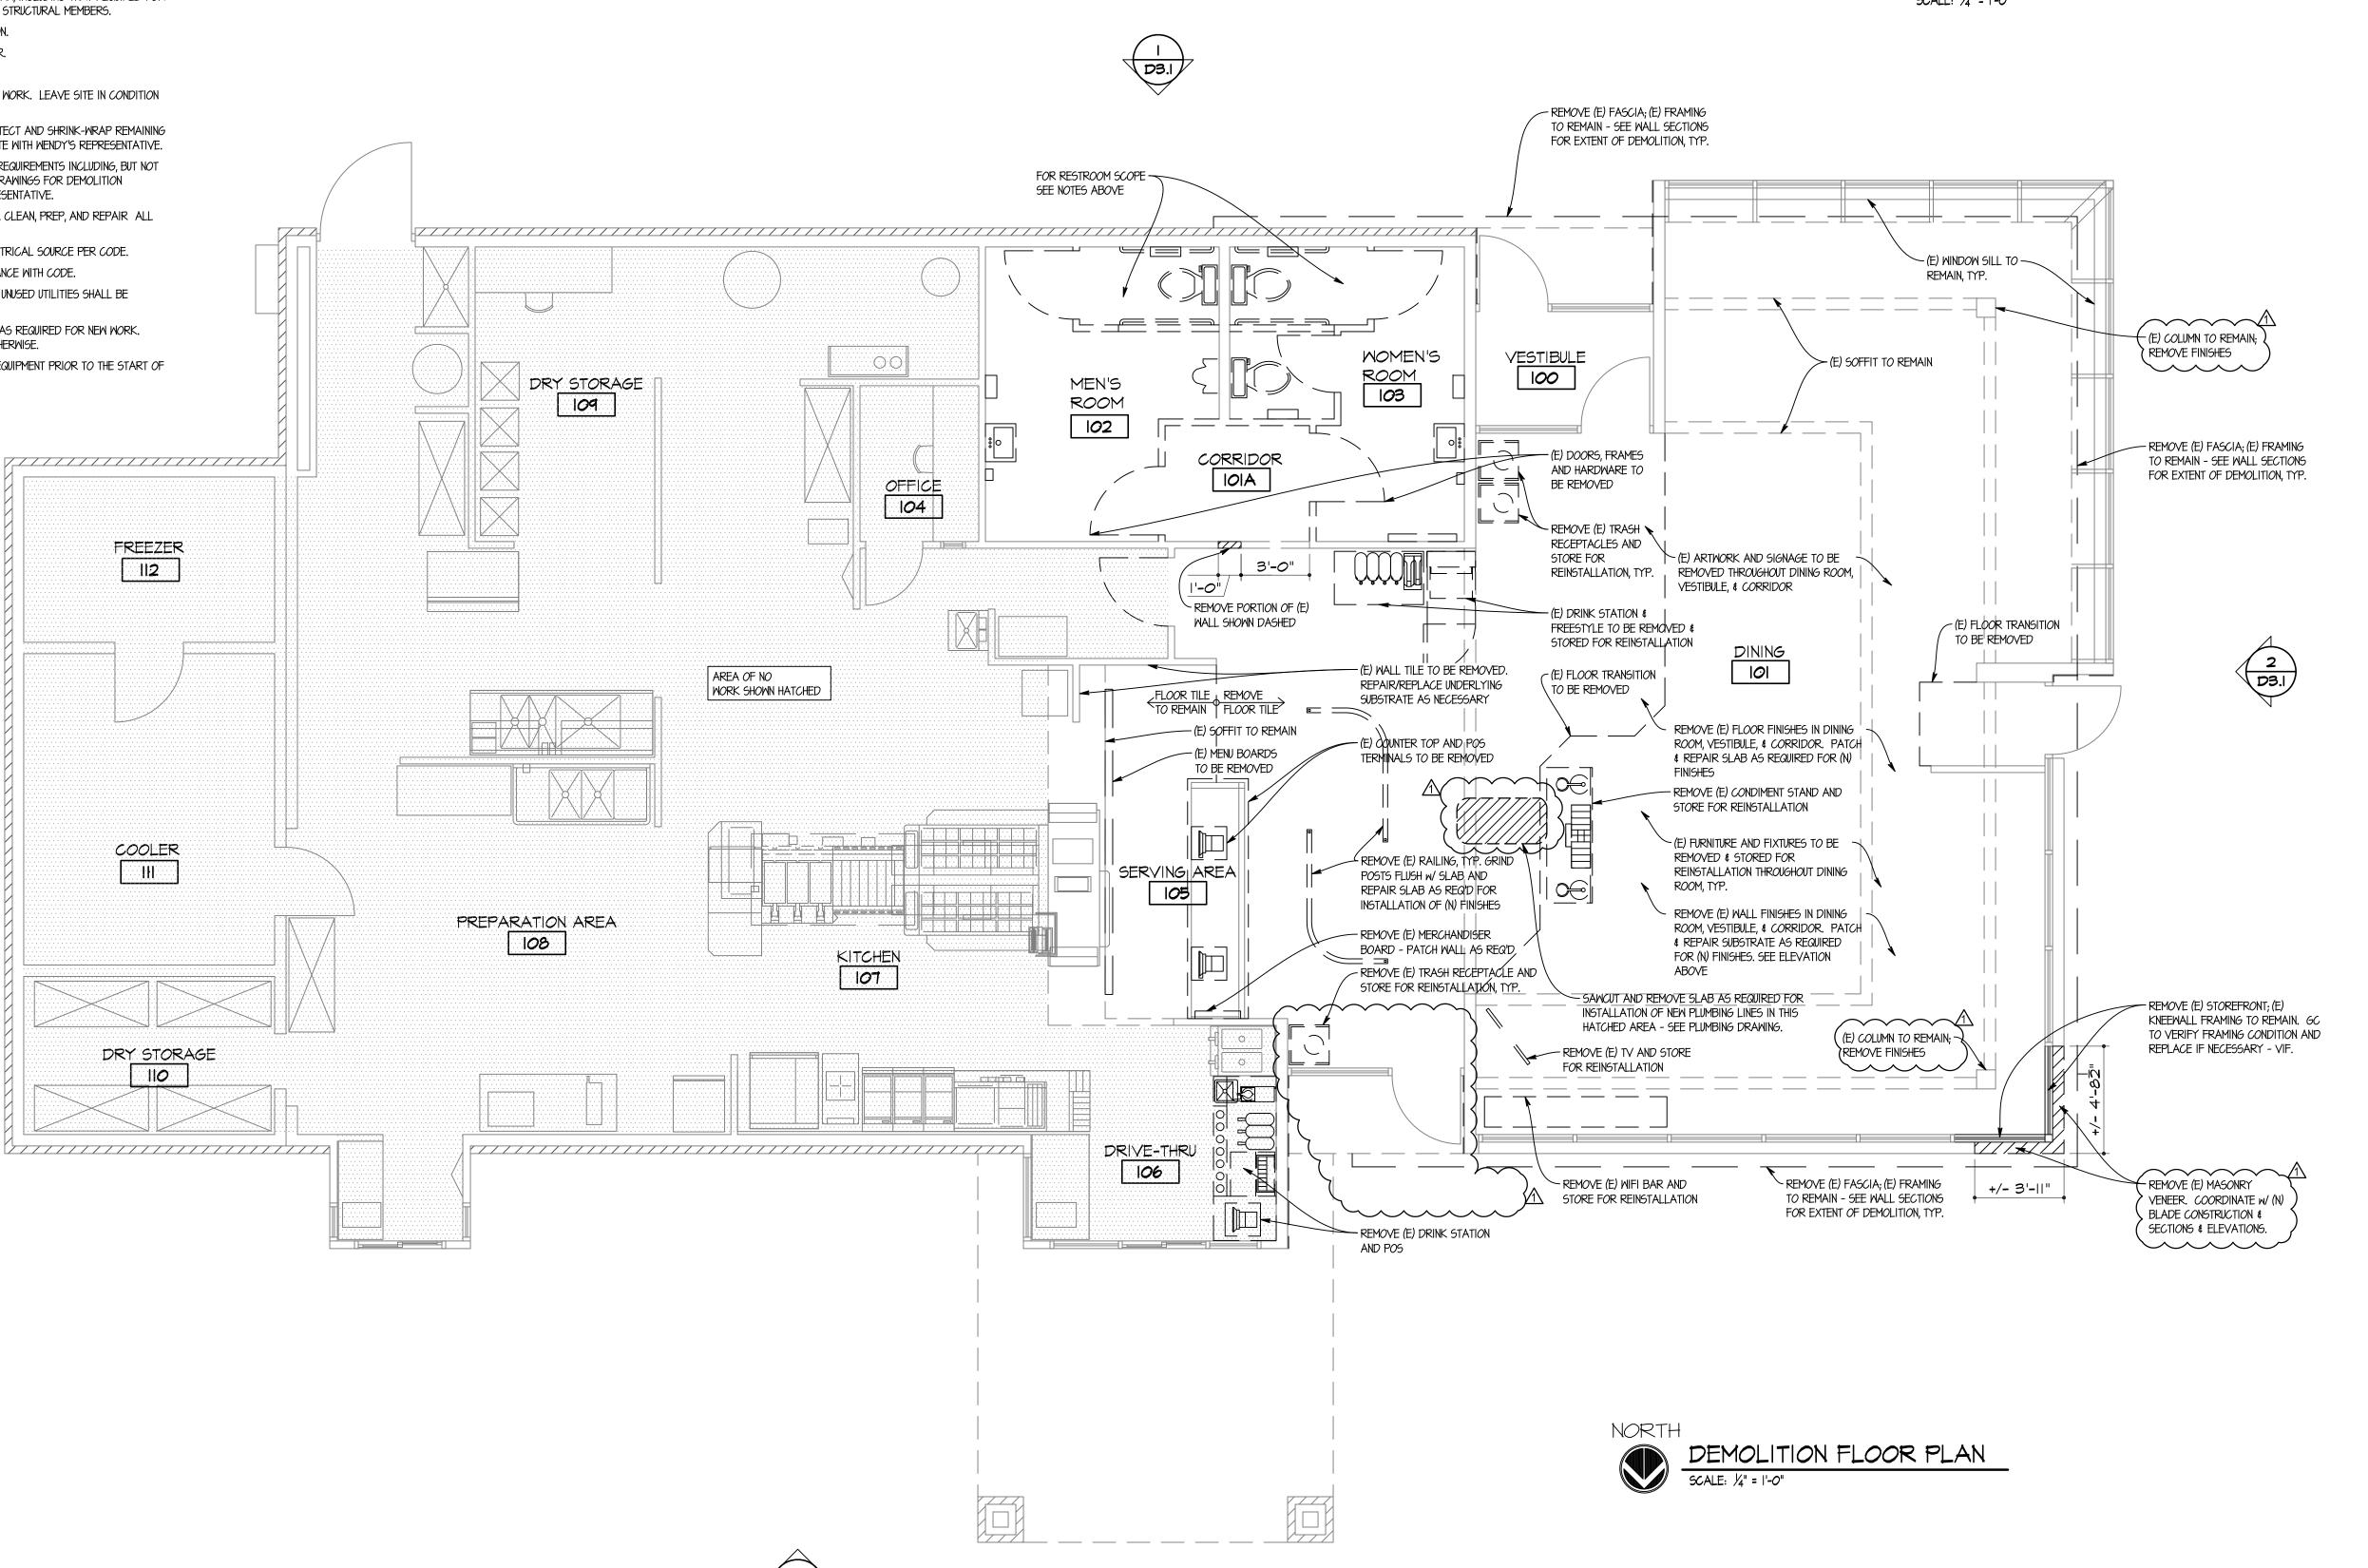Fax: 312-427-6611 e-mail: admin@wgaltd.com

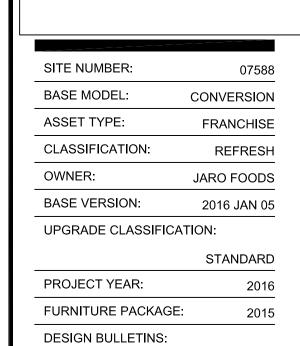
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٧.	DATE	DESCRIPTION				
	01-08-16	ISSUED FOR PERMIT & BID				
<u>1</u>	01-19-16	OWNER REVISIONS				

PLOT DATE 1/19/2016 PROJECT NUMBER 15130 DRAWN BY CL/KH CHECKED BY DJW


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STATE OF INDIANA AR19500067 REGISTERED ARCHITECT DONALD J. WALLIN EXPIRATION DATE: 12/31/2017



DEMOLITION **FLOOR PLAN**

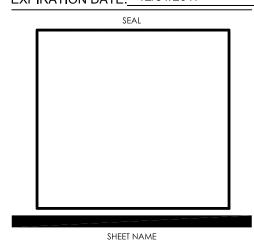

SITE NUMBER: 07588 BASE MODEL: CONVERSION ASSET TYPE: FRANCHISE CLASSIFICATION: REFRESH OWNER: JARO FOODS BASE VERSION: 2016 JAN 05 UPGRADE CLASSIFICATION: STANDARD PROJECT YEAR: 2016 FURNITURE PACKAGE:

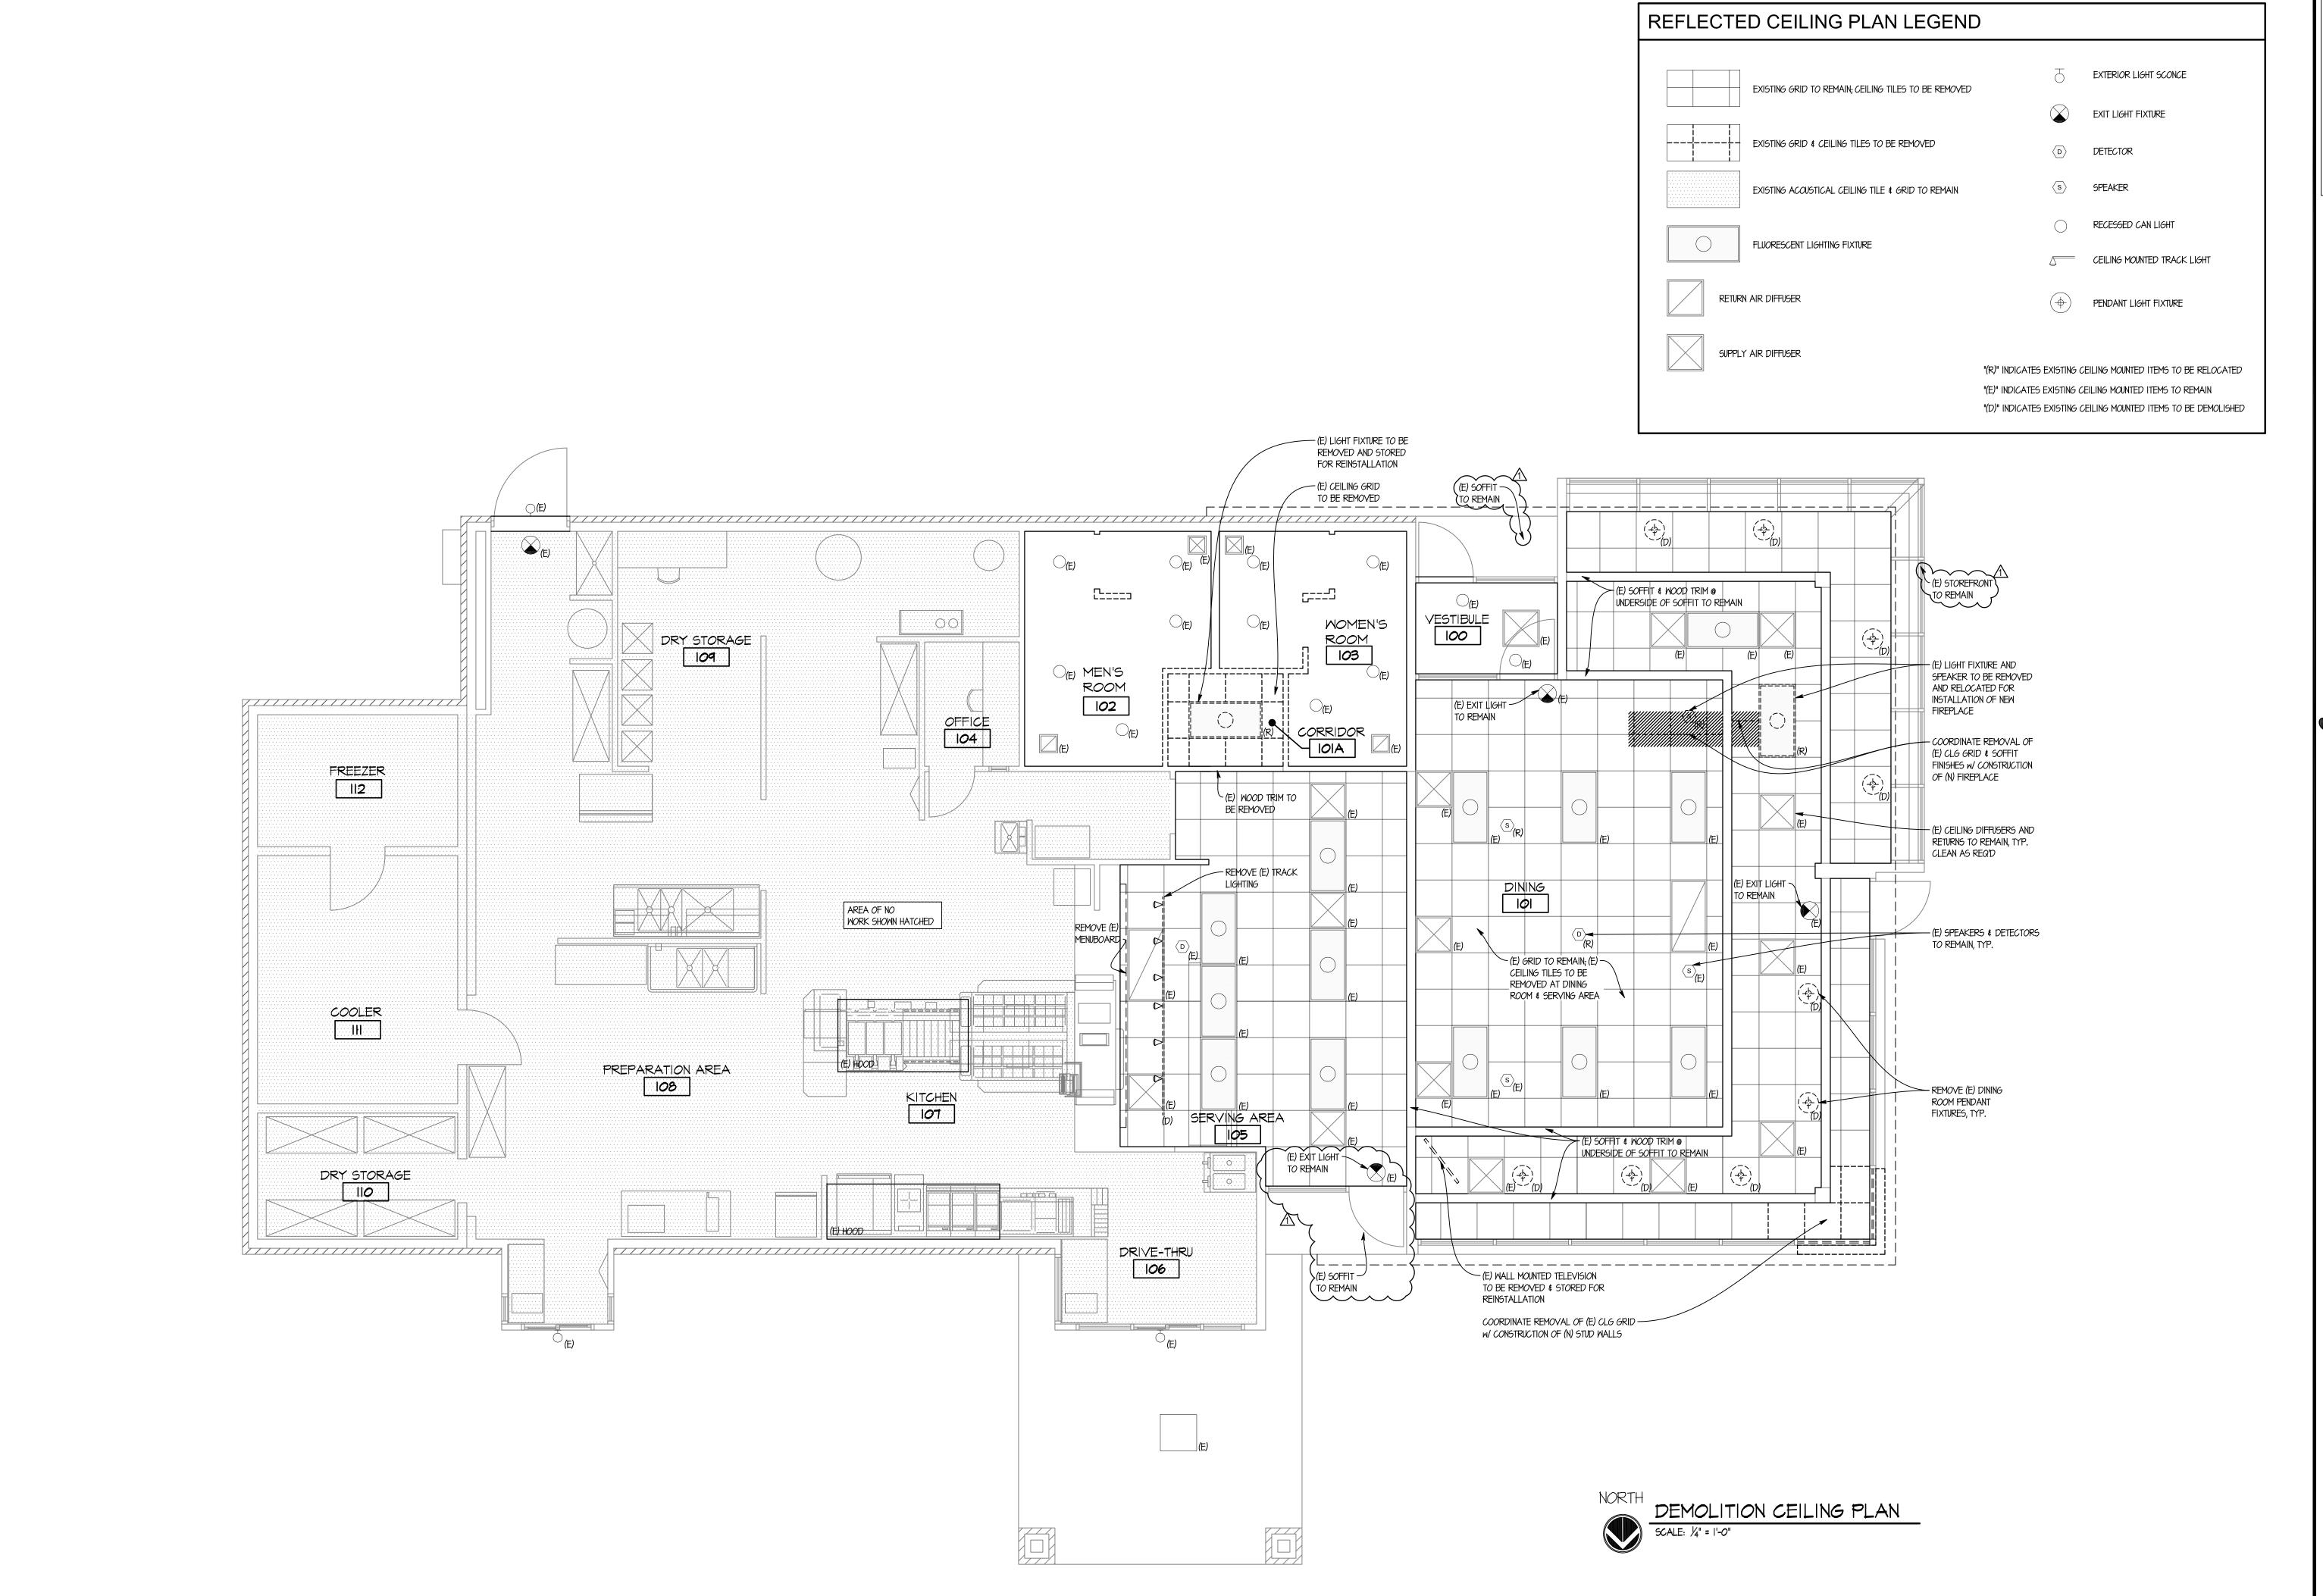Wallin - Gomez Architects, Ltd.

711 South Dearborn Street Suite 606 Chicago, IL 60605 Tel: 312-427-4702 Fax: 312-427-6611

DESIGN BULLETINS:

e-mail: admin@wgaltd.com



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REV.	DATE	DESCRIPTION			
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$\overline{\mathbb{A}}$	01-19-16	OWNER REVISIONS			

PROJECT NUMBER 15130 DRAWN BY CL/KH CHECKED BY DJW

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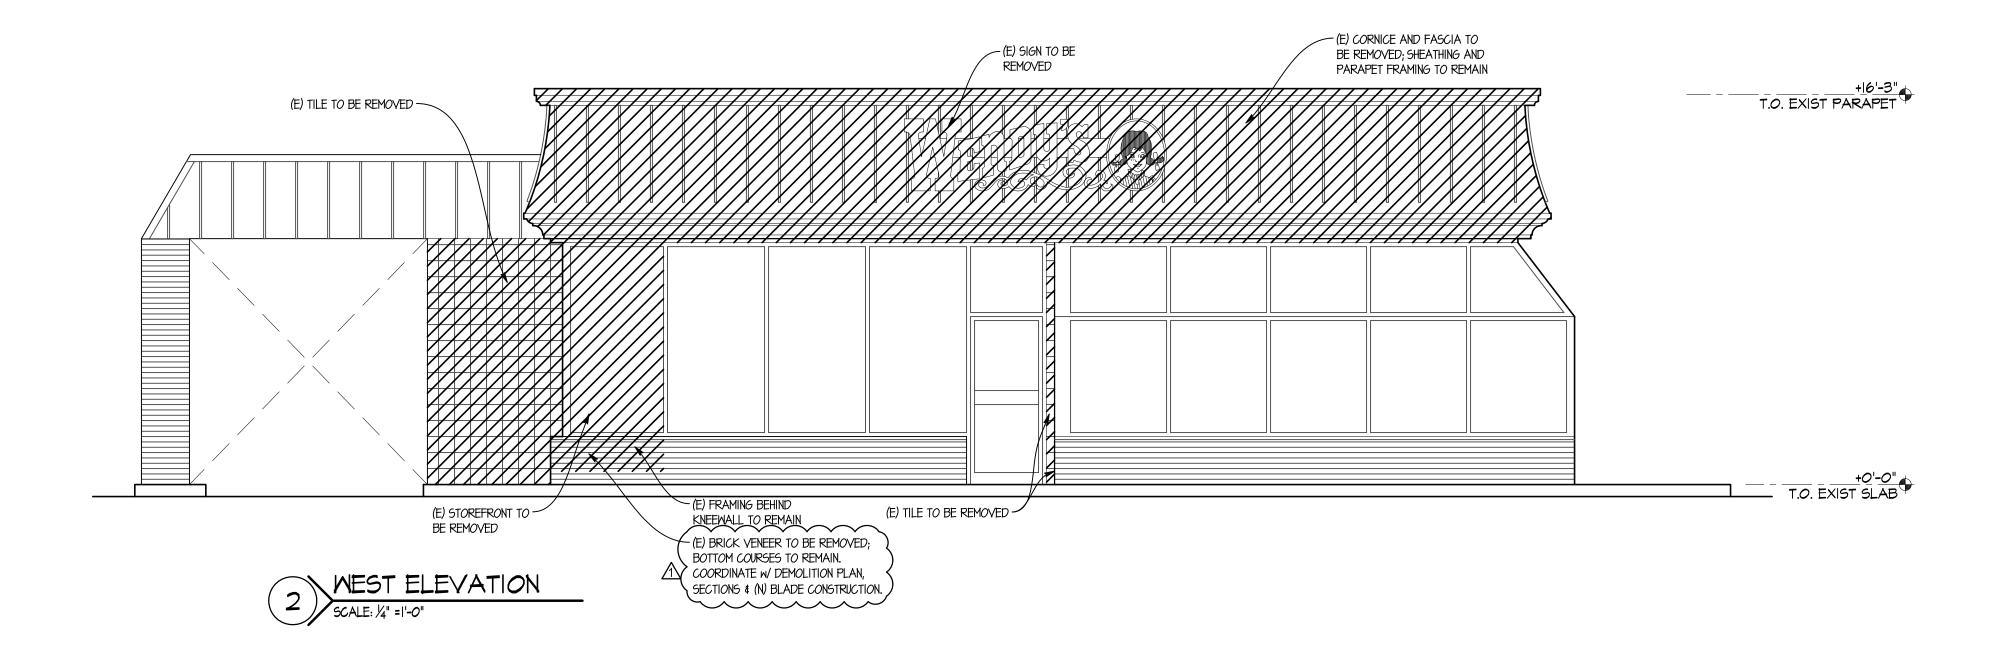
> DEMOLITION **CEILING PLAN**


EXISTING SIGNAGE CALCS

 WEST
 32.5 SF

 EAST
 32.5 SF

 TOTAL
 65 SF



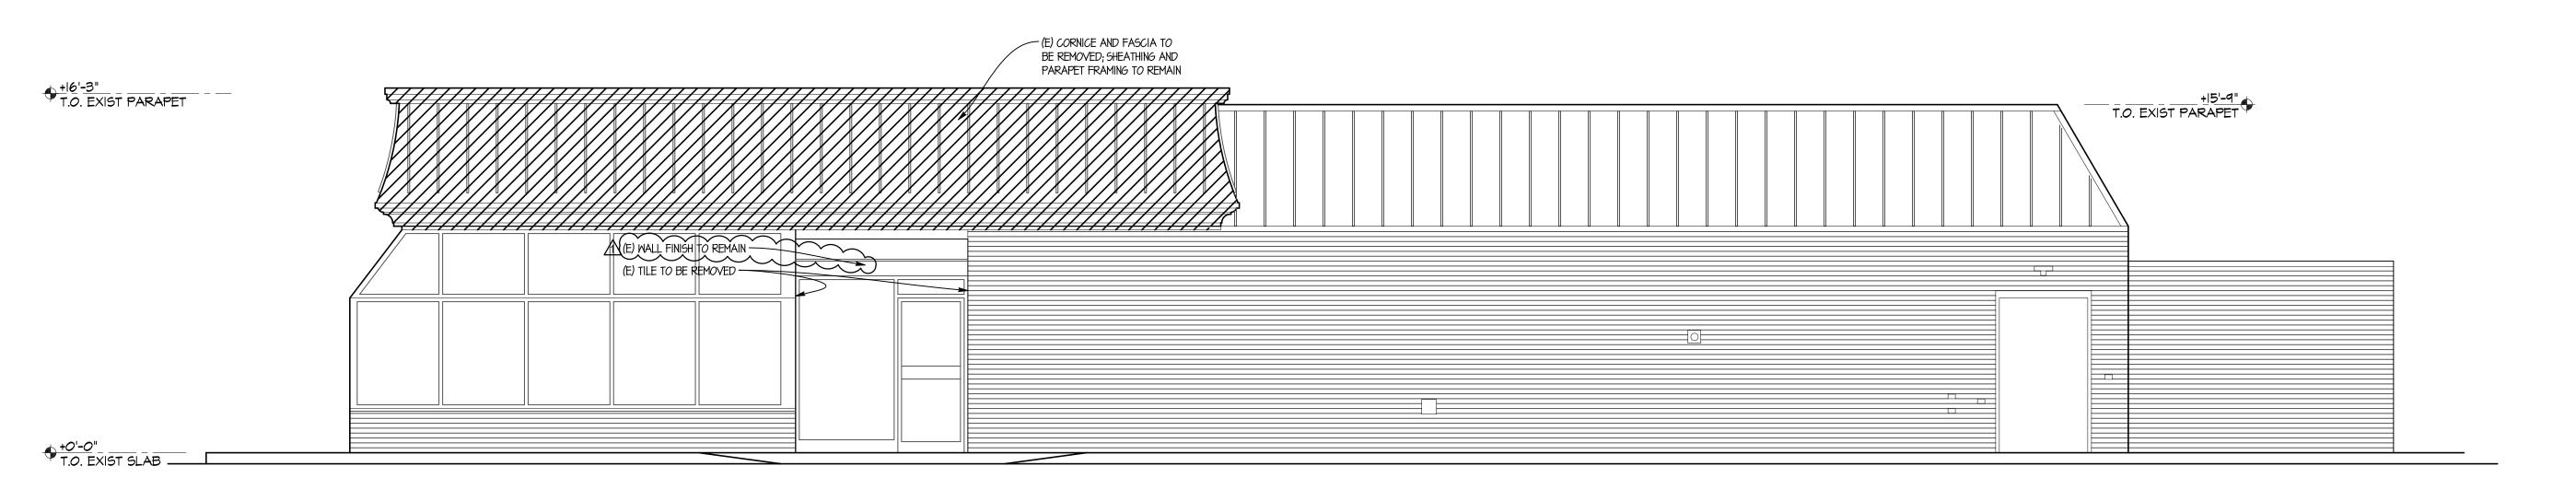

SOUTH ELEVATION

SCALE: 1/4" =1'-0"

	SITE NUMBER:	07588
	BASE MODEL:	CONVERSION
	ASSET TYPE:	FRANCHISE
	CLASSIFICATION:	REFRESH
	OWNER:	JARO FOODS
	BASE VERSION:	2016 JAN 05
	UPGRADE CLASSIFICA	ATION:
		STANDARD
	PROJECT YEAR:	2016
•	FURNITURE PACKAGE	2015
•	DESIGN BULLETINS:	

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711 South Dearborn Street
Suite 606
Chicago, IL 60605
Tel: 312-427-4702
Fax: 312-427-6611
e-mail: admin@wgaltd.com

STORE #07588
747 SOUTH STATE ROAD 135

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PROJECT NUMBER 1/19/2016

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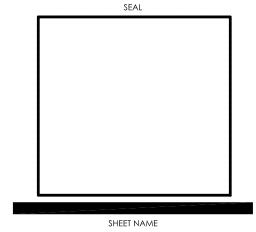
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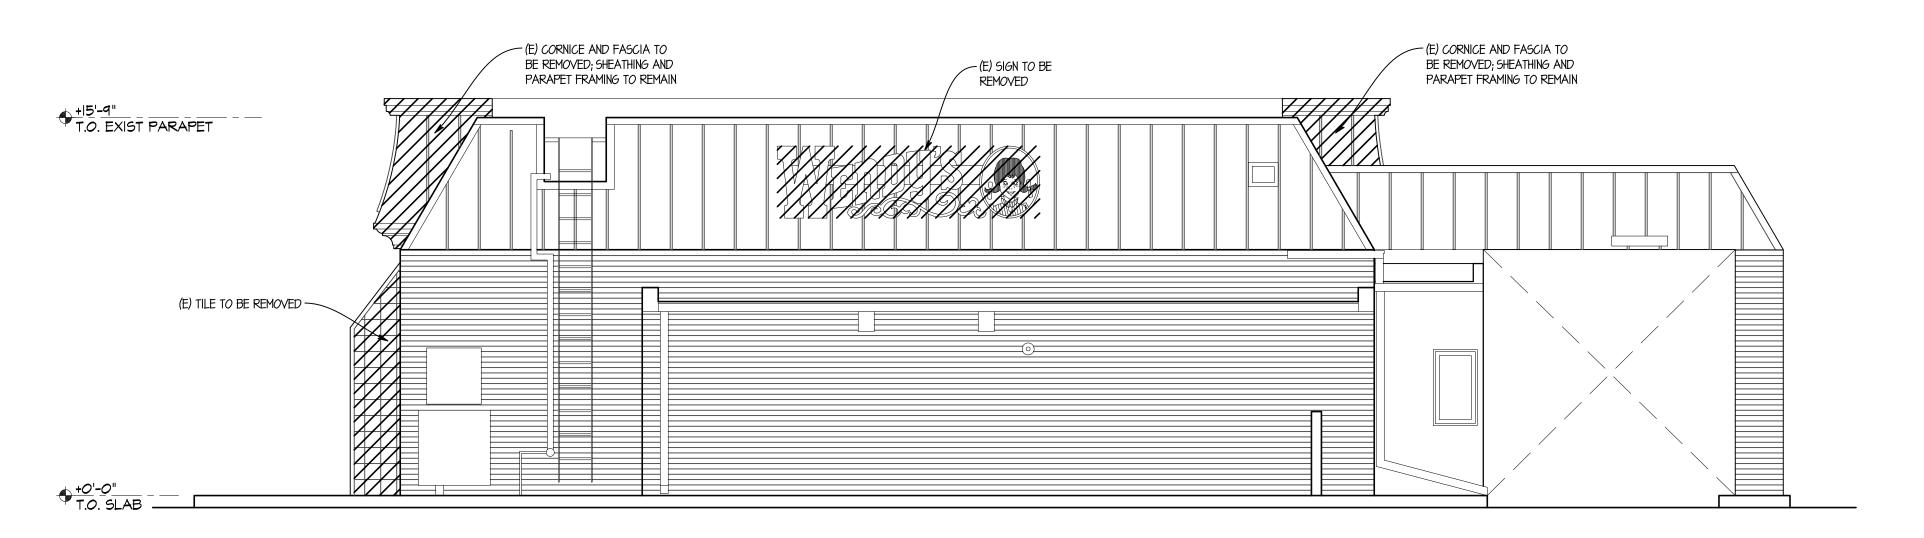
STATE OF INDIANA
AR19500067
REGISTERED ARCHITECT
DONALD J. WALLIN
EXPIRATION DATE: 12/31/2017




DEMOLITION ELEVATIONS



32.5 SF TOTAL 65 SF



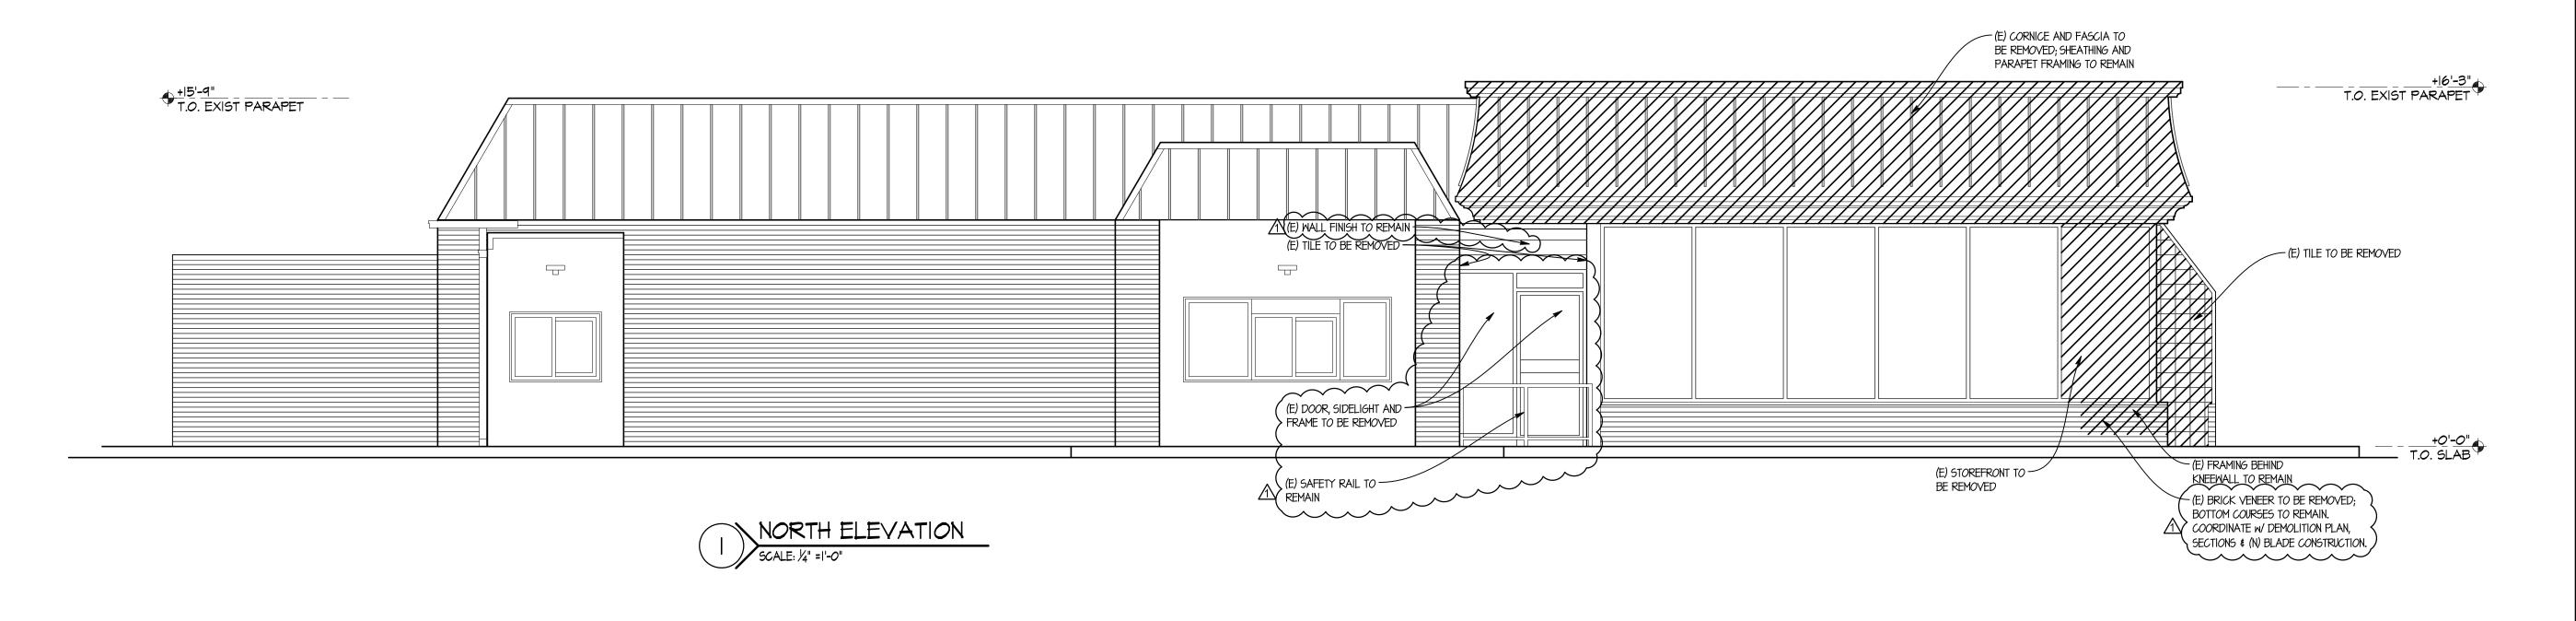

SITE NUMBER:	07588
BASE MODEL:	CONVERSION
ASSET TYPE:	FRANCHISE
CLASSIFICATION:	REFRESH
OWNER:	JARO FOODS
BASE VERSION:	2016 JAN 05
UPGRADE CLASSIFICA	TION:
	STANDARD
PROJECT YEAR:	2016
FURNITURE PACKAGE:	2015
DESIGN BULLETINS:	

Wallin • Gomez Architects, Ltd.

711 South Dearborn Street Suite 606 Chicago, IL 60605

Tel: 312-427-4702 Fax: 312-427-6611 e-mail: admin@wgaltd.com




REV.	DATE	DESCRIPTION
	01-08-16	ISSUED FOR PERMIT & BID
<u> </u>	01-19-16	OWNER REVISIONS

PLOT DATE 1/19/2016 PROJECT NUMBER 15130 DRAWN BY CL/KH CHECKED BY DJW


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STATE OF INDIANA AR19500067 REGISTERED ARCHITECT DONALD J. WALLIN EXPIRATION DATE: 12/31/2017



DEMOLITION ELEVATIONS

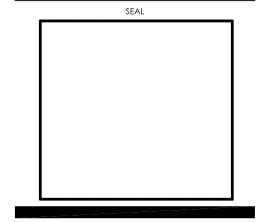

SITE NUMBER: BASE MODEL: CONVERSION ASSET TYPE: FRANCHISE CLASSIFICATION: REFRESH OWNER: JARO FOODS BASE VERSION: 2016 JAN 05

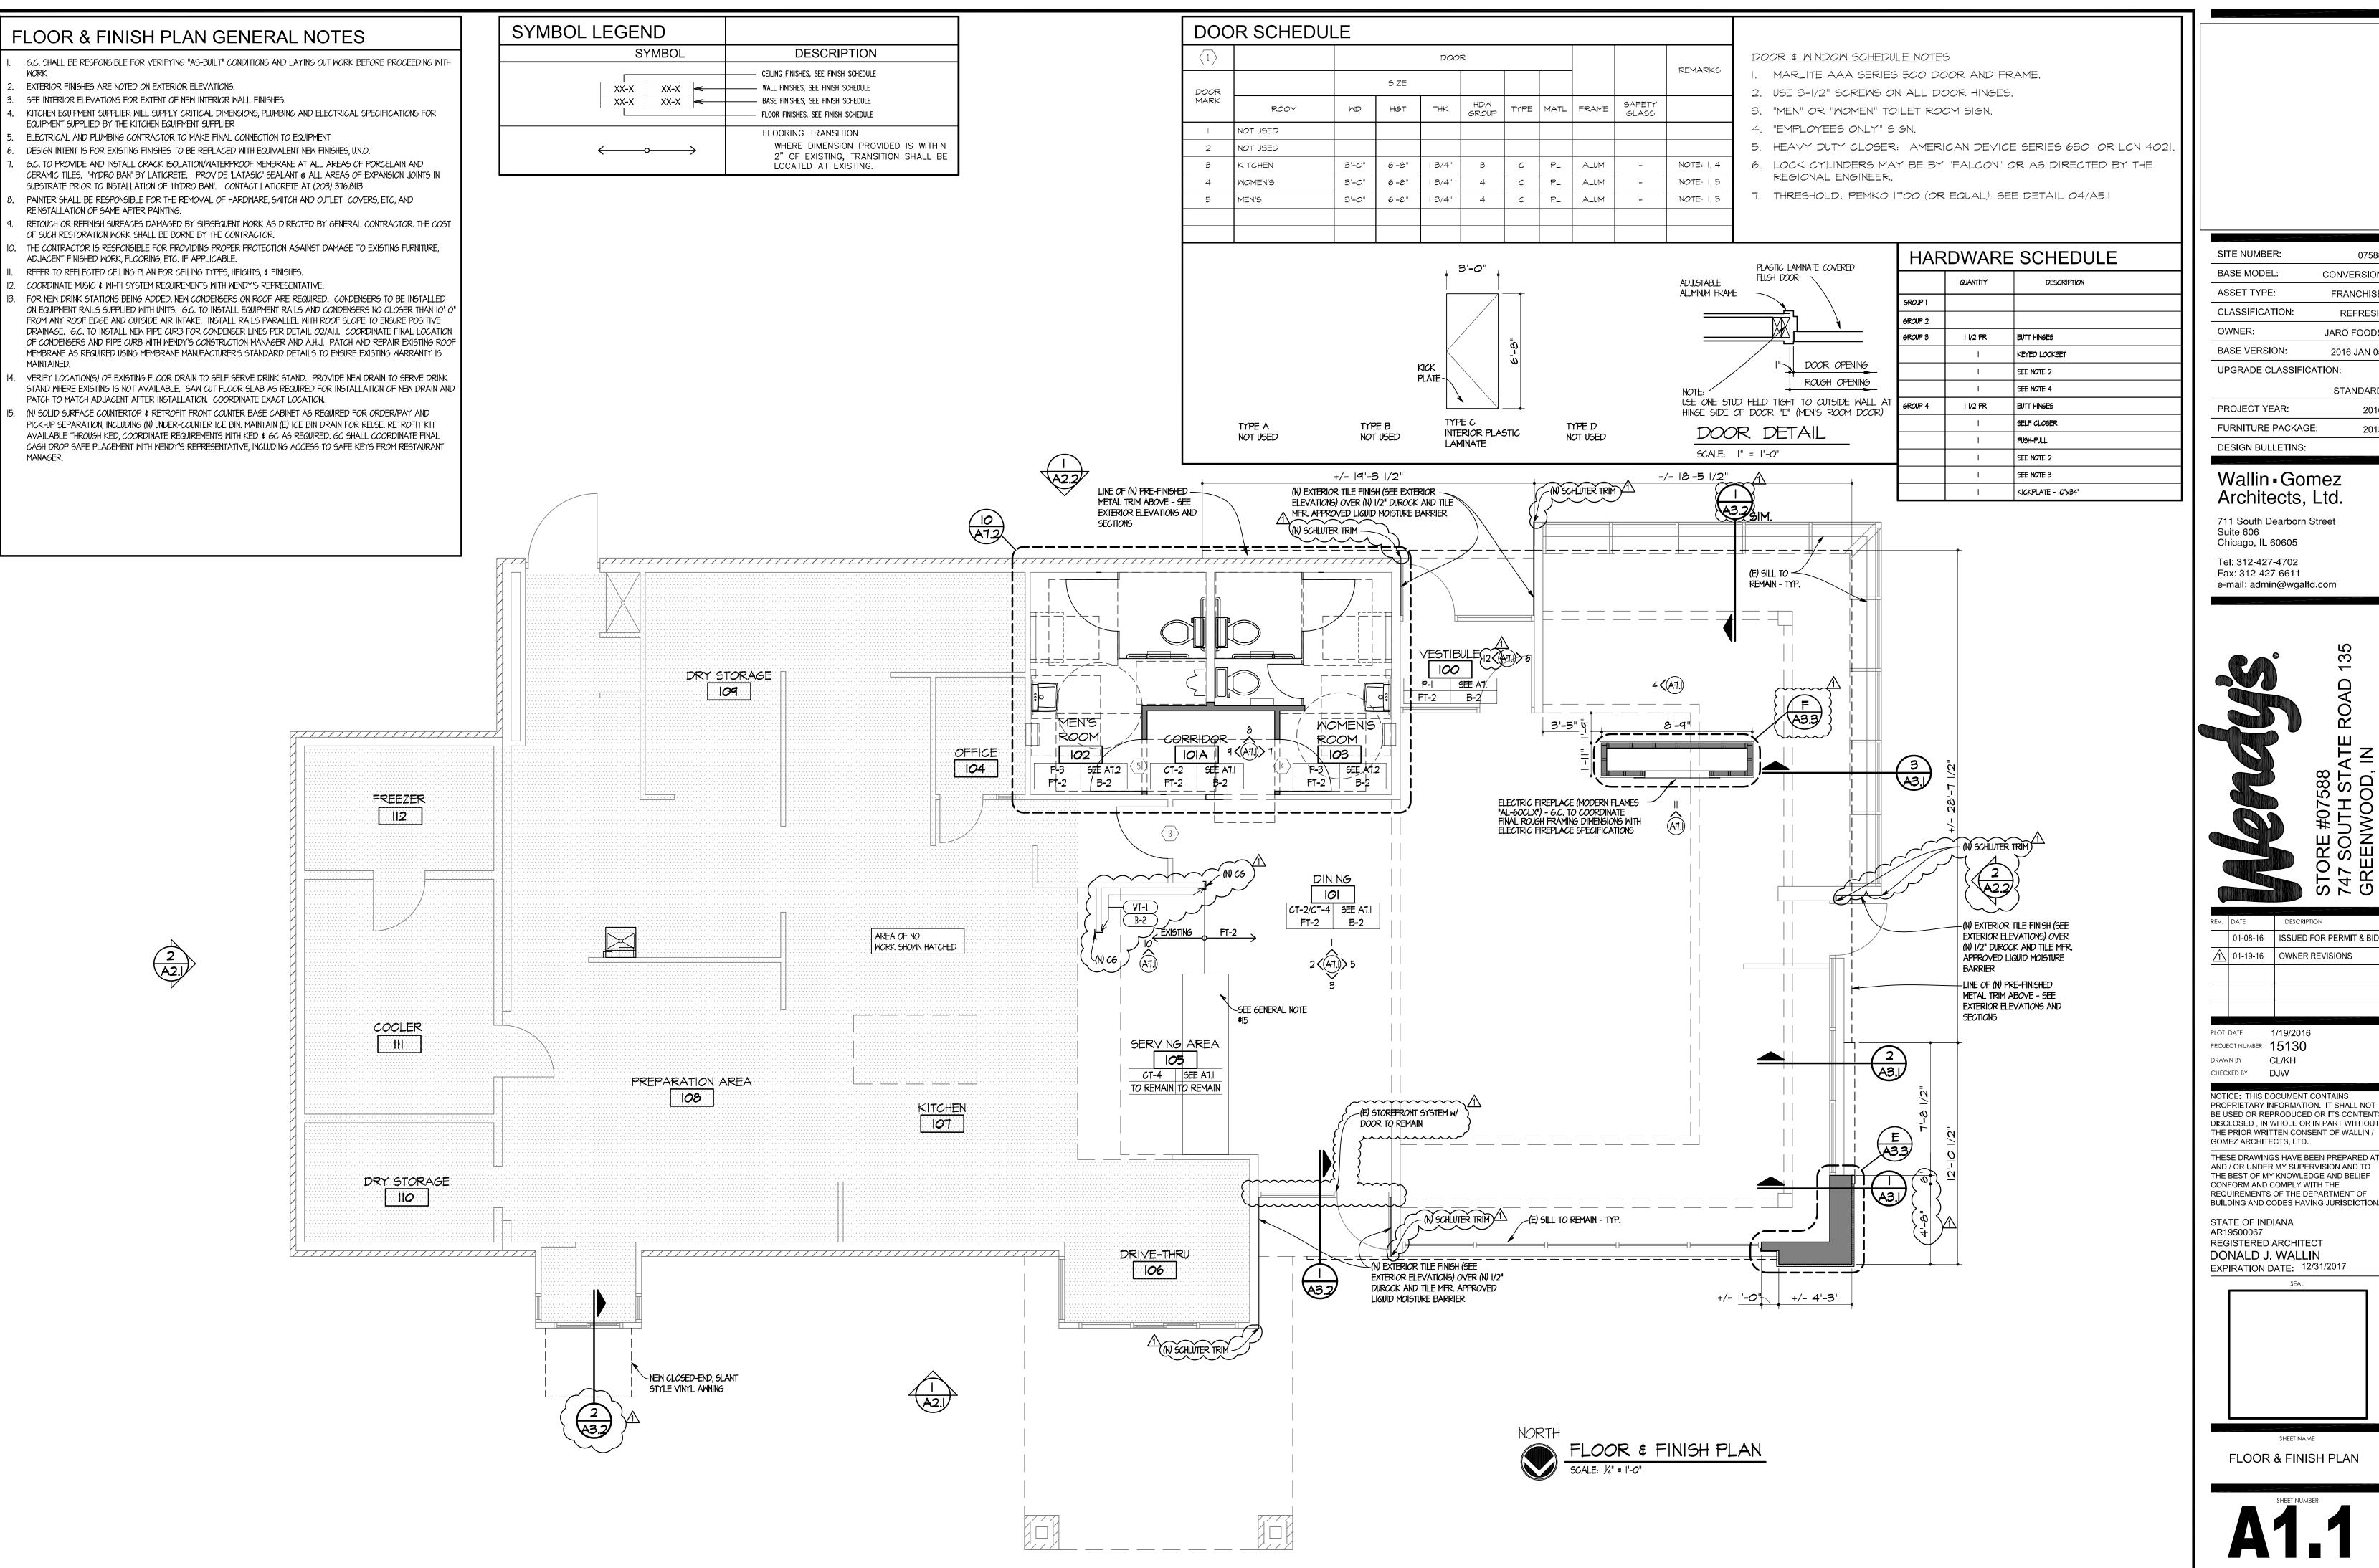STANDARD PROJECT YEAR: 2016 FURNITURE PACKAGE: 2015

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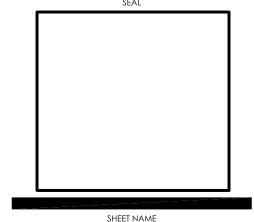
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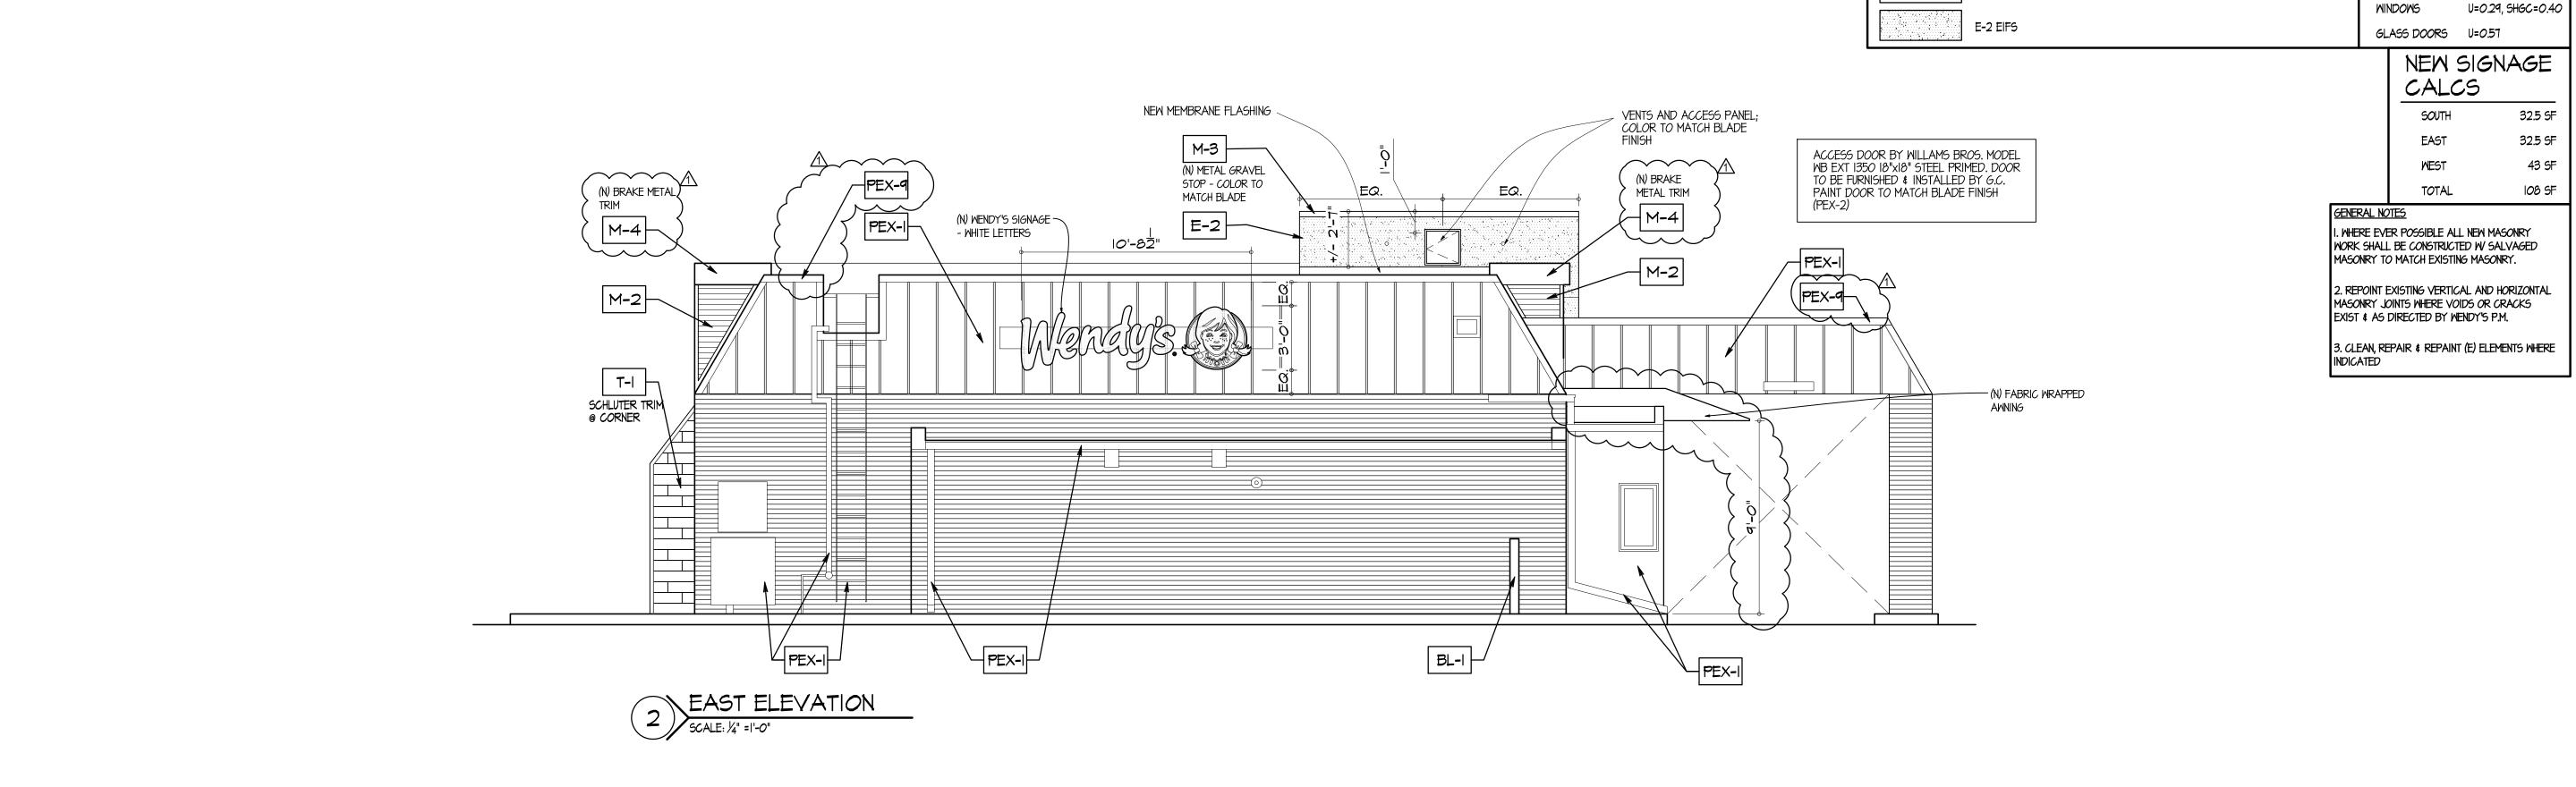
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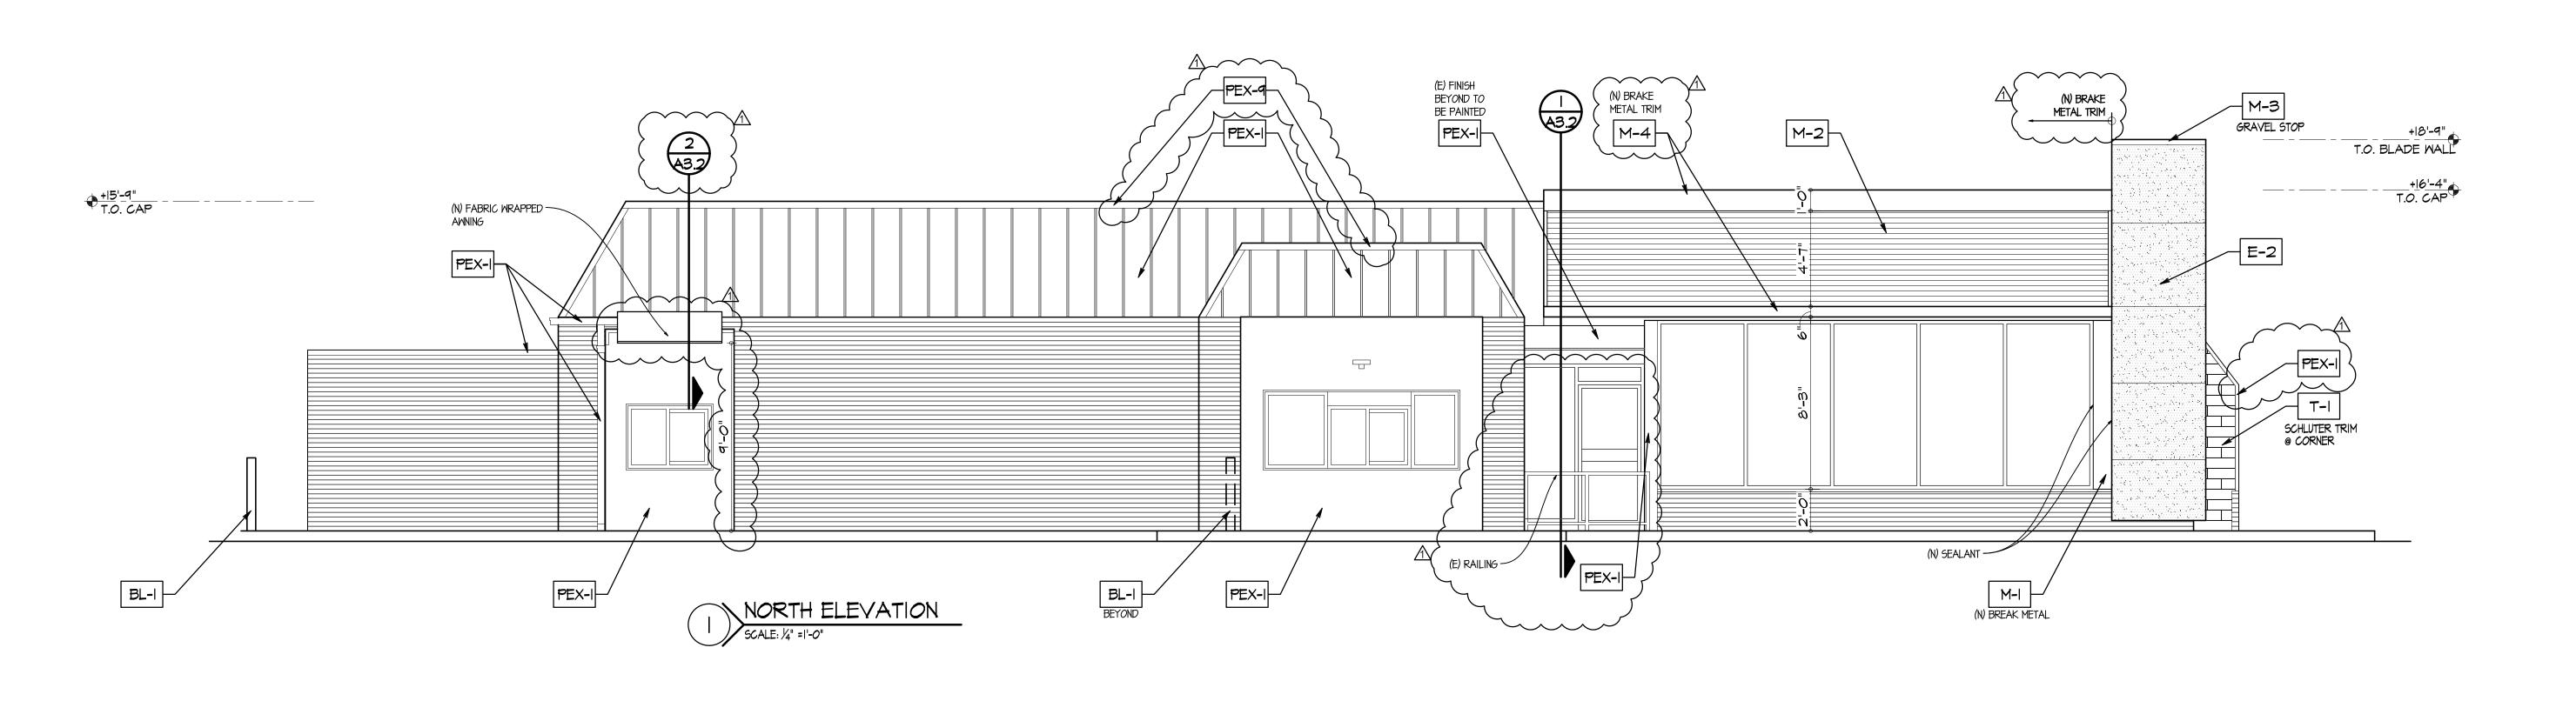
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STATE OF INDIANA AR19500067 REGISTERED ARCHITECT DONALD J. WALLIN EXPIRATION DATE: 12/31/2017



FLOOR & FINISH PLAN





SITE NUMBER: 07588

BASE MODEL: CONVERSION

ASSET TYPE: FRANCHISE

CLASSIFICATION: REFRESH

OWNER: JARO FOODS

BASE VERSION: 2016 JAN 05

UPGRADE CLASSIFICATION:

ENVELOPE

ROOF

WALLS

PRE-FAB TRIM PIECES 🗥

BY SIGN SUPPLIER

COMPLIANCE

R-20

R-21

LEGEND NOTE: REFER TO MATERIAL/FINISH/RESPONSIBILITY SCHEDULE ON SHEET A6.1 FOR SPECIFICATIONS OF ALL EXTERIOR MATERIALS AND FINISHES.

T-I, EXTERIOR TILE

M-2, CORRUGATED

METAL PANEL

PROJECT YEAR: 2016

FURNITURE PACKAGE: 2015

Wallin - Gomez

Architects, Ltd.
711 South Dearborn Street
Suite 606
Chicago, IL 60605

DESIGN BULLETINS:

Tel: 312-427-4702 Fax: 312-427-6611 e-mail: admin@wgaltd.com

STORE #07588

REV. DATE DESCRIPTION

01-08-16 ISSUED FOR PERMIT & BID


101-19-16 OWNER REVISIONS

PLOT DATE 1/19/2016
PROJECT NUMBER 15130
DRAWN BY CL/KH
CHECKED BY DJW


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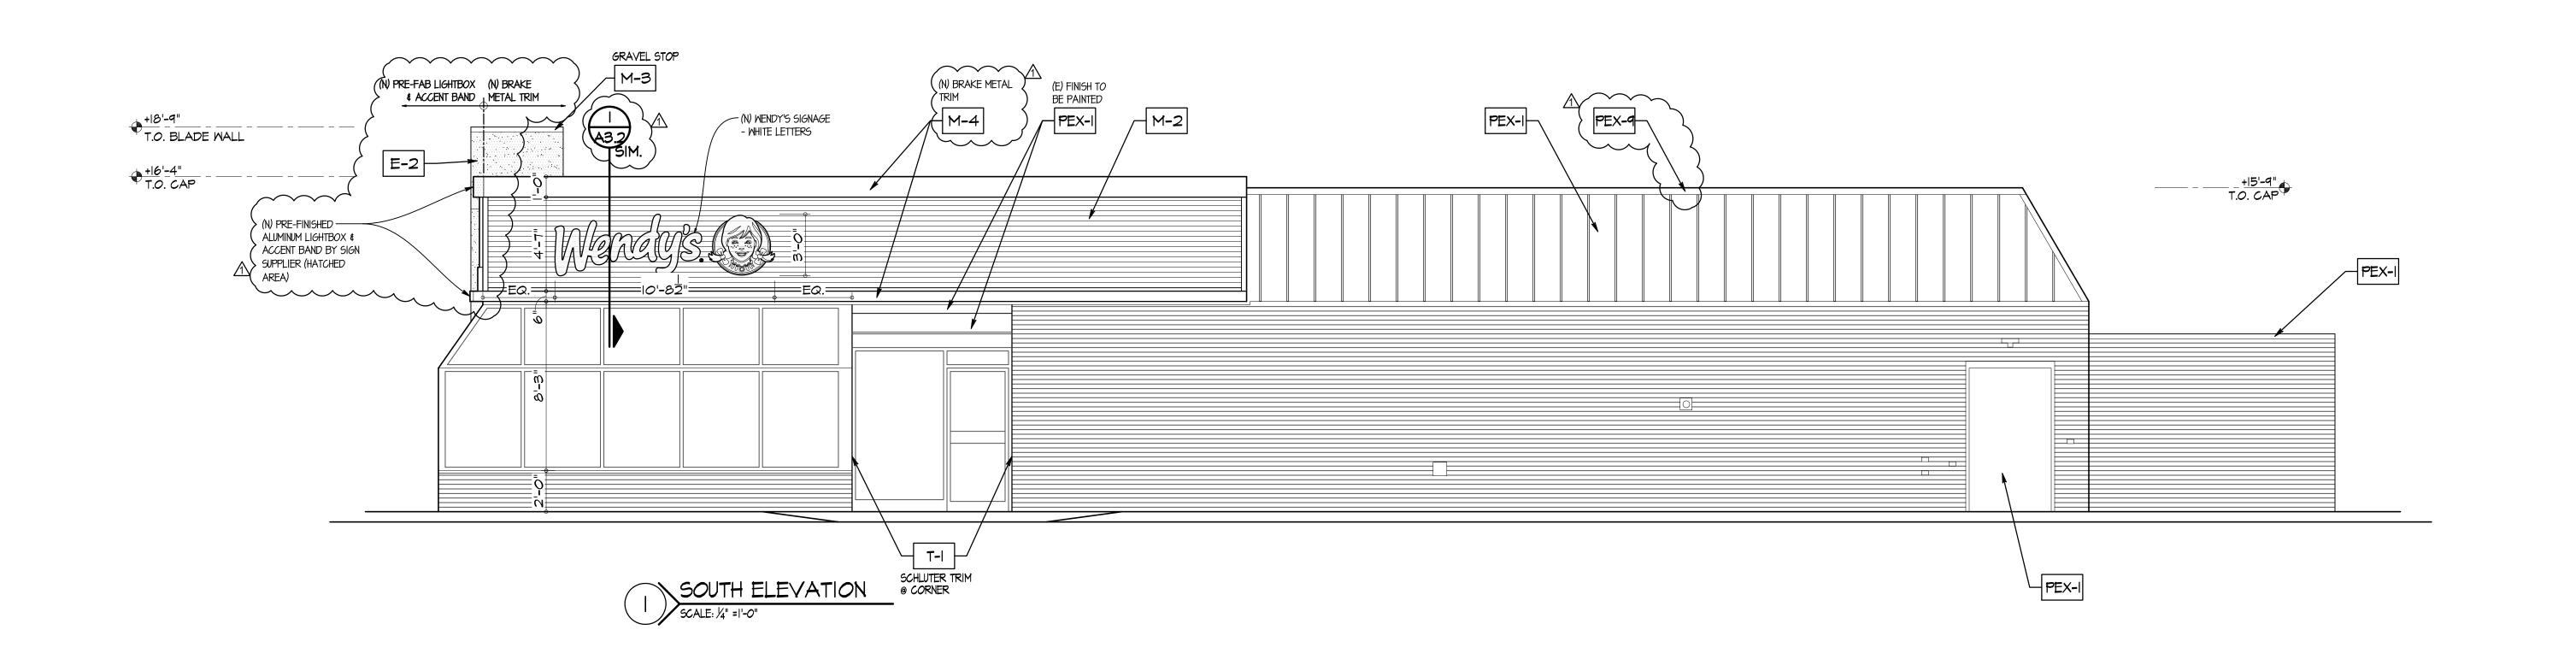
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EXTERIOR ELEVATIONS



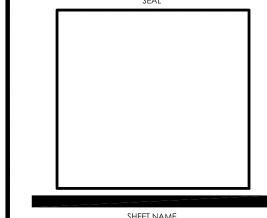

SITE NUMBER: 07588 BASE MODEL: CONVERSION ASSET TYPE: FRANCHISE CLASSIFICATION: REFRESH OWNER: JARO FOODS BASE VERSION: 2016 JAN 05 UPGRADE CLASSIFICATION: STANDARD PROJECT YEAR: 2016 FURNITURE PACKAGE: 2015 DESIGN BULLETINS:

WHERE EVER POSSIBLE ALL NEW MASONRY WORK SHALL BE CONSTRUCTED W SALVAGED

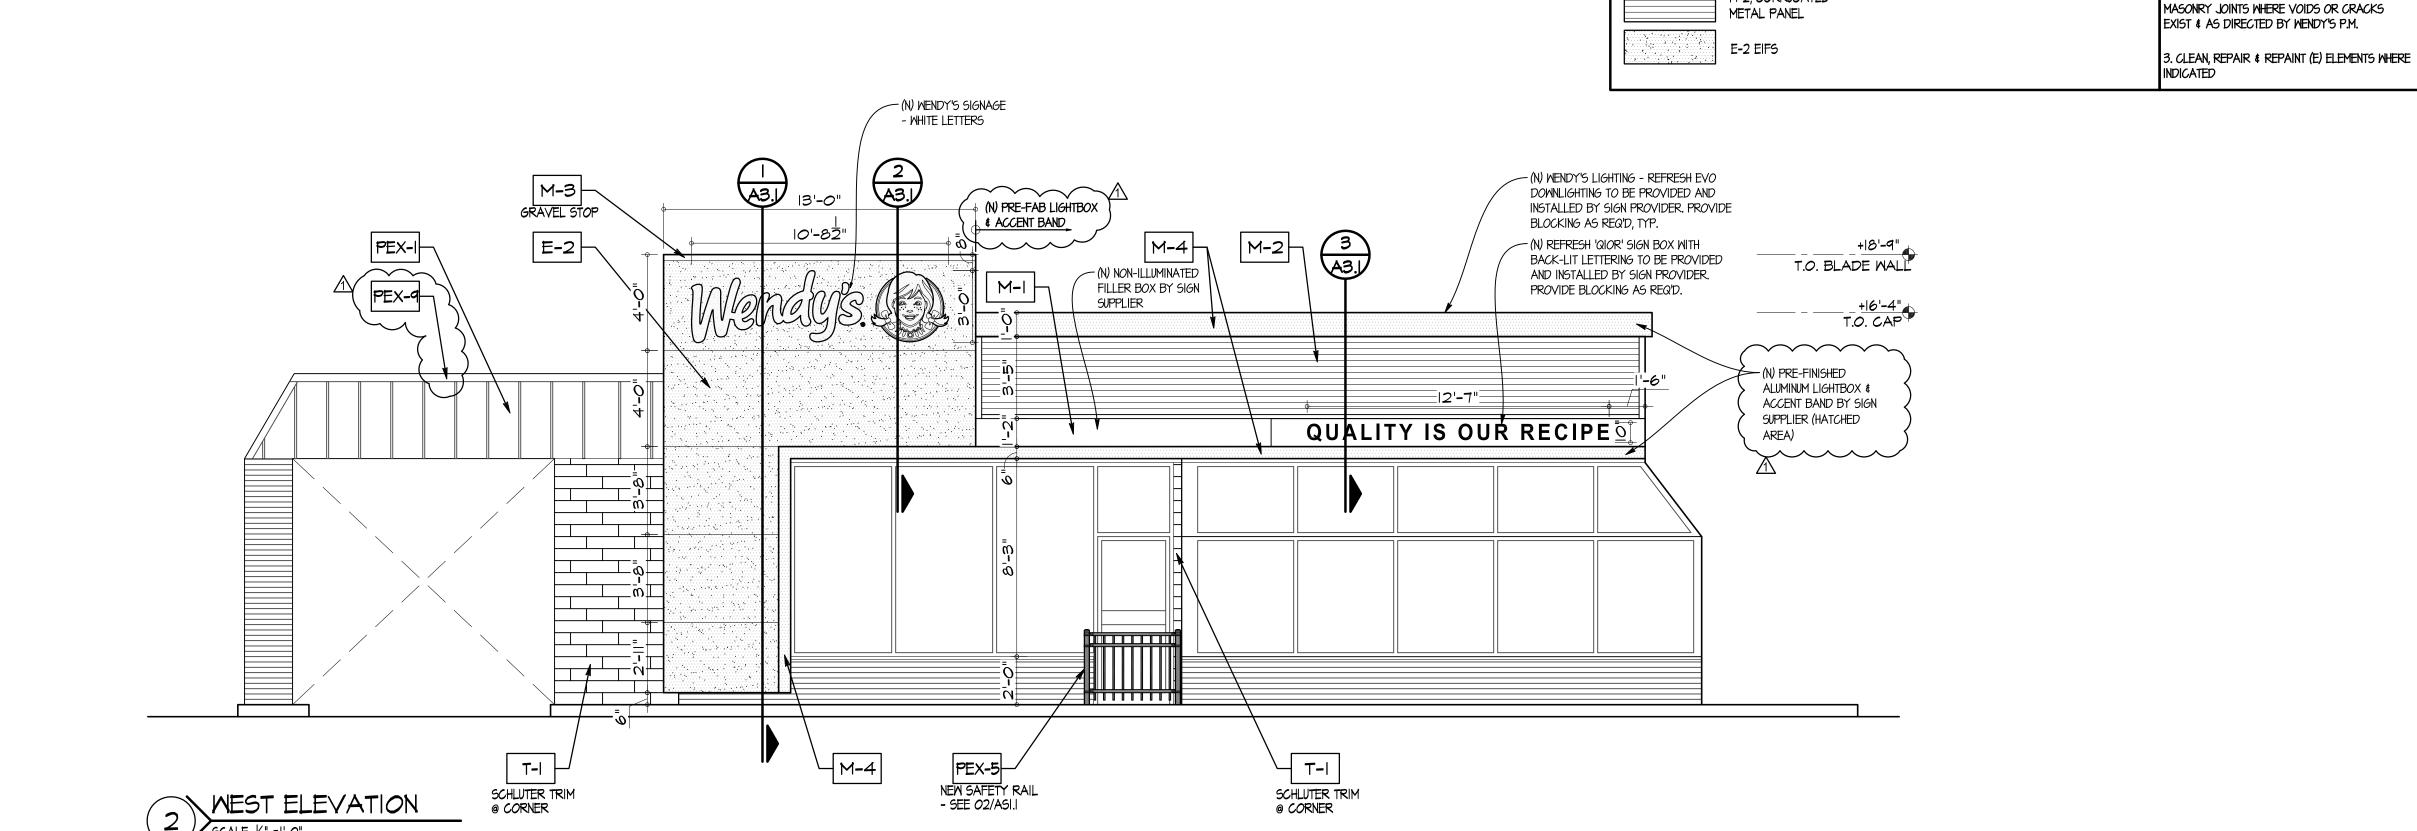REPOINT EXISTING VERTICAL AND HORIZONTAL

MASONRY TO MATCH EXISTING MASONRY.

LEGEND NOTE: REFER TO MATERIAL/FINISH/RESPONSIBILITY SCHEDULE ON SHEET A6.I

T-I, EXTERIOR TILE

M-2, CORRUGATED

FOR SPECIFICATIONS OF ALL EXTERIOR MATERIALS AND FINISHES.

PRE-FAB TRIM PIECES
BY SIGN SUPPLIER

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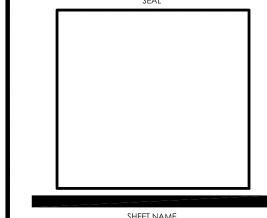
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	01-08-16	ISSUED FOR PERMIT & BID
$\overline{\mathbb{A}}$	01-19-16	OWNER REVISIONS

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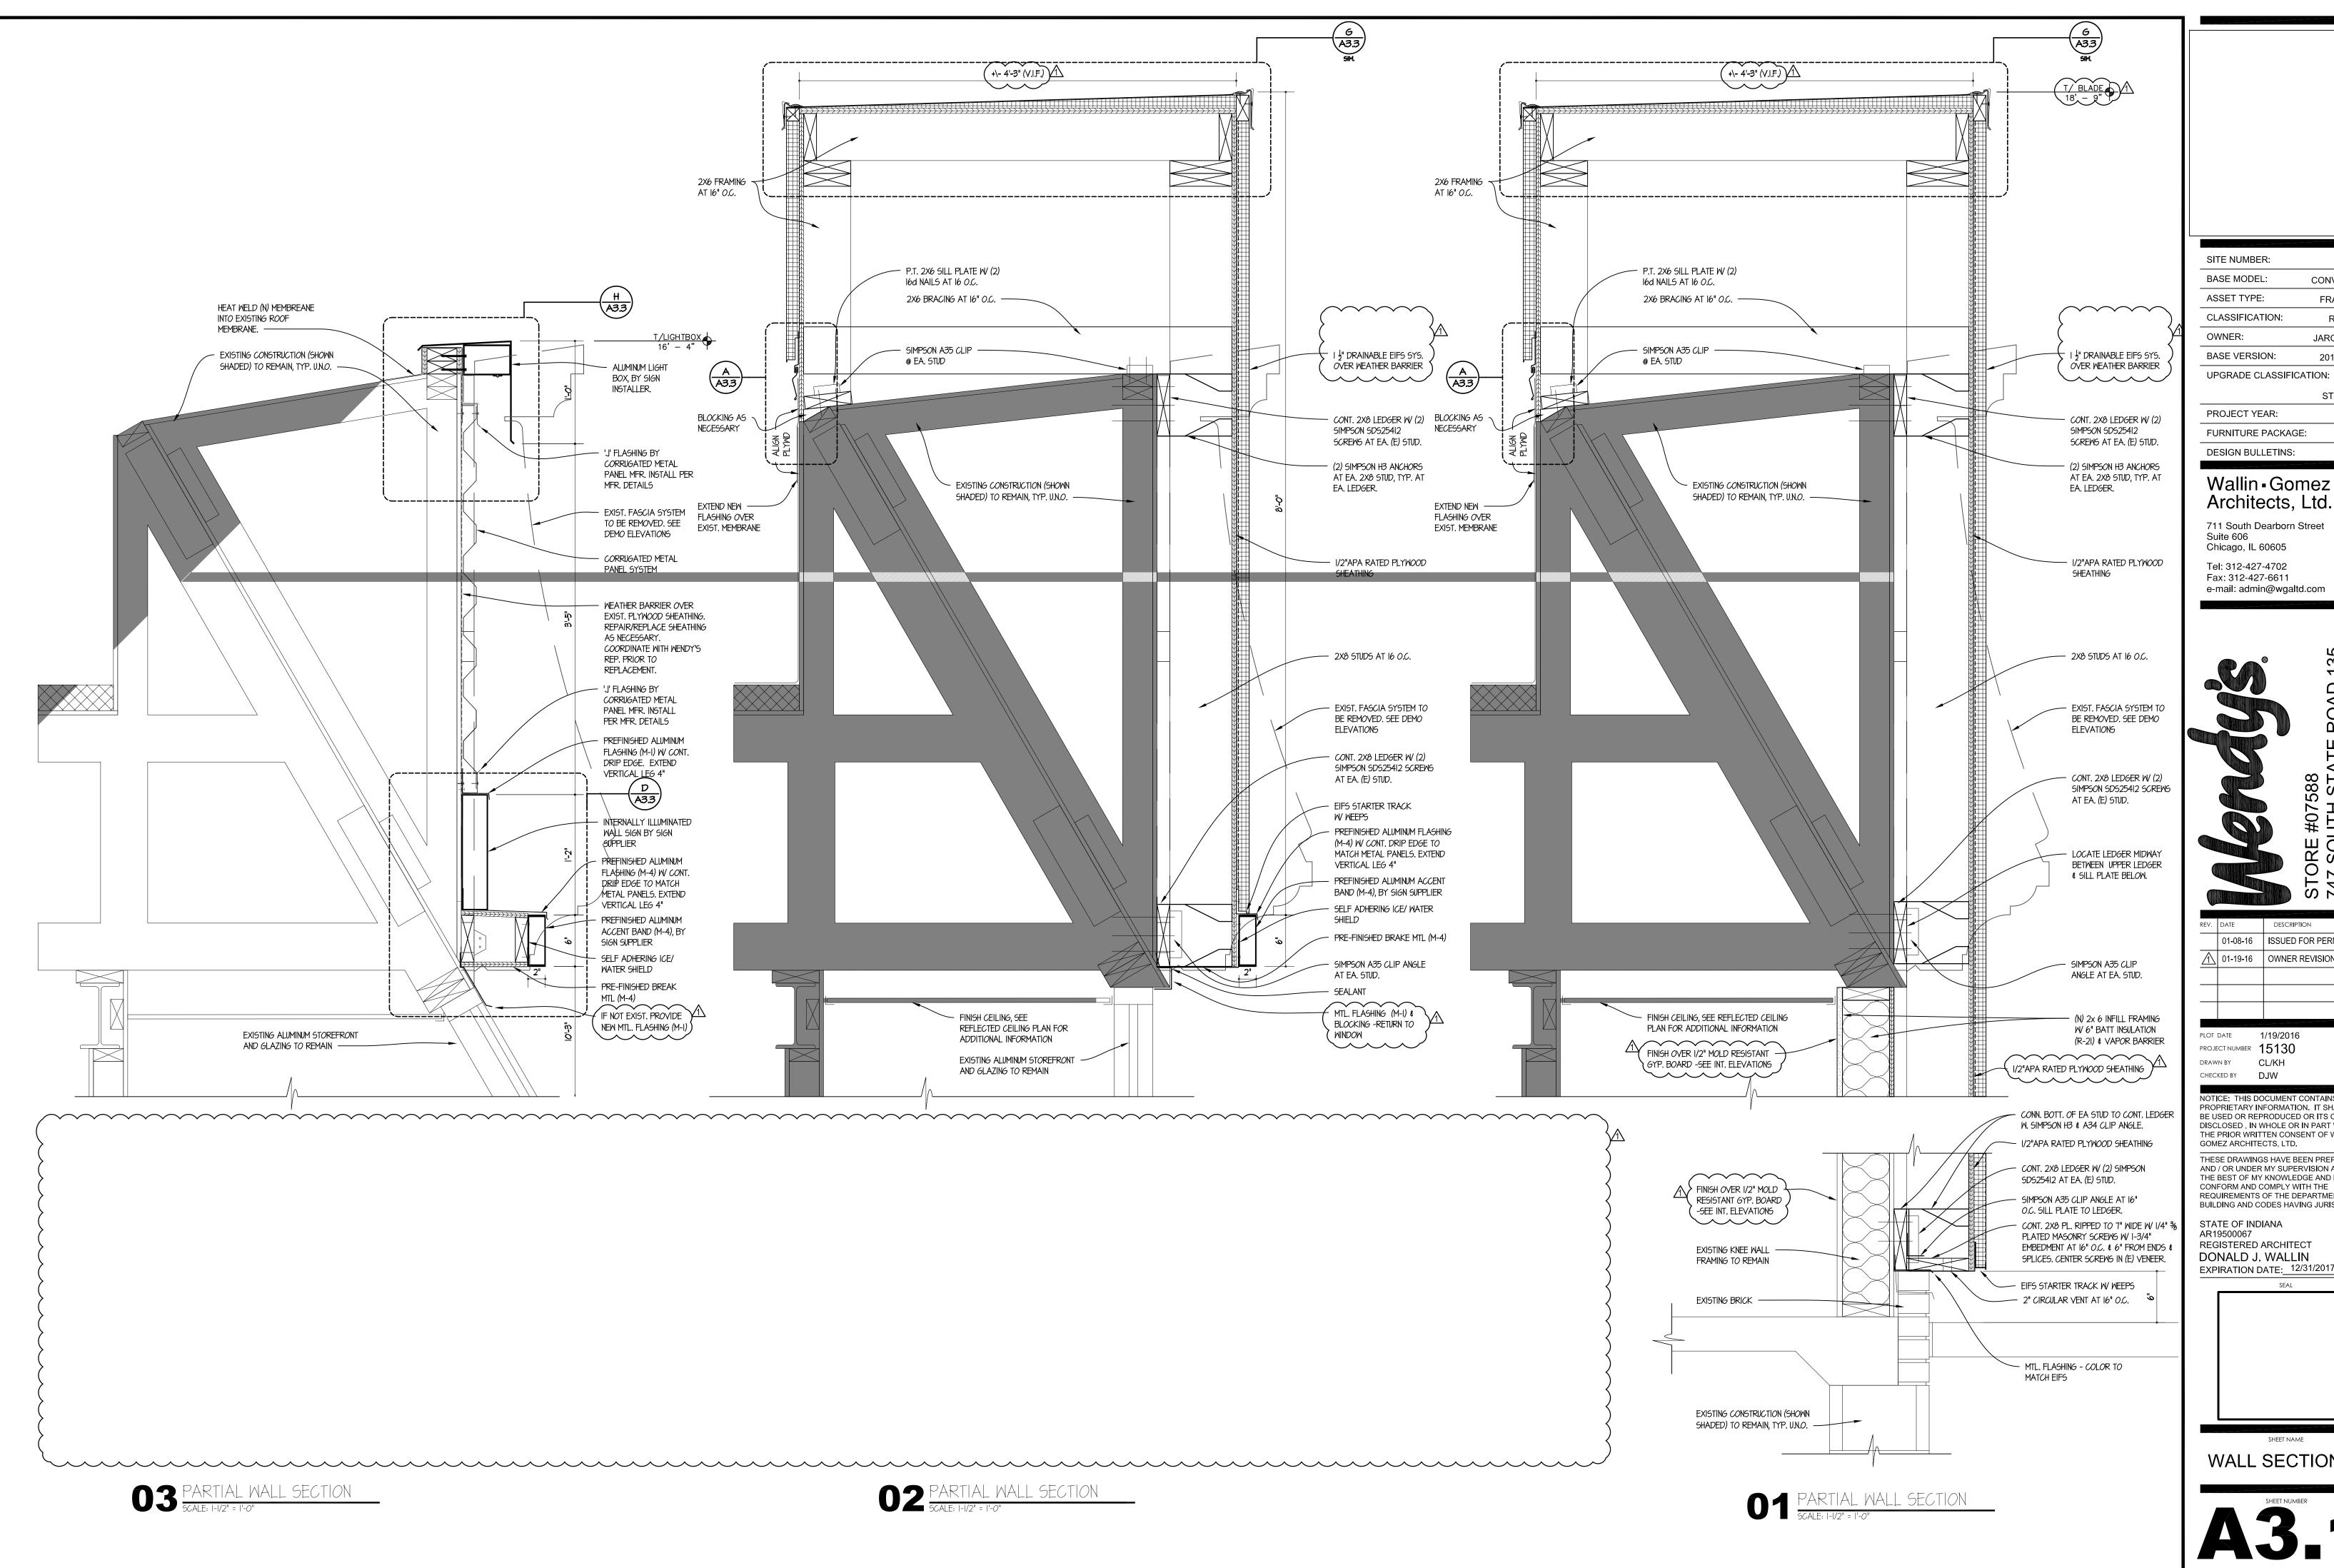
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EXTERIOR ELEVATIONS



SITE NUMBER: 07588 BASE MODEL: CONVERSION ASSET TYPE: FRANCHISE CLASSIFICATION: REFRESH JARO FOODS BASE VERSION: 2016 JAN 05

STANDARD PROJECT YEAR: 2016 FURNITURE PACKAGE: 2015

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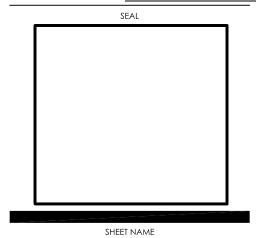
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PLOT DATE 1/19/2016 PROJECT NUMBER 15130 DRAWN BY CL/KH CHECKED BY DJW


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WALL SECTIONS




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CLASSIFICATION:	REFRESH
OWNER:	JARO FOODS
BASE VERSION:	2016 JAN 05

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ROJECT YEAR:	2016
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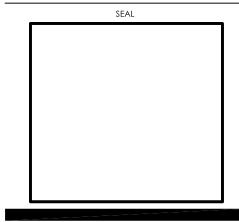
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WALL DETAILS


 $\mathbf{04}^{\frac{1}{3}}$

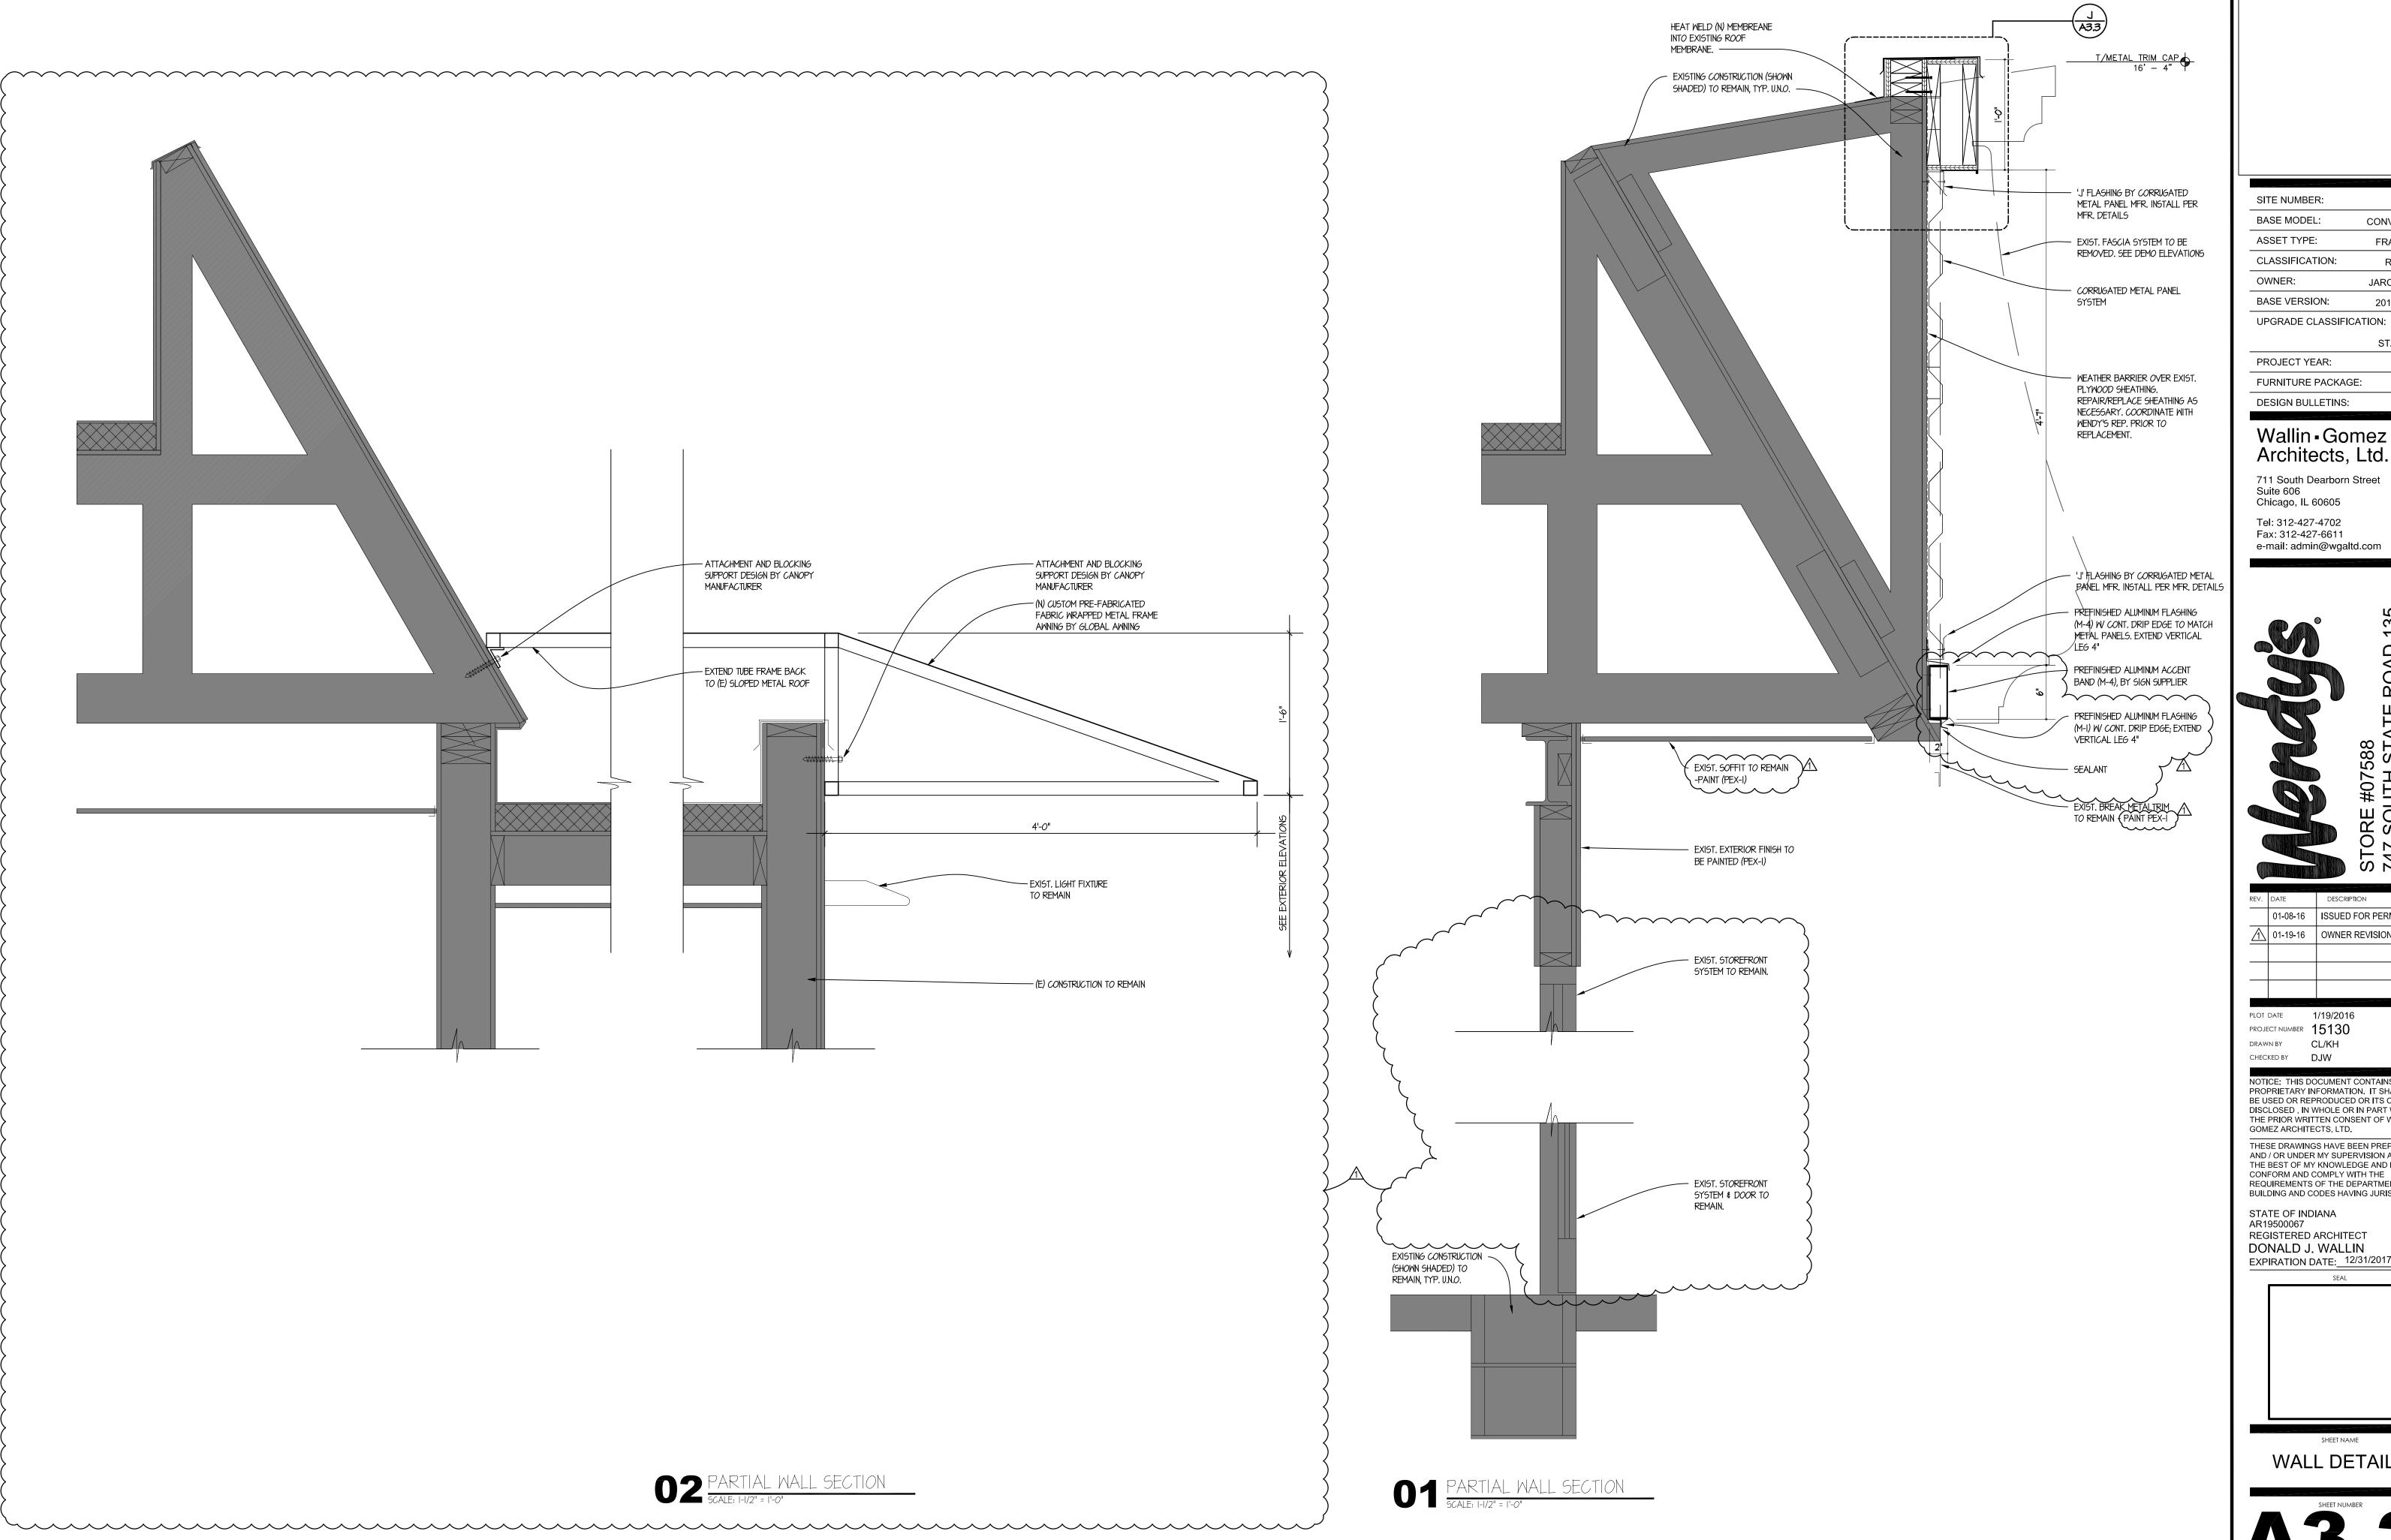04 NOT USED

SCALE: 1/4" = 1'-0"

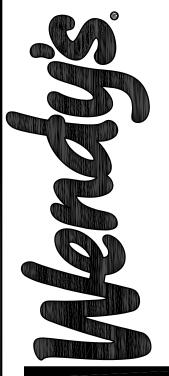03 NOT USED

SCALE: 3" = 1'-0"

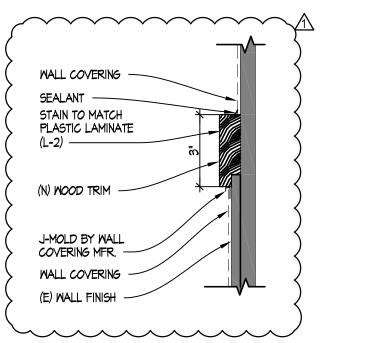

02 CHAIR RAIL TRIM DETAIL

SCALE: 3" = 1'-0"

THIS DETAIL IS BASED ON LATICRETE DETAIL FII3-I2 MR-I / GR-I

PERMACOLOR GROUT

TILE

4-XLT - THIN SET

HYDRO BAN - WATERPROOFING /
CRACK ISOLATION MEMBRANE AT WET
AREAS AND CRACKS/CONTROL JOINTS

CONCRETE

08 DINING AREA TILE GROUT DETAIL
SCALE:1 1/2"= 1'-0"

09 NOT USED SCALE:1 1/2"= 1'-0"

08 NOT USED

SCALE:1 1/2"= 1'-0"

05 NOT USED
| SCALE:" = 6"= 1'-0"

07 NOT USED SCALE:" = 6"= 1'-0"

06 NOT USED

SCALE: 1"= 1'-0"

O1 NOT USED

SCALE:" = N.T.S.

SITE NUMBER: 07588 BASE MODEL: CONVERSION ASSET TYPE: FRANCHISE CLASSIFICATION: REFRESH OWNER: JARO FOODS BASE VERSION: 2016 JAN 05 UPGRADE CLASSIFICATION: STANDARD PROJECT YEAR: 2016 FURNITURE PACKAGE: 2015 DESIGN BULLETINS:

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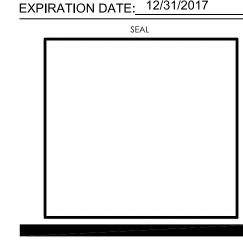
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STATE OF INDIANA AR19500067 REGISTERED ARCHITECT DONALD J. WALLIN EXPIRATION DATE: 12/31/2017



FINISH DETAILS

NTERIOR MATERIALS AND FINISHES				NTERIOR	MATERIALS AND FINISHES			PAINT SCHE	DULE				
ALL MATERIAL DESCRIPTION	BY:	SHED INSTALLE BY: GC KED O GC			DESCRIPTION	BY:	HED INSTALLE BY: KES O GC	KES COLOR BASE	SHEEN	SHERWIN WILLIAMS	EXTERIOR BENJAMIN MOORE	PPG	
FLOORING		$\overline{}$		SEATING TABLE CHAIR	GRAND RAPIDS E946 "TAN ECHO"; LEGS: "SPARKLE SILVER"			PEX-1: WENDY'S DARK BRONZE		BRONZETONE CUSTOM COLORS: "MISSISSIPF	PPI BRONZE" P23-60 "BRONZETONE"	530-7 "PHANTOM MIST"	
			-	TALL TABLE CHAIR FREESTANDING TABLE BASES	GRAND RAPIDS E946BS "TAN ECHO"; LEGS: "SPARKLE SILVER"		•	•					
FLOOR TILE (DINING TRANSCERAMICA; 6"x24" PLANKED, TRANSCERAMICA WOODS; COLOR: "RAW COPPLETED TO THE CONTROL OF				TABLE TOPS	FREE STANDING 20"x24", 24"x42" (ADA): FORMICA "CRÈME QUARSTONE" (6218-58 MATTE FINISH) w/ REHAU ANTIQUE BRUSH EDGE; 24"x42" BOOTHS, 36" ROUND, 42" ROUND FAMILY: FORMICA "PLANKED PEAR" (ARTISAN FINISH #43) w/ REHAU MULTIPLEX EDGE (592E); CROPPED CIRCLE HIGH-TOP 26"Dx24": NEVAMAR "CREST MAHOGONY" w/ REHAU EDGE TO MATCH (CP30079 1MM)		•	METAL	SATIN	RECOMMENDED: SEE PPG PRODUCT INFO ALTERNATE PRIME: PROCRYL UNIVERSAL ME	RECOMMENDED: SEE PPG PRODUCT INFO BETAL PRIMER ALTERNATE PRIME: SELF PRIME WITH P23-60	COLOR: CORAFLON "STATUARY BROWN" (ADS8022030) RECOMMENDED PRIME: CORAFLONTM ADS EPOXY PRIMER, ADS	S
ROOM, RESTROOMS, VESTIBULE) MATTE; 33% OFFSET; 1/8" JOINTS GROUT: MAPEI #47 "CHARCOAL"OR LATICRETE #45 "RAVEN" TILE BASE (DINING ROOM, RESTROOMS, VESTIBULE, ORDER TRIM (AT CURTAIN WALL CURBS ONLY): SCHLUTER "QUADEC" w/ CORNER	ABLE:		-	LOUNGE CHAIR BOOTH AND BENCH SEATING BOOTH DIVIDER	GRAND RAPIDS: E10019L; UPHOLSTERY: UP-2 (SEE BELOW) UPHOLSTERED BOOTH SEAT AND BACK: UP-1, UP-2 (SEE BELOW) FRAME FINISHED IN WILSONART "AMBER CHERRY" (#7919-38-107); CORIAN "CANYON" CAP GRASS DIGITAL GRAPHICS PRINTED ON 3/8" THICK PLEX PANELS		•	•		ALTERNATE FINISH: SHER-CRYL HPA (SMIE-GI	GLOSS OR GLOSS) ALTERNATE FINISH: P23-60 DTM ALKYD LOW LUST	RECOMMENDED FINISH: CORAFLON ADS ALTERNATE FINISH: PITTHANE ULTRA (COORD. PRIME WITH MFR.)	SITE NUMBE BASE MODE
SERVING AREA) INSERTS (ABGB: BRUSHED ANTIQUE BRONZE ANOD. ALUM.)			UP-1 UP-2	PANELS UPHOLSTERY (BOOTH BACK) UPHOLSTERY (BOOTH	MORBERN; STYLE: "FLAIR"; COLOR: "MINERAL" (FA-307) NASSIMI; STYLE: "SYMPHONY CLASSIC"; COLOR: "BRITISH TAN" (SCL-008)			PLASTIC (HERITAGE II) PEX-2: WENDY'S EXTERIOR RED	SATIN	PRIME: MULTI PURPOSE LATEX PRIMER FINISH: SHER-CRYL HPA (SEMI-GLOSS) SW 6321 "RED BAY"	PRIME: 023 FRESH START ALL PURPOSE PRIMER FINISH: P23-60 DTM ACRYLIC LOW LUSTER ENAME PM-18 "HERITAGE RED"		ASSET TYPE CLASSIFICA
CEILING				SEAT, LOUNGE CHAIR					SATIN	PRIME: LOXON MASONRY PRIMER FINISH: A-100 EXTERIOR LATEX SATIN	PRIME: 521 AURA RED WATERBORNE COLOR FOU FINISH: AURA WATERBORNE EXTERIOR SATIN FIN	NDATION PRIME: PPG SEAL GRIP 17-921 ACRYLIC UNIVERSIAL PRIMER	OWNER: BASE VERS
				MISCELLAN	EOUS 			METAL	SATIN	PRIME: PROCRYL UNIVERSAL METAL PRIMER		PRIME: PPG PITT-TECH 90-721 ACRYLIC METAL PRIMER	UPGRADE (
CEILING TILE (DINING ROOM) CERTAINTEED; SYTLE: "SYMPHONY M"; 24"x24"x3/4" (1222BB-IOF-1); COLOR: "WHITE"; REVEAL EDGE GRID: 15/16"; COLOR: STANDARD WHITE	•	•	L-2	FRONT COUNTER	TOP: CORIAN "CANYON" BODY: WILSONART "AMBER CHERRY" (#7919-38-107)		•	PEX-3 DARK BRONZE METAL PYLON SIGN	T	NO SUBSTITUTE (AVAILABLE THRU SIGN VENESW 7022 "ALPACA"			PROJECT Y FURNITURE
CEILING TILE (CONDIMENT AREA & SERVING AREA) CERTAINTEED; STYLE: VINYLROCK GYPSUM (1142-CRF-1); COLOR: WHITE, 24"x24"x1 EDGE GRID: 15/16"; COLOR: STANDARD WHITE	2"; TRIM												Wallin Archite
SEE PAINT SCHEDULE: EQUALS THRU SHERWIN-WILLIAMS, BENJAMIN MOORE, PPG CERAMIC COLOR: "CEILING WHITE"	& MDC	• •						PEX-5 BLACK		BLACK	BLACK	BLACK	711 South I ——— Suite 606 Chicago, IL
COLOR: "CEILING WHITE" FINISH: EGGSHELL (DINING & RESTROOMS), SEMI-GLOSS (KITCHEN) WALLS				TOILET PARTITIONS & DOORS	SATIN FINISH STAINLESS STEEL	•	•		SATIN	PRIME: PROCRYL UNIVERSAL METAL PRIMER FINISH: SHER-CRYL HPA GLOSS		PRIME: PPG PITT-TECH 90-721 ACRYLIC METAL PRIMER FINISH: PPG PITT-TECH PLUS 90-1306 DTM GLOSS	Tel: 312-42 Fax: 312-42
VVALLO	•	•	L-2	DOORS (RESTROOMS, CLOSET, SERVING AREA)	WILSONART "AMBER CHERRY" (#7919-38-107); BOTH FACES (OUTSIDE/INSIDE) DOOR FRAMES: "BRUSHED ALUMINUM"	•	•						Fax: 312-4 e-mail: adn
WALL COVERING KOROSEAL (RJF31346)OR MDC LEN-TEX; STYLE: "CORONADO LX"; COLOR: "OYST (#3603CR/4734); 54" WIDE CORNERS: 'CP-2' (SEE BELOW)	•	• •		"ARTPACK" AND "WAYFINDING"	WALL DÉCOR & INTERIOR SIGNAGE	•	•						
				XTERIOF	R MATERIALS AND FINISHES								
RED ACCENT WALL (DINING ROOM) KOROSEAL; STYLE "DESERT SAND"; COLOR: "ROASTED PEPPER" CORNERS: 'CP-3' (SEE BELOW)	•	•				FURNISH BY:	HED INSTALLE BY:	ED					
RED WALL COVERING	SION		CALL	MATERIAL TRIM 8	DESCRIPTION 0.040 ALUMINUM, FORMED-TO-SHAPE, CUSTOM BRONZE POWDER COATED FINISH TO MATCH	O GC	KES O GC	KES	<u> </u>				
(GRAPHIC) COSTOM PRINTED WENDY'S GRAPHIC WALLCOVERING MURAL (FROM GTC); 72" VER CORNERS: 'CP-3' (SEE BELOW)			IVI-1	METAL TRIM & BRAKE METAL	"DARK BRONZE" STOREFRONT SYSTEM, CONTACT AMERICAN PRODUCTS, INC. (API), (813) 925-0144, BIDS@AMERICANPROD.COM; ATTN: KERRI BEALS			PEX-9 WENDY'S ACCENT SILVER (HORI	IZ. ÁCCÉNT BANDS	S) PER MANUFACTURER'S RECOMMENDATION	PER MANUFACTURER'S RECOMMENDATION	PER MANUFACTURER'S RECOMMENDATION	
			M-2	CORRUGATED METAL PANEL	REYNOLUX 7.2" RIB PANEL, 20 GA, FACTORY FINISH COLOR: "CLASSIC BRONZE", AS MFG BY ALCOA CLADDING SYSTEMS. 20 GA. GALVANIZED STEEL.	•		METAL	TBD	AND PAINT PER MANUFACTURER'S RECOMME	"BRUSHED ALUMINUM" (METALLIC FLECK FINISH REQUIRED; PREP, PRIME MENDATIONS USING APPROVED PRIMER FOR EXISTING SUBSTRATES.	<u> </u>	
WALL COVERING (WAINSCOT) KOROSEAL: TRAFFIC PATTERNS (0.060"), COLOR: KOROSEAL, SAILCLOTH "BUOY" (8 OUTSIDE CORNER TRIM: CP-5 / CP-6 (SEE BELOW) CAULK: C100 COLOR-MATCHED				METAL COPING ON BLADE	0.040 ALUMINUM, FORMED-TO-SHAPE, CUSTOM RED POWDER COATED FINISH TO MATCH "WENDY'S RED" STOREFRONT SYSTEM.	•			<u> </u>	TOTAL	INTERIOR		
WALL TILE CRÓSSVÍLLE; COLOR BY NŮMBÉRS; ŤEA FOR TWO (#WŤ02.10412G); 4"x8"; ČOLŎR: Ġ WHITE; PATTERN: RUNNING BOND CUSTOMERS LINE OF GROUT: MAPEI #38 "AVALANCHE"OR LATICRETE #44 "BRIGHT WHITE"	•				CONTACT: AMERICAN PRODUCTS, INC. (API), (813) 925-0144, BIDS@AMERICANPROD.COM; ATTN: KERRI BEALS			P-1: WENDY'S BEIGE G.W.B.	EGGSHELL	SW 7036 "ACCESSIBLE BEIGE" PRIME: PROMAR 200 ZERO VOC PRIMER	OC-15 "BABY FAWN" PRIME: 046 SUPERIOR PRIMER OR SELF PRIME WI		
CORNER TRIM: SCHLUTER "SCHEINE" (AE: SATIN ANOD. ALUM.) TRANSCERAMICA; 12"x24"; COLOR: "EXTRA IVORY"; PATTERN: STACKED BOND GROUT: MAPEI #06 "HARVEST"OR LATICRETE #39 "MUSHROOM" HORIZONTAL TRIM: SCHLUTER "SCHEINE" (AE: SATIN ANOD. ALUM.) OUTSIDE CORNER TRIM: SCHLUTER "QUADEC" w/ CORNER INSERTS (AE: SATIN ANOD.	•		M-4	METAL TRIM & BRAKE METAL	0.040 ALUMINUM, FORMED-TO-SHAPE, CUSTOM POWDER COATED "GG BRUSHED ALUMINUM"	•	•			FINISH: PROMAR 200 ZERO VOC EGG-SHELL	FINISH: 524 AURA WATERBORNE INTERIOR EGGSI	HELL FINISH FINISH: PPG SPEEDHIDE 6-411 INTERIOR EGGSHELL ENAMEL	REV. DATE
WALL TILE REALSTONE; SHADOWSTONE; 6"x24" PANELS; COLOR: "SIERRA"; (DINING RM G"x24" CORNER PANELS, (SPLIT 8"X6" AND 16"X6" WITH INTERLOCKING CORNER), 6"	(24" END	•	PEX-1	REAR DOOR, DOWNSPOUTS, COLLECTOR BOXES,	"WENDY'S DARK BRONZE" (SEE PAINT SCHEDULE)	•		P-3: CEILING WHITE RESTROOM G.W.B.	FLAT	SW 7006 "EXTRA WHITE" PRIME: PROMAR 200 ZERO VOC PRIMER	PM-1195 "SUPER WHITE" PRIME: 046 SUPERIOR PRIMER OR SELF PRIME WI	518-1 "DELICATE WHITE" ITH 524 PRIME: PPG SPEEDHIDE 6-2 INTERIOR QD ACRYLIC PRIMER	01-08-16
PANELS, PATTERN: OFFSET RUNNING BOND PAINT ALTERNATE (FOR HUMID CLIMATES) PANELS, PATTERN: OFFSET RUNNING BOND SEE PAINT SCHEDULE: EQUALS THRU SHERWIN-WILLIAMS, BENJAMIN MOORE, PPG CERAMIC COLOR: "WENDY'S BEIGE"	& MDC		<u> </u>	TRASH ENCLOSURE, FENCE, GATES, EXTERIOR SIGNAGE / POLES	"WENDY'S DARK BRONZE" (SEE PAINT SCHEDULE)	•		VESTIBULE G.W.B.	FLAT	PRIME: PROMAR 200 ZERO VOC PRIMER FINISH: PROMAR 200 ZERO VOC FLAT	FINISH: 522 AURA WATERBORNE INTERIOR MATTE		+
FINISH: EGGSHELL					NEW: POWDER COAT BLACK								PLOT DATE
		+++	PEX-9	I COMMOL	REMODEL: PAINT BLACK (SEE PAINT SCHEDULE) REMODEL: PAINT SILVER (SEE PAINT SCHEDULE)		1 1 - 1	<u> </u>					PROJECT NUMBER DRAWN BY CHECKED BY
			1 (L L \ -3	, CONNICE	CROSSVILLE, SWW-2: CUSTOM COLOR: "WENDY'S WOODGRAIN", 6"X26".	444	1 1 - 1	<u></u>					NOTICE: THIS PROPRIETARY
CODNED PROTECTION KODOCARD COTE CORNED CHARDS OVER ON OR BURNOS			T-1	EXTERIOR TILE	PATTERN: 1/3 RUNNING BOND GROUT: MAPEI #42 MOCHA, WITH 1/8" GROUT JOINT RECOMMENDED. PROVIDE SCHLUTER "RONDEC" TRIM AT VERTICAL OUTSIDE CORNERS AND EDGES;				<u> </u>				BE USED OR R DISCLOSED , IN THE PRIOR WR
CORNER PROTECTION KOROGARD G875 CORNER GUARD; 3/4"x3/4"; COLOR: PUMICE (FOR WC-1) CORNER PROTECTION KOROGARD G875 CORNER GUARD; 3/4"x3/4"; CUSTOM COLOR: MATCH 'WC-3'		<u>, </u>	BL-1	BOLLARD SLEEVE	COLOR: SATIN COPPER/BRONZE ANODIZED ALUMINUM. NEW: PAWLING, PRO-TEK BOLLARD SLEEVE (RED); 6" DIA, 48" HEIGHT REMODEL: SAME AS ABOVE, VERIFY EXISTING DIAMETER & HEIGHT	•		TILE INSTAL	LATIO	N SCHEDULE	NIT (1.2) IOINIT MEMPERALE (2) SERVES:	/C	GOMEZ ARCHI THESE DRAWII AND / OR UNDI
(FOR WC-3 & WC-4)		+++	+					LOCATION T EXTERIOR WALLS T-1	6"x24	MR-3, MR-4 GR-1	OUT (1,2) JOINT MEMBRANE (2) REMARI- 1/8" WM-2 MORTAR: MR-3 MEMBRANE: E	FREEZE-THAW REGIONS, MR-4 MODERATE REGIONS. NTIRE WALL	THE BEST OF CONFORM ANI REQUIREMEN
CORNER PROTECTION KOROGARD G875 90 DEGREE CORNER GUARD; 3/4"x3/4"; COLOR: FLAGSTONE (FOR WC-6)	•	•						INTERIOR FLOORS DINING ROOMS FT-	İ		1/8"		BUILDING AND STATE OF IN
CORNER PROTECTION KOROGARD G815 135 DEGREE CORNER GUARD; 1-1/2"x1-1/2"; COLOR: FLAGSTONE (FOR WC-6) CORNER PROTECTION KOROGARD G815 135 DEGREE CORNER GUARD; 1-1/2"x1-1/2"; COLOR: MATCH WT-1			$\vdash \vdash$			++		RESTROOMS FT-	-2 6"x24	MR-1 GR-2	1/8" WM-1 EXTEND MEMB	RANE 24" OUT AND 12" UP PERIMETER WALLS	AR19500067 REGISTEREI DONALD
(FOR WT-1)		<u>' </u>						INTERIOR WALLS	<u> </u>				EXPIRATION
							$ \ \ \ $	DINING ROOMS					\dashv \sqcap
								RESTROOMS WT			1/8"		
								B-2			1/8" WM-1 EXTEND MEME	BRANE 24" OUT AND 12" UP PERIMETER WALLS	$\exists \mid \mid$
			∫E-2	EXTERIOR INSULATED FINISH SYSTEM (E.I.F.S.)	OPTION #1: STO, STOTHERM ESSENCE NEXT SYSTEM, TEXTURE: STO FINE SAND FINISH TOP-COATED WITH 2 COATS OF STO COAT ACRYL PLUS: HIGH-IMPACT "AMOUR MAT" REINFORCING MESH TO 6'-9" ABOVE GRADE; COLOR: "WENDY'S RED" (STO FINE SAND NA13-0042, STOCOAT ACRYL PLUS NA13-0042)	•		MORTAR AND GROUT	PRODUCT	TS MORTAR (2) GRO		PTION MODIFIED-PORTLAND CEMENT THIN SET MORTAR	
					OPTION#2: DRYVIT "OUTSULATION PLUS MD EIFS SYSTEM"; TEXTURE: "SANDPEBBLE FINE			\					FIN
					(SPF)"; PAINT COATING "DEMANDIT" (MIN 2 COATS); HIGH IMPACT "PANZER 20 MESH" REINFORCING TO 6'-9" ABOVE GRADE: COLOR: "WENDY'S RED". "WEND051085" DEMANDIT			\			I		_
					(SPF)"; PAINT COATING "DEMANDIT" (MIN 2 COATS); HIGH IMPACT "PANZER 20 MESH" REINFORCING TO 6'-9" ABOVE GRADE; COLOR: "WENDY'S RED", "WEND051085" DEMANDIT W/ "STRATOTONE" (S14J42278) HIGH PERFORMANCE COLORANT OVER OVER WENDO51022 SPF TEXTURE			\		GR-1		DIFIED HIGH PERFORMANCE CEMENT TILE GROUT	
			SEE AI KEY: C	PPROVED SUPPLIERS D = Owner, GC=General Col Kitchen Equipment Supplier/	REINFORCING TO 6'-9" ABOVE GRADE; COLOR: "WENDY'S RED", "WEND051085" DEMANDIT W/ "STRATOTONE" (S14J42278) HIGH PERFORMANCE COLORANT OVER OVER WENDO51022 SPF TEXTURE			>		GR-1 GR-2 GR-3	CHEMICAL RES	DIFIED HIGH PERFORMANCE CEMENT TILE GROUT BISTANT, WATER-CLEANABLE, INDUSTRIAL GRADE, TILE-GROUTING EPOXY IABLE, TILE-GROUTING EPOXY	

CONVERSION FRANCHISE REFRESH JARO FOODS 2016 JAN 05 LASSIFICATION:

STANDARD

2016

2015

DESCRIPTION ISSUED FOR PERMIT & BID OWNER REVISIONS

OCUMENT CONTAINS
NFORMATION. IT SHALL NOT
PRODUCED OR ITS CONTENTS
WHOLE OR IN PART WITHOUT
WHOLE CONSENT OF WALLIN /
FECTS, LTD.

NGS HAVE BEEN PREPARED AT ER MY SUPERVISION AND TO MY KNOWLEDGE AND BELIEF COMPLY WITH THE SOF THE DEPARTMENT OF CODES HAVING JURISDICTION.



APPROVED	SUPPLIER LIST								
PRODUCT	CONTACT INFORMATION ISION 3 - CONCRETE	PRODUCT	CONTACT INFORMATION 8 - DOORS AND WINDOWS	PRODUCT	9 - FINISHES (CONTINUED)	DIVISION 10) - SPECIALTIES (CONTINUED)		DIVISION 23 - HVAC
PRE-TINTED CONCRETE	CHEMMASTERS MADISON, OHIO 800-486-7866 ATTN: CLAUDIA BENTLEY 4 - MASONRY AND STONE	DOORS AND HARDWARE	***BASIS OF DESIGN*** LA FORCE, INC. COLUMBUS, OH 1-800-762-7301 ATTN: DAVE CARIDAS	TILE (FT-1, B-1, B-2, WT-1)	CROSSVILLE CERAMICS CROSSVILLE, TENNESSEE 931-456-3997 ATTN: TONI HALE	RESTROOM PARTITIONS AND ACCESSORIES	, , , , , , , , , , , , , , , , , , , ,	HVAC EQUIPMENT	***BASIS OF DESIGN*** PREFERRED EQUIPMENT (AAON) DAYTON, OH 877-435-4655, 937-432-6099 ATTN: MELISSA NEU
FACE BRICK	BOWERSTON SHALE COMPANY 740-269-2921 ATTN: CUSTOMER SERVICE HAMILTON PARKER (OHIO)		HAMILTON PARKER COLUMBUS, OHIO 614-358-7806 ATTN: JIM CAMPBELL	TILE (FT-2, WT-2)	TRANSCERAMICA TILE CROSSVILLE, TN 312-506-2856 ATTN: JAN WERNER	-	HAMLITON PARKER COLUMBUS, OHIO 614-358-7806 ATTN: JIM CAMPBELL		TRANE AIR CONDITIONING COLUMBUS, OH 866-986-4822 ATTN: MARTY CUSICK
WT-3 (ONLY) CONTACT HAMILTON PARKER	614-358-7800 ATTN: GABRIEAL CANTRELL DUTCH QUALITY STONE	STOREFRONT AND CURTAIN WALL	***BASIS OF DESIGN*** US ALUMINUM 213-309-3628 (CELL)	LUXURY VINYL TILE (WC-2)	DAVIS FLOORS 1-888-338-1029 ATTN: KERRY BISHOP		MARLITE PRODUCTS DOVER, OHIO		LENNOX INDUSTRIES INC. DALLAS, TX
MANUFACTURED STONE	MT. EATON, OHIO 330-401-2115 ATTN: WENDALL MAST OWENS CORNING MASONRY PRODUCTS		ATTN: BRAD THURMAN (DIRECTOR OF SALES & MARKETING) KAWNEER COMPANY, INC. FRANKLIN, INDIANA 317-771-9263	WALLCOVERINGS (WC-1, WC-3, WC-6, WC-7) CORNER GUARDS	KOROSEAL/KORGUARD CINCINNATI, OH 866-628-2280 ATTN: MICHEAL GROSS	WINDOW SHADES	800-377-1221; 330-343-6621 ATTN: CUSTOMER SERVICE/TJ RHINE INSIDE OUTFITTERS COLUMBUS, OHIO	EXHAUST HOODS	800-367-6285 ATTN: ERIK LAWSON AEROLATOR SYSTEMS INC. MONROE, NC
D	MEDINA, OHIO 866-315-5081 ATTN: KATHY MANNON (FOR NEAREST DISTRIBUTOR)		TUBELITE WALKER, MICHIGAN 616-808-2529	WALLCOVERINGS (WC-4) SOLID SURFACE SILLS (SS-2, SS-3)	(SEE "ART PACK ELEMENTS" BELOW) OHIO VALLEY SUPPLY CINCINNATI, OHIO 614-975-6700 ATTN: DAVE GREENING		800-742-3372; 614-798-3500 ATTN: STEVE JASZEK ROLL-A-SHADE LAKE ELSINORE, CA		866-841-0318 ATTN: STEVEN LUDDY ACTION AIR (VENTMASTER) ALPHARETTA, GA
DUMPSTER GATES AND HARDWARE	FORTIN WELDING COLUMBUS, OHIO 614-291-4342 ATTN: DAN FORTIN		ATTN: BRIAN MCGINNIS OLDCASTLE BUILDING ENVELOPE TERRELL, TEXAS 651-253-5062	CANOPY (PUW & ORDER)	SION 10 - SPECIALTIES ***BASIS OF DESIGN*** GLOBAL AWNING	SAFETY EQUIPMENT	951-245-5077 x113 ATTN: RIC BERG (VP OF BUSINESS DEVELOPMENT) FRONT LINE SALES	AIR CURTAINS (ABOVE PUW, AS REQUIRED	866-844-1896 ATTN: BRENT COX BERNER INTERNATIONAL CORP NEW CASTLE, PA
ROOF JOIST, MICRO-LAM	OD, PLASTICS AND COMPOSITES REDBUILT	GLAZING	ATTN: MARK LEHMAN ***BASIS OF DESIGN***		MONROE, LOISIANNA 318-699-0088 ATTN: FRED MURPHY	SAI ETT EQUITIVIENT	630-226-5309 ATTN: TIM HAYES	BY CODE)	724-658-3551 ATTN: KAREN RYDER
BEAMS	COLUMBUS, OHIO 877-371-0445 ATTN: HENRY GRUESEN NATIONAL BUILDING SYSTEMS SUGAR GROVE, OHIO	_	GUARDIAN GLASS INDIANAPOLIS, IN 765-404-0964 ATTN: DALE HAUSER (ARCH SALES MGR) PPG INDUSTRIES		UNI-STRUCTURES, INC. KENNESAW, GEORGIA 678-974-1753 ATTN: KRISTINE WATTS	DIVI KITCHEN EQUIPMENT (KED)	N. WASSERSTROM AND SONS COLUMBUS, OHIO 800-444-4697 x8869 ATTN: ADAM CALTRIDER		EASI-SERV VANCOVER, BC 604-422-8611 ATTN: FELIPE MONTIEL
MILLWORK	937-291-2950 ATTN: KEN DUVALL S & G DISTRIBUTING HILLIARD, OH	PICK-UP WINDOW (PUW)	INDIANAPOLIS, IN 630-962-4800 ATTN: JOSEPH SENNESE (ARCHITECTURAL MGR) ***BASIS OF DESIGN***		AWNING TEC USA INC. CORYDON, IN 812-734-0423 ATTN: ANDREW ENGLEMAN		S & G DISTRIBUTING HILLIARD, OH 888-529-1992 x3635		QUIKSERV HOUSTON, TX 800-388-8307 ATTN: Jackie Brady
	888-529-1992 x3635 ATTN: JOE URASKI, JR N. WASSERSTROM AND SONS COLUMBUS, OHIO	PICK-UP WINDOW (PUW)	QUIKSERV (STANDARD PUW & IMPACT RATED) HOUSTON, TX 800-388-8307; 713-462-1936 ATTN: STEVE BERT (NATIONAL SALES MGR)	EXTERIOR MENUBOARD EXTERIOR PRE-SALE BOARDS INTERIOR QUEING BOARDS (STATIC)	CUSTOM SIGN CENTER COLUMBUS, OHIO 800-522-2934 ATTN: MICHAEL ANDERSON		ATTN: JOE URASKI, JR AEI AYDELOTT EQUIPMENT INC. CENTERVILLE, OHIO 888-293-3568, 937-435-8220 ATTN: HERB AYDELOTT	DIVISION ELECTRICAL DISTRIBUTION PANELS	24 - ELECTRICAL SYSTEMS ***BASIS OF DESIGN*** WESCO (WR CONTROLS) COLUMBUS, OH 800-417-7543; 614-875-6522
	800-444-4697 x8869 ATTN: ADAM CALTRIDER AEI AYDELOTT EQUIPMENT INC. CENTERVILLE, OHIO	_	EASI-SERV (STANDARD PUW ONLY) VANCOVER, BC 604-422-8611 ATTN: FELIPE MONTIEL		NATIONAL SIGN SYSTEMS COLUMBUS, OHIO 800-544-6726 ATTN: CUSTOMER SERVICE	DIVIS DINING ROOM FURNITURE	SION 12 - FURNISHINGS (SEE "KITCHEN EQUIPMENT" ABOVE)		ATTN: WENDY'S PROJECT TEAM GEXPRO (GE SUPPLY) GAHANNA, OH 800-336-5718; 614-308-2753
DIVISION 7 - THER	888-293-3568; 937-435-8220 ATTN: HERB AYDELOTT RMAL AND MOISTURE PROTECTION	SUSPENDED ACOUSTICAL CEILING	VISION 9 - FINISHES CERTAINTEED (FORMERLY BPB CELOTEX)	INTERIOR MENUBOARD (STATIC)	***BASIS OF DESIGN*** C3 LIGHTING SYSTEMS LOS ANGELES, CA 800-733-6661 x108	PATIO FURNITURE	***BASIS OF DESIGN*** RECYCLE DESIGN ANDERSON, IN	LIGHTING	ATTN: ANN GILLMAN ***BASIS OF DESIGN*** CAPITAL LIGHTING
ROOFING PRODUCTS	***BASIS OF DESIGN*** DUROLAST ROOFING, INC. SAGINAW, MICHIGAN 800-248-0280 ATTN: JASON DARK	(CT-1, CT-2, CT-3, CT-4) FRP PANELING	800-346-7978 x2263 ATTN: CHRISTINA HOPEWELL MARLITE PRODUCTS DOVER, OHIO 800-377-1221; 330-343-6621		ATTN: MIKE MCINNIS NATIONAL SIGN SYSTEMS COLUMBUS, OHIO 800-544-6726 ATTN: CUSTOMER SERVICE		765-374-0316 ATTN: JOSH BOUTWELL WAUSAU TILE WAUSAU, WI 715-359-3121		COLUMBUS, OH 877-841-1200; 614-841-1200 ATTN: BOB BEATTIE LOUISVILLE LIGHTING
	SARNAFIL ROOFING SYSTEMS CANTON, MASSACHUSETTS 608-270-0053 ATTN: BEN BIEDRZYCKI		HAMILTON PARKER COLUMBUS, OHIO 614-358-7806 ATTN: JIM CAMPBELL	INTERIOR MENUBOARD (DIGITAL) INTERIOR QUEUING BOARDS (DIGITAL) TELEVISIONS	THE WENDY'S COMPANY; IT DEPARTMENT	DIVISION 1 WALK-IN COOLER / FREEZER / DRY STORAGE	ATTN: PETE JANDA 3 - SPECIAL CONSTRUCTION		LOUISVILLE, KY 800-678-1532 ATTN: ROBERT LARSON LSI INDUSTRIES (SITE LIGHTING ONLY) CINCINNATI, OH 800-436-7800; 513-793-3200
EIFS	***BASIS OF DESIGN*** STO CORP ATLANTA, GA 407-466-5371 ATTN: TIM SALERNO (STRATEGIC ACCOUNTS MANAGER)	LAMINATE (L-1,L-2)	WILSONART 254-718-7907 ATTN: JOHN HILL, hillj@wilsonart.com AVAILABLE THRU LOCAL RETAIL LOCATIONS;	EXTERIOR SIGNAGE (INCLUDING EXTERIOR BRANDING MOMENT & PREMANUFACTURED ACM	CUSTOM SIGN CENTER COLUMBUS, OHIO 800-522-2934 ATTN: MICHAEL ANDERSON		XIOTITA, KS 319-230-8889 ATTN: MARK NORVOLD KOLPAK PARSONS, TN 1-800-826-7036 x5623		PEPCO (EDISON EQ) HILLIARD, OH 614-883-5710
	DRYVIT SYSTEMS, INC. WARWICK, RI 734-276-0404 ATTN: ROBERT DAZEL (MARKETING MGR)	(PEX-1, PEX-2, PEX-4, PEX-5, PEX-6, PEX-7, PEX-8)	CONTACT NATIONAL ACCOUNT REP'S BELOW FOR TECHNICAL QUESTIONS ONLY. BENJAMIN MOORE & COMPANY CLEVELAND, OHIO	PANELS)	EVERBRITE GREENFIELD, WI 414-786-5470 ATTN: STEVE GLASENAPP	DIV WATER HEATER	ATTN: TABITHA KING ISION 22 - PLUMBING RHEEM RUUD	PARKING BLOCKS, BOLLARD	ATTN: JENNIFER THOMAS 2 - EXTERIOR IMPROVEMENTS ***BASIS OF DESIGN***
ACM PANEL FABRICATOR	CLADDING & COMPONENT SOLUTIONS CUMMING, GA 770-887-2777 ATTN: STEPHEN ROEGGE	_	330-353-3850 ATTN: DOROTHY HAZINSKI (NATIONAL ACCOUNT MANAGER) MDC WALLCOVERING ELK GROVE VILLAGE, IL		NATIONAL SIGN SYSTEMS COLUMBUS, OHIO 800-544-6726 ATTN: CUSTOMER SERVICE		MONTGOMERY, AL 800-330-6935 ATTN: PAT POWELL (NATIONAL ACCOUNTS MGR) AO SMITH	COVERS	PAWLING CORPORATION WASSAIC, NY 800-431-3456 x3345 ATTN: MARCELLA FARRELL HER VENDORS
	LSI GRAPHICS SOLUTIONS HOUSTON, TX 713-744-4178 ATTN: ANDREW HAREY		800-621-4006 x8338 ATTN: JAN PREWITT ***BASIS OF DESIGN*** (FOR STOREFRONT REFINISHING)		ID ASSOCIATES DOTHAN, AL 615-579-1818 ATTN: MANISH JAISINGHANI	LAVATORY PACKAGE	ALPHARETTA, GA 800-447-1953 (OPT #1) ATTN: NATIONL ACCT. OHIO VALLEY SUPPLY	FREESTYLE MACHINE	COKE 404-676-7952 ATTN: STEVE MULDOWNY
CORRUGATED METAL	ALCOA BULIDING & CONSTRUCTION SYSTEMS MACON, GEORGIA 478-319-0139 ATTN: KEVIN R. JUEDEMAN	_	PPG INDUSTRIES 317-318-5800 cell ATTN: RICK GARLIN (BUSINESS DEVELOPMENT MGR) SHERWIN-WILLIAMS	ART PACK ELEMENTS AND WAYFINDING	GTC COLUMBUS, OHIO 614-252-6342 ATTN: APRIL ANDRICK	- (VANITY, MOUNTING BRACKETS, AND BOWL) PLUMBING FIXTURES	CINCINNATI, OH 800-696-5608 ATTN: RICK NEELY/DAN CORLEY GC SUPPLIED		
DDEMANUEA OTUBER TO SAI	(RETAIL PROGRAM MANAGER)		216-341-5553 ATTN: BRAD HARRINGTON (NATIONAL ACCOUNTS MGR)	LADDER RECEIVER	LADDERTECH, LLC BRIGHTON, MICHIGAN 800-770-8851	(WC AND URINALS) FAUCETS	MOEN INC. CLEVELAND, OH		
PREMANUFACTURED FASCIA AND SOFFITS	CLADDING & COMPONENT SOLUTIONS CUMMING, GA 770-887-2777 ATTN: STEPHEN ROEGGE	SIGN PAINT (PEX-3) WALLCOVERINGS (WC-1, WC-5)	(SEE SIGN VENDORS BELOW) MDC WALLCOVERING ELK GROVE VILLAGE, IL 800-621-4006 x8338		ATTN: MICHELE ORAS OR CUSTOMER SERVICE MODERN FLAMES PHOENIX, AZ	_	800-321-8809 ATTN: CUSTOMER SERVICE AMERICAN STANDARD		
		GROUT, THINSET, AND WATERPOOFING MEMBRANE	ATTN: JAN PREWITT LATICRETE INTERNATIONAL, INC. ITIO IIIth STREET GRAND PRAIRIE, TX 75050-1913, USA Phone: +1.972.641.3266 Fax: +1.972.660.5365	FIREPLACE	877-246-9353 ATTN: TOM FOY		800-442-1902 SLOAN VALVE COMPANY OHIO: 513-681-9999 ATTN: JIM NOLAN OUTSIDE OHIO: 800-982-5839		
			MAPEI AMERICAS HEADQUARTERS 1144 E. NEWPORT CENTER DRIVE DEERFIELD BEACH, FLORIDA 33442 Phone: 1-800-992-6273						

SITE NUMBER:	07588
BASE MODEL:	CONVERSION
ASSET TYPE:	FRANCHISE
CLASSIFICATION:	REFRESH
OWNER:	JARO FOODS
BASE VERSION:	2016 JAN 05
UPGRADE CLASSIFIC	CATION:
	STANDARD
PROJECT YEAR:	2016

FURNITURE PACKAGE: 2015

DESIGN BULLETINS:

Wallin - Gomez Architects, Ltd. 711 South Dearborn Street Suite 606 Chicago, IL 60605

Tel: 312-427-4702 Fax: 312-427-6611 e-mail: admin@wgaltd.com


		57.0
REV.	DATE	DESCRIPTION
	01-08-16	ISSUED FOR PERMIT & BID
$\overline{\Lambda}$	01-19-16	OWNER REVISIONS

PLOT DATE 1/19/2016
PROJECT NUMBER 15130
DRAWN BY CL/KH
CHECKED BY DJW


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GOMEZ ARCHITECTS, LTD.

THESE DRAWINGS HAVE BEEN PREPARED AT AND / OR UNDER MY SUPERVISION AND TO THE BEST OF MY KNOWLEDGE AND BELIEF CONFORM AND COMPLY WITH THE REQUIREMENTS OF THE DEPARTMENT OF BUILDING AND CODES HAVING JURISDICTION.

STATE OF INDIANA
AR19500067
REGISTERED ARCHITECT
DONALD J. WALLIN
EXPIRATION DATE: 12/31/2017

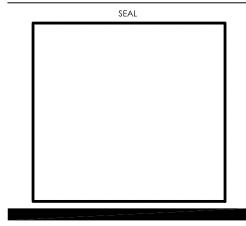

SHEET NAME
APPROVED SUPPLIERS

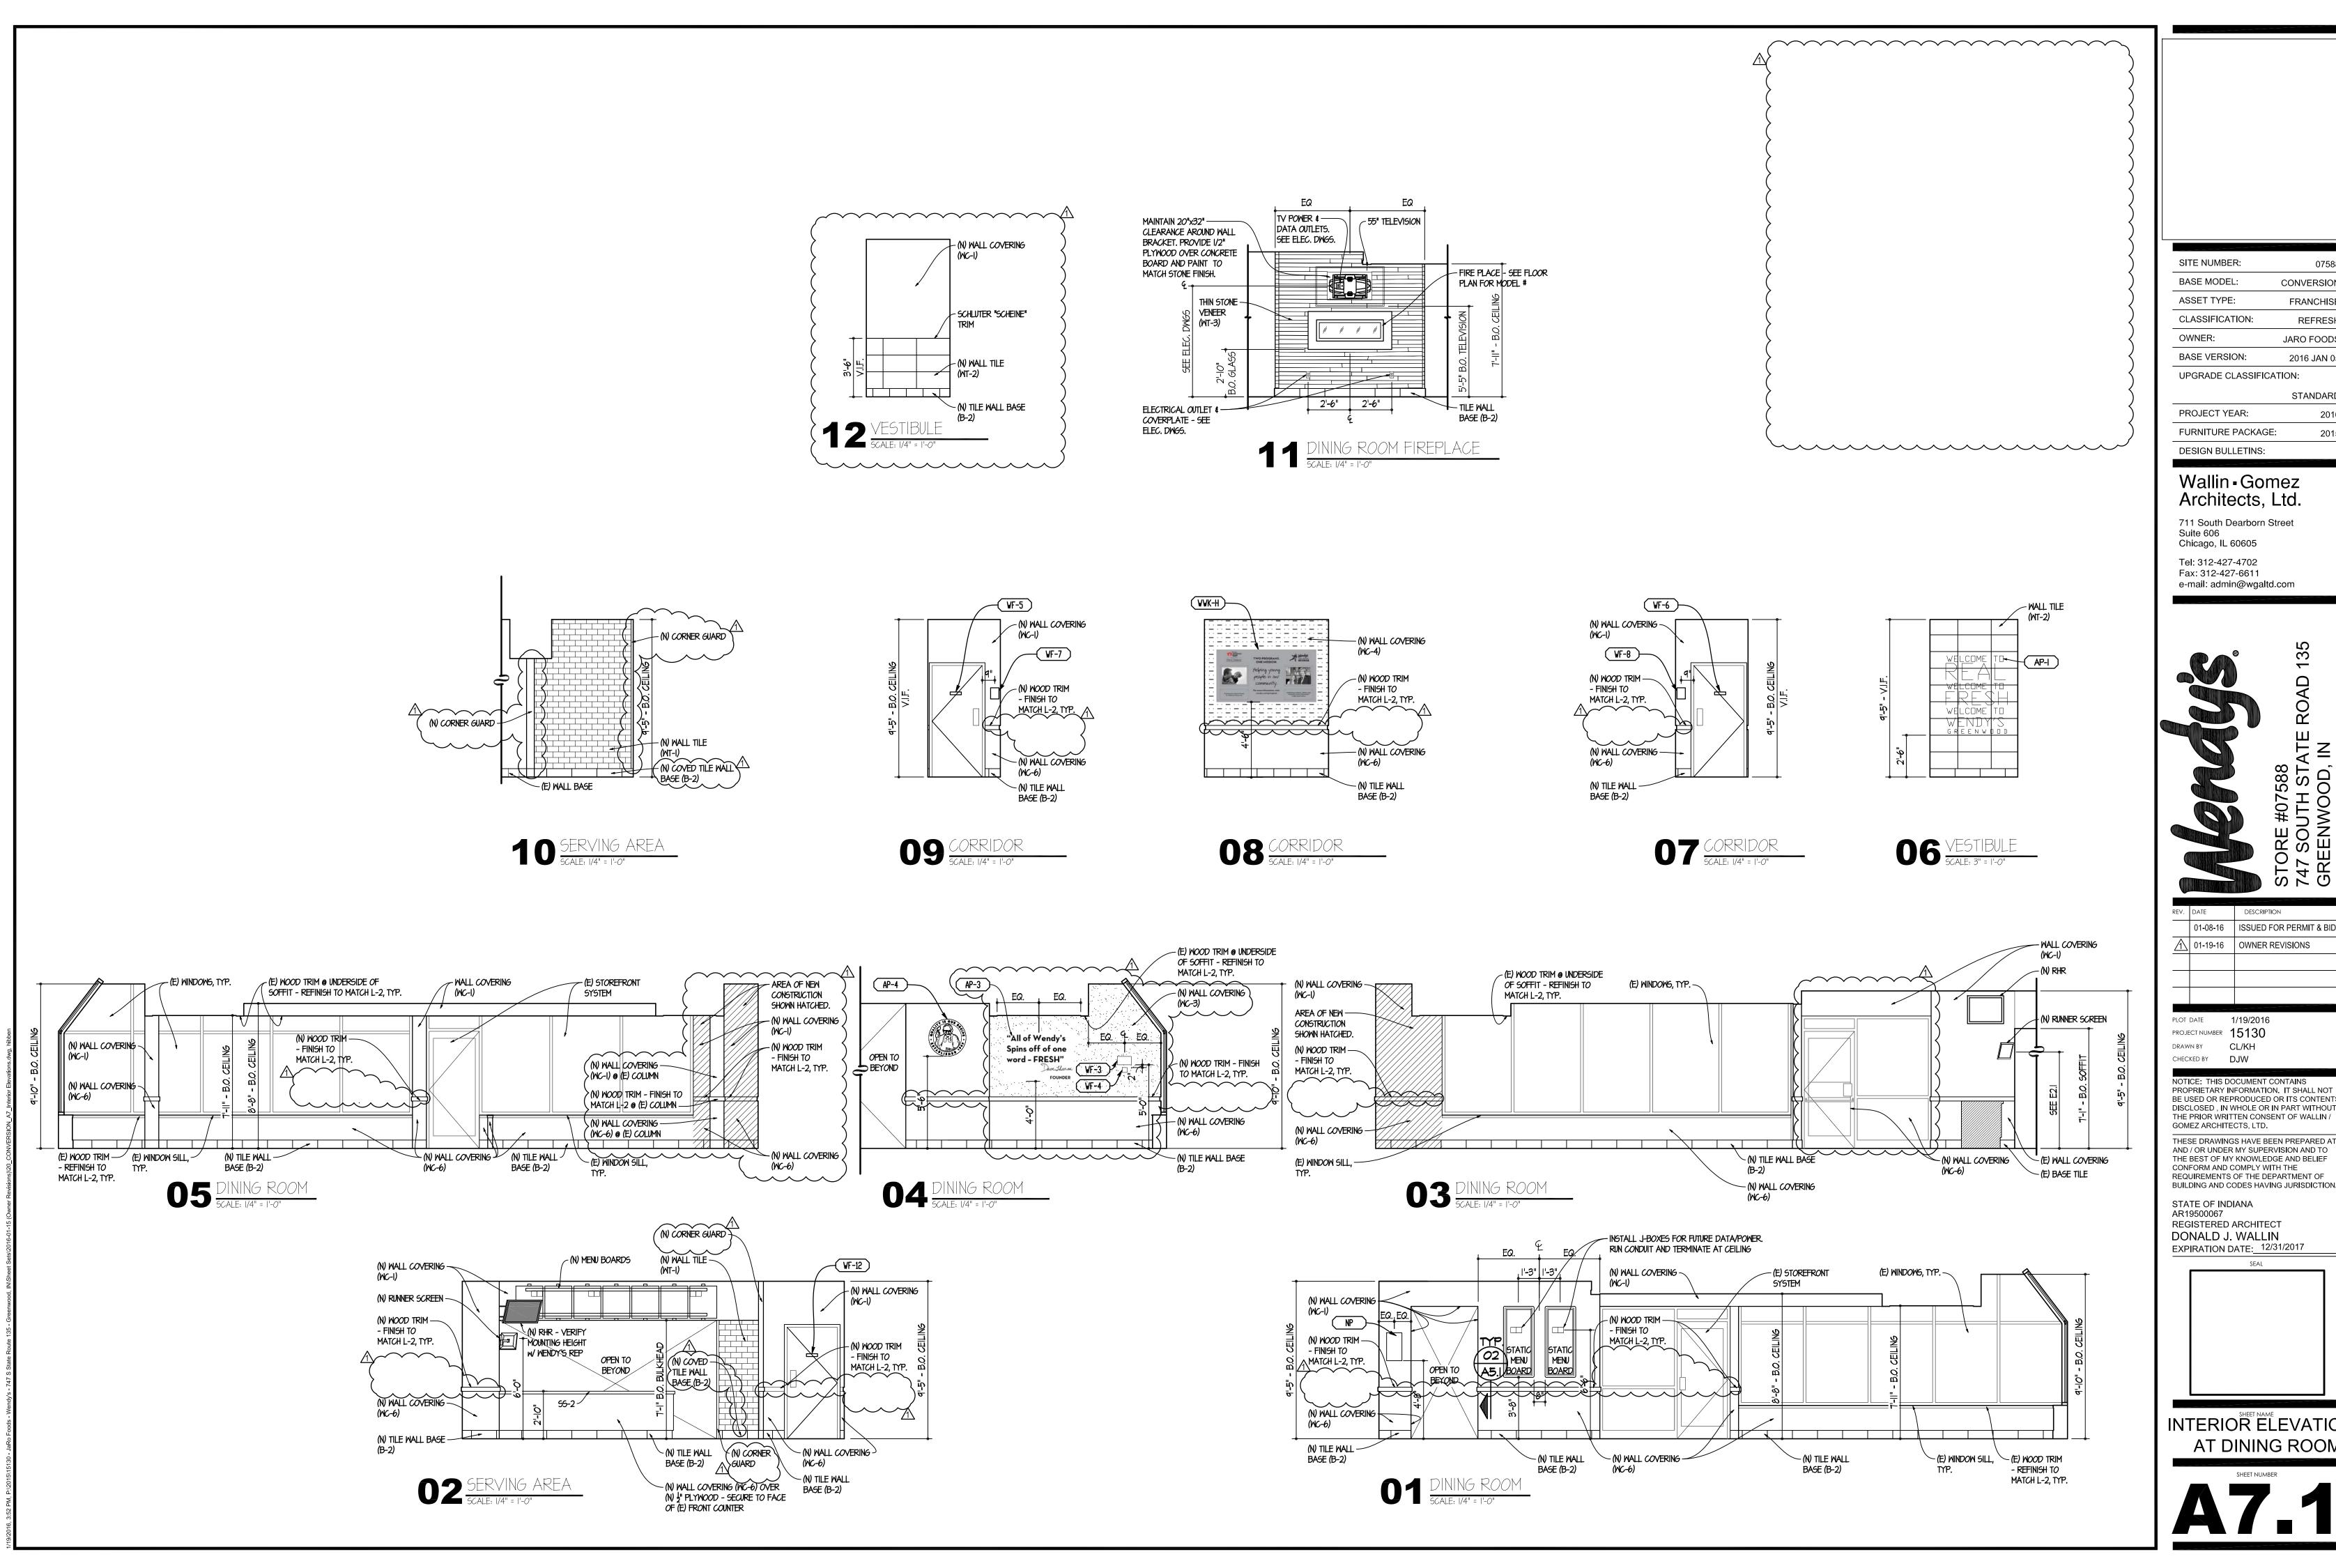

CONVERSION FRANCHISE CLASSIFICATION: REFRESH JARO FOODS BASE VERSION: 2016 JAN 05 UPGRADE CLASSIFICATION:

STANDARD PROJECT YEAR: 2016 FURNITURE PACKAGE:

Wallin - Gomez Architects, Ltd

711 South Dearborn Street Chicago, IL 60605

Tel: 312-427-4702 Fax: 312-427-6611 e-mail: admin@wgaltd.com


	ANTONIA WASHES ANTEN TOTAL TOTAL							
REV.	DATE	DESCRIPTION						
	01-08-16	ISSUED FOR PERMIT & BID						
$\overline{\mathbb{A}}$	01-19-16	OWNER REVISIONS						

PROJECT NUMBER 15130 DRAWN BY CL/KH

> PROPRIETARY INFORMATION. IT SHALL NOT BE USED OR REPRODUCED OR ITS CONTENTS DISCLOSED, IN WHOLE OR IN PART WITHOUT THE PRIOR WRITTEN CONSENT OF WALLIN /

AND / OR UNDER MY SUPERVISION AND TO THE BEST OF MY KNOWLEDGE AND BELIEF CONFORM AND COMPLY WITH THE REQUIREMENTS OF THE DEPARTMENT OF BUILDING AND CODES HAVING JURISDICTION.

REGISTERED ARCHITECT DONALD J. WALLIN EXPIRATION DATE: 12/31/2017

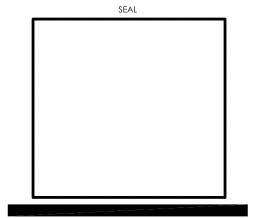

INTERIOR ELEVATIONS AT DINING ROOM

FIXTURE LEGEND

- (A) NOT USED
- SEMI-RECESSED HAND DRYER: XLERATOR XL-SB W 40502 ACCESSIBLE RECESS KIT & STAINLESS STEEL PANEL BELOW
- TOILET TISSUE DISPENSERS: WALL MOUNTED JUMBO ROLL TISSUE DISPENSER BY ASI MODEL NO 0042.
- D NOT USED
- E BABY CHANGING STATION
- F) 42" SIDE GRAB BAR
- (G) 36" REAR GRAB BAR
- (H) MIRROR
- J VERTICAL GRAB BAR
- WALL MOUNTED "ECOLAB" HANDS-FREE SOAP DISPENSER, BLACK

GRAB BARS: STAINLESS STEEL WITH EXPOSED MOUNTING. FINISH SHALL BE SMOOTH AND FURNISHED COMPLETE WITH MOUNTING KIT.

TOILET PARTITIONS


STAINLESS STEEL PARTITIONS IN "SATIN FINISH" BY ACCURATE
PARTITIONS CORP. W/ STAINLESS STEEL CONTINUOUS BRACKETS,
CONTINUOUS PIANO HINGES (SELF-CLOSING ON ACCESSIBLE
STALL DOOR), STAINLESS STEEL SURFACE MOUNTED SLIDE
LATCH, DOOR PULLS ON BOTH SIDES OF ACCESSIBLE STALL
DOOR, AND STAINLESS STEEL SHOES - FLOOR ANCHORED /
OVERHEAD BRACED INSTALLATION. PROVIDED BY G.C. OR KES
(KITCHEN EQUIPMENT SUPPLIER).

RESTROOM SCOPE OF WORK

MINIMUM SCOPE AS NOTED BELOW CONTRACTOR SHALL FURNISH, INSTALL, AND COMPLETE ALL WORK AS NOTED BELOW . CONTRACTOR SHALL VERIFY COMPLETE SCOPE OF RESTROOM WORK WITH THE OWNER'S CONSTRUCTION REPRESENTATIVE PRIOR TO COMPLETING BID PROPOSAL.


- NEW FLOOR, BASE & WALL TILE NEW SEMI-RECESSED HAND DRYER
- NEW DOORS & FRAMES
- NEW RESTROOM SIGNAGE
- NEW PLUMBING FIXTURES AS SCHEDULED ON PLUMBING DRAWING.
 PROVIDE AND INSTALL NEW SOLID WALL BLOCKING IN WALLS AS
- REQUIRED FOR ANY NEW OR RELOCATED FIXTURES OR ACCESSORIES.

NOTE: CONTRACTOR TO PROVIDE 2x WOOD BLOCKING IN WALL FOR ANCHORAGE OF GRAB BARS AS REQUIRED.

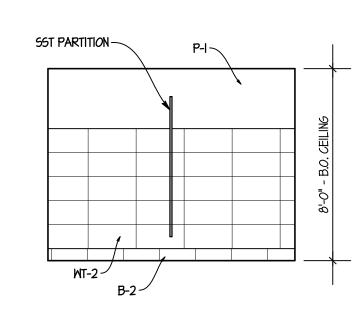


08 MEN'S TOILET ROOM

5CALE: 1/4" = 1'-0"

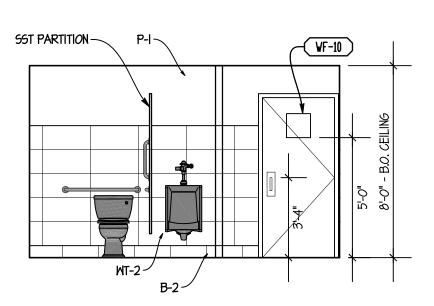


07 MEN'S TOILET ROOM SCALE: 1/4" = 1'-0"

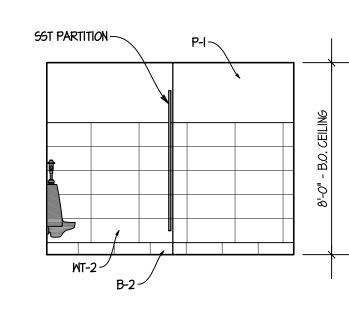


06 MEN'S TOILET ROOM

SCALE: 1/4" = 1'-0"

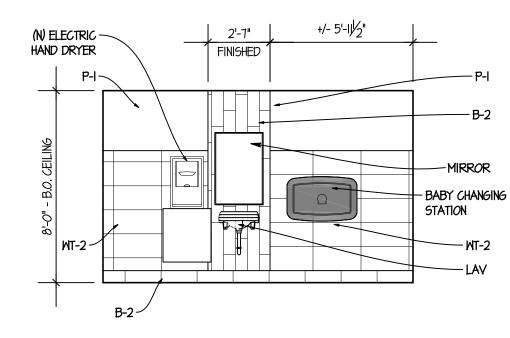


05 MEN'S TOILET ROOM
5CALE: 1/4" = 1'-0"

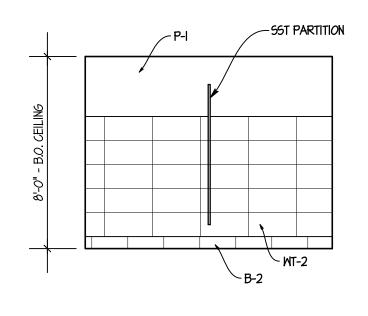


04 MOMEN'S TOILET ROOM


SCALE: 1/4" = 1'-0"

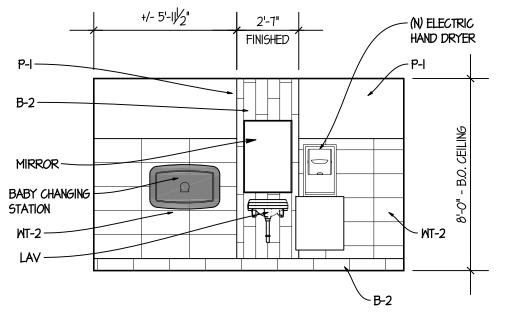

03 MOMEN'S TOILET ROOM
5CALE: 1/4" = 1'-0"

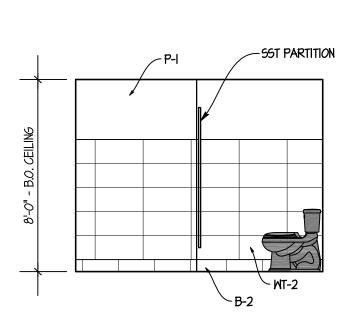



02 MOMEN'S TOILET ROOM SCALE: 1/4" = 1'-0"

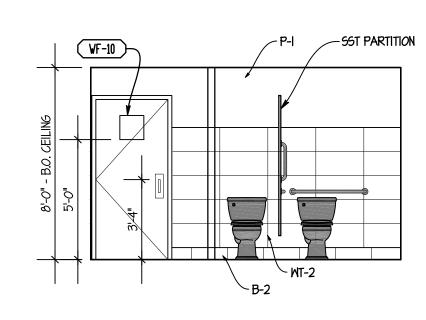


MOMEN'S TOILET ROOM

SCALE: 1/4" = 1'-0"

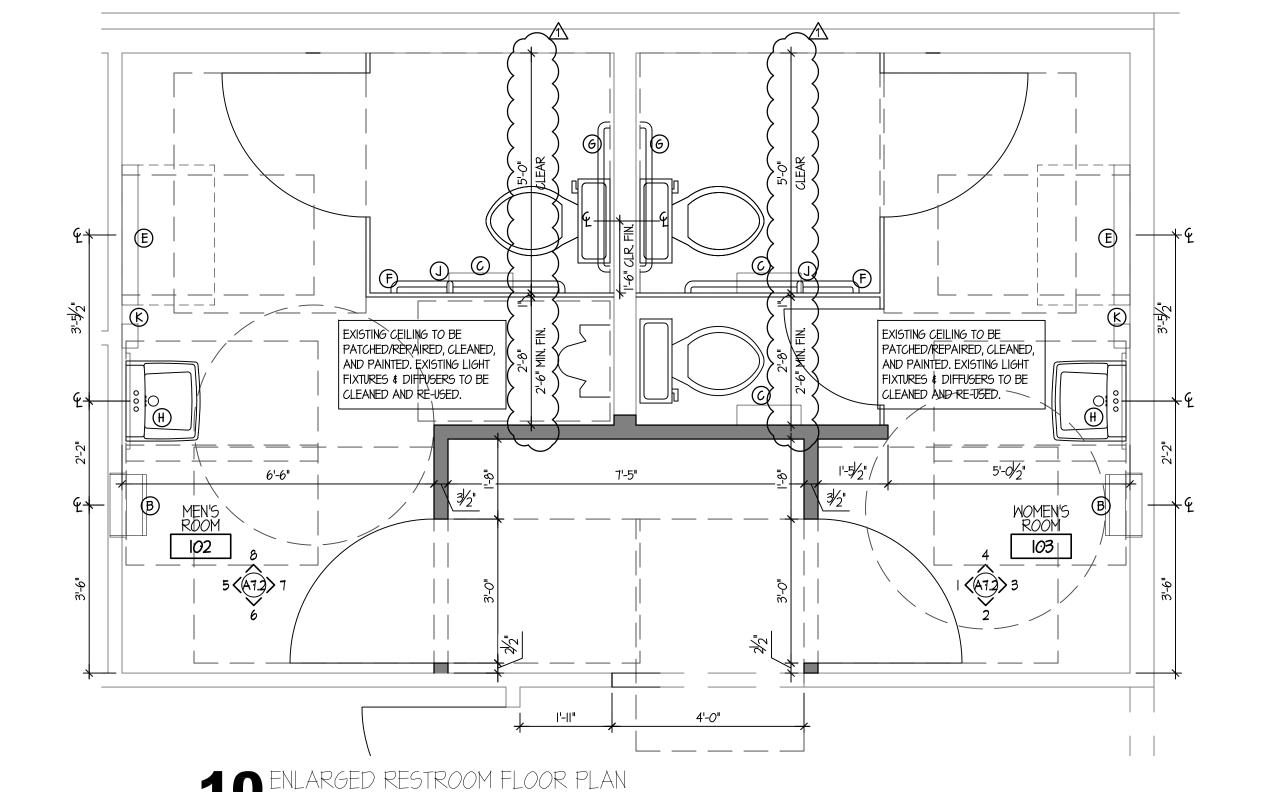

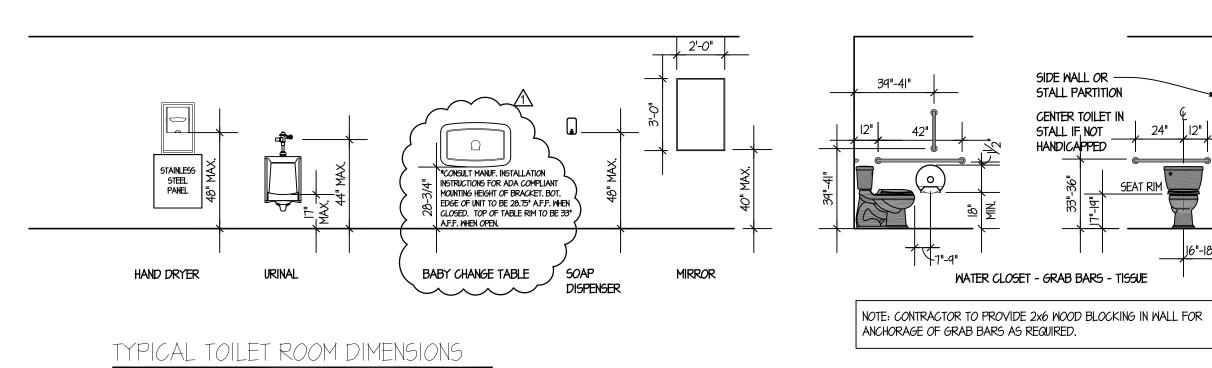

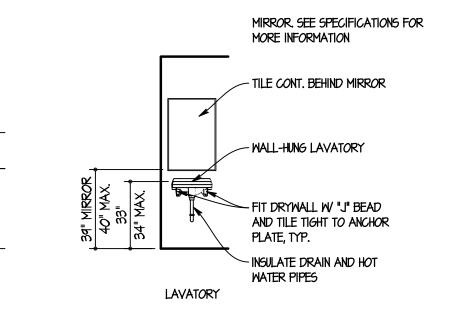

SITE NUMBER: 07588

BASE MODEL: CONVERSION

ASSET TYPE: FRANCHISE

CLASSIFICATION: REFRESH

OWNER: JARO FOODS

BASE VERSION: 2016 JAN 05


UPGRADE CLASSIFICATION:

	STANDARD
PROJECT YEAR:	2016
FURNITURE PACKAGE:	2015
DESIGN BULLETINS:	_

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Tel: 312-427-4702 Fax: 312-427-6611 e-mail: admin@wgaltd.com




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REV.	DATE	DESCRIPTION								
	01-08-16	ISSUED FOR PERMIT & BID								
<u> </u>	01-19-16	OWNER REVISIONS								

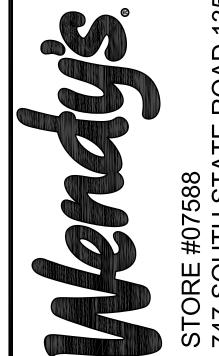PLOT DATE 1/19/2016
PROJECT NUMBER 15130
DRAWN BY CL/KH
CHECKED BY DJW


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STATE OF INDIANA
AR19500067
REGISTERED ARCHITECT
DONALD J. WALLIN
EXPIRATION DATE: 12/31/2017



INTERIOR ELEVATIONS
AT RESTROOMS

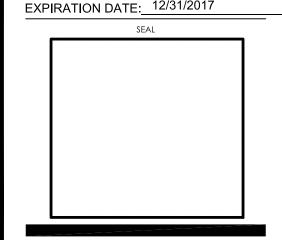

NOTE: THE CONTRACTOR SHALL PROVIDE AND INSTALL SOLID WOOD BLOCKING FOR ALL WALL MOUNTED ITEMS, SIGNS, EQUIPMENT, MILLWORK, ETC. COORDINATE LOCATIONS WITH OWNER'S CONSTRUCTION REP AS NECESSARY.

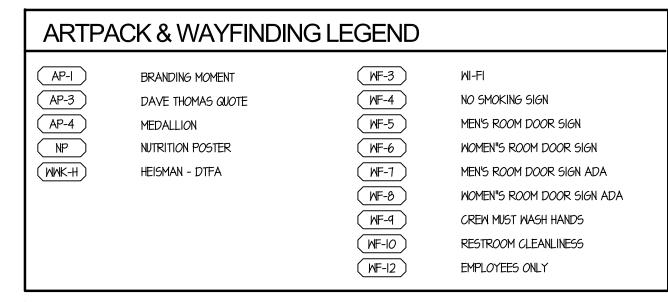(E) MATER HEATER DRY STORAGE 109 T270	/ \	RACH BELOW H H H H H H H H H H H H H H H H H H H
COOLER III PREPARATION AREA IOB IIIO	DOIOO RUNNER SCREEN (E) TRASH (E) COFFEE BREWER REINSTALLED (E) TEA DISPENSERS RELOCATED DRIVE-THRU AOIOO KES TO MODIFY EXIST.	DINING IOI BICH CHAIRS EN VREINSTALLED VREINSTALLED H H H H H H H H H H H H H
CONFIRM W MENDY'S REP AND KES IF DRIVE-THRU POS SYSTEMS ARE TO BE REPLACED	DOZOO BEVARIETY INSTALL CONFIRM W MENDY'S REP AND KES IF DRIVE-THRU POS SYSTEMS ARE TO BE REPLACED	NORTH EQUIPMENT PLAN SCALE: 1/4" = 1'-0"

MARK	QTY.	EQUIPMENT SCHEDULE					
≥		DESCRIPTION OF EQUIPMENT	REMARKS	FURNISHED	INSTALLED		
A0100		BEVERAGE SYSTEM DRIVE-THRU (BEVARIETY)		0	0		
					\pm		
CO2O#	3	SOAP DISPENSERS	*OWNER TO VERIFY ACTUAL EQUIPMENT/MODEL TO BE USED	0	0		
CO30#	2	HAND DRYER	*OWNER TO VERIFY ACTUAL EQUIPMENT/MODEL TO BE USED	0	0		
CO30#		PAPER TOWEL DISPENSER - KITCHEN	*OWNER TO VERIFY ACTUAL EQUIPMENT/MODEL TO BE USED	E5	GC		
CO102	<u> </u>	6 HOLE CUP DISPENSER (SADDLE TYPE)		E5	ES		
C0700	3	TOILET TISSUE DISPENSER		ES	ES		
C1801	ı	LID/STRAW DISPENSER		ES	ES		
D0100		POS MONITOR		0	0		
D0200	2	POS TERMINAL		0	0		
E1405		FRONT COUNTER (COUNTER TOP ONLY)		E5	ES		
	\vdash				+		
NO202	2	CASH DROP BOX		ES	ES		
	\vdash				+		
V <i>050</i> 1	I	STATIC MENU BOARDS	*OWNER TO VERIFY ACTUAL EQUIPMENT/MODEL TO BE USED	0	0		
V0502	2	STATIC QUEUING BOARDS	*OWNER TO VERIFY ACTUAL EQUIPMENT/MODEL TO BE USED	0	0		
V0503	-	STATIC RHR BOARD	*OWNER TO VERIFY ACTUAL EQUIPMENT/MODEL TO BE USED	0	0		
T0302		FAUCET - HAND SINK (HANDS FREE)		ES	GC		
T270I	1	HAND SINK		ES	GC		

SITE NUMBER:	07588
BASE MODEL:	CONVERSION
ASSET TYPE:	FRANCHISE
CLASSIFICATION:	REFRESH
OWNER:	JARO FOODS
BASE VERSION:	2016 JAN 05
UPGRADE CLASSIFIC	CATION:
	STANDARD
PROJECT YEAR:	2016

Wallin • Gomez Architects, Ltd.

2015

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FURNITURE PACKAGE:

DESIGN BULLETINS:

Tel: 312-427-4702 Fax: 312-427-6611 e-mail: admin@wgaltd.com

STORE #07588
747 SOUTH STATE ROAD 138
GREENWOOD, IN

REV.	DATE	DESCRIPTION								
	01-08-16	ISSUED FOR PERMIT & BID								
$\overline{\Lambda}$	01-19-16	OWNER REVISIONS								

PLOT DATE 1/19/2016
PROJECT NUMBER 15130
DRAWN BY CL/KH
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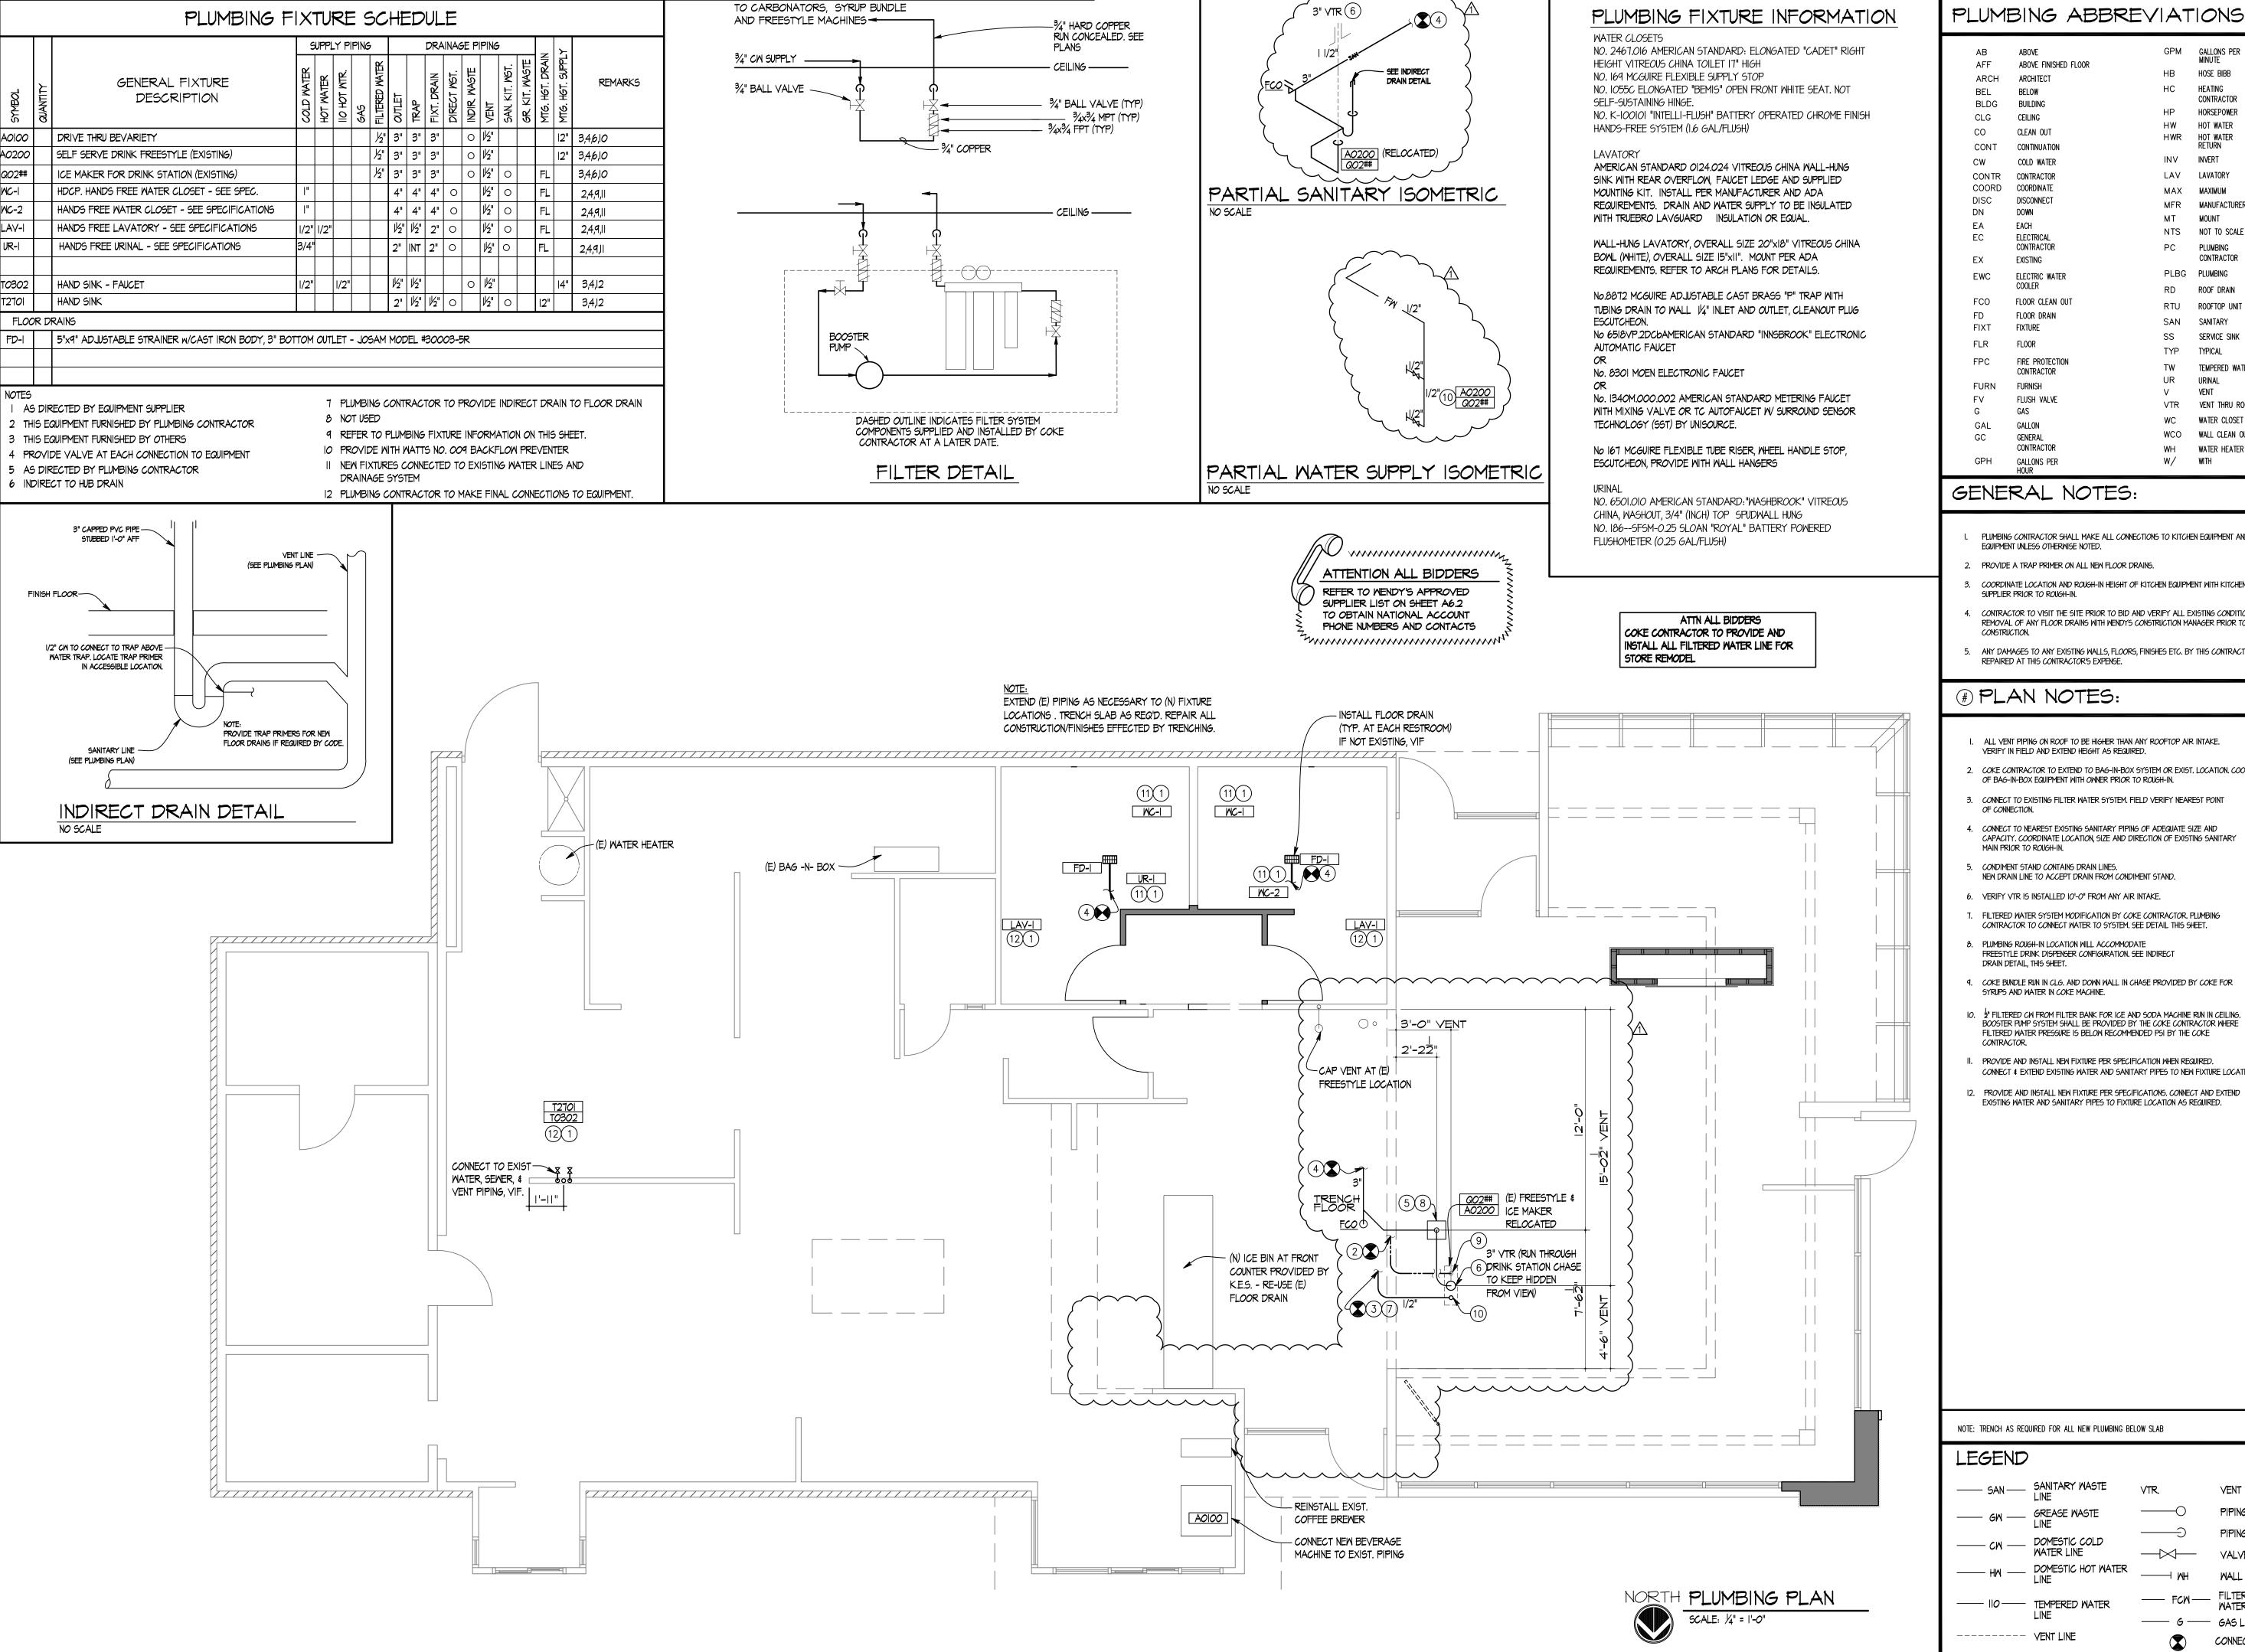
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STATE OF INDIANA
AR19500067
REGISTERED ARCHITECT
DONALD J. WALLIN
EXPIRATION DATE: 12/31/2017

. .

SHEET NAME
EQUIPMENT PLAN
AND SCHEDULE



TO CARBONATORS, SYRUP BUNDLE

PLUMBING ABBREVIATIONS

GPM GALLONS PER MINUTE

HP HORSEPOWER

HW HOT WATER

HWR HOT WATER RETURN

LAV LAVATORY

MAX MAXIMUM

INVERT

MFR MANUFACTURER

NTS NOT TO SCALE

PLBG PLUMBING

SAN SANITARY

TYP

UR

SS SERVICE SINK

TYPICAL

TW TEMPERED WATER

URINAL

VENT

VTR VENT THRU ROOF

WCO WALL CLEAN OUT

WH WATER HEATER

W/ WITH

WATER CLOSET

RD ROOF DRAIN

RTU ROOFTOP UNIT

PLUMBING

CONTRACTOR

HB

INV

HOSE BIBB

HEATING

CONTRACTOR

ABOVE FINISHED FLOOR CONTINUATION COLD WATER CONTRACTOR COORDINATE DISCONNECT ELECTRICAL CONTRACTOR ELECTRIC WATER FLOOR CLEAN OUT FLOOR DRAIN

- PLUMBING CONTRACTOR SHALL MAKE ALL CONNECTIONS TO KITCHEN EQUIPMENT AND MECHANICAL EQUIPMENT UNLESS OTHERWISE NOTED.
- PROVIDE A TRAP PRIMER ON ALL NEW FLOOR DRAINS.
- COORDINATE LOCATION AND ROUGH-IN HEIGHT OF KITCHEN EQUIPMENT WITH KITCHEN EQUIPMENT
- CONTRACTOR TO VISIT THE SITE PRIOR TO BID AND VERIFY ALL EXISTING CONDITIONS. VERIFY REMOVAL OF ANY FLOOR DRAINS WITH WENDYS CONSTRUCTION MANAGER PRIOR TO START OF
- ANY DAMAGES TO ANY EXISTING WALLS, FLOORS, FINISHES ETC. BY THIS CONTRACTOR ARE TO BE REPAIRED AT THIS CONTRACTOR'S EXPENSE.

PLAN NOTES:

- . ALL VENT PIPING ON ROOF TO BE HIGHER THAN ANY ROOFTOP AIR INTAKE. VERIFY IN FIELD AND EXTEND HEIGHT AS REQUIRED.
- COKE CONTRACTOR TO EXTEND TO BAG-IN-BOX SYSTEM OR EXIST. LOCATION. COORDINATE LOCATION OF BAG-IN-BOX EQUIPMENT WITH OWNER PRIOR TO ROUGH-IN.
- 3. CONNECT TO EXISTING FILTER WATER SYSTEM. FIELD VERIFY NEAREST POINT
- 4. CONNECT TO NEAREST EXISTING SANITARY PIPING OF ADEQUATE SIZE AND CAPACITY. COORDINATE LOCATION, SIZE AND DIRECTION OF EXISTING SANITARY
- MAIN PRIOR TO ROUGH-IN
- CONDIMENT STAND CONTAINS DRAIN LINES. NEW DRAIN LINE TO ACCEPT DRAIN FROM CONDIMENT STAND.
- 6. VERIFY VTR IS INSTALLED IO'-O" FROM ANY AIR INTAKE.
- 7. FILTERED WATER SYSTEM MODIFICATION BY COKE CONTRACTOR, PLUMBING CONTRACTOR TO CONNECT WATER TO SYSTEM. SEE DETAIL THIS SHEET.
- FREESTYLE DRINK DISPENSER CONFIGURATION. SEE INDIRECT DRAIN DETAIL, THIS SHEET.
- 9. COKE BUNDLE RUN IN CLG. AND DOWN WALL IN CHASE PROVIDED BY COKE FOR SYRUPS AND WATER IN COKE MACHINE.
- 10. $\frac{1}{2}$ " FILTERED CM FROM FILTER BANK FOR ICE AND SODA MACHINE RUN IN CEILING. BOOSTER PUMP SYSTEM SHALL BE PROVIDED BY THE COKE CONTRACTOR WHERE FILTERED WATER PRESSURE IS BELOW RECOMMENDED PSI BY THE COKE
- II. PROVIDE AND INSTALL NEW FIXTURE PER SPECIFICATION WHEN REQUIRED.
- CONNECT & EXTEND EXISTING WATER AND SANITARY PIPES TO NEW FIXTURE LOCATION AS REQ'D.

DRAWN BY CL/KH CHECKED BY DJW

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NOTE: TRENCH AS REQUIRED FOR ALL NEW PLUMBING BELOW SLAB

VENT THRU ROOF PIPING RISE PIPING DROP WALL HYDRANT - FCW FILTERED COLD WATER

—— 6 —— GAS LINE

CONNECT TO EXISTING

BASE MODEL: CONVERSION **ASSET TYPE:** FRANCHISE CLASSIFICATION: REFRESH OWNER: JARO FOODS BASE VERSION: 2016 JAN 05 **UPGRADE CLASSIFICATION:** STANDARD PROJECT YEAR: 2016 FURNITURE PACKAGE: 2015 **DESIGN BULLETINS:**

07588

SITE NUMBER:

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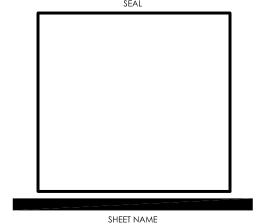
PLOT DATE 1/19/2016 PROJECT NUMBER 15130

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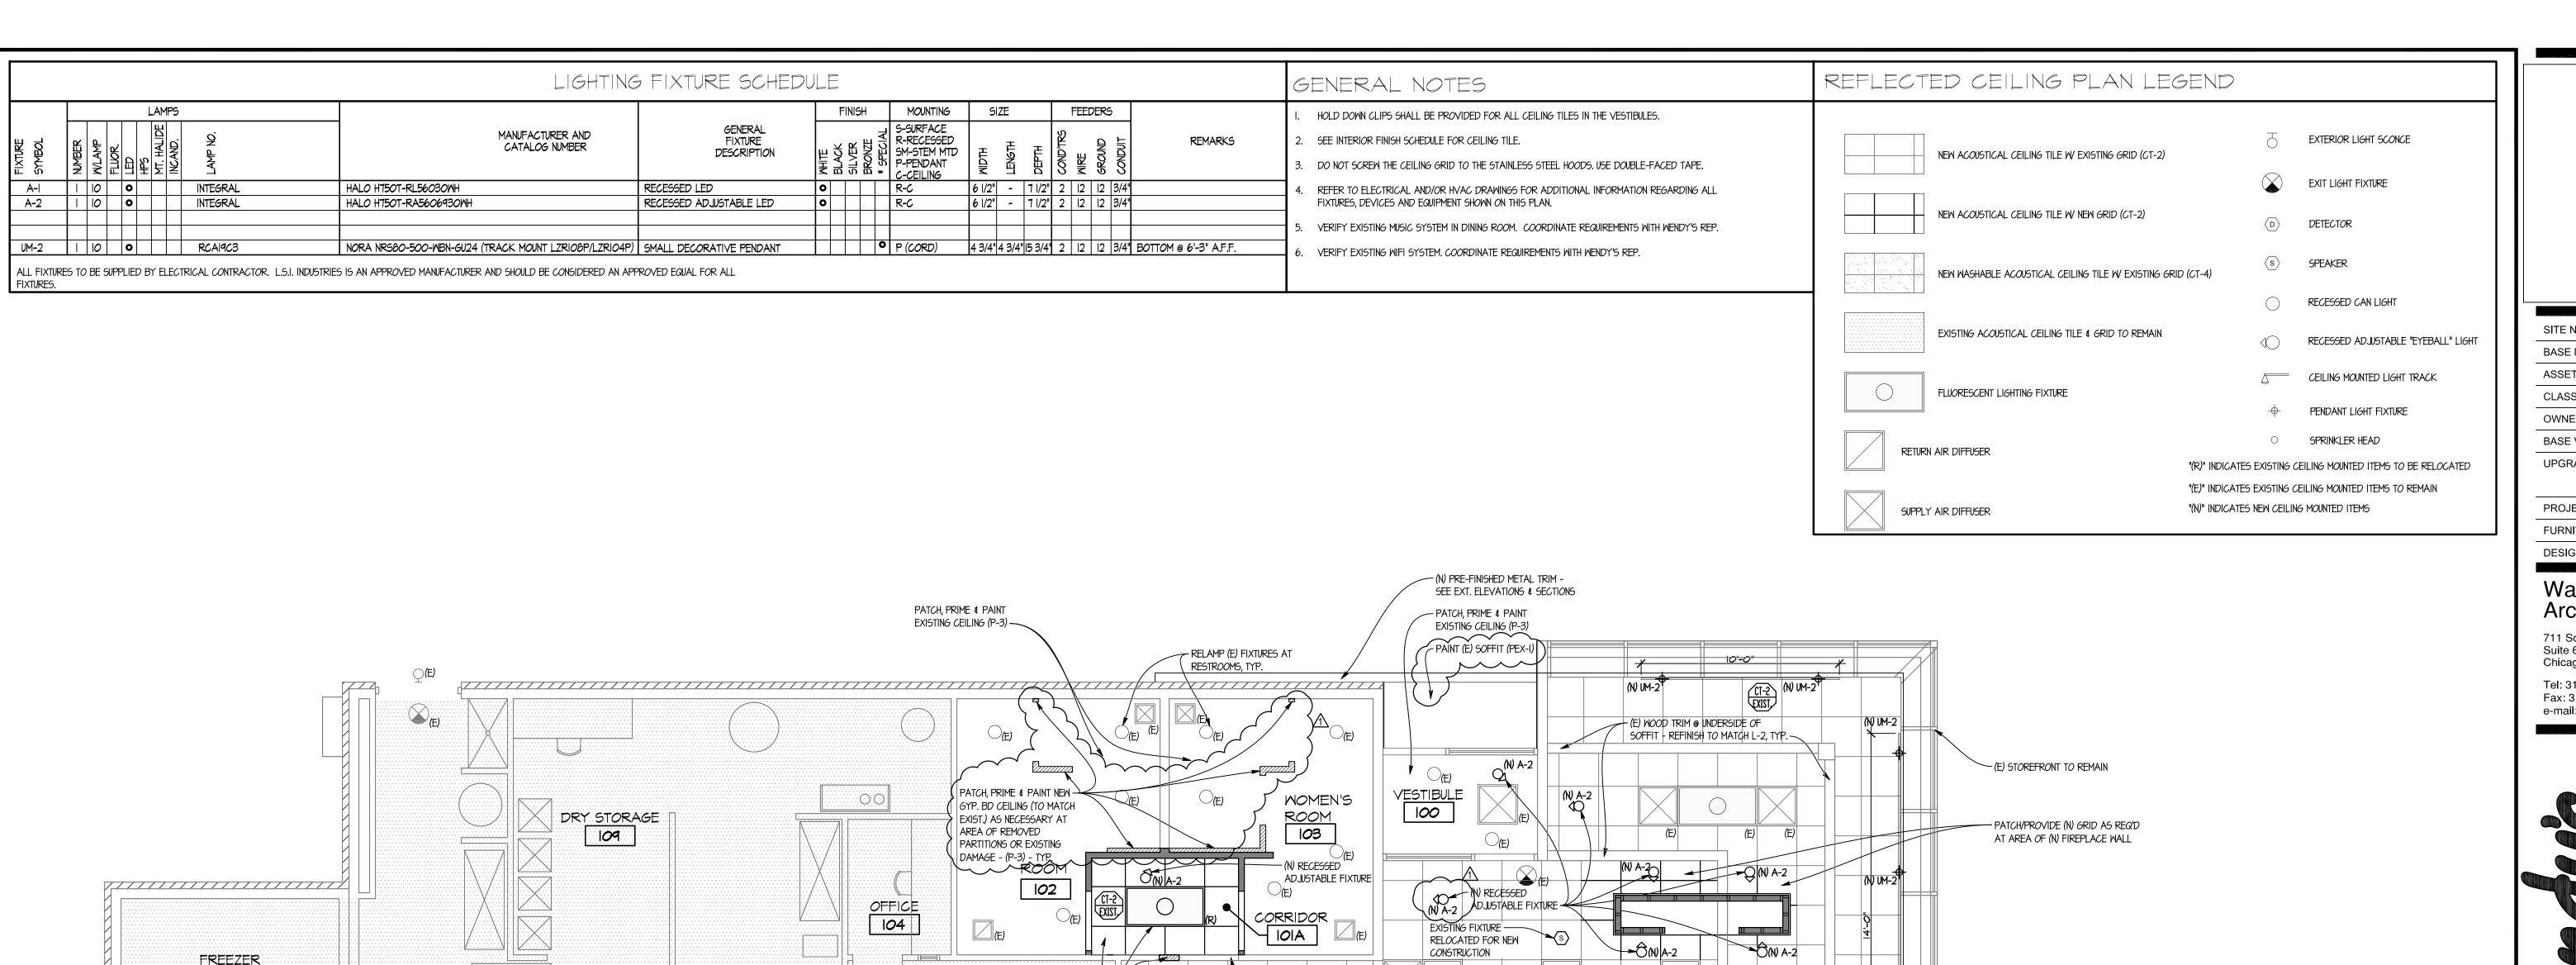
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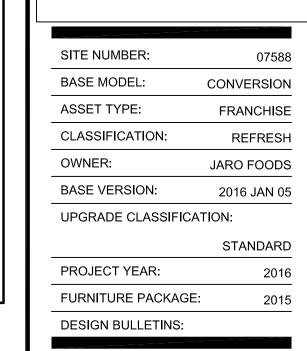
1\ 01-19-16 OWNER REVISIONS

STATE OF INDIANA AR19500067 REGISTERED ARCHITECT DONALD J. WALLIN EXPIRATION DATE: 12/31/2017



PLUMBING PLAN AND SCHEDULE





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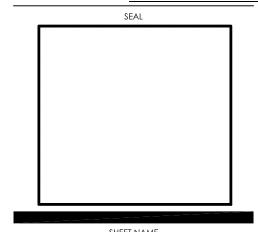
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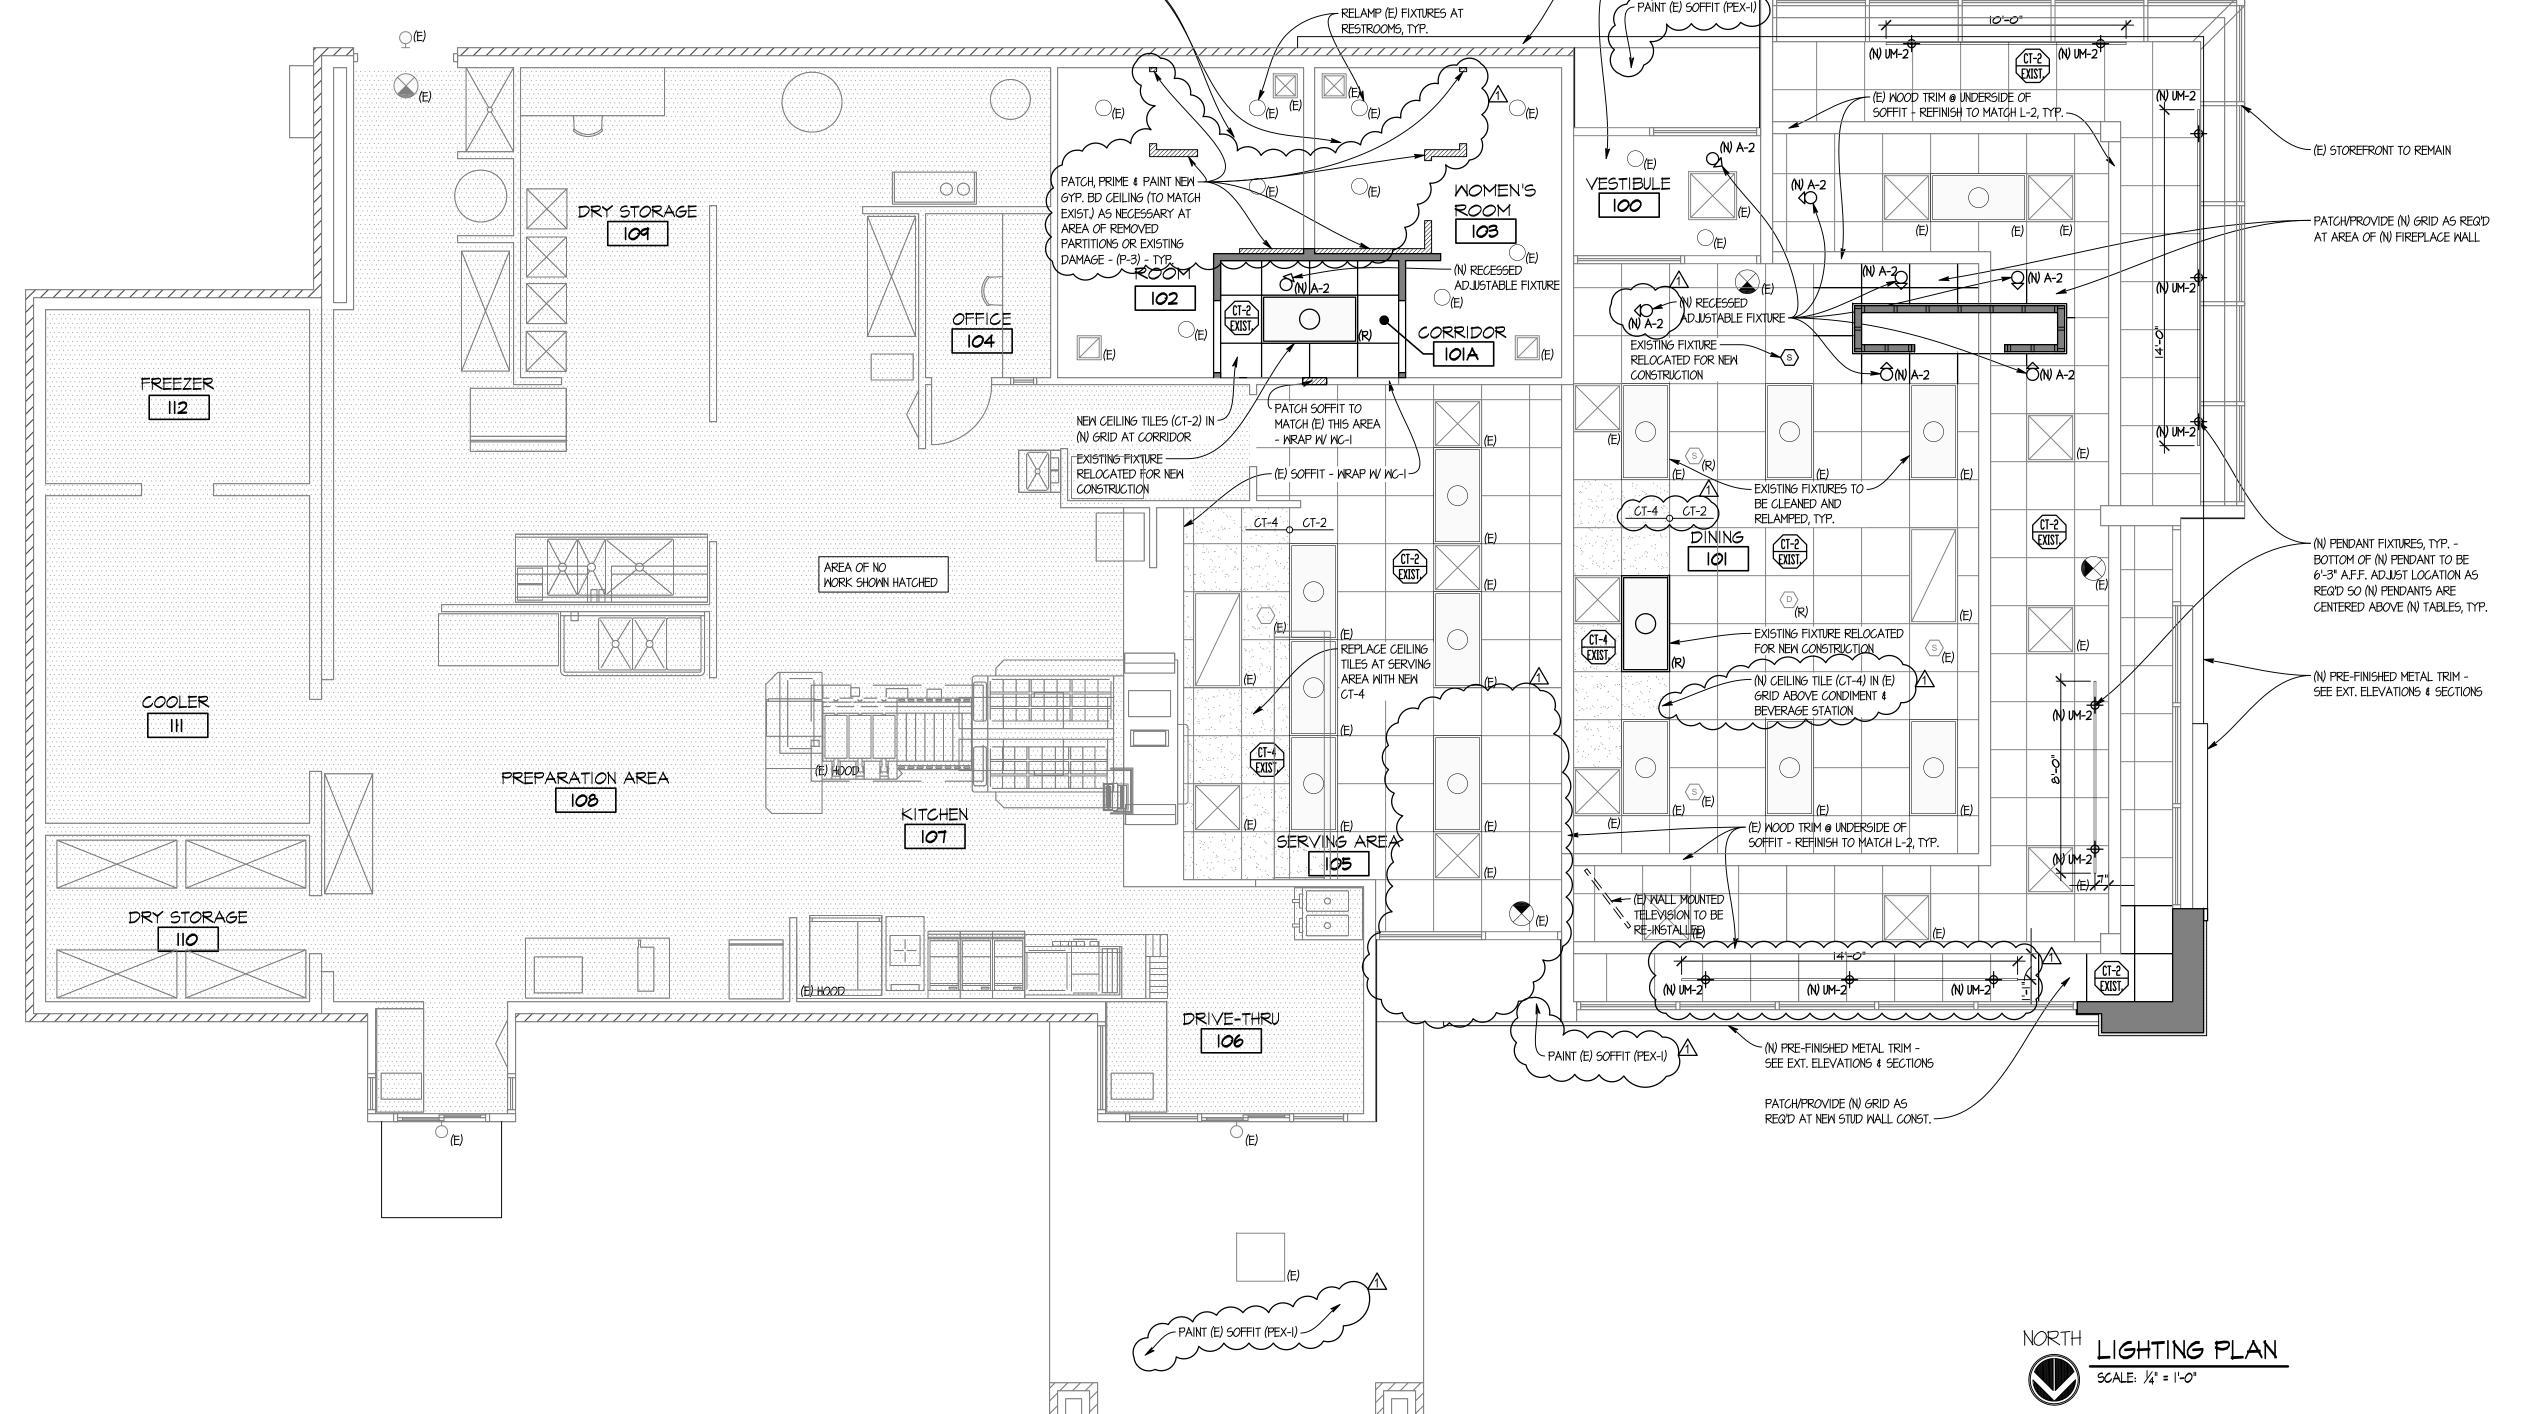
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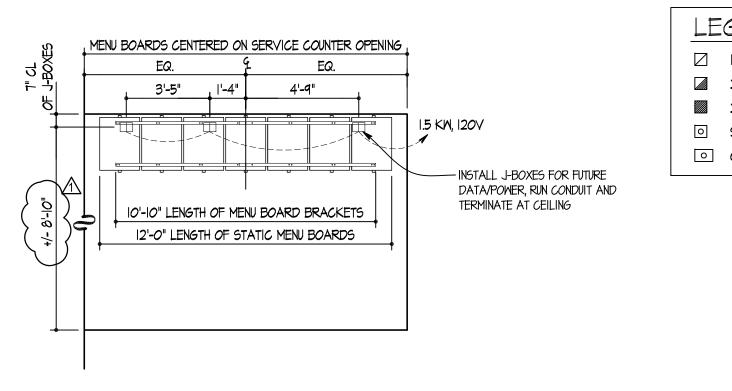
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DONALD J. WALLIN
EXPIRATION DATE: 12/31/2017



REFLECTED CEILING & LIGHTING PLAN






O1 STATIC MENU BOARD ROUGH-IN ELEVATION

SCALE: 1/4" = 1'-0"

LEGEND

- ☐ I20V-IPH JUNCTION BOX
- 208/240V-IPH JUNCTION BOX
- 208/240V-3PH JUNCTION BOX
- OVERSIZED JUNCTION BOX WITH CONDUIT
- STANDARD JUNCTION BOX WITH CONDUIT
- → 20 AMP 120V-IPH DUPLEX RECEPTACLE 120V-IPH QUADUPLEX RECEPTACLE
- → MOTOR STARTER € 208/240V-IPH RECEPTACLE TELEPHONE TERMINATION ● 208/240V-3PH RECEPTACLE □ DATA CONNECTION
- 208/240V-IPH DISCONNECT SMITCH BFC BELOW FINISHED CEILING 208/240V-3PH DISCONNECT SWITCH AFF ABOVE FINISHED FLOOR

ELECTRIC MOTOR

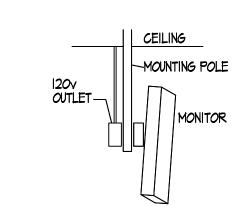

02 MONITOR SCHEMATIC

EQUIPMENT & CONNECTIONS


		LOAD VOLTAGE			CONNECTIONS		FEEDER							
CIRCUIT	DESCRIPTION ALL BLACK HORSEPOWER	KILOWATTS	20V-IPH	208V-IPH	208V-3PH	120/208V-IPH	TYPE	PLUG CORD *	CONDUCTORS *	MIRE SIZE	GROUND SIZE	CONDUIT SIZE	NOTES	
	VEICTION LITIER ODON IND		.5	0				DIRECT	ES	2	12	12	3/4"	
	MENUBOARD		1.5	0				DIRECT	ES	2	12	12	3/4"	
	REDHEAD ROASTER		.5	0				RECEPTACLE	ES	2	12	12	3/4"	
	RUNNER SCREEN		.2	0				RECEPTACLE	ES	2	12	12	3/4"	
(E) SELF SERVE FREESTYLE		1.4	0				RECEPTACLE	ES	2	12	12	3/4"	
(E) CONDENSER		2.5		0			MP DISC SMITCH @ UNIT	ES	3	0	9	3/4	
	TV		.8	0				RECEPTACLE	ES	2	12	12	3/4"	
(E) WIFI/CONVENIENCE OUTLETS		1.5	0				DIRECT	ES	2	12	12	3/4"	
-	ELECTRIC FIREPLACE		.2	0				DIRECT	EC	2	12	12	3/4"	

- ES /EQUIPMENT SUPPLIER EC /ELECTRICAL CONTRACTOR
- ** CONDUCTOR QUANTITY DOES NOT INCLUDE GROUND WIRE

GENERAL NOTES

REFER TO "WIRING AND SITE PREPARATION GUIDE" AS PREPARED BY WENDY'S INTERNATIONAL "INFORMATION SYSTEMS DEPARTMENT" FOR INSTALLATION OF POINT OF SALE CASH REGISTER

- ELECTRICAL CONTRACTOR TO COORDINATE WORK WITH MECHANICAL, REFRIGERATION AND EQUIPMENT CONTRACTORS, INCLUDING COOLER/FREEZER WORK. (IF APPLICABLE)
- ELECTRICAL CONTRACTOR TO VERIFY ALL ROUGH-IN DIMENSIONS AND POWER REQUIREMENTS
- WITH KITCHEN EQUIPMENT SUPPLIER PRIOR TO ROUGH-IN. ELECTRICAL CONTRACTOR TO HOOK UP FIELD CONNECTIONS WITHIN FRONT COUNTER, AND ICE
- MACHINE REMOTE UNIT (ON ROOF) AT TIME OF INSTALLATION.
- HEIGHTS INDICATED FOR RECEPTACLES AND JUNCTION BOXES ARE MEASURED FROM FINISH FLOOR TO THE CENTER OF THE BOX UNLESS OTHERWISE NOTED.
- ELECTRICAL CONTRACTOR IS RESPONSIBLE FOR INSTALLING ALL TELEPHONE LINES AND TERMINATIONS. VERIFY QUANTITY AND LOCATIONS WITH OWNER PRIOR TO BIDDING.
- ALL CIRCUITS MAY BE CORRECTED TO THE LEAST AMOUNT OF CONDUIT RUN UNLESS OTHERWISE
- ALL COVER PLATES TO BE SATIN FINISH STAINLESS STEEL THROUGHOUT UNLESS OTHERWISE
- ALL NEW 120V RECEPTACLES IN KITCHEN TO HAVE GROUND-FAULT CIRCUIT INTERRUPTER PROTECTION. OTHER GFI'S SHOWN SEPARATELY.
- 10. FOR THE IBM POINT OF SALE REGISTER SYSTEM ONLY: ALTERNATE P.O.S. SUPPLIERS MUST CONFORM TO THE REGISTER LAYOUT OR PROVIDE THE OWNER AND/OR GENERAL CONTRACTOR WITH WIRING DIAGRAMS AND INSTALLATION DETAILS BEFORE THE ELECTRICAL CONTRACTOR STARTS ANY WORK.
- ALL CONDUITS SHOULD BE STEEL FLEX OR PLASTIC STUBBED OUT ABOVE THE CEILING LINE AND TERMINATED INTO A J-BOX AS NOTED AND CAPABLE OF ACCEPTING A FACEPLATE COVER.
- ALL J-BOXES SHOULD BE INSTALLED IN SUCH A WAY THAT THEY ARE NOT BLOCKED BY OTHER EQUIPMENT OR STRUCTURAL COMPONENTS.

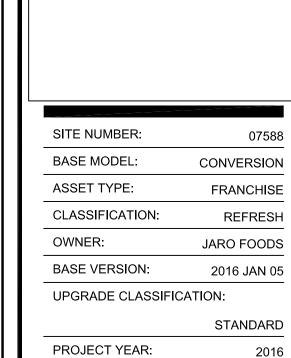

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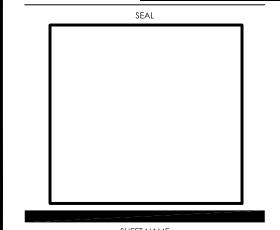
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	01-08-16	ISSUED FOR	PERMIT	& BID
<u> </u>	01-19-16	OWNER REV	ISIONS	


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STATE OF INDIANA AR19500067 REGISTERED ARCHITECT DONALD J. WALLIN EXPIRATION DATE: 12/31/2017





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DIVISION I - GENERAL SPECIFICATIONS

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DIVISION 4 - MASONRY

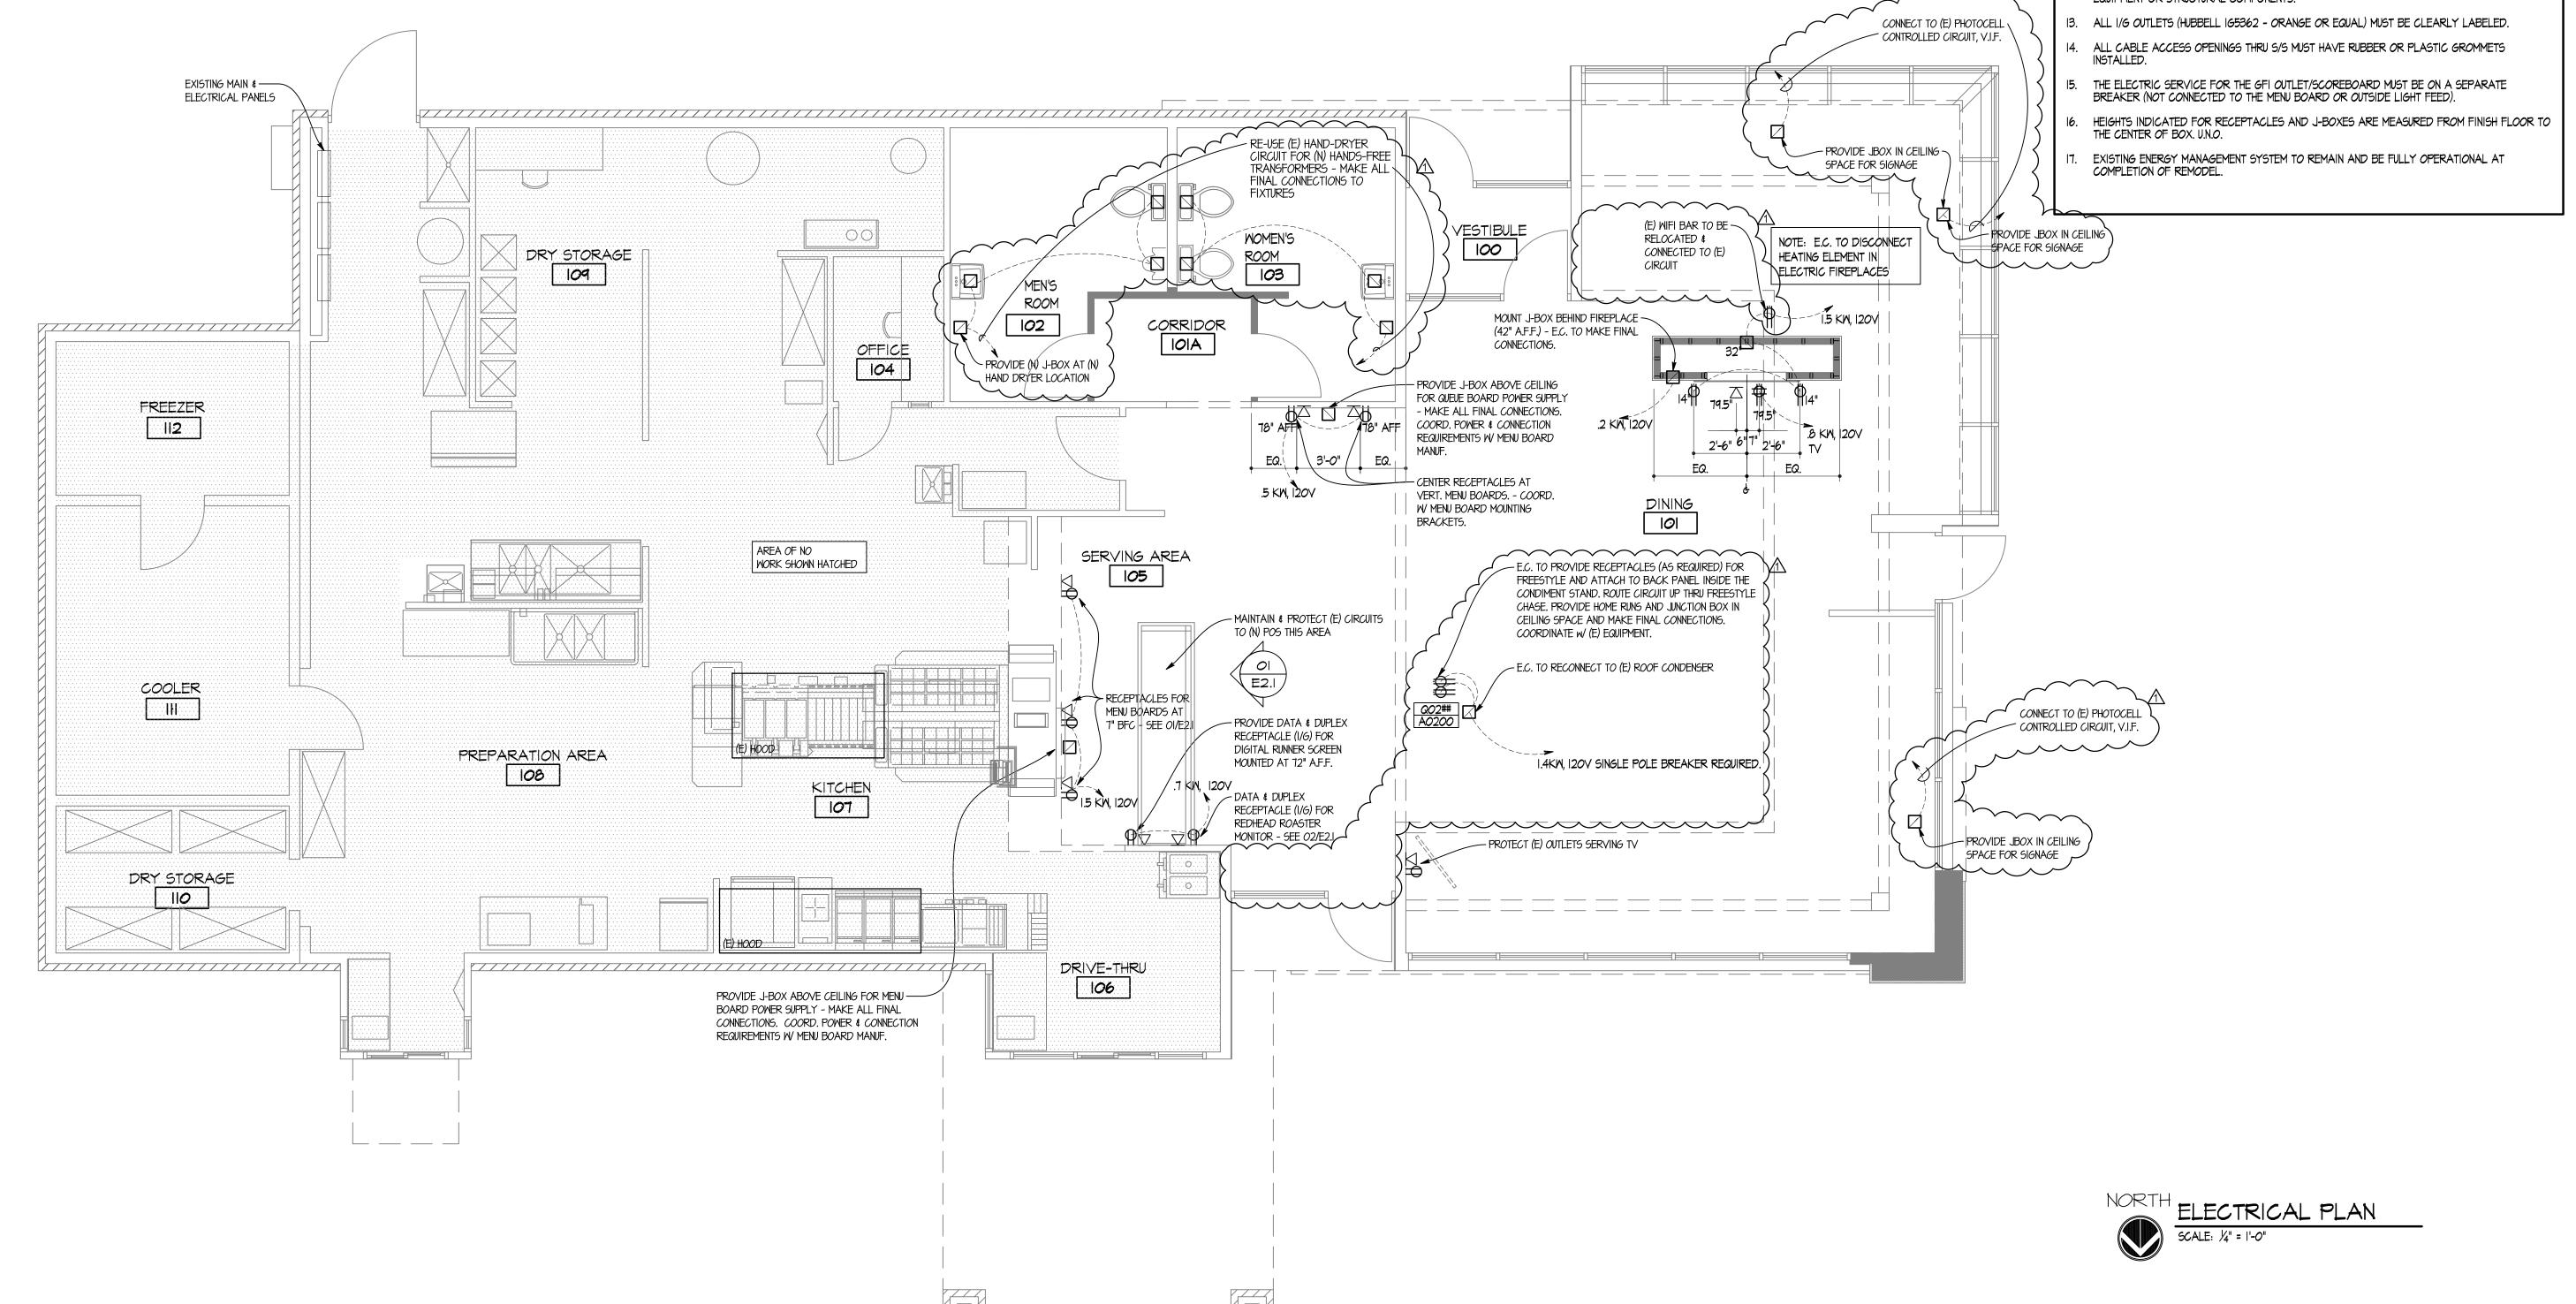GENERAL MORTAR FOR FACE BRICK

FACE BRICK DIVISION 5 - METALS

GENERAL ORNAMENTAL METAL RAILING (OUTSIDE - REQUIRED)

DIVISION 6 - WOOD, PLASTICS, AND COMPOSITES

ROUGH CARPENTRY STRUCTURAL LUMBER FINISH CARPENTRY SOLID SURFACING MATERIAL

BUILDING WRAP/WEATHER BARRIER

DIVISION 7 - THERMAL AND MOISTURE PROTECTION

BUILDING INSULATION INSULATION ATTACHMENT (MECHANICAL) GENERAL ROOFING DELIVERY HANDLING

STORAGE OVERNIGHT COVER ROOFING AND SHEET METAL SURFACE PREPARATION MOOD DECKS

MEMBRANE FLASHING PERIMETER LAPS PROJECT / SITE CLEAN-UP INSPECTIONS

CONTRACTOR QUALIFICATION ASSURANCE METAL TRIMS CORRUGATED METAL PANELS SEALANT

DIVISION 8 - OPENINGS

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E.I.F.S.

ALUMINUM ENTRANCE DOORS AND STOREFRONT GLAZING STEEL SERVICE DOORS AND FRAMES

PREFINISHED DOORS PICK-UP WINDOW

ACCESS PANELS

DIVISION 9 - FINISHES ACM PANELS FLOOR AND WALL TILE INSTALLATION GYPSUM DRYWALL SUSPENDED CEILING SYSTEM WALLCOVERING

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EXTERIOR TRASH ENCLOSURE SIGNAGE ROOM IDENTIFICATION SIGN A.D.A. RESTROOM IDENTIFICATION SIGNSMOKELESS SNUFFER TOILET COMPARTMENTS

PUBLIC RESTROOM ACCESSORIES LADDER RECEIVER WALL DECOR HEIGHT WARNING DEVICE ORDER STATION CANOPY

SMOKELESS SNUFFER STAINLESS STEEL CORNERS

KITCHEN EQUIPMENT HOOD FIRE SUPPRESSION SYSTEM AND PORTABLE FIRE EXTINGUISHERS WALK-IN COOLER/FREEZER/DRY STORAGE

COMMUNICATION SYSTEM DIVISION 22 - PLUMBING

WATER CLOSETS LAVATORY URINALS MOP SINK FIXTURES AND EQUIPMENT

DIVISION 23 - HEATING, VENTILATING & AIR CONDITIONING

DIVISION 26 - ELECTRICAL

DIVISION 31 - EARTHWORK

EXCAVATION, BACK FILLING, GRADING

DIVISION 32 - EXTERIOR IMPROVEMENTS ASPHALT PAVING

CONCRETE PAVING STRIPPING AND PARKING BLOCKS LANDSCAPING

DIVISION 33 - UTILITIES

UTILITIES

CONTRACTOR BID SHEET APPROVED SUPPLIERS LIST

DIVISION 3 - CONCRETE

NOTE: FURNISH LABOR, MATERIALS AND EQUIPMENT NECESSARY TO COMPLETE CONCRETE WORK INCLUDING EXCAVATION, TRENCHING, FORM WORK, REINFORCING, CEMENT FINISH AND PRECAST

SIDEWALKS AND RAMPS

A. 4,000 PSI AIR ENTRAINED CONCRETE, 4" THICK, BROOM FINISH SCORE WITH 3/4" DEEP CONTRACTION JOINTS INTO APPROXIMATELY 4'-O" SQUARES AS SHOWN ON DETAIL ON THE FOUNDATION PLAN.

DIVISION 5 - METALS

NOTE: FURNISH LABOR, MATERIAL, AND EQUIPMENT NECESSARY TO COMPLETE THE MISCELLANEOUS STRUCTURAL AND DECORATIVE METAL WORK INDICATED ON THE DRAWINGS, MATERIALS TO MEET ASTM A-36.

ORNAMENTAL METAL RAILINGS (OUTSIDE - SAFETY RAIL)

A. PROVIDE METAL RAILINGS AS INDICATED ON THE DRAWINGS, RAILINGS SHALL BE COMPLETE WITH POSTS, CAPS, PICKETS, RAILS AND FITTINGS. FINISH AS NOTED ON DRAWINGS.

DIVISION 6 - WOOD, PLASTICS, AND COMPOSITES

FURNISH LABOR, TOOLS, EQUIPMENT AND MATERIALS TO COMPLETE WORK UNDER THIS HEADING AS INDICATED ON THE DRAWINGS AND DESCRIBED IN THE SPECIFICATIONS.

ROUGH CARPENTRY

- A. PROVIDE AND MAINTAIN TEMPORARY ENCLOSURES, AND BARRICADES AS REQUIRED BY GOVERNING LOCAL ORDINANCES.
- PROVIDE TEMPORARY DOOR AND WINDOW ENCLOSURES AS REQUIRED
- D. HEADERS TO BE SIZED AS DETAILED IN THE STRUCTURAL DRAWINGS.

FINISH CARPENTRY

- A. FURNISH LABOR AND MATERIALS TO COMPLETE WORK UNDER THIS SECTION AS INDICATED ON DRAWINGS AND DESCRIBED IN THESE SPECIFICATIONS.
- B. HARDWARE DIMENSIONS ARE TO BE NET SIZE AND NOT NOMINAL SIZE. MATERIAL FOR INTERIOR FINISH SHALL BE AS FOLLOWS:
- I. DINING ROOM TRIM REFER TO FINISH SCHEDULE & DETAILED DRAWINGS.
- 2. COUNTERTOPS TO BE FURNISHED AND INSTALLED BY KITCHEN EQUIPMENT SUPPLIER.

SOLID SURFACING MATERIAL

A. VANITY TOPS AND WINDOW SILLS: DUPONT CORIAN, COLORS AS NOTED ON DRAWINGS. B. PROVIDE IN THICKNESS, FINISH AND EDGE TREATMENT AS REQUIRED AND COORDINATED WITH THE

OWNER'S REPRESENTATIVE.

BUILDING WRAP/WEATHER BARRIER A. ASTM E1677, TYPE 1: DUPONT TYVEK COMMERCIALWRAP.

B. BUILDING-WRAP TAPE: PRESSURE-SENSITIVE PLASTIC TAPE RECOMMENDED BY BUILDING-WRAP MANUFACTURER FOR SEALING JOINTS AND PENTRATIONS IN BUILDING WRAP.

DIVISION 7 - THERMAL AND MOISTURE PROTECTION

BUILDING INSULATION

A. FURNISH LABOR, MATERIALS AND EQUIPMENT NECESSARY TO COMPLETE WORK AS INDICATED ON THE CONSTRUCTION DOCUMENTS AND DESCRIBED IN THE SPECIFICATIONS.

- B. EXTERIOR WALL INSULATION: REFER TO INSULATION SCHEDULE ON DRAWINGS.
- VAPOR BARRIER SHALL BE GRIFFOLYN T-65 BY REEF INDUSTRIES, INC. OR EQUAL. THE MATERIAL SHALL HAVE A 3-PLY, HIGH DENSITY POLYETHYLENE AND NYLON YARN LAMINATE. MATERIAL SHALL HAVE A REINFORCED NON-WOVEN GRID WITH A PPT TEAR STRENGTH OF AT LEAST 15.0 LBS. VAPOR BARRIER SHALL BE APPLIED IN THE WIDEST PRACTICAL WIDTHS. SIDE AND END JOINTS SHALL BE LAPPED AT LEAST 6". LAPS SHALL BE SEALED USING FAB TAPE. PUNCTURES OR TEARS ARE TO BE REPAIRED USING GRIFFOLYN'S GRIFF TAPE, FAB TAPE OR EQUAL. VAPOR BARRIER MUST PROVIDE A COMPLETE SEAL TO PREVENT MOISTURE TRANSFER. NOTE: FOR SOUTHERN COASTAL AREAS, THE VAPOR BARRIER SHOULD BE USED ON THE EXTERIOR OF THE WALL. WHERE THERE IS UNCERTAINTY, FOLLOW LOCAL PRACTICE.
- D. RIGID ROOF INSULATION: FURNISHED AND INSTALLED BY THE ROOFING CONTRACTOR. INSULATION TO BE MINIMUM OF (2) LAYERS OF ROOF MANUFACTURER'S RECOMMENDED INSULATION BOARDS. INSTALL IN THICKNESS REQUIRED TO MEET THE R-VALUES INDICATED IN THE INSULATION SCHEDULE ON DRAWINGS. CONTRACTOR TO PROVIDE BID UTILIZING DURO-GUARD ISO II BOARDS. 'ENRGY 3' INSULATION BOARDS BY JOHNS MANVILLE ARE AN ACCEPTABLE EQUAL.
- E. PERIMETER INSULATION: REFER TO INSULATION SCHEDULE ON DRAWINGS...

FLASHING

- A. FLASHING ON PARAPET WALLS SHALL BE FASTENED 12" ON CENTER ALONG BOTTOM ON MAIN DECK WITH A MINIMUM 6" LAP WELDABLE TO DECK MEMBRANE, COVERING APPROVED FASTENERS. PARAPET WALLS SHALL BE COVERED MINIMUM OF 12" HIGH.
- B. PROVIDE AND INSTALL FLASHING FOR PARAPET WALLS. (FINISH AS NOTED ON EXTERIOR ELEVATIONS AND SCHEDULES.)
- C. FLASH AND COUNTER-FLASH ITEMS THAT PASS THROUGH THE ROOF PROVIDE "PITCH POCKETS" AS REQUIRED TO FORM A COMPLETE JOB.
- D. PROVIDE NECESSARY MOUNTING CLIPS, CLOSURES, FASTENINGS, ETC., REQUIRED TO COMPLETE THE COUNTER-FLASHING, GRAVEL STOPS, CAPS AND COPINGS, INDICATED ON THE DRAWINGS.

PERIMETER LAPS

A. ANY TIME A ROOF EDGE DOES NOT HAVE A PARAPET WALL OR ROOF TIE-IN, (I.E. DRIP EDGE, WATER/GRAVEL STOP, TERMINATION BAR ON EDGE, GUTTER, ETC.) THEN THE ROOF SECTION MUST HAVE A LAP 21" IN FROM THE EDGE AND REVERSED. THIS HELPS REDUCE WIND UP-LIFT AROUND PERIMETERS AND REVERSING THE LAP, ALLOWS CONTRACTOR APPLICATOR TO PLACE ROOF SECTION AWAY FROM THE EDGE.

PROJECT/SITE CLEAN-UP

A. UPON COMPLETION, THE ROOFING CONTRACTOR SHALL REMOVE RUBBISH, WASTE MATERIALS, ETC. FROM THE ROOF, LEAVING THE ROOF IN A CLEAN CONDITION AND FURTHER REMOVING SUCH ROOFING DEBRIS FROM THE WORK SITE. A RIGOROUS INSPECTION FOR WATERTIGHT FIELD SEAMS SHALL BE MADE AFTER COMPLETION OF JOB.

A. UPON COMPLETION OF EACH ROOFING JOB, CONTRACTOR SHALL FILL OUT INSPECTION CARD AND RETURN TO MANUFACTURER. EACH ROOF SHALL BE INSPECTED BY AN AUTHORIZED QUALITY CONTROL FIELD INSPECTOR TO MAKE SURE APPLICATION MEETS MANUFACTURERS SPECIFICATIONS, BEFORE ISSUANCE OF WARRANTY. CONTRACTOR SHALL ACCOMPANY INSPECTOR ON INSPECTIONS AND OBTAIN SIGNED WARRANTY FROM CUSTOMER AND RETURN TO MANUFACTURER, WITH NO FINAL PAYMENT BEING MADE UNTIL AN OWNER'S REPRESENTATIVE HAS WARRANTY.

CONTRACTOR QUALIFICATION ASSURANCE

A. THE ROOFING CONTRACTOR SHALL BE DULY CERTIFIED BY ROOFING MANUFACTURER FOR COMPLETE APPLICATION AND INSTALLATION OF THIS ROOFING SYSTEM. TO MAINTAIN ROOF WARRANTY, FUTURE REPAIRS AND ALTERATIONS SHALL BE MADE BY PERSONNEL DULY CERTIFIED BY ROOFING MANUFACTURER.

METAL TRIMS

A. THIS SECTION INCLUDES METAL TRIM AT PARAPET CAPS, WALL CAPS, BREAK METAL TRIMS, AND THE BOTTOM TRIM ON THE FASCIAS. TRIM MATERIAL SHALL CONSIST OF PREFINISHED (REFER TO FINISH SCHEDULE FOR COLOR), .040" ALUMINUM SHEETS OR 24 GA. GALVALUME STEEL, FORMED TO THE PROFILES SHOWN ON THE DRAWINGS. ATTACHMENT TO THE SUB STRUCTURE SHALL BE BY NON-FERROUS FASTENERS THAT ARE CONCEALED FROM VIEW WHERE POSSIBLE. FASTENERS NOT CONCEALED FROM VIEW MUST MATCH THE COLOR OF THE TRIM BEING FASTENED.

CORRUGATED METAL PANEL SYSTEM

- A. MANUFACTURER: ALCOA ARCHITECTURAL PRODUCTS, 50 INDUSTRIAL BLVD., EASTMAN, GA 31023.
- I. SYSTEM: 7.2" RIB PANEL.
- B. DESIGN REQUIREMENTS: I. CONTINUOUS, ONE-PIECE, PREFORMED, PREFINISHED SINGLE LENGTH METAL WALL PANELS WITH
- EXPANSION JOINTS AT 20'-0" INTERVALS. 2. PANELS, FASTENERS AND OTHER COMPONENTS REQUIRED FOR SPECIFIC PROJECT CONDITIONS.
- 3. EXPOSED ADJACENT FLASHING SHALL BE OF THE SAME MATERIAL AND FINISH AS THE PANELS.
- 4. SEALANT PER MANUFACTURER'S WRITTEN SPECIFICATIONS.
- C. SHEET MATERIALS: PREFINISHED BASE SHEET MATERIAL SHALL BE 7.2" RIB PANEL, 20 GAUGE
- 2. FINISH COLOR SHALL BE CLASSIC BRONZE. UNLESS NOTED OTHERWISE, PRODUCTS SHALL BE OF

REQUIREMENTS OUTLINED IN THE MANUFACTURER'S WRITTEN SPECIFICATIONS.

THE SAME FINISH AND COLOR. D. FABRICATION:

I. FABRICATE METAL WALL PANELS AND RELATED SHEET METAL WORK IN ACCORDANCE WITH

UNLESS NOTED OTHERWISE. E. EXECUTION: I. G.C. IS RESPONSIBLE FOR ALL INSPECTION, INSTALLATION, FIELD QUALITY CONTROL AND CLEANING

APPLICABLE STANDARDS SET FORTH IN THE SMACNA ARCHITECTURAL SHEET METAL MANUAL

2. WALL PANELS AND SHEET METAL FLASHING SHALL BE FABRICATED IN MINIMUM 10'-0" LENGTHS

- SEALANT A. SURFACES TO RECEIVE SEALANT ARE TO BE DRY AND THOROUGHLY CLEANED OF LOOSE PARTICLES OF DIRT AND DUST, OIL, GREASE, OR OTHER FOREIGN MATTER.
- B. SEAL AT EXTERIOR DOOR FRAMES, WINDOW FRAMES, AND OPENINGS FOR PLUMBING, ELECTRICAL REFRIGERANT AND GAS LINES IN EXTERIOR WALLS, FLOORS AND ROOFS.

- SEALANT MATERIALS A. JOINT LOCATIONS AND JOINT SEALANT TYPES ARE NOTED ON DRAWINGS. ACCEPTABLE
- MANUFACTURER/TYPE PER EACH JOINT TREATMENT TYPE IS AS FOLLOWS: B. JS-I SINGLE COMPONENT SILICONE
- 1. DOW CORNING 791
- 2. GE SILICONES SILPURFLM SCS2700 3. PECORA 865
- C. JS-2 SINGLE COMPONENT SILICONE

2. GE SILICONES SILPURFLM SCS2700

- 1. DOW CORNING 791
- 3. PECORA 865
- D. JS-3 SINGLE COMPONENT SILICONE I. DOW CORNING 890-SL
- 2. PECORA 300 PAVEMENT SEALANT (NONSAG) E. JS-4 SINGLE COMPONENT SILICONE
- I. DOW CORNING 890-SL
- 2. PECORA 300 PAVEMENT SEALANT (NONSAG) F. JS-5 SINGLE COMPONENT SILICONE
- DOW CORNING 786 MILDEM RESISTANT 2. GE SILICONES SANITARY SCSITOO
- 3. PECORA 860

A. PROVIDE ADMINISTRATION, FACILITIES, EQUIPMENT, LABOR AND MATERIALS REQUIRED TO FURNISH AND INSTALL EXTERIOR INSULATION AND FINISH SYSTEM (EIFS) AND DIRECT EXTERIOR FINISH SYSTEM

- (DEFS) PRODUCTS AS SHOWN ON THE DRAWINGS AND SPECIFIED BELOW. RELATED WORK: MASONRY (DIVISION 4), SHEATHING AND WEATHER BARRIER (DIVISION 6) SHEET
- METAL & CAULKING (DIVISION 7). DELIVERY, STORAGE AND HANDLING: DELIVERED MANUFACTURED PLASTERING PRODUCTS TO JOB
- SITE IN ORIGINAL, UNOPENED PACKAGES, CONTAINERS OR BUNDLES BEARING MANUFACTURER'S NAME BRAND, TYPE AND GRADE. KEEP MATERIALS DRY UNTIL USED. STORE UNDER COVER AND OFF THE
- GROUND. PROTECT METAL FROM RUSTING AND DAMAGE. MARRANTY: EIFS MANUFACTURER IS PROVIDING OWNER WITH WARRENTY OF MATERIAL AND COLOR FADE. TO ENSURE WARRENTY IS ENFORCEABLE, CONTRACTOR MUST COMPLY WITH "EFIS GENERAL
- CONTRACTOR" BELOW: . CONTRACTOR REQUIREMENTS FOR EIFS (STOTHERM ESSENCE NEXT):
- a. ENGAGED IN APPLICATION OF EIFS FOR A MINIMUM OF THREE (3) YEARS. b. KNOWLEDGEABLE IN THE PROPER USE AND HANDLING OF STO MATERIALS
- c. EMPLOY SKILLED MECHANICS WHO ARE EXPERIENCED AND KNOWLEDGEABLE IN FLUID-APPLIED AIR / MOISTURE BARRIERS AND EIFS APPLICATION, AND FAMILIAR WITH THE
- REQUIREMENTS OF THE SPECIFIED WORK d. SUCCESSFUL COMPLETION OF MINIMUM OF THREE (3) PROJECTS OF SIMILAR SIZE AND COMPLEXITY TO THE SPECIFIED PROJECT.
- e. PROVIDE THE PROPER EQUIPMENT, MANPOWER AND SUPERVISION ON THE JOB SITE TO INSTALL THE SYSTEM IN COMPLIANCE WITH STO'S PUBLISHED SPECIFICATIONS AND DETAILS AND THE PROJECT PLANS AND SPECIFICATIONS.
- 2. CONTRACTOR REQUIREMENTS FOR ACRYLIC COATING (STOCOAT ACRYL PLUS): a. THE CONTRACTOR SHALL BE QUALIFIED TO PERFORM THE WORK SPECIFIED BY REASON OF
- EXPERIENCE. 3. EIFS CONTRACTOR MUST OBTAIN STOTHERM ESSENCE NEXT SYSTEM WARRANTY BY REQUESTING THE
- WARRANTY FROM THE STO DISTRIBUTOR WHERE MATERIAL WAS PURCHASED*. 4. COATING / PAINTING CONTRACTOR MUST OBTAIN STOCOAT ACRYL PLUS WARRANTY BY REQUESTING
- THE WARRANTY FROM THE STO DISTRIBUTOR WHERE MATERIAL WAS PURCHASED*. *IF EIFS CONTRACTOR ALSO APPLIES THE STO COATING, THEY CAN OBTAIN ONE WARRANTY THAT WILL INCLUDE BOTH; THE STOTHERM ESSENCE NEXT & STOCOAT ACRYL PLUS COATING WARRANTY.
- 5. CONTRACTORS SHALL FOLLOW STO SPECIFICATIONS FOR THE INSTALLATION OF THE EIFS AND COATING MATERIALS. ANY DEVIATIONS BETWEEN STO SPECIFICATIONS AND THE CONTRACT DOCUMENTS SHALL BE BROUGHT TO THE ATTENTION OF THE GENERAL CONTRACTOR FOR FURTHER DIRECTION. THE EIFS / COATINGS CONTRACTORS SHALL BE RESPONSIBLE FOR ANY WORKMANSHIP
- 6. STO SHALL NOT HAVE ANY OBLIGATION UNDER THIS WARRANTY UNLESS THE OWNER NOTIFIES STO IN WRITING AT 3800 CAMP CREEK PKWY, BUILDING 1400, SUITE 120, ATLANTA, GEORGIA 30331, ATTN: WARRANTY SERVICES, WITHIN 30 DAYS OF THE DISCOVERY OF ALLEGED DEFECTS. STO CORP. SHALL BE ALLOWED A REASONABLE PERIOD OF TIME TO INVESTIGATE THE ALLEGED DEFECT, INCLUDING REMOVAL OF SAMPLES, AND TO PERFORM ANY TESTING DEEMED NECESSARY TO DETERMINE THE CAUSES OF THE ALLEGED DEFECT. THE OWNER SHALL PROVIDE AND CAUSE ANY TEMPORARY REPAIRS TO BE ACCOMPLISHED IN A TIMELY MANNER TO PREVENT FURTHER DAMAGE TO THE STRUCTURE OR CONTENTS OF THE BUILDING UNTIL THE CAUSE OF THE DEFECT IS DETERMINED AND A REPAIR IS IMPLEMENTED.
- 7. CONTACTS FOR STO:
- a. STO TECHNICAL SERVICES: I-800-221-2397
- b. STO STRATEGIC ACCOUNTS: 1-888-786-3437
- BASIS OF DESIGN AND SPECIFICATION: STO CORPORATION "STOTHERM ESSENCE NEXT". ACCEPTABLE ALTERNATE: DRYVIT SYSTEMS, INC. - "OUTSULATION PLUS MD". PROVIDE MATERIALS,
- COMPONENTS AND INSTALLATION BY DRYVIT COMPARABLE TO THOSE LISTED IN THIS SECTION. TEXTURE: TROWEL APPLY STO FINE SAND FINISH TOP-COATED PER FINISH SCHEDULE, OVER HIGH-IMPACT @ARMOR MAT REINFORCING MESH WITH STO 4.5 OZ. MESH TO 6'-9" ABOVE GRADE,
- STO 4.5 OZ. MESH ABOVE 6'-9". ALTERNATE: DRYVIT INTEGRAL COLORED "WENDO51022", "SANDPEBBLE FINE" FINISH, "DEMANDIT" TOP COAT PER FINISH SCHEDULE, OVER "PANZER 15 OZ." HIGH-IMPACT MESH TO
- 6'-9" MIN.; AND, "STANDARD 4.3 OZ." REINFORCING MESH ABOVE 6'-9". MATERIALS:
- GENERAL: PROVIDE STANDARD PRODUCTS RECOMMENDED BY THE MANUFACTURER FOR THE
- APPLICATION INDICATED. 2. WATER: POTABLE AND FREE FROM IMPURITIES THAT AFFECT STUCCO.
- 3. PORTLAND CEMENT: ASTM CI50, TYPE I; GRAY FOR BASE COAT.
- 4. AIR/WATER-RESISTIVE BARRIER COMPONENTS:
- ALTERNATE: DRYVIT "BACKSTOP NT" SERIES. b. STO GOLD FILL AND STOGUARD MESH FOR JOINT TREATMENT AND STO GOLD COAT WATERPROOF COATING. (NOTE: STOGUARD FABRIC STORAPID FILL MAY BE USED IN LIEU OF
- GOLD FILL / STOGUARD MESH FOR JOINT TREATMENT. ALTERNATE: DRYVIT "BACKSTOP NT - TEXTURE"; AND; GRID TAPE5.

a. ST*OG*UARD.

- 5. FLASHING MATERIALS:
- a. LIQUID APPLIED: STO GOLD FILL AND STOGUARD MESH. ALTERNATE: DRYVIT "AQUAFLASH AND AQUAFLASH MESH".
- b. SHEET TYPE FLASHING TAPE AND SURFACE CONDITIONER:
- ALTERNATE: DRYVIT "FLASHING TAPE" AND "FLASHING TAPE SURFACE
- 7. STARTER TRACK: RIGID PVC PLASTIC TRACK PART NO. STDE BY PLASTIC COMPONENTS, INC. OR

6. ADHESIVE: STO PRIMER ADHESIVE OR STO PRIMER ADHESIVE B. ALTERNATE: DRYVIT "PRIMUS"

- INSULATION BOARD (EPS BOARD): ASTM C 578 TYPE I. 3/4" MINIMUM THICKNESS AT BASE OF REVEALS. I. DIMENSIONAL TOLERANCES SHALL BE AS FOLLOWS:
- a. EDGES SHALL BE SQUARE WITHIN 1/16" OVER THE ENTIRE LENGTH OF THE BOARD.
- b. THICKNESS SHALL BE PLUS OR MINUS 1/16". 2. THICKNESS SHALL BE AS INDICATED ON DRAWINGS.
- 3. MAXIMUM SIZE OF EPS BOARD SHALL NOT EXCEED 2'X 4'. BASE COAT COMPATIBLE WITH EPS INSULATION BOARD AND REINFORCING MESHES. STO PRIMER
- ADHESIVE OR STO PRIMER ADHESIVE B. ALTERNATE: DRYVIT "PRIMUS" SERIES.

PREPARATION

- REINFORCING MESH: BALANCED, OPEN MEAVE, GLASS FIBER FABRIC TREATED FOR COMPATIBILITY WITH OTHER SYSTEM MATERIALS.
- I. STO 15.0 OZ. ARMOR MAT MESH FOR AREAS BELOW 6'-9" ABOVE GRADE, INCLUDING STO 4.5 OZ. ALTERNATE: DRYVIT "PANZER 15 OZ." HIGH-IMPACT MESH TO 6'-9" MIN.; AND, "STANDARD 4.3 OZ."
- REINFORCING MESH. 2. STANDARD, DETAIL AND CORNER MESH ELSEWHERE AS REQUIRED.
- APPLICATION OF THE SPECIFIED PRODUCTS SHALL BE BY AN EXPERIENCED EIFS CONTRACTOR WHO CAN DEMONSTRATE THE FOLLOWING:
- a. ENGAGED IN APPLICATION OF EIFS FOR A MINIMUM OF (3) THREE YEARS. b. KNOWLEDGEABLE IN THE PROPER ISE AND HANDLING OF STO MATERIALS AND LISTED BY STO
- / DRYVIT AS HAVING ATTENDED STO / DRYVIT EIFS CONTINUING EDUCATION. c. EMPLOY SKILLED MECHANICS WHO ARE EXPERIENCED AND KNOWLEDGEABLE IN EIFS APPLICATION, AND ARE FAMILIAR WITH THE REQUIREMENTS OF THE SPECIFIED WORK.
- d. SUCCESSFUL COMPLETION OF MINIMUM OF (3) THREE PROJECTS OF SIMILAR SIZE AND COMPLEXITY TO THE SPECIFIED PROJECT.
- e. PROVIDE A PROPER EQUIPMENT, MANPOWER AND SUPERVISION ON THE JOB SITE TO INSTALL THE SYSTEM IN COMPLIANCE WITH STO'S PUBLISHED SPECIFICATION AND DETAILS AND THE PROJECT PLANS AND SPECIFICATION.
- 2. FOLLOW MANUFACTURER'S LATEST PRINTED APPLICATION INSTRUCTIONS.

- 3. ALL FEDERAL, LOCAL AND/OR STATE CODE AND ORDINANCES SHALL GOVERN WHEN THEIR REQUIREMENTS ARE IN EXCESS OF THOSE NOTED IN THIS SECTION.
- 4. SUBMIT MANUFACTURER'S STANDARD PRINTED INSTRUCTION FOR INSTALLATION OF THE SYSTEM.
- 5. ONE 4'-O" X 4'-O" MOCKUP FOR EACH SUBSTRATE AND MESH TYPE SHALL BE CONSTRUCTED ON SITE BY EFIS CONTRACTOR, INDICATING SIZE, THICKNESS AND TEXTURE FOR OWNER AND ARCHITECT'S APPROVAL. INSTALLATION SHALL NOT PROCEED UNTIL WRITTEN APPROVAL OF MOCKUP IS RECEIVED.
- 6. MANUFACTURERS STANDARD WARRANTY FOR LIMITED MATERIALS DEFECT AND LABOR TO REPALCE DEFECTIVE MATERIALS.

- AFTER SATISFACTORY INSPECTION OF SURFACES AND CORRECTION OF ANY DEVIATIONS FROM SPECIFICATION REQUIREMENTS, THE EIFS INSTALLATION MAY BEGIN. A STARTER STRIP OF MESH SHALL BE APPLIED TO THE WALL AT THE BASE LINE WITH ADHESIVE PRIOR TO THE INSTALLATION OF THE INSULATION BOARD.
- 2. THE STARTER STRIP OF MESH IS USED TO SEAL/PROTECT THE BOTTOM OF THE FIRST COURSE OF INSULATION BOARD. IT SHALL BE WIDE ENOUGH TO ADHERE 2-1/2" MIN. OF MESH ONTO THE WALL BE ABLE TO WRAP AROUND THE BOARD EDGE AND COVER 2-1/2" MIN. ON THE OUTSIDE FACE SURFACE OF THE BOARD. THIS "BACKWRAP" PROCEDURE SHALL BE FOLLOWED AT ALL EXPOSED BOARD EDGES.
- 3. APPLY THE ADHESIVE TO THE BACK OF THE INSULATION BOARD WITH PROPER SIZE NOTCHED TROWEL. RIBBONS OF ADHESIVE SHALL BE UNIFORM AND RUN VERTICAL IN RELATION TO THE
- 4. THE INSULATION BOARDS ARE IMMEDIATELY PLACED HORIZONTALLY ON THE WALLS STARTING FROM A LEVEL BASE LINE. STAGGER VERTICAL JOINTS AND INTERLOCK BOARDS AT ALL INSIDE AND OUTSIDE CORNERS. APPLY FIRM PRESSURE OVER ENTIRE STRENGTH OF THE BOARDS TO INSURE UNIFORM CONTACT. BOARDS SHALL BRIDGE SHEATHING JOINTS BY A MINIMUM OF 8". AL. BOARD JOINTS SHALL BE BUTTED TIGHTLY TOGETHER TO ELIMINATE ANY THERMAL BREAKS IN THE EIFS. CARE MUST BE TAKEN TO PREVENT ANY ADHESIVE FROM GETTING BETWEEN THE JOINTS OF THE BOARDS. ALL OPEN JOINTS IN THE INSULATION BOARD LAYER SHALL BE FILLED WITH SLIVERS ' OF INSULATION BOARD OR AN APPROVED SPRAY FOAM.
- 5. NAILS, SCREWS, OR ANY OTHER NON-THERMAL MECHANICAL FASTENER SHALL NOT BE USED
- 6. ALL AREAS WHERE THE EIFS MEETS DISSIMILAR MATERIAL OR TERMINATES THE INSULATION BOARD, CUT BACK FROM THE ADJOINING MATERIAL A MINIMUM OF 3/4" TO FORM AN EXPANSION JOINT AND ALL BOARD EDGES SHALL BE COATED WITH APPROPRIATE GROUND COAT AND MESH II ACCORDANCE WITH STANDARD "BACKWRAPPING" PROCEDURE. APPROPRIATE SEALANT/PRIMER AND BACKER SHALL BE INSTALLED AFTER GROUND COAT IS FULLY DRY TO PREVENT ANY WATER FROM GETTING INTO OR BEHIND THE SYSTEM. NOTE: MIN. 1/2" JOINT AT WINDOWS, DOORS AND OTHER PENETRATIONS; MIN. 3/4" AT EXPANSION JOINTS.
- 7. EXPANSION JOINTS ARE REQUIRED IN THE EIFS WHERE THEY EXIST IN THE SUBSTRATE AND WHERE THE EIFS ADJOINS DISSIMILAR CONSTRUCTION. THE EIFS SHALL TERMINATE AT THE EXPANSION JOINT TO PROVIDE APPROPRIATE JOINT SIZE AND ALL BOARD EDGES SHALL BE COATED WITH APPROPRIATE GROUND COAT AND MESH IN ACCORDANCE WITH STANDARD "BACKWRAPPING" PROCEDURE. APPROPRIATE SEALANT/PRIMER AND BACKER SHALL BE INSTALLED AFTER GROUND COAT IS FULLY DRY TO PREVENT ANY WATER FROM GETTING INTO OR BEHIND THE SYSTEM.
- 8. USE OF PLASTIC OR METAL CORNER BEADS, STOPBEADS, ETC., IS NOT PERMITTED AT EIFS. PVC STARTER TRACK IS ACCEPTABLE.

9. AFTER INSULATION BOARDS ARE FIRMLY ADHERED, THE SURFACE SHALL BE RASPED TO ACHIEVE

- A SMOOTH, EVEN SURFACE AND TO REMOVE ANY ULTRAVIOLET RAY DAMAGE. 10. AT HIGH IMPACT AREAS INSTALL HIGH IMPACT MESH. APPLY GROUND COAT WITH PROPER SPRAY EQUIPMENT OR A STAINLESS STEEL TROWEL TO A UNIFORM THICKNESS OF APPROXIMATELY 1/8". WORK HORIZONTALLY OR VERTICALLY IN STRIPS OF 40" AND IMMEDIATELY EMMBED THE HIGH IMPACT MESH INTO THE WET GROUND COAT AND FEATHER OUT SEAMS AND EDGES. THE HIGH IMPACT MESH SHALL BE TIGHTLY BUTTED WITH GAPS NOT GREATER THAN 1/8" AT SEAMS. THE FINISHED THICKNESS OF THE GROUND COAT SHALL BE SUCH THAT THE HIGH IMPACT MESH IS FULLY EMMBEDDED. ALLOW THE APPLICATION TO DRY BEFORE APPLYING STANDARD REINFORCING MES
- TO ENTIRE AREA WITH APPROPRIATE GROUND COAT. II. AT STANDARD MESH AREAS, APPLY APPROPRIATE GROUND COAT OVER THE INSULATION BOARD, INCLUDING AREAS WITH HIGH IMPACT MESH, WITH PROPER SPRAY EQUIPMENT OR A STAINLESS STEEL TROWEL TO A UNIFORM THICKNESS OF APPROXIMATELY I/I6". WORK HORIZONTALLY OR VERTICALLY IN STRIPS OF 40", AND IMMEDIATELY EMMBED STANDARD REINFORCING MESH INTO THE WET GROUND COAT. THE MESH SHALL BE DOUBLE WRAPPED AT ALL CORNERS AND OVERLAPPED NOT LESS THAN 2-1/2" AT MESH JOINTS. AVOID WRINKLES IN THE MESH. THE FINISH THICKNESS OF THE GROUND COAT SHALL BE SUCH THAT THE MESH IS FULLY EMMBEDDED. ALLOW GROUND COAT TO THOROUGHLY DRY BEFORE APPLYING PRIMER OR FINISH.

SITE NUMBER: BASE MODEL: CONVERSION ASSET TYPE: FRANCHISE CLASSIFICATION: REFRESH JARO FOODS

BASE VERSION: 2016 JAN 05 **UPGRADE CLASSIFICATION:**

STANDARD PROJECT YEAR: 2016 FURNITURE PACKAGE:

Wallin • Gomez Architects, Ltd

DESIGN BULLETINS:

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DESCRIPTION 01-08-16 ISSUED FOR PERMIT & BID ↑ 01-19-16 OWNER REVISIONS

PROJECT NUMBER 15130 DRAWN BY CL/KH CHECKED BY DJW NOTICE: THIS DOCUMENT CONTAIN PROPRIETARY INFORMATION. IT SHALL NOT

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PLOT DATE 1/19/2016


GOMEZ ARCHITECTS, LTD. THESE DRAWINGS HAVE BEEN PREPARED AT AND / OR UNDER MY SUPERVISION AND TO THE BEST OF MY KNOWLEDGE AND BELIEF CONFORM AND COMPLY WITH THE REQUIREMENTS OF THE DEPARTMENT OF BUILDING AND CODES HAVING JURISDICTION.

STATE OF INDIANA

REGISTERED ARCHITECT

DONALD J. WALLIN

AR19500067

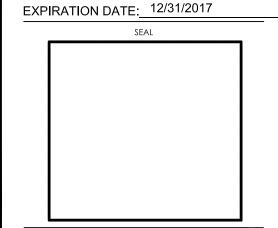

SPECIFICATIONS

DIVISION 8 - OPENINGS

ALUMINUM ENTRANCE DOORS, STOREFRONT DOORS AND WINDOWS SHALL HAVE PRODUCT LABELS INDICATING U-VALUE, SHGC AND AIR LEAKAGE RATE IN COMPLIANCE WITH LATEST ENERGY CODES. ALLOWED AIR LEAKAGE SHALL NOT EXCEED I.O CFM/FT2 FOR GLAZED DOORS AND 0.3 CFM/FT2 FOR WINDOWS.

A. SYSTEMS: REFER TO EXTERIOR MATERIALS AND FINISHES SCHEDULE ON DRAWINGS.

- B. DOORS SHALL BE "350 MEDIUM STILE" DOOR, MANUFACTURED BY US ALUMINUM.
- C. HARDWARE FOR ENTRANCE DOORS: SEE HARDWARE SCHEDULE ON DRAWINGS.
- D. EXPOSED ALUMINUM MATERIAL SHALL BE KAWNEER #40 DARK BRONZE, OR US ALUMINUM DARK BRONZE OR OLD CASTLE DARK BRONZE. HARDWARE SHALL MATCH.
- E. MISCELLANEOUS TRIMS, SHAPES, SPACERS, AND ADAPTERS AS REQUIRED.

A. EXTERIOR GLASS SHALL BE I" INSULATED (UNLESS NOTED OTHERWISE) WITH U-VALUE AND SHGC AS NOTED ON EXTERIOR ELEVATIONS. SEE THE FINISH SCHEDULE FOR COLOR. GLAZING MUST MEET SAFETY CODES AS REQUIRED. GLASS MUST HAVE 5-YEAR WARRANTY AGAINST SEAL FAILURE. . GLASS THICKNESSES: SELECT MIN. GLASS THICKNESSES PER ASTM E 1300, PER FOLLOWING

a. SPECIFIED DESIGN WIND LOADS: DESIGN WIND LOADS APPLICABLE TO PROJECT FROM BASIC WIND SPEED - IN MILES PER HOUR (METERS PER SECOND) AT 33 FEET (IO M) ABOVE GRADE, ACCORDING TO ASCE 7, "MINIMUM DESIGN LOADS FOR BUILDINGS AND OTHER STRUCTURES"

SECTION 6.4.2, "ANALYTIC PROCEDURE," BASED ON MEAN ROOF HEIGHTS ABOVE GRADE INDICATED ON DRAWINGS. b. PROBABILITY OF BREAKAGE FOR VERTICAL GLAZING: 8 LITES PER 1000 FOR LITES SET VERTICALLY OR NOT MORE THAN 15 DEGREES OFF VERTICAL AND UNDER WIND ACTION.

I) LOAD DURATION: 60 SECONDS OR LESS

c. MINIMUM GLASS THICKNESS FOR EXTERIOR LITES: NOT LESS THAN 6 MM. d. THICKNESS OF TINTED AND HEAT-ABSORBING GLASS:

I) PROVIDE THE SAME THICKNESS FOR EACH TINT COLOR INDICATED THROUGHOUT PROJECT B. PRODUCTS AND MANUFACTURERS

AVAILABLE PRODUCTS: SUBJECT TO COMPLIANCE WITH REQUIREMENTS, PRODUCTS THAT MAY BE INCORPORATED INTO THE WORK INCLUDE, BUT ARE NOT LIMITED TO, THE PRODUCTS INDICATED IN SCHEDULES ON THE DRAWINGS.

C. PRIMARY FLOAT GLASS ASTM C 1036, TYPE I (TRANSPARENT GLASS, FLAT), QUALITY Q3 (GLAZING SELECT); CLASS I

D. HEAT-TREATED FLOAT GLASS

ASTM C 1048; TYPE I (TRANSPARENT GLASS, FLAT); QUALITY Q3 (GLAZING SELECT); CLASS, KIND, AND CONDITION AS INDICATED.

E. INSULATING GLASS

PREASSEMBLED UNITS CONSISTING OF SEALED LITES OF GLASS SEPARATED BY A DEHYDRATED INTERSPACE, AND COMPLYING WITH ASTM E 774 FOR CLASS CBA UNITS AND WITH REQUIREMENTS SPECIFIED IN THIS ARTICLE.

a. PROVIDE KIND HS (HEAT-STRENGTHENED) FLOAT GLASS IN PLACE OF ANNEALED GLASS WHERE NEEDED TO RESIST THERMAL STRESSES INDUCED BY DIFFERENTIAL SHADING OF INDIVIDUAL GLASS LITES AND TO COMPLY WITH GLASS DESIGN REQUIREMENTS SPECIFIED IN "PERFORMANCE REQUIREMENTS" ARTICLE. PROVIDE KIND FT (FULLY TEMPERED) WHERE SAFETY

GLASS IS INDICATED. 2. OVERALL UNIT THICKNESS AND THICKNESS OF EACH LITE: DIMENSIONS INDICATED IN THE GLASS SCHEDULE ARE NOMINAL AND THE OVERALL THICKNESSES OF UNITS MEASURED PERPENDICULARLY FROM OUTER SURFACES OF GLASS LITES AT UNIT'S EDGE.

3. SEALING SYSTEM: DUAL SEAL, WITH PRIMARY AND SECONDARY SEALANTS AS FOLLOWS: a. RETAIN ONE SEALANT SYSTEM BELOW OR REVISE TO INSERT OTHER COMBINATIONS;

CORRELATE WITH PRODUCTS/MANUFACTURERS SELECTED. I) MANUFACTURER'S STANDARD SEALANTS.

4. SPACER SPECIFICATIONS: MANUFACTURER'S STANDARD SPACER MATERIAL AND CONSTRUCTION

COMPLYING WITH THE FOLLOWING REQUIREMENTS: a. ALUMINUM WITH DARK BRONZE COLOR-ANODIZED FINISH.

b. DESICCANT: MOLECULAR SIEVE OR SILICA GEL, OR BLEND OF BOTH.

c. CORNER CONSTRUCTION: MANUFACTURER'S STANDARD CORNER CONSTRUCTION. 5. LOWE - SPUTTER-COATED FLOAT GLASS; ASTM C1376 APPLIED TO SURFACE $\sharp 2.$

F. MISCELLANEOUS GLAZING MATERIALS

GENERAL: PROVIDE PRODUCTS OF MATERIAL, SIZE, AND SHAPE COMPLYING WITH REFERENCED GLAZING STANDARD, REQUIREMENTS OF MANUFACTURERS OF GLASS AND OTHER GLAZING MATERIALS FOR APPLICATION INDICATED, AND WITH A PROVEN RECORD OF COMPATIBILITY WITH SURFACES CONTACTED IN INSTALLATION.

2. CLEANERS, PRIMERS, AND SEALERS: TYPES RECOMMENDED BY SEALANT OR GASKET MANUFACTURER.

3. SETTING BLOCKS: ELASTOMERIC MATERIAL WITH A SHORE TYPE A DUROMETER HARDNESS OF 85,

4. SPACERS: ELASTOMERIC BLOCKS OR CONTINUOUS EXTRUSIONS WITH A SHORE TYPE A DUROMETER HARDNESS REQUIRED BY GLASS MANUFACTURER TO MAINTAIN GLASS LITES IN PLACE FOR INSTALLATION INDICATED.

5. EDGE BLOCKS: ELASTOMERIC MATERIAL OF HARDNESS NEEDED TO LIMIT GLASS LATERAL MOVEMENT (SIDE WALKING).

H. FABRICATION OF GLASS AND OTHER GLAZING PRODUCTS

FABRICATE GLASS AND OTHER GLAZING PRODUCTS IN SIZES REQUIRED TO GLAZE OPENINGS INDICATED FOR PROJECT, WITH EDGE AND FACE CLEARANCES, EDGE AND SURFACE CONDITIONS, AND BITE COMPLYING WITH MRITTEN INSTRUCTIONS OF PRODUCT MANUFACTURER AND REFERENCED GLAZING STANDARD, TO COMPLY WITH SYSTEM PERFORMANCE REQUIREMENTS.

2. GRIND SMOOTH AND POLISH EXPOSED GLASS EDGES. EXAMINATI*O*N

EXAMINE FRAMING GLAZING, WITH INSTALLER PRESENT, FOR COMPLIANCE WITH THE FOLLOWING: a. MANUFACTURING AND INSTALLATION TOLERANCES, INCLUDING THOSE FOR SIZE, SQUARENESS,

AND OFFSETS AT CORNERS. b. PRESENCE AND FUNCTIONING OF WEEP SYSTEM.

c. MINIMUM REQUIRED FACE OR EDGE CLEARANCES.

d. EFFECTIVE SEALING BETWEEN JOINTS OF GLASS-FRAMING MEMBERS.

. PROCEED WITH INSTALLATION ONLY AFTER UNSATISFACTORY CONDITIONS HAVE BEEN CORRECTED. . PREPARATION

CLEAN GLAZING CHANNELS AND OTHER FRAMING MEMBERS RECEIVING GLASS IMMEDIATELY BEFORE GLAZING. REMOVE COATINGS NOT FIRMLY BONDED TO SUBSTRATES. K. GLAZING, GENERAL

COMPLY WITH COMBINED WRITTEN INSTRUCTIONS OF MANUFACTURERS OF GLASS, SEALANTS, GASKETS, AND OTHER GLAZING MATERIALS, UNLESS MORE STRINGENT REQUIREMENTS ARE INDICATED, INCLUDING THOSE IN REFERENCED GLAZING PUBLICATIONS.

2. GLAZING CHANNEL DIMENSIONS, AS INDICATED ON DRAWINGS, PROVIDE NECESSARY BITE ON GLASS, MINIMUM EDGE AND FACE CLEARANCES, AND ADEQUATE SEALANT THICKNESSES, WITH REASONABLE TOLERANCES. ADJUST AS REQUIRED BY PROJECT CONDITIONS DURING INSTALLATION.

PROTECT GLASS EDGES FROM DAMAGE DURING HANDLING AND INSTALLATION. REMOVE DAMAGED GLASS FROM PROJECT SITE AND LEGALLY DISPOSE OF OFF PROJECT SITE. DAMAGED GLASS IS GLASS WITH EDGE DAMAGE OR OTHER IMPERFECTIONS THAT, WHEN INSTALLED, COULD WEAKEN GLASS AND IMPAIR PERFORMANCE AND APPEARANCE.

4. APPLY PRIMERS TO JOINT SURFACES WHERE REQUIRED FOR ADHESION OF SEALANTS, AS DETERMINED BY PRECONSTRUCTION SEALANT-SUBSTRATE TESTING.

INSTALL SETTING BLOCKS IN SILL RABBETS, SIZED AND LOCATED TO COMPLY WITH REFERENCED GLAZING PUBLICATIONS, UNLESS OTHERWISE REQUIRED BY GLASS MANUFACTURER. SET BLOCKS IN THIN COURSE OF COMPATIBLE SEALANT SUITABLE FOR HEEL BEAD.

6. DO NOT EXCEED EDGE PRESSURES PER GLASS MANUFACTURERS FOR INSTALLING GLASS LITES. a. PROVIDE SPACERS FOR GLASS LITES WHERE THE LENGTH PLUS WIDTH IS LARGER THAN 50 INCHES: LOCATE SPACERS DIRECTLY OPPOSITE EACH OTHER ON BOTH INSIDE AND OUTSIDE FACES OF GLASS. INSTALL CORRECT SIZE AND SPACING TO PRESERVE REQUIRED FACE CLEARANCES, UNLESS GASKETS AND GLAZING TAPES ARE USED THAT HAVE DEMONSTRATED

ABILITY TO MAINTAIN REQUIRED FACE CLEARANCES AND TO COMPLY WITH SYSTEM

PERFORMANCE REQUIREMENTS. PROVIDE I/8-INCH (3-MM) MINIMUM BITE OF SPACERS ON GLASS AND USE THICKNESS EQUAL TO SEALANT WIDTH. WITH GLAZING TAPE, USE THICKNESS LESS THAN FINAL THICKNESS OF TAPE. PROVIDE EDGE BLOCKING WHERE INDICATED OR NEEDED TO PREVENT GLASS LITES FROM MOVING SIDEWAYS IN GLAZING CHANNEL, AS RECOMMENDED IN WRITING BY GLASS MANUFACTURER AND

ACCORDING TO REQUIREMENTS IN REFERENCED GLAZING PUBLICATIONS. 8. SET GLASS LITES IN EACH SERIES WITH UNIFORM PATTERN, DRAW, BOW, AND SIMILAR

9. GLASS STOPS ARE EXTRUDED ALUMINUM SNAP-IN TYPE FOR INTERIOR GLAZING OF GLASS OF PANELS 5/8" THICK (CUSTOM STOPS FOR THICKNESSES UP TO AN I" ARE AVAILABLE) AND HAVE A FIXED GASKET OF HIGH QUALITY ELASTOMERIC MATERIAL PERIMETER WOOL PILE AND ELASTOMERIC WEATHER-STRIP IS FACTORY APPLIED.

L. GLASS TYPES: REFER TO EXTERIOR MATERIALS AND FINISHES SCHEDULE ON DRAWINGS.

10. GLASS MUST HAVE (5) FIVE YEAR WARRANTY AGAINST SEAL FAILURE.

DIVISION 9 - FINISHES

NOTE: IT IS THE CONTRACTOR'S RESPONSIBILITY TO DETERMINE USE OF "CLASS A" OR "CLASS C" MATERIAL.

FLOOR AND WALL TILE INSTALLATION

A. PROVIDE TILE WORK COMPLETE IN PLACE AS INDICATED ON DRAWINGS, SPECIFIED HEREIN. B. TILE WORK SHALL BE SUBJECT TO PERFORMANCE STANDARDS AS SET BY THE AMERICAN NATIONAL STANDARDS INSTITUTE (ANSI) SPECIFICATION A-137J-80 FOR CERAMIC TILE OR CTI-69-5 FOR SPECIAL

PURPOSE TILE AND THE TILE COUNCIL OF AMERICA (TCA) CURRENT HANDBOOK FOR CERAMIC TILE INSTALLATION. C. DELIVER MATERIAL TO THE JOB SITE AND STORE IN ORIGINAL UNOPENED CARTONS WITH LABELS

INTACT AND LEGIBLE.

D. TILE SHOULD BE STORED IN A DRY COVERED AREA. E. TILE SHALL BE STANDARD GRADE IN ACCORDANCE WITH SPECIFICATIONS PUBLISHED BY ANSI A-137J-80 FOR CERAMIC TILE OR CT1-69-5 FOR SPECIAL PURPOSE TILE. I. EXTERIOR DECORATIVE WALL TILE: SEE FINISH SCHEDULE.

2. INTERIOR FLOOR TILE: SEE FINISH SCHEDULE. F. TILE SETTING, GROUTING MATERIALS, AND WATERPROOFING MEMBRANE:

I. BASIS-OF-DESIGN: LATICRETE INTERNATIONAL, INC. 2. APPROVED EQUAL: MAPEL CORPORATION.

G. [MR-I] MEDIUM BED, MODIFIED-PORTLAND CEMENT THIN SET MORTAR: ISO 13007: C2EPI / C2TESIPA AND ANSI AII8.15 AND CAPABLE OF BEING INSTALLED UP TO 1/4-INCH THICK. PRODUCTS: LATICRETE: 4XLT OR MAPEI: ULTRA FLEX LFT.

H. [MR-2] MODIFIED-PORTLAND CEMENT THIN SET MORTAR: ISO 13007: C2EPI / C2TESIPA AND ANSI

I. PRODUCTS: LATICRETE: 254 PLATIUM THINSET OR MAPEI: ULTRA FLEX 2. [MR-3] FREEZE-THAW REGIONS - FAST SETTING, SECOND GENERATION, TWO-COMPONENT MORTAR CONSISTING OF LATEX ADDITIVE AND MORTAR; COMPLY WITH ANSI AII8.4 AND ISO ISOOT CLASSIFICATION: C2FS2P2

PRODUCTS: LATICRETE: 4XLT RAPID OR MAPEI: GRANDI-RAPID.

. [MR-4] MODERATE REGIONS (NOT SUBJECT TO FREEZE-THAW CONDITIONS) FAST SETTING SINGLE COMPONENT POLYMER MODIFIED THIN SET MORTAR; COMPLY WITH ANSI AII8.4 AND ISO ISOOT CLASSIFICATION: C2TFSIPI.

PRODUCTS: LATICRETE: 4XLT RAPID OR MAPEI: ULTRA FLEX LFT. K. [GR-I] POLYMER-MODIFIED HIGH PERFORMANCE CEMENT TILE GROUT: ISO 13007: CG-2WAF AND

ANSIºAII8.7. I. PRODUCTS: FOR JOINTS 1/8-INCH OR WIDER (SANDED GROUT): LATICRETE: PERMACOLOR OR MAPEI: ULTRACOLOR PLUS.

2. COLORS: SEE INTERIOR AND EXTERIOR FINISH SCHEDULES.

L. [GR-2] CHEMICAL RESISTANT, WATER-CLEANABLE, INDUSTRIAL GRADE, TILE-GROUTING EPOXY: ISO 13007: R2 AND ANSI AII8.5, RESISTANT TO ENZYMATIC CLEANERS. TEMPERATURE RESISTANT: PRODUCT CAPABLE OF WITHSTANDING CONTINUOUS AND INTERMITTENT EXPOSURE TO TEMPERATURES OF UP TO 140°DEG°F AND 212°DEG, RESPECTIVELY, AND CERTIFIED IN WRITING BY MANUFACTURER FOR

I. PRODUCTS: LATICRETE: SPECTRALOCK 2000 IG OR MAPEI: KERAPOXY IEG.

2. COLORS: SEE INTERIOR FINISH SCHEDULE. M. [GR-3] WATER-CLEANABLE, TILE-GROUTING EPOXY: ISO I3007: RG AND ANSI II8.5.

I. PRODUCTS: LATICRETE: SPECTRA LOCK PRO (USE SPECTRALOCK 2000 IG IF USING ENZYMATIC CLEANERS) OR MAPEI: KERAPOXY CQ.

2. COLORS: SEE INTERIOR FINISH SCHEDULE. N. [WM-I] INTERIOR WATERPROOFING MEMBRANE: COMPLY WITH ANSI AII8.10. ADJOINING FLOOR AND WALL AREAS AT MOP SINK LOCATIONS OR WHERE INDICATED ON DRAWINGS, AND ELSEWHERE AS REQUIRED FOR WATERPROOFING TILE ASSEMBLY AS SPECIFIED IN ANSI A108.13 I. PRODUCTS: LATICRETE: HYDROBAN OR MAPEI: AQUA DEFENSE.

O. [MM-2] EXTERIOR WATERPROOFING MEMBRANE: FLEXIBLE WATERPROOFING MEMBRANE. PRODUCTS: LATICRETE: HYDROBAN OR MAPEI: MAPELASTIC 315; MAPELASTIC FIBERGLASS MESH.

P. THRESHOLDS: PROVIDE THRESHOLDS TO ADJUST BETWEEN TILE AND OTHER FLOOR FINISHES. Q. ACCEPTABILITY OF SURFACES: SURFACES TO BE TILED SHALL BE SMOOTH AND LEVEL FOR MORTAR

BED AT THE REQUIRED FINISH ELEVATION, AND A STEEL TROWEL FINISH WITH A LIGHT BROOM TEXTURED FINISH WITHOUT MORE THAN THE FOLLOWING MAXIMUM VARIATIONS I. PORTLAND CEMENT MORTAR: WALLS AND CEILINGS - I/4" IN 8"; FLOORS - I/8" IN IO'-O".

2. DRY SET, LATEX AND CEMENT MORTARS: WALLS AND CEILINGS - 1/8" IN 8"; FLOORS - 1/8" IN

R. PREPARATION: PRIOR TO THE START OF LAYING TILE, SWEEP OR VACUUM AND WASH SURFACES TO BE COVERED. SURFACE SHOULD BE FREE FROM COATING, CURING COMPOUNDS, OIL, GREASE, WAX AND

MAINTAINED DURING TILE WORK AND FOR SEVEN (7) DAYS THEREAFTER. PROVIDE ADEQUATE LIGHTING FOR GOOD GROUTING AND CLEAN-UP. T. LAYOUT OF WORK: INTERIOR WALL AND FLOOR FINISH LAYOUTS AND PATTERNS FOR KITCHEN,

S. JOB CONDITIONS: A MINIMUM TEMPERATURE OF 50 DEGREES F (10 DEGREES C) SHOULD BE

RESTROOMS AND DINING ROOM SHALL BE AS SHOWN ON INTERIOR ELEVATIONS AND FLOOR TILE PLAN. REFER TO THE FINISH SCHEDULE. DETERMINE LOCATIONS OF MOVEMENT (EXPANSION) JOINTS BEFORE STARTING TILE WORK. LAYOUT TILE WORK SO AS TO MINIMIZE CUTS LESS THAN ONE HALF TILE IN SIZE. LOCATE CUTS IN BOTH WALLS AND FLOORS SO AS TO BE LEAST CONSPICUOUS.

U. SETTING METHODS: SET TO TILE COUNCIL OF AMERICA SPECIFICATIONS WALLS W242-98 AND FLOORS FII3-98.

V. GROUTING: FOLLOW MANUFACTURER'S RECOMMENDATIONS AS TO GROUTING PROCEDURES AND PRECAUTIONS. REMOVE GROUT HAZE, OBSERVING GROUT MANUFACTURER'S RECOMMENDATIONS AS TO DIVISION 10 - SPECIALTIES

THE USE OF VARIOUS CLEANERS. FLOOR TILE GROUT TO BE 1/4" WIDE; WALL TILE GROUT TO BE 1/16" W. FINISHING: THOROUGHLY RINSE TILE WORK. USE NEUTRAL CLEANER WITH ABRASIVE ADDITIVE (WALTER GENERAL SIGNAGE

G. LEGGE'S "TEXSPAR" OR EQUAL) FOR FINAL CLEANING. ACID CLEANERS ARE NOT RECOMMENDED EXCEPT AS NOTED.

I. USE MIXTURE OF 75% WATER AND 25% MAPEI KARACLEAN TO CLEAN TILE SURFACE (EQUAL LATICRETE TILE CLEANER 1:3 DILUTION RATIO). APPLY AND BUFF.

2. USE PHOSPHORIC ACID OR SULFAMIC ACID ONLY FOR REMOVAL OF GROUT RESIDUE. DO NOT USE MURIATIC ACID.

GYPSUM DRYWALL

A. FURNISH MATERIAL AND LABOR NECESSARY TO PROVIDE FINISHED DRYWALL SURFACES IN AREAS SCHEDULED TO RECEIVE THIS FINISH ON THE DRAWINGS. TAPE, SPACKLE AND SAND SURFACES TO RECEIVE PAINT. REPEAT AS REQUIRED.

B. DRYWALL OVER FURRING AND WOOD STUDS SHALL BE 5/8" FIRECODE GYPSUM. MATERIALS SHALL BE STANDARD PRODUCTS MANUFACTURED BY US GYPSUM, NATIONAL GYPSUM OR GOLD BOND GYPSUM

SUSPENDED CEILING SYSTEM

A. FURNISH MATERIALS AND LABOR TO PROVIDE A COMPLETE SUSPENDED CEILING INCLUDING CEILING TILE, HANGERS, GRID TEES, AND MOLDINGS.

B. ACOUSTICAL CEILING MATERIALS IN THE DINING ROOM AT THE PERIMETER CEILING, RE: CT-2 ON FINISH

C. ACOUSTICAL CEILING MATERIALS IN THE DINING ROOM AT CENTRAL ACCENT CEILINGS, RE: CT-3 ON FINISH SCHEDULE.

D. CEILING IN THE KITCHEN, RE: CT-I ON FINISH SCHEDULE E. THE CEILING IN THE RESTROOMS SHALL BE SMOOTH, PAINTED GYPSUM DRYWALL.

I. COLOR: SEE THE FINISH SCHEDULE. F. THE CEILING SOFFITS IN THE DINING AREA SHALL BE SMOOTH, PAINTED GYPSUM DRYWALL.

I. COLOR: SEE THE FINISH SCHEDULE.

WALLCOVERING

A. WALLCOVERINGS INDICATED ON THE DRAWINGS TO BE SUPPLIED BY APPROVED SUPPLIERS AND INSTALLED BY GENERAL CONTRACTOR. REFER TO THE FINISH SCHEDULE FOR MATERIAL SPECIFICATIONS. (CONTRACTOR TO VERIFY QUANTITIES PRIOR TO START OF CONSTRUCTION).

B. PREPARATION: SURFACES MUST BE STRUCTURALLY SOUND, SMOOTH, CLEAN AND DRY. MOISTURE CONTENT OF WALLS SHOULD NOT EXCEED (5%) 5-PERCENT C. DRYMALL SURFACES MUST BE FINISHED AS TO RECEIVE PAINT. APPLY ONE COAT OF A WATER BASED

PRIMER SUCH AS ZINSSER SHIELDZ #2501 VINYL PRIMER TO SEAL AND SIZE THE SURFACE. D. INSTALLATION: APPLY VINYL WALLCOVERINGS USING A PRE-MIXED VINYL ADHESIVE WITH MILDEW INHIBITOR (ZINSSER SURE GRIP-122, #2881 OR EQUAL). BRUSH OR ROLL ADHESIVE UNIFORMLY GIVING ATTENTION TO EDGES. USE APPROXIMATELY ONE GALLON PER 10-12 LINEAR YARDS. PASTE AND

ROLL, ALLOWING MATERIAL TO STAND FOR AT LEAST FIVE MINUTES. HANG ON WALL USING BUTT

NON-TILE FIBERGLASS REINFORCED POLYESTER (FRP) PANELS

A. NON TILE WALL FINISH FRP (FOOD PREP AREA): SEE FINISH SCHEDULE.

PROCEDURE. ROLL SEAMS LIGHTLY AND SMOOTH OUT BLISTERS AS REQUIRED.

B. TEXTURED FIBERGLASS REINFORGED POLYESTER (FRP) PANELS SANITARY WALL SYSTEMS TO BE FRP PANEL. INSTALL 4'X9'XI/8 PANEL WITH HARMONIZING PVC MOLDINGS, ADHESIVE AND SEALANTS IN STRICT ACCORDANCE WITH MANUFACTURERS WRITTEN INSTALLATION INSTRUCTIONS, AS MANUFACTURED BY MARLITE OR KEMLITE GLASBORD.

C. NON-TILE WALL FINISH (DINING ROOM AREA): SEE FINISH SCHEDULE.

A. PROVIDE MATERIALS, LABOR, TOOLS AND EQUIPMENT REQUIRED TO COMPLETE THE PAINTING OF BUILDING AS SPECIFIED.

B. WORKMANSHIP: I. MATERIALS SHALL BE APPLIED FREE FROM RUNS, SAGS, WRINKLES, STREAKS, SHINERS AND BRUSH

2. MATERIALS SHALL BE APPLIED UNIFORMLY. IF REDUCTION OF THE COATINGS VISCOSITY IS

NECESSARY, IT SHALL BE DONE IN ACCORDANCE WITH THE MANUFACTURER'S LABEL DIRECTIONS. 3. NEW PLASTER AND OTHER MASONRY SURFACES SHALL NOT BE PRIMED UNTIL IT HAS BEEN DETERMINED THESE SUBSTRATES HAVE DRIED SUFFICIENTLY TO SAFELY ACCEPT PAINT. A RELIABLE ELECTRONIC MOISTURE METER SHOULD BE USED TO MAKE THIS DETERMINATION.

UNACCEPTABLE MOISTURE CONTENT SHOULD BE REPORTED TO THE ARCHITECT OR HIS REPRESENTATIVE. 4. A MINIMUM INTERIOR TEMPERATURE OF 65 DEGREES F SHALL BE MAINTAINED DURING THE ACTUAL APPLICATION AND DRYING OF THE PAINT, AND UNTIL OCCUPANCY OF THE BUILDING OCCURS. ADEQUATE VENTILATION SHALL BE MAINTAINED TO CONTROL EXCESSIVE HUMIDITY WHICH WILL ADVERSELY AFFECT THE CURING OF COATINGS. THE GENERAL CONTRACTOR IS SOLELY

RESPONSIBLE FOR MAINTAINING SUITABLE TEMPERATURES AND VENTILATION. 5. BEFORE PAINTING BEGINS, VERIFY WORK THAT CREATES DUST OR DEBRIS HAS BEEN COMPLETED. THE ROOMS OR AREAS ARE TO BE LEFT IN BROOM CLEAN CONDITION.

6. ENAMEL AND VARNISH UNDERCOATS ARE TO BE SANDED PRIOR TO THE RECOATING. TOP AND BOTTOMS OF DOORS ARE TO BE FINISHED IN THE SAME MANNER AS DOOR FACING. 7. NO EXTERIOR PAINTING SHALL BE UNDERTAKEN IF AIR OR SURFACE TEMPERATURE IS BELOW 50 DEGREES F, NOR IMMEDIATELY FOLLOWING RAIN OR UNTIL FROST, DEW OR CONDENSATION HAS EVAPORATED. SURFACES SHOULD ALWAYS BE TESTED WITH MOISTURE METER BEFORE

PROCEEDING.

C. PREPARATION OF SURFACES: DO NOT COMMENCE WORK UNTIL SURFACE IS IN PROPER CONDITION.

2. SURFACES ARE TO BE CLEAN. IF FOR ANY REASON THE SURFACE CANNOT BE CLEANED, THIS CONDITION SHALL BE PROMPTLY REPORTED TO THE GENERAL CONTRACTOR AND OWNER. 3. THE PRIME COAT SHOULD BE APPLIED SOON AFTER SURFACE PREPARATION HAS BEEN

COMPLETED, TO PREVENT CONTAMINATION OF THE SUBSTRATE. D. INSPECTION: WORK NOT CONFORMING TO THE SPECIFICATIONS OR NOT MEETING WITH THE APPROVAL OF THE OWNER, SHALL BE REMOVED OR CORRECTED AND/OR REPAINTED AS APPROVED BY THE

PAINT SCHEDULE

A. EXTERIOR ITEMS: REFER TO EXTERIOR FINISH SCHEDULE.

B. INTERIOR WOOD TRIM: EXISTING OR NEW INTERIOR WOOD TRIM TO BE FINISHED TO MATCH WALL FINISH. REFER TO FINISH SCHEDULE.

A. FOR BUILDING, FREE-STANDING PYLON, AND GROUND AND DIRECTIONAL SIGNS: . NEW STORES: WHITE WENDY'S LETTERS ON RED BACKGROUND, POLES AND HARDWARE PAINTED

PPG "BRILLIANT RED" 2. REMODEL STORES: NEW SIGN FACE, BODY REPAINTED PPG "BRILLIANT RED."

B. SIGNAGE INCLUDING MENU AND SPEAKER SIGNS SHALL BE FURNISHED BY OWNER AND INSTALLED BY

LICENSED SIGN ERECTOR. SEE APPROVED SIGN MANUFACTURERS LIST.

COORDINATE BUILDING IDENTITY SIGNS WITH WENDY'S REGIONAL ENGINEER. 2. SIGNS TO BE PROVIDED AND INSTALLED BY MANUFACTURER FROM APPROVED SIGN MANUFACTURERS LIST.

D. MENU BOARDS (INTERIOR AND EXTERIOR): SEE LISTING OF APPROVED SIGN MANUFACTURERS. BUILDINGS REQUIRE: a. ONE EXTERIOR BURGUNDY MENU BOARD WITH ORDER CONFIRMATION SYSTEM WITHIN SPEAKER

PEDESTAL.

b. ONE INTERIOR MENU BOARD, SOFFIT MOUNTED: I) FOUNDER'S LITE DESIGN ONLY: ONE BACKLIT BURGUNDY 8 PANEL MENU BOARD. 2) FRESH, SIMPLE AND FOUNDERS DESIGNS: ONE FRAMED MAGNETIC 7 PANEL MENU BOARD.

ROOM IDENTIFICATION SIGN

A. IDENTIFICATION SIGNS FURNISHED BY OWNER AND INSTALLED BY GENERAL CONTRACTOR. PRODUCED BY SIGN MANUFACTURER.

(SEE FINISH SCHEDULE FOR FRAME AND MAGNETIC STRIP COLOR)

A.D.A. RESTROOM IDENTIFICATION SIGN

A. SIGN SHALL BE 6" X 8" BEIGE WITH CONTRASTING BROWN ICONS IN COMPLIANCE WITH CURRENT ADAAG STANDARDS SECTION 703. SIGN SHALL BE MOUNTED ON WALL (LATCH SIDE OF DOOR).

TOILET COMPARTMENTS

A. FLOOR MOUNTED, OVERHEAD BRACED STAINLESS STEEL TOILET PARTITIONS: ACCURATE PARTITIONS

. URINAL SCREEN STYLE: WALL HUNG. 2. HARDWARE: HEAVY DUTY STAINLESS STEEL TAMPER-RESISTANT FASTENERS.

a. HINGES: CONTINUOUS PIANO HINGES. b. LATCH AND KEEPER: SURFACE MOUNTED SLIDE WITH ADA PADDLE HANDLES AT ACCESSIBLE

c. DOOR PULLS: STANDARD UNITS.

d. BRACKETS: CONTINUOUS STAINLESS STEEL.

D. INSTALL PARTITIONS ACCURATELY PER ADA REQUIREMENTS.

PROVIDE BLOCKING IN THE WALLS WHERE REQUIRED FOR TOILET PARTITION ATTACHMENT.

PUBLIC RESTROOM ACCESSORIES

PROJECT DRAWINGS FOR ACCESSORY SPECIFICATION AND LOCATIONS. I. OPTIONAL WHERE REQUIRED BY LOCAL AUTHORITIES: HAND DRYER: XLERATOR #XL-SB HAND DRYER WITH ADA COMPLIANCE RECESS KIT. FURNISHED BY OWNER AND INSTALLED BY

A. TOILET ROOM ACCESSORIES TO BE PROVIDED AND INSTALLED BY THE GENERAL CONTRACTOR. SEE

A. FRAMED ARTWORK TO BE MOUNTED TO WALLS WITH CONCEALED SECURITY HARDWARE SUPPLIED WITH

DECOR. REFER TO "MISCELLANEOUS-FINISH SCHEDULE" AND WENDY'S REGIONAL ENGINEER FOR ALL

. MISCELLANEOUS ITEMS: FURNISHINGS: VERIFY ALL MATERIALS AND FINISHES WITH THE FINISH

S&G METAL WORKS OR EQUAL, INSTALLED BY GENERAL CONTRACTOR.

SCHEDULE AND WENDY'S REGIONAL ENGINEER.

CONTRACTOR.

STAINLESS STEEL CORNERS A. 18 GAUGE STAINLESS STEEL WRAP STYLE CORNER PROTECTORS IN KITCHEN AREA. INSTALL PRIOR TO FLOOR AND WALL TILE IN ACCORDANCE WITH LOCATIONS NOTED ON EQUIPMENT PLAN. SUPPLIED BY

SITE NUMBER: BASE MODEL: CONVERSION ASSET TYPE: FRANCHISE CLASSIFICATION: REFRESH OWNER JARO FOODS BASE VERSION: 2016 JAN 05 **UPGRADE CLASSIFICATION:**

STANDARD

PROJECT YEAR: 2016 FURNITURE PACKAGE:

DESIGN BULLETINS: Wallin - Gomez

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01-08-16 ISSUED FOR PERMIT & BID 1 01-19-16 OWNER REVISIONS

PLOT DATE 1/19/2016 PROJECT NUMBER 15130 DRAWN BY CL/KH

CHECKED BY DJW


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THESE DRAWINGS HAVE BEEN PREPARED AT AND / OR UNDER MY SUPERVISION AND TO THE BEST OF MY KNOWLEDGE AND BELIEF CONFORM AND COMPLY WITH THE REQUIREMENTS OF THE DEPARTMENT OF BUILDING AND CODES HAVING JURISDICTION. STATE OF INDIANA

REGISTERED ARCHITECT

DONALD J. WALLIN



SPECIFICATIONS

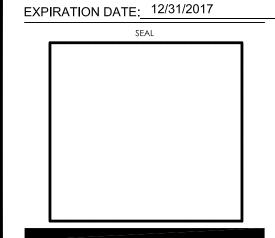DIVISION 22 - PLUMBING

- A. PROVIDE LABOR, EQUIPMENT, AND MATERIALS NECESSARY TO EXECUTE THE PLUMBING WORK INDICATED ON THE DRAWINGS, AND AS REQUIRED BY LOCAL CODES AND ORDINANCES.
- B. INCLUDE PIPING; DOMESTIC HOT AND COLD WATER, SANITARY AND SUPPLY AND HOOK-UP OF FIXTURES SCHEDULED ON THE DRAWINGS; AND INSULATION OF DESIGNATED PIPING RUNS SHALL ALSO INCLUDE GAS PIPING AND EQUIPMENT CONNECTIONS WHERE REQUIRED.
- C. INCLUDE ITEMS, SUCH AS FITTINGS, ETC. NOT MENTIONED BUT UNDERSTOOD AS NECESSARY TO COMPLETE THE PLUMBING SYSTEM.
- D. WASTE, AND VENT PIPING TO BE OF MATERIAL APPROVED BY LOCAL CODES.
- F. WATER SUPPLY PIPING BELOW GROUND SHALL BE TYPE K SOFT COPPER TUBING, (AVOID FITTINGS BELOW SLAB WHENEVER POSSIBLE). WATER SUPPLY PIPING ABOVE GROUND SHALL BE TYPE L HARD COPPER TUBING.
- G. PROVIDE FOR DRAINING WATER SYSTEM, AND CAP STUBS UNTIL FINISH WORK IS INSTALLED. H. PROVIDE STOPS ON WATER SUPPLIES TO EACH FIXTURE.
- I. INCLUDE GAS PIPING FOR HEATING SYSTEMS WITH GAS-FIRED EQUIPMENT. GAS PIPING SHALL BE STANDARD WEIGHT, BLACK STEEL PIPE, SCHEDULE 40. PIPING EXPOSED TO ATMOSPHERE OR RUN BELOW GRADE SHALL HAVE POLYETHYLENE PLASTIC COATING. GAS PIPING, FITTINGS AND INSTALLATION SHALL BE IN ACCORDANCE WITH REQUIREMENTS OF UTILITY COMPANY AND GOVERNING
- J. INSULATE COLD AND HOT WATER PIPING WITH ARMSTRONG COMPANY ARMAFLEX "II" PIPE INSULATION. SEAL JOINTS WITH ARMSTRONG 520 ADHESIVE. IMPORTANT - HOLD COLD AND HOT WATER PIPING TO MARM SIDE OF INSULATION TO PROHIBIT FREEZING. INSULATION SHALL MEET FLAME SPREAD AND SMOKE DEVELOPED RATINGS REQUIRED BY LOCAL CODES.
- K. PLUMBING FIXTURES SHALL BE FURNISHED AND INSTALLED WHERE SHOWN ON THE DRAWINGS. FIXTURE FITTINGS AND EXPOSED FIXTURE PIPING SHALL BE BRASS CHROMIUM PLATED. TRAPS SHALL BE CAST BRASS, FIXTURES SHALL BE WHITE, FIXTURES SHALL BE AS MANUFACTURED BY AMERICAN STANDARD. KOHLER OR CRANE AND EQUAL IN ALL RESPECTS TO FIXTURES SPECIFIED. CLOSET SEATS SHALL BE
- L. FIXTURES AND EQUIPMENT FIXTURES AND EQUIPMENT BY OTHERS. ROUGH-IN FINAL CONNECTIONS OF REQUIRED WASTE, VENT, AND WATER SUPPLY PIPING BY CONTRACTOR. SUPPLY PIPING SHALL BE
- M. GUARANTEE WORK INSTALLED UNDER THE CONTRACT TO BE FREE FROM DEFECTIVE WORKMANSHIP OR MATERIALS, USUAL MEAR EXPECTED, AND SHOULD SUCH DEFECTS DEVELOP WITHIN A PERIOD OF ONE YEAR AFTER ACCEPTANCE OF THE BUILDING BY THE OWNER, THIS CONTRACTOR SHALL REPAIR AND/OR REPLACE DEFECTIVE ITEMS AND DAMAGE RESULTING FROM FAILURE OF THESE ITEMS, AT NO EXPENSE WHATSOEVER TO THE OWNER.
- N. BACKFLOW PREVENTOR TO BE INSTALLED WHEN REQUIRED BY LOCAL CODE AND IS TO BE PROVIDED BY AND INSTALLED BY THE CONTRACTOR.
- O. SUPPLY AND INSTALL PREMADE GAS COOKING EQUIPMENT MANIFOLD AS SHOWN IN DRAWINGS SUPPLIED BY S&G METAL WORKS.

DIVISION 23 - HEATING, VENTILATING & AIR CONDITIONING

- A. PROVIDE LABOR, MATERIALS AND EQUIPMENT NECESSARY TO COMPLETE THE HEATING AND VENTILATING WORK INDICATED ON THE DRAWINGS AND AS REQUIRED BY LOCAL CODES AND ORDINANCES.
- B. INCLUDED IN THIS SECTION IS WORK TO INSTALL ROOM VENTS AS SHOWN ON THE DRAWINGS. C. FURNISH AND INSTALL HEATING AND COOLING UNITS AS INDICATED ON THE DRAWINGS. HEATING AND VENTILATING UNITS INDICATED ON THE DRAWINGS AND HEREINAFTER SPECIFIED ARE DESIGNED TO
- DEG. F WINTER. D. DIFFUSERS, REGISTERS, LOUVERS SHALL BE AS PER MODEL AND SIZE INDICATED ON DRAWINGS. NO E. PROVIDE CLEANOUTS FOR WASTE LINES AS SHOWN ON DRAWINGS, AND OF TYPE APPROVED BY LOCAL SUBSTITUTES SHALL BE ACCEPTED UNLESS APPROVED BY THE OWNER OR ARCHITECT IN WRITING. DIFFUSERS AND LOUVERS NOT MEETING SPECIFICATION AS SHOWN ON DRAWINGS SHALL BE REPLACED
 - AT CONTRACTOR'S EXPENSE. E. BEFORE FINAL ACCEPTANCE BY OWNER, AN OWNER'S REPRESENTATIVE SHALL CHECK ENTIRE HVAC
 - SYSTEM AND SUBMIT A WRITTEN REPORT TO THE OWNER. FINAL BALANCE OF HVAC SYSTEM SHALL BE PERFORMED BY MECHANICAL CONTRACTOR. NO FINAL PAYMENT WILL BE MADE UNTIL THE ABOVE REPORT HAS BEEN RECEIVED AND HVAC SYSTEMS ARE IN BALANCE.
 - SUPPLY DUCTS TO HAVE I 1/2" (R-8 MIN) FIBERGLASS INSULATION. EXHAUST INSTALLATION SHALL
 - CONFORM TO NFPA 96. G. WHERE REQUIRED, PROVIDE CLASS "B" GAS VENT FLUES COMPLETE WITH CAP, COLLAR AND FLASHING.
 - H. INSTALL THERMOSTAT COMPLETE WITH NECESSARY WIRING AND CONTROLS, LOCATION AS INDICATED ON THE DRAWINGS. THERMOSTAT SHALL PROVIDE FOR AUTOMATIC AND MANUAL FAN OPERATION. INSTALL AND CONNECT THE COMPLETE SYSTEM IN STRICT ACCORDANCE WITH GOVERNING CODES,
 - ORDINANCES AND THE LATEST CODES AND MANUALS OF THE NATIONAL WARM AIR HEATING AND AIR CONDITIONING ASSOCIATION. J. ADJUST CONTROLS AND EQUIPMENT FOR PROPER OPERATION. LUBRICATE AND CLEAN EQUIPMENT
 - PRIOR TO ACCEPTANCE OF BUILDING OWNER. K. FURNISH THE OWNER WITH OPERATING MANUALS AND MAINTENANCE INSTRUCTIONS FOR EQUIPMENT
 - INSTALLED. .. GUARANTEE WORK INSTALLED UNDER THE CONTRACT TO BE FREE FROM THE DEFECTIVE WORKMANSHIP
 - AND MATERIALS, USUAL MEAR EXPECTED, AND SHOULD SUCH DEFECTS DEVELOP WITHIN A PERIOD OF ONE YEAR AFTER ACCEPTANCE OF THE BUILDING BY THE OWNER, REPAIR AND/OR REPLACE DEFECTIVE ITEMS AND DAMAGE RESULTING FROM FAILURE OF THESE ITEMS, AT NO EXPENSE MHATSOEVER TO THE OWNER.

DIVISION 26 - ELECTRICAL

INTERLOCKED.

- A. PROVIDE A COMPLETE ELECTRICAL SYSTEM AS INDICATED ON THE DRAWINGS AND DESCRIBED
- B. ELECTRIC WORK SHALL COMPLY WITH THE LATEST NATIONAL ELECTRIC CODE AS WELL AS STATE AND LOCAL GOVERNING CODES. C. PAY FOR PERMITS AND INSPECTIONS AND PROVIDE A CERTIFICATE OF INSPECTION.
- D. PROVIDE REQUIRED SERVICE AND EQUIPMENT GROUNDING SYSTEMS. THE CONDUIT SYSTEM SHALL BE MEET ASHRAE 90-65 BASED ON COLUMBUS, OHIO DESIGN CONDITIONS OF 93 DEG. F SUMMER AND O ELECTRICALLY CONTINUOUS AND SHALL BE SAFELY GROUNDED AT THE DISTRIBUTION PANEL. DEVICES SHALL BE BONDED TO THE CONDUIT SYSTEM. PROVIDE A SEPARATE GROUNDING CONDUCTOR IN EACH CONDUIT, #12 MINIMUM OR AS SHOWN ON DRAWINGS.
 - E. MATERIALS SHALL BE NEW WITH MANUFACTURER'S NAME PRINTED THEREON AND UNDERWRITER'S LABORATORY LISTED. THE SELECTION OF MATERIALS AND EQUIPMENT TO BE PROVIDED UNDER THIS CONTRACT SHALL BE IN STRICT ACCORDANCE WITH THE SPECIFICATIONS AND DRAWINGS. F. SUBMIT TO THE ARCHITECT FOR APPROVAL & COPIES OF EQUIPMENT AS FOLLOWS: PANELBOARDS, DISCONNECT SWITCHES AND LIGHTING FIXTURES.
 - G. IDENTIFY DISCONNECT SWITCHES WITH LAMINATED PHENOLIC NAME PLATES WITH 1/4" MINIMUM HEIGHT
- F. WHERE REQUIRED BY GOVERNING ORDINANCES, PROVIDE FIRE DAMPERS CONFORMING TO NFPA 90A. H. PROVIDE POWER WIRING AND HOOK-UP FOR EACH MECHANICAL AND KITCHEN EQUIPMENT ITEM. MOUNT PROVIDE WIRING, AND MAKE FINAL CONNECTIONS TO EQUIPMENT CONTROL PANELS (WHICH INCLUDE PREWIRED STARTERS, RELAYS, ETC.). FURNISH AND INSTALL STARTERS WHICH ARE NOT FURNISHED AS A PART OF MECHANICAL EQUIPMENT.
 - PROVIDE DEVICES, WIRING AND HOOK-UP FOR THE EMERGENCY KITCHEN SHUTDOWN SYSTEM AS
 - DESCRIBED AND SPECIFIED ON DRAWINGS. WIRING SHALL BE IN CONDUIT. J. DISCONNECT SMITCHES SHALL BE THE HEAVY DUTY TYPE IN NEMA I ENCLOSURE OR EQUAL BY SQUARE D OR ARROW-HART. SWITCHES SHALL BE QUICK-MAKE, QUICK-BREAK, EXTERNALLY OPERATED AND
 - K. SMITCHES SHALL BE 20 AMP HUBBELL 1221-1 SINGLE POLE OR 1223-1 THREE WAY. DUPLEX RECEPTACLES SHALL BE 20 AMP HUBBELL 5362-I. PASS AND SEYMOUR, ARROW-HART AND BRYANT SHALL BE CONSIDERED AS EQUAL. GROUND FAULT INTERRUPTING SHALL BE G.E. TGTRII5F. COVER PLATES SHALL BE SIERRA (PASS AND SEYMOUR). SMITCH PLATES TO BE SERIES #S-IN. DUPLEX PLATES TO BE SERIES #S-IN. DUPLEX PLATES IN DINING ROOM TO BE #P-8 ETC. COVER PLATES TO HAVE SATIN FINISH #302 STAINLESS STEEL.
 - L. TEST ELECTRICAL SYSTEM FOR SHORT CIRCUITS AND MEGGER TEST FEEDERS AND BRANCH CIRCUIT WIRING, INSURE LOW IMPEDANCE GROUND SYSTEM.
 - M. FOR SERVICE AND PANEL FEEDER WIRING, USE TYPE THHN CABLE. USE TW CABLE FOR INTERIOR BRANCH CIRCUIT WIRING EXCEPT AS NOTED. DESIGN IS BASED ON COPPER CONDUCTORS AND COPPER WIRING. MINIMUM #12 AWG. WIRING SHALL BE IN CONDUIT. SPLICE WIRES #6 AWG. AND LARGER WITH APPROVED SOLDERLESS CONNECTORS SUCH AS ILSCO PROPERLY TAPED AND INSULATED. SPLICE SMALLER WIRES WITH MECHANICAL CONNECTORS SUCH AS 3M "SCOTCHLOCK"
 - N. PROVIDE RIGID GALVANIZED STEEL HEAVY WALL CONDUIT OR PLASTIC CONDUIT FOR SERVICE AND PANEL FEEDER CONDUITS. FITTINGS SHALL BE STEEL. THREADED, SET-SCREW TYPE WITH INSULATED THROATS. FURNISH EMT CONDUIT FOR INTERIOR WIRING WHERE PHYSICAL DAMAGE IS NOT A CONSIDERATION. MINIMUM CONDUIT SIZE IS 3/4" EXCEPT FOR FLEXIBLE RUNOUTS TO FIXTURES, MOTORS, ETC. WHICH MAY BE 1/2".
 - O. CONDUIT SHALL BE CONCEALED WHEREVER POSSIBLE AND SHALL BE RUN PARALLEL OR PERPENDICULAR TO BUILDING WALLS AND CEILINGS.
 - P. CONDUIT INSTALLED IN OR BELOW SLAB SHALL BE GALVANIZED RIGID CONDUIT OR PLASTIC CONDUIT. NO CONDUIT LARGER THAN 1-1/2" DIAMETER WILL BE INSTALLED IN SLAB.
 - Q. PROVIDE STRUCTURAL STEEL FRAMEWORK AND HANGING RODS WITH BRACES AND ACCESSORIES WHERE REQUIRED TO HOLD EQUIPMENT IN FINAL POSITION. PROVIDE STEEL SHAPES AND FRAMES TO
 - SUPPORT WALL MOUNTED EQUIPMENT WHERE NORMAL WALL STRENGTH MAY BE INADEQUATE. R. ELECTRICAL DEVICES, MOTOR STARTERS, DISCONNECT SWITCHES, ETC. SHALL BE SUPPORTED INDEPENDENT OF AND ISOLATED FROM EQUIPMENT VIBRATION.
 - S. COORDINATE INTERIOR WIRING CONNECTIONS NEEDED DURING ASSEMBLY OF KITCHEN EQUIPMENT WITH KITCHEN EQUIPMENT SUPPLIER.
 - T. PROVIDE POWER TO CASH REGISTERS WITH THE FOLLOWING GROUNDING REQUIREMENTS. I. SYSTEM POWER AND GROUND MUST BE MADE ONLY AT THE MAIN ENTRANCE PANEL. THE GROUND CONDUCTOR MUST BE OF INSULATED WIRE EQUAL IN SIZE TO THE POWER CONDUCTOR (CONDUIT
 - MAY NOT BE USED AS THE GROUND CONDUCTOR). 2. THE GROUND CONDUCTOR MUST NOT BE USED AS A RETURN OR NEUTRAL CONDUCTOR FOR ANY EQUIPMENT AND MUST NOT BE USED AS A GROUND FOR ANY EQUIPMENT OTHER THAN CASH REGISTER EQUIPMENT.
 - 3. RECEPTACLES FOR THE REGISTERS MUST BE 2 POLE, 3 WIRE, 120 VOLTS, 20 AMPERES. THE GROUND MUST BE INSULATED FROM THE MOUNTING HARDWARE (HUBBEL 1G5362).
 - 4. FOR ADDITIONAL INFORMATION, IF REQUIRED, CONTACT WENDY'S INTERNATIONAL, INC., 4288 W. DUBLIN-GRANVILLE ROAD, DUBLIN, OH.
 - 5. THE REGISTER CONDUITS MUST NOT BE USED FOR OTHER EQUIPMENT. T. PROVIDE FIXTURES AS LISTED ON LIGHTING FIXTURE SCHEDULE. PROVIDE NECESSARY MOUNTING HARDWARE FOR A COMPLETE INSTALLATION. PROVIDE LAMPS, BALLASTS AND SPECIAL CONTROLS.
 - RECESSED LIGHT FIXTURES SHALL BE GASKETED OR CAULKED AND IC RATED. U. GUARANTEE WORK INSTALLED UNDER THE CONTRACT TO BE FREE FROM DEFECTIVE WORKMANSHIP
 - AND MATERIALS, USUAL WEAR EXPECTED, AND SHOULD SUCH DEFECTS DEVELOP WITHIN A PERIOD OF ONE YEAR AFTER ACCEPTANCE OF THE BUILDING BY THE OWNER, REPAIR AND/OR REPLACE DEFECTIVE ITEMS AND DAMAGE RESULTING FROM FAILURE OF THESE ITEMS, AT NO EXPENSE WHATSOEVER TO THE OWNER.

SITE NUMBER: 07588 BASE MODEL: CONVERSION ASSET TYPE: **FRANCHISE** CLASSIFICATION: REFRESH OWNER: JARO FOODS BASE VERSION: 2016 JAN 05 UPGRADE CLASSIFICATION:

STANDARD PROJECT YEAR: 2016 FURNITURE PACKAGE: 2015

DESIGN BULLETINS:

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DESCRIPTION 01-08-16 ISSUED FOR PERMIT & BID OWNER REVISIONS

PROJECT NUMBER 15130 DRAWN BY CL/KH

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BUILDING AND CODES HAVING JURISDICTION. STATE OF INDIANA AR19500067 REGISTERED ARCHITECT DONALD J. WALLIN EXPIRATION DATE: 12/31/2017

