
OPTIONS LIST] = OPTION NOT INCLUDED IN SET	T ■ = OPTION INC	CLUDED IN SET											
INTERIOR OPTIONS								EXTERIOR OPTIONS	OPTIO	ONS PER PLAN				
DESCRIPTION	DESCRIPTION		DESCRIPTION		DESCRIPTION			DESCRIPTION		RIPTION	DESCRIPTION		DESCRIPTION	1
	NEW CEILING TILES		MUSIC W/ CEILING N		·	DING FIREPLACE		NEW BUILDING SIGNAGE		PICK-UP WINDOW ITEMS (PARTIAL)				
	NEW CEILING GRID■ NEW PENDANT LIGHTS		□ SEPARATE ORDER/F					REMOVE DIRECTIONALS LANDSCAPING		PICK-UP WINDOW AWNING (SOFT)				
SELF SERVE DRINK - ONE FREESTYLE (EXISTING)	REPLACE SERVICE COUNTE	ER BACK WALL FINISHES	☐ CARPET		□ NEW GREAS	SE TANK		■ FLAG BLADE	□ NEW	ORDER STATION CANOPY				
	ARTPACK		REPLACE RESTROO			<u> </u>		■ NEW CORRUGATED PANELS □ PAINT (E) WALL SCONCES						
	WIFI SERVICE ALL WOOD LOOK PORCELA	AIN PLANK TILE	■ ONE BEVARITY IN D	· I	PUW VESTI	BULE		PAINT (E) WALL SCONCES PAINT (E) STOREFRONT						
		I									<u> </u>			
GENERAL NOTES		ABBREVIA	TIONS			CODE	DATA AND S	SQUARE FOOTAGE	SHEE	T INDEX				SITE NUMBER: 07588
DISCREPANCIES BETWEEN THESE DOCUMENTS CONDITIONS SHALL BE BROUGHT TO THE ATTEN ARCHITECT BEFORE PROCEEDING WITH WORK.	ENTION OF THE		INE M COMPOSITE PANEL CAL CEILING TILE		SIDE DIAMETER SULATION	STORE TYPE:	CONVERSIO	N						BASE MODEL: CONVERSION ASSET TYPE: FRANCHISE CLASSIFICATION: REFRESH
REVIEW DOCUMENTS AND VERIFY DIMENSIONS		ADJ. ADJUSTAI		KES KIT	TCHEN EQUIPMENT SUPPLIER MINATE	LOCATION:	747 SOUTH S	TATE ROAD 135, GREENWOOD, IN 46143						OWNER: JARO FOODS
CONDITIONS AND CONFIRM THAT WORK IS CON SHOWN. CONFLICTS OR OMISSIONS, ETC., SHAI			TY HAVING JURISDICTION	I LB(S). POL	DUND(S) AXIMUM	BUILDING LEVE			G1.1	COVER SHEET				BASE VERSION: 2015 OCT 16
REPORTED TO THE ARCHITECT FOR CLARIFICAT PERFORMANCE OF WORK IN QUESTION.	ATION PRIOR TO THE	A.O.R. ARCHITEC	CT OF RECORD	MECH. MEG	ECHANICAL	APPLICABLE CODES:	BUILDING: AMMENDMENT:							UPGRADE CLASSIFICATION:
3. DO NOT SCALE DRAWINGS. WRITTEN DIMENSIC		ARCH. ARCHITEC	JIURAL	MGR. MAN	ANUFACTURER ANAGER		PLUMBING: AMMENDMENT	2006 INTERNATIONAL PLUMBING CODE w/ INDIANA	AS1.1	SITE PLAN				PROJECT YEAR: 2015
LOCATIONS. IN CASE OF CONFLICT, NOTIFY THE RECORD. FLOOR PLAN BY ARCHITECT OF RECO		BLDG. BUILDING BLKG. BLOCKING	3	MISC MIS	NIMUM SCELLANEOUS		ELECTRICAL: AMMENDMEN	2008 NATIONAL ELECTRIC CODE w/ INDIANA	D1 1	DEMOLITION EL COP PLAN				PROJECT YEAR: 2015 FURNITURE PACKAGE: 2015
OTHER PLANS. DIMENSIONS MARKED "CLEAR" S AND SHALL ALLOW FOR THICKNESS OF FINISHE		BM. BEAM BOT. BOTTOM			ETAL DRTH		MECHANICAL:	2012 INTERNATIONAL MECHANICAL CODE w/	D1.1 D2.1	DEMOLITION FLOOR PLAN DEMOLITION CEILING PLAN				DESIGN BULLETINS:
PAD, CERAMIC TILE, V.C.T., ETC.	LO INOLODINO CAN LI,	CAB. CABINET CER. CERAMIC			OT IN CONTRACT OT TO SCALE		INDIANA AMM ENERGY:	ASHRAE 90.1 2007 w/ INDIANA AMMENDMENTS		DEMOLITION ELEVATIONS				
 INTERIOR DIMENSIONS ARE TO THE FACE OF NE NOTED OTHERWISE. 	IEW STUD, UNLESS	CLG. CEILING CLKG. CAULKING	3	(N) NEV			ACCESSIBILIT	Y CODE: 2012 INTERNATIONAL BUILDING CODE		DEMOLITION ELEVATIONS				Wallin • Gomez Architects, Ltd.
5. COLUMN CENTER LINE (OR GRID LINES) ARE SH		CLR. CLEAR	•	NOM. NOI	DMINAL		(ANSI A117.1-2	2003) 2012 INTERNATIONAL FIRE CODE w/ INDIANA	A1.1	FLOOR & FINISH PLAN				711 South Dearborn Street
DIMENSIONING. VERIFY EXACT LOCATIONS IN F	FIELD.	COL. COLUMN CONC. CONCRET		OPNG. OPE	JTSIDE DIAMETER PENING		AMMENDMEN		A2.1	EXTERIOR ELEVATIONS				711 South Dearborn Street Suite 606 Chicago, IL 60605
MARK LOCATIONS OF PARTITIONS AND DOORS I OWNER'S REPRESENTATIVE PRIOR TO INSTALL	LATION. REVIEW WILL BE	CONT. CONTINUO COORD. COORDIN.		P.LAM. PLA	PPOSITE ASTIC LAMINATE				A2.2	EXTERIOR ELEVATIONS				Tel: 312-427-4702
FOR DESIGN INTENT. COORDINATE AND VERIFY ENSURE PROPER FIT.		DBL. DOUBLE DET. DETAIL		PL. PLA	ATE ASTER	OCCUPANCY	A-2 (RESTAU	RANT)	A3.1	WALL SECTIONS & DETAILS				Fax: 312-427-6611 e-mail: admin@wgaltd.com
7. CONTRACTOR IS REQUIRED TO SCHEDULE A PR	RE-CONSTRUCTION	DIA. DIAMETER DIM. DIMENSIO			YWOOD	CLASSIFICAITOI EXISTING	ON .	,	A3.2	WALL SECTIONS & DETAILS				o main adminie wgana.som
MEETING WITH THE OWNER'S REPRESENTATIVE REQUIREMENTS. CONTRACTOR IS RESPONSIBLE		DND DO NOT D		PT. POI	DINT	CONSTRUCTION TYPE:	NVB		A5.1	FINISH DETAILS				
WENDY'S COMPANY RULES AND REGULATIONS.		DR. DOOR DS. DOWNSPO		P.U.W. PUL	RESSURE-TREATED ILL UP WINDOW		I		A6.1	FINISH SCHEDULES				Ω.
 WHEN CONTRACTOR ACCEPTS DELIVERY OF AL PLANS WHETHER IN CONTRACT OR NOT IN CON 		DWG. DRAWING (E) EXISTING			ADIUS FERENCE	BUILDING SUMN	MARY:		A6.2	APPROVED SUPPLIERS				D 13
RESPONSIBLE FOR LOSS AND/OR DAMAGE TO T	· · · · · · · · · · · · · · · · · · ·	EA. EACH ELEV. ELEVATIO	N		GISTER QUIRED	FLAGRIA	EXISTING: 3,4		A7.1	INTERIOR ELEVATIONS - DINING RO	ОМ			
 THE CONTRACTOR SHALL MAINTAIN, FOR THE E THE WORK, ALL EXITS, EXIT/ EGRESS LIGHTING, 		ELEC. ELECTRIC EMER. EMERGEN	AL	RM. RO	OOM DUTH		EVISED TOTAL: 3,		A7.2	INTERIOR ELEVATIONS - RESTROOM	MS			
DEVICES AND ALARMS IN CONFORMANCE WITH CODES AND ORDINANCES.	•	EQ. EQUAL		S.C. SOL	OLID CORE				EQ1.1	EQUIPMENT PLAN & SCHEDULE				
10. EXISTING WORK: WITH PRIOR APPROVAL OF TH	HE OWNER'S	F/MAS FACE OF I F.D. FLOOR DF	RAIN	S.S. STA	QUARE FOOT TAINLESS STEEL		OCCUI	PANCY CALCULATIONS:	P1.1	PLUMBING PLAN & SCHEDULE				FZ
REPRESENTATIVE AND RETURN OF PROPER CR WHICH FITS THE SCHEME MAY BE RE-USED.	REDIT, EXISTING WORK	F.E. FIRE EXTI F.O. FACE OF	NGUISHER		CHEDULE HEET	FLOOR		SQUARE LOAD NUMBER OF NUMBER	E1.1	REFLECTED CEILING & LIGHTING PL	AN			.588 ST/ OD,
11. DEMOLITION: REMOVE INTERIOR PARTITIONS, O	CASEWORK,	F.O.F. FACE OF F F.O.S. FACE OF S			MILAR COPE OF WORK	I LOOK	F	OOTAGE FACTOR OCCUPANTS OF SEATS	E2.1	ELECTRICAL PLAN				
STOREFRONTS, CEILING, FINISHED FLOORING A USED IN NEW SCHEME. REMOVE UTILITIES, ELE		F/F FINISH TO F.R. FIRE RETA	FINISH	SPEC. SPE	PECIFICATION QUARE	1 OF: 1	DINING 12	24 SQ.FT. 1:15 82 66	SP1	SPECIFICATIONS				1
PIPING AS REQUIRED BACK TO EXISTING CONST	STRUCTION AND	FIN. FINISH	ALDANI	STD. STA	ANDARD	1 OF: 1 K	KITCHEN	1,602 1:200 8 -	SP2	SPECIFICATIONS				ORE SOL
TERMINATE AND/OR CAP AS REQUIRED BY LOCATIONS SHALL ITS AND CORING LOCATIONS SHALL ITS AND CO		FL. FLOOR FLUOR. FLUORES		STOR. STO	EEL ORAGE	1 OF: 1 RES		SQ.FT. 6	SP3	SPECIFICATIONS				10 I S I S I S I S I S I S I S I S I S I
AND COORDINATED WITH THE OWNER'S REPRE CUTTING/CORING.		FT. FOOT, FEE F.V. FIELD VEF	RIFY	T.C. TIM	JSPENDED ME CLOCK		OCCUPIED	55 SQ.FT		I				STC 747 GRI
13. DURING ALL PHASES OF WORK, DO NOT DISTUR	RB THE DELIVERIES AND	G.B. GRAB BAF G.C. GENERAL	R CONTRACTOR		OP OF ELEPHONE		TOTAL NU	JMBER OF OCCUPANTS: 90 -						rev. date description
FUNCTIONS OF ADJACENT AND NEIGHBORING T		GA. GAUGE GL. GLASS			IICK PICAL			COOLER, WALLS, CLOSET, RESTROOMS, AND VESTIBULE BASED ON LENGTH OF BOOTHS: 1 PER 24" OF BOOTH LENGTH.						01-08-16 ISSUED FOR PERMIT & BID
14. 'TYP.' MEANS THAT THE CONDITION IS REPRESE CONDITIONS THROUGHOUT, UNLESS OTHERWIS		GYP. GYPSUM H. HIGH		U.N.O. UNL	ILESS NOTED OTHERWISE		,,,,,,,	EGRESS EGRESS						
15. PROVIDE PORTABLE FIRE EXTINGUISHER(S) IN A		H.C. HOLLOW		V.I.F. VEF	RIFY IN FIELD	EGRESS CAL	_CULATION: O	COUDANTS OCCUPANT WIDITH WIDTH						
NFPA 10, WITH U.L. LABEL AND A RATING OF NO 75 FT. TRAVEL DISTANCE TO ALL POSITIONS OF		H.M. HOLLOW I HC. HANDICAF	PPED	W. WE. W/ WIT	TH			90 0.20" REQUIRED: PROVIDED:						
DIRECTED BY THE FIRE DEPARTMENT FIELD INS CLASS K FIRE EXTINGUISHER WITHIN 30 FT. OF		HDWD. HARDWOO HORIZ. HORIZON			ATER CLOSET ITHOUT			90 0.20" 18" 108" TOTAL						PLOT DATE 1/8/2016
HEAT-PROCESSING EQUIPMENT.	COMMENCE A COD	HGT. HEIGHT H.T. HANGER-	TIGHT UNIT		ATER RESISTANT OOD	TOTAL EXITS	REQUIRED:	2 TOTAL EXITS PROVIDED: 3 EGRESS WIDTH PROVIDED PER EXIT: 36"						PROJECT NUMBER 15130
16. EXTERIOR BUILDING SIGNS SHALL BE SUBMITTE PERMIT APPLICATION FOR REVIEW AND APPROVE			VENTILATION,			THE LOSS OF ONE		EGRESS WIDTH PROVIDED PER EXIT. 30 EGRESS SHALL NOT REDUCE THE EGRESS CAPACITY TO LESS HAN 50% OF REQUIRED.						DRAWN BY CL/KH CHECKED BY DJW
LOCAL AUTHORITIES. EXTERIOR SIGNS ARE NO BUILDING DEPARTMENT APPROVAL.		AIRCOOND	THOMING				'	IAN 30 % OF INEQUINED.						NOTICE: THIS DOCUMENT CONTAINS
17. PRIOR TO COMMENCEMENT OF WORK, AS REQU	QUIRED BY GOVERNING							(TERIOR BEARING WALL(0 HOUR) (EXISTING)						PROPRIETARY INFORMATION. IT SHALL NOT BE USED OR REPRODUCED OR ITS CONTENTS DISCLOSED, IN WHOLE OR IN PART WITHOUT
JURISDICTION, OBTAIN A COPY OF THE BUILDING PERMIT FROM THE AUTHORITY HAVING JURISDI	NG CONSTRUCTION					FIRE RES REQUIREI	MENTS:	OOF CONSTRUCTION(0 HOUR)						THE PRIOR WRITTEN CONSENT OF WALLIN / GOMEZ ARCHITECTS, LTD.
COPY OF THE SET OF CONSTRUCTION DOCUME	ENTS SIĞNED AND						CI	EILING(0 HOUR)						THESE DRAWINGS HAVE BEEN PREPARED AT AND / OR UNDER MY SUPERVISION AND TO
SEALED BY A LICENSED DESIGN PROFESSIONAL AS REQUIRED AND USED TO OBTAIN THE BUILD						FIRE SPRII	NKLERS: NO	ONE REQUIRED						THE BEST OF MY KNOWLEDGE AND BELIEF CONFORM AND COMPLY WITH THE REQUIREMENTS OF THE DEPARTMENT OF
						MAX. TRAVEL	DISTANCE: 20	0'-0"						BUILDING AND CODES HAVING JURISDICTION.
							W	ATER CLOSETS: 1 REQUIRED FOR MALE, 1			<u> </u>			STATE OF INDIANA AR19500067
DESCRIPTIVE SUMMARY OF WO	ORK	SYMBOLS	LEGEND					EQUIRED FOR FEMALE (2 PROVIDED) VATORIES: 1 REQUIRED FOR MALE, 1 REQUIRED				VICINITY MA	P PROJECT SITE	REGISTERED ARCHITECT DONALD J. WALLIN
THE WORK INCLUDES ALL LABOR MATERIALS AND						RESTROOM RE	FC	PR FEMALE RINALS1 PROVIDED						EXPIRATION DATE: 12/31/2017
THE WORK INCLUDES ALL LABOR, MATERIALS, AN REPLACE EXISTING PRE-FABRICATED FASCIA AND	ID INTERIOR FINISHES FOR	(x.x)— NEW GR	ID LINE	<i>e I</i> I I	ETAIL REFERENCE HEET NUMBER	TALOTAGOWI RE	0,	RINALS1 PROVIDED RINKING FOUNTAINSNOT REQUIRED				- TEST -		SEAL
A PROPOSED REFRESH OF AN EXISTING RESTAULTHE WORK SHALL INCLUDE ALL ITEMS REQUIRED			NDK	<u> </u>			Pl	JBLIC ACCESSPROVIDED						
DRAWINGS. ALL ELECTRICAL SYSTEMS AND PLUM	IMBING ARE TO BE	# DOOR M	<i></i>		EVATION NUMBER &		UI	NISEX IS PERMITTEDN/A					The same of the sa	
INCLUDED FOR A COMPLETE OPERATING SYSTEM AND INSTALLATION INCLUDED.	M WITH COORDINATION	(#) WINDOV	V MARK 11<(6)	<i>)</i> .	RECTION HEET NUMBER									
		⊗ KEY NO	1(F F	U								N A A A A A A A A A A A A A A A A A A A		
		NET NO	. 4=		EVATION HEIGHT TARGET DCATION IN SPACE									
		XXX EQUIPMI	ENT NOTE	-· LO	OCATION IN SEMUE						.48	H TOTAL DE		CHEET NAME
		△ ELE\/∧∓I	ON REFERENCE FLOO	ING WALL FIN	NISH CODE (SEE							7		COVER SHEET
		5 SHEET N	SUMBER	ok base SC	CHEDULE)							and the same of th		
			JOETAN DESERVICE	_ 🔬 RE	EVISION SYMBOL						1		distance of the state of the st	SHEET NUMBER
		SHEET N	N DETAIL REFERENCE NUMBER	RF	EVISION CLOUD							10 200	The same of the sa	
		1		~~~ '\ <u>_</u>									NORTH	

ROOM NAME ROOM NUMBER

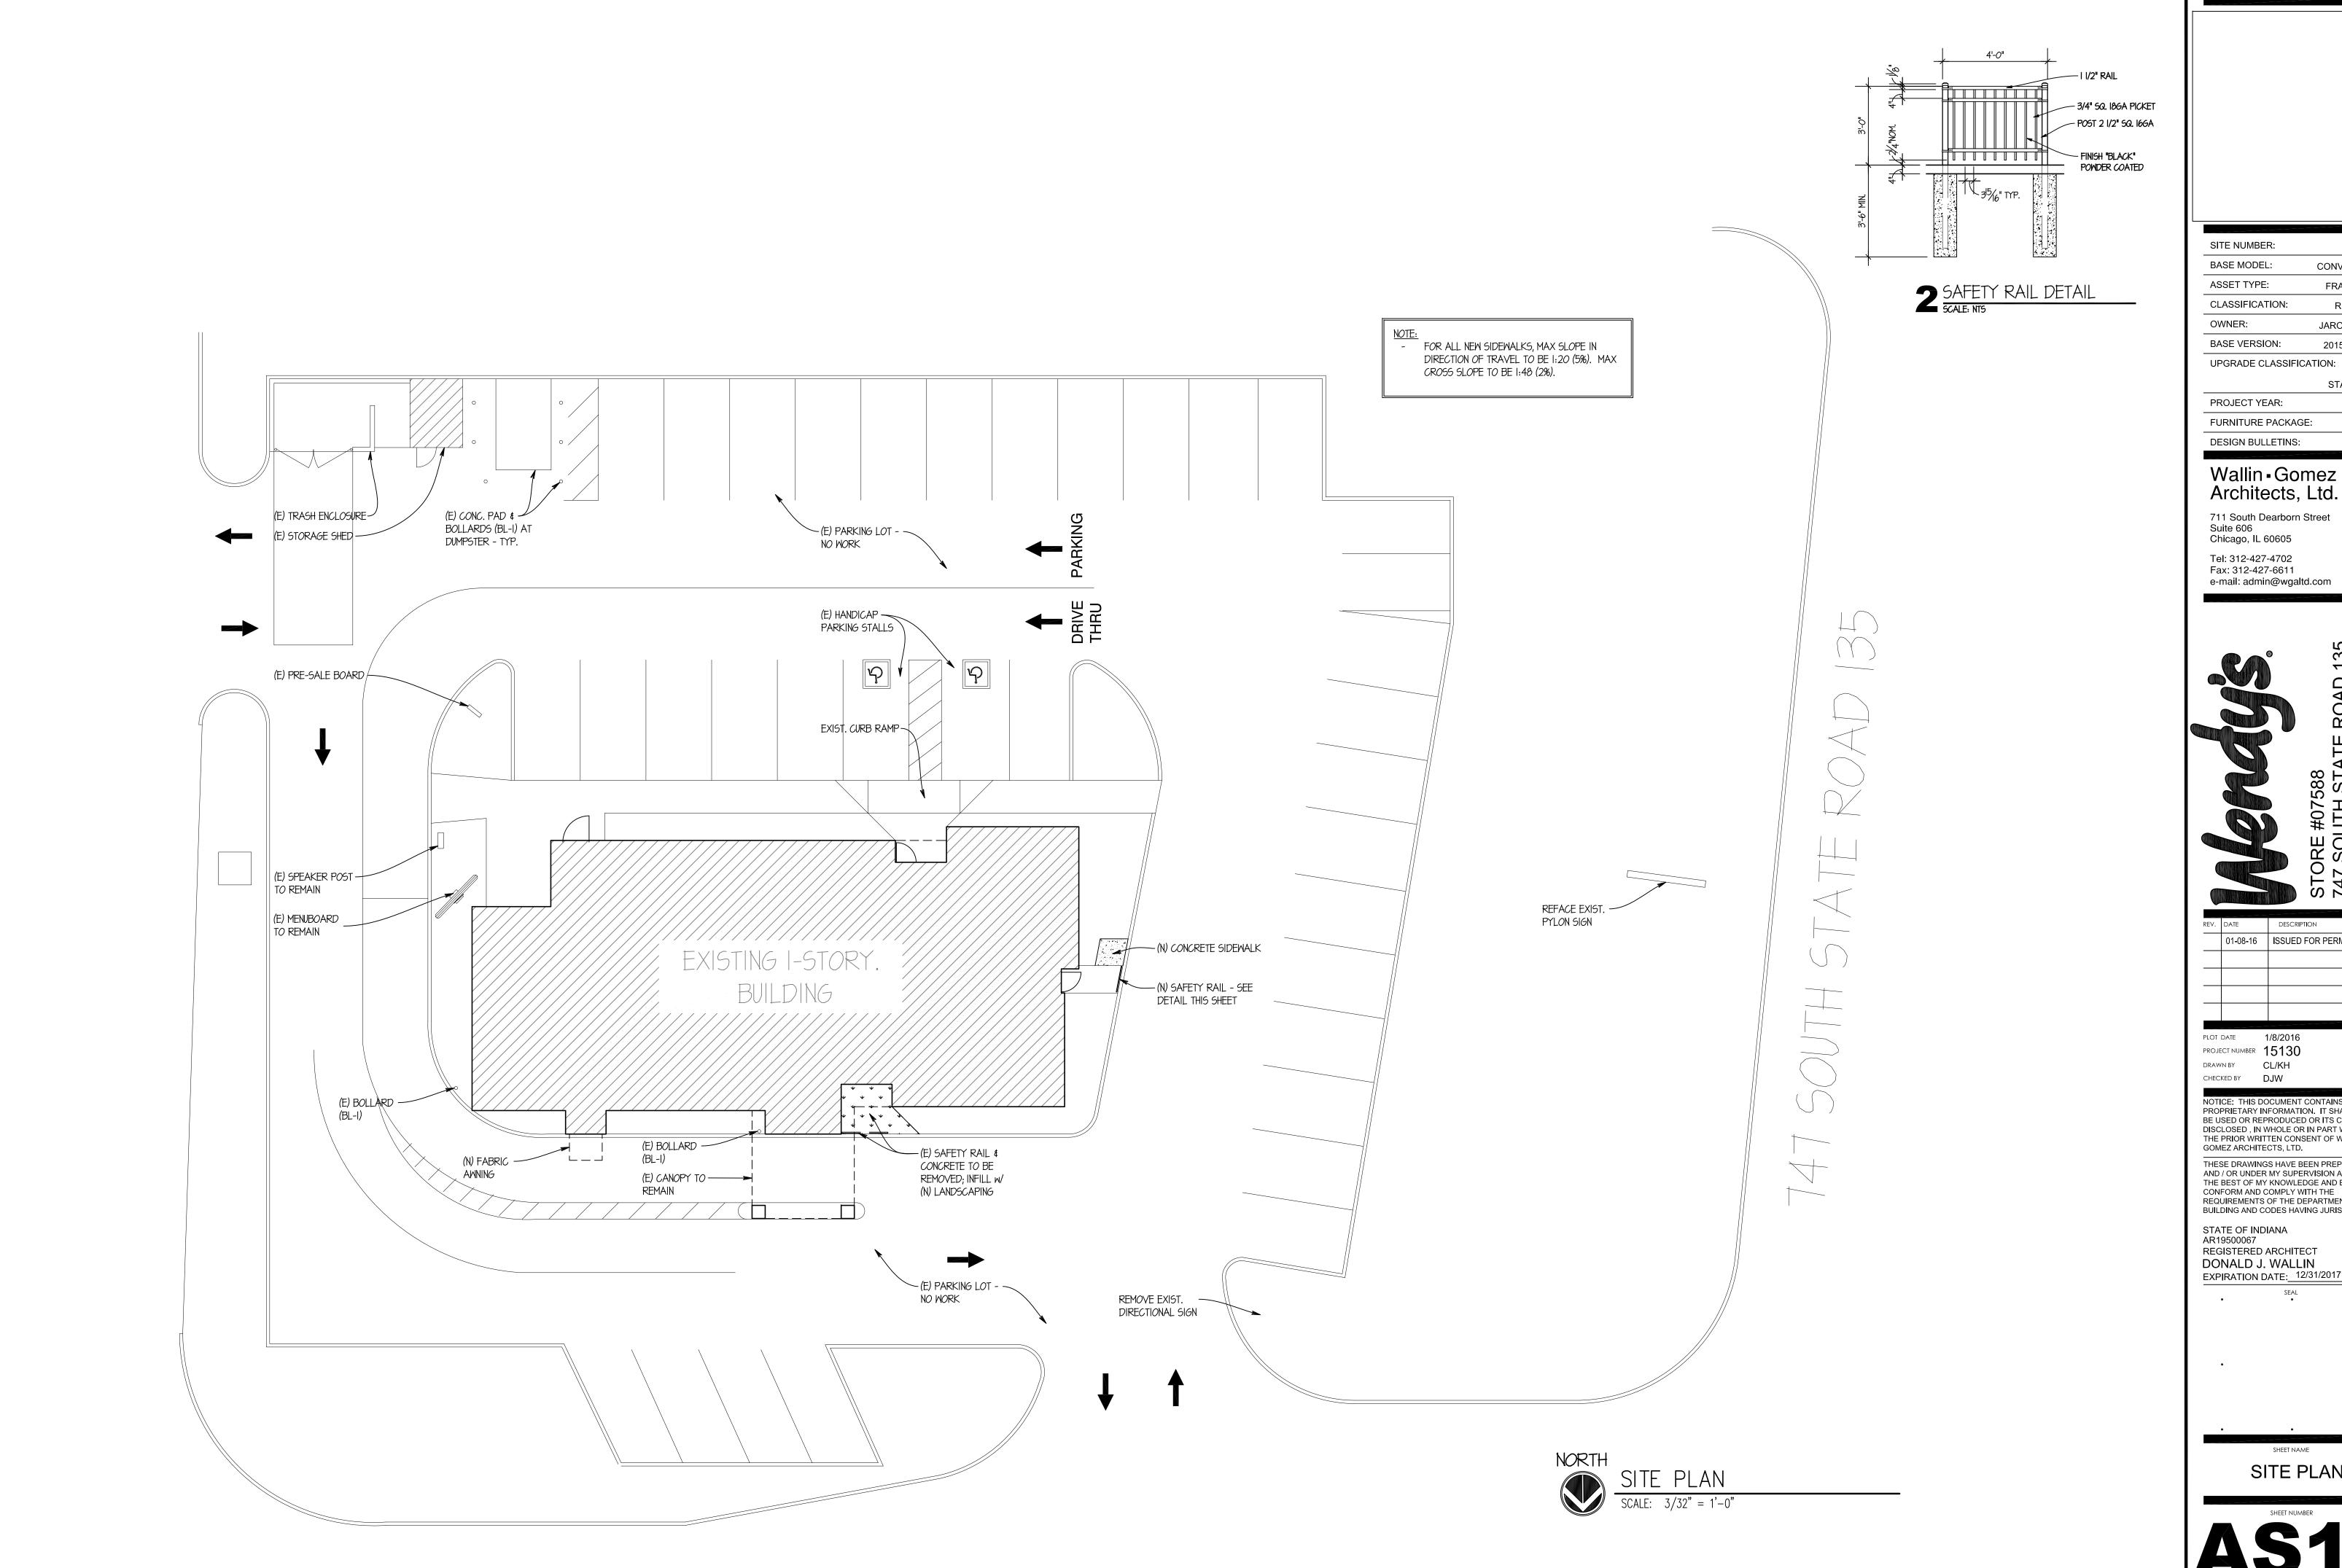

SITE NUMBER: 07588 BASE MODEL: CONVERSION ASSET TYPE: FRANCHISE CLASSIFICATION: REFRESH OWNER: JARO FOODS BASE VERSION: 2015 OCT 16

STANDARD PROJECT YEAR: 2015 FURNITURE PACKAGE: 2015

Wallin - Gomez Architects, Ltd.

711 South Dearborn Street Suite 606 Chicago, IL 60605 Tel: 312-427-4702 Fax: 312-427-6611 e-mail: admin@wgaltd.com

EV.	DATE	DESCRIPTION		
	01-08-16	ISSUED FOR PERMIT & BID		

PLOT DATE PROJECT NUMBER 15130 CHECKED BY DJW

NOTICE: THIS DOCUMENT CONTAINS
PROPRIETARY INFORMATION. IT SHALL NOT
BE USED OR REPRODUCED OR ITS CONTENTS DISCLOSED, IN WHOLE OR IN PART WITHOUT THE PRIOR WRITTEN CONSENT OF WALLIN / GOMEZ ARCHITECTS, LTD.

THESE DRAWINGS HAVE BEEN PREPARED AT AND / OR UNDER MY SUPERVISION AND TO THE BEST OF MY KNOWLEDGE AND BELIEF CONFORM AND COMPLY WITH THE REQUIREMENTS OF THE DEPARTMENT OF BUILDING AND CODES HAVING JURISDICTION.

STATE OF INDIANA AR19500067 REGISTERED ARCHITECT

DONALD J. WALLIN

EXPIRATION DATE: 12/31/2017

SITE PLAN

<u>DEMOLITION GENERAL NOTES</u> THE GENERAL CONTRACTOR SHALL BE RESPONSIBLE FOR ALL DEMOLITION WORK REQUIRED TO IMPLEMENT NEW WORK, AS SHOWN ON OTHER DRAWINGS. THIS PLAN INDICATES ONLY THE APPROXIMATE DEMOLITION REQUIRED FOR COMPLETION OF THIS REMODEL. EXISTING CONDITIONS NOT SHOWN OR NOTED SHALL REMAIN UNCHANGED UNLESS APPROVED BY THE ARCHITECT OR OWNER'S REPRESENTATIVE. ALL EXISTING MATERIALS ADJACENT TO THE NEW CONSTRUCTION SHALL BE PATCHED, REPAIRED, AND FINISHED TO PROVIDE A SMOOTH, LEVEL AND UNNOTICEABLE TRANSITION BETWEEN NEW AND EXISTING FINISHES. CONTRACTOR SHALL VERIFY FIELD CONDITIONS AND NOTIFY WENDY'S REPRESENTATIVE AND ARCHITECT OF ALL DISCREPANCIES BEFORE PROCEEDING WITH WORK. PREVENT MOVEMENT OR SETTLEMENT OF STRUCTURE(S). PROVIDE AND PLACE BRACING OR SHORING TO ENSURE SAFETY AND SUPPORT OF STRUCTURE. G.C. TO ASSUME LIABILITY FOR SUCH MOVEMENT, DAMAGE, OR INJURY. CEASE OPERATIONS AND NOTIFY THE WENDY'S REPRESENTATIVE IMMEDIATELY IF SAFETY OF STRUCTURE APPEARS TO BE COMPROMISED. TAKE PRECAUTIONS TO PROPERLY SUPPORT STRUCTURE. DO NOT RESUME OPERATIONS UNTIL SAFETY IS RESTORED. PROVIDE, ERECT, AND MAINTAIN BARRICADES, LIGHTING, AND GUARD RAILS AS REQUIRED BY APPLICABLE CODES TO PROTECT OCCUPANTS OF BUILDING, WORKERS, AND PEDESTRIANS. BEFORE DISCONNECTING, REMOVING, AND CAPPING UTILITY SERVICES WITHIN AREAS OF DEMOLITION, NOTIFY THE LOCAL UTILITY COMPANY AND WENDY'S REPRESENTATIVE IN ADVANCE AND OBTAIN APPROVAL BEFORE STARTING THE WORK. HVAC SUBCONTRACTOR TO INSPECT EXISTING CONDITIONS PRIOR TO DEMOLITION, AND DETERMINE WHETHER ANY COMPRESSOR REFRIGERANT LINES ARE PRESENT THAT MUST BE PROPERLY DRAINED (TO E.P.A. STANDARDS) PRIOR TO DEMOLITION. PLACE MARKERS TO INDICATE LOCATION OF DISCONNECTED SERVICES. IDENTIFY SERVICE LINES AND CAPPING LOCATIONS ON PROJECT RECORD DOCUMENTS. EXCEPT WHERE NOTED OTHERWISE, MAINTAIN POSSESSION OF MATERIALS BEING DEMOLISHED. IMMEDIATELY REMOVE FROM 10. DEMOLISH IN AN ORDERLY AND CAREFUL MANNER AS REQUIRED TO ACCOMMODATE NEW WORK, INCLUDING THAT REQUIRED FOR CONNECTION TO THE EXISTING BUILDING. PROTECT EXISTING FOUNDATIONS AND SUPPORTING STRUCTURAL MEMBERS. PERFORM DEMOLITION IN ACCORDANCE WITH APPLICABLE AUTHORITIES HAVING JURISDICTION. 12. REPAIR ALL DEMOLITION PERFORMED IN EXCESS OF THAT REQUIRED, AT NO COST TO OWNER. 13. BURNING OF MATERIALS ON SITE IS NOT PERMITTED. 14. REMOVE DEMOLISHED MATERIALS, TOOLS, AND EQUIPMENT FROM SITE UPON COMPLETION OF WORK. LEAVE SITE IN CONDITION ACCEPTABLE TO WENDY'S REPRESENTATIVE. WENDY'S VENDOR TO REMOVE ALL F.F.&E. PRIOR TO G.C.'S DEMOLITION START. G.C. TO PROTECT AND SHRINK-WRAP REMAINING F.F.&E. NOT AFFECTED BY REMODEL WORK FOR DURATION OF REMODEL. G.C. TO COORDINATE WITH WENDY'S REPRESENTATIVE. PRIOR TO BID SUBMISSION, THE G.C. SHALL MAKE A SITE VISIT TO REVIEW THE DEMOLITION REQUIREMENTS INCLUDING, BUT NOT LIMITED TO SITE WORK, EXTERIOR & INTERIOR OF THE EXISTING STRUCTURE, REVIEW M.E.P. DRAWINGS FOR DEMOLITION REQUIREMENTS / UTILITY RELOCATIONS. COORDINATE ALL DEMOLITION WITH WENDY'S REPRESENTATIVE. REMOVE EXISTING FLOOR & WALL FINISHES AS NOTED AND AS REQUIRED FOR NEW FINISHES. CLEAN, PREP, AND REPAIR ALL SUBSTRATES TO SPECIFICATION REQUIREMENTS OF NEW SCHEDULE FINISHES. 18. DISCONNECT AND/OR REMOVE ALL UNUSED / ABANDONED ELECTRICAL CIRCUITS FROM ELECTRICAL SOURCE PER CODE. 19. CAP, DISCONNECT AND/OR REMOVE ALL PLUMBING LINES NOTED FOR DEMOLITION ACCORDANCE WITH CODE. 20. WHENEVER PRACTICAL TO DO SO AND/OR AS DIRECTED BY WENDY'S REPRESENTATIVE ALL UNUSED UTILITIES SHALL BE REMOVED IN THEIR ENTIRETY. REMOVE (E) FINISHES AND TRIM THROUGHOUT DINING ROOM, HALL, VESTIBULE & RESTROOMS AS REQUIRED FOR NEW WORK. EXISTING GYPSUM BOARD TO REMAIN IF POSSIBLE EXCEPT WHERE SPECIFICALLY NOTED OTHERWISE. 22. G.C. TO PHOTOGRAPH AND DOCUMENT THE LOCATION OF ALL KITCHEN AND SERVICE AREA EQUIPMENT PRIOR TO THE START OF CONSTRUCTION

112


COOLER

111


110

I. DISCONNECT & REMOVE EXISTING PLUMBING FIXTURES INCLUDING BUT NOT LIMITED TO WATER CLOSETS, URINALS, AND

- LAVATORIES AS REQUIRED FOR NEW WORK. 2. REMOVE EXISTING RESTROOM ACCESSORIES.
- 3. REMOVE EXISTING FLOOR & WALL FINISHES THROUGHOUT THE RESTROOMS. CLEAN, PREP, & REPAIR ALL SUBSTRATES TO SPECIFICATION REQUIREMENTS OF NEW SCHEDULED FINISHES. REPLACE SUBSTRATES AS REQUIRED, DO NOT ADD LAYERS OF SUBSTRATES, ADA CLEARANCES MAY BE VIOLATED WITH THE ADDITION OF (N) LAYERS OF MATERIALS.
- 4. REMOVE EXISTING TOILET PARTITIONS AND ASSOCIATED HARDWARE.
- REMOVE & REPLACE DAMAGED SUBSTRATES AS REQUIRED AND IN ACCORDANCE WITH REQUIREMENTS OF NEW SCHEDULED FINISHES. NOTIFY PROJECT ARCHITECT & WENDY'S REPRESENTATIVE OF ANY HAZARDOUS CONTAINING MATERIALS ENCOUNTERED DURING DEMOLITION THAT MAY NEED TESTING OR REMEDIATION.

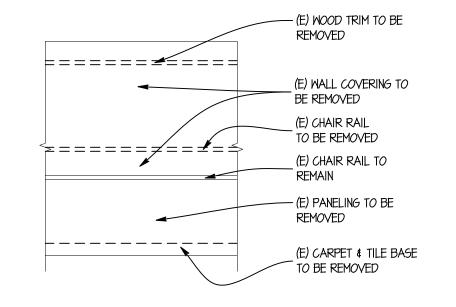

EXISTING INTERIOR ELEVATION

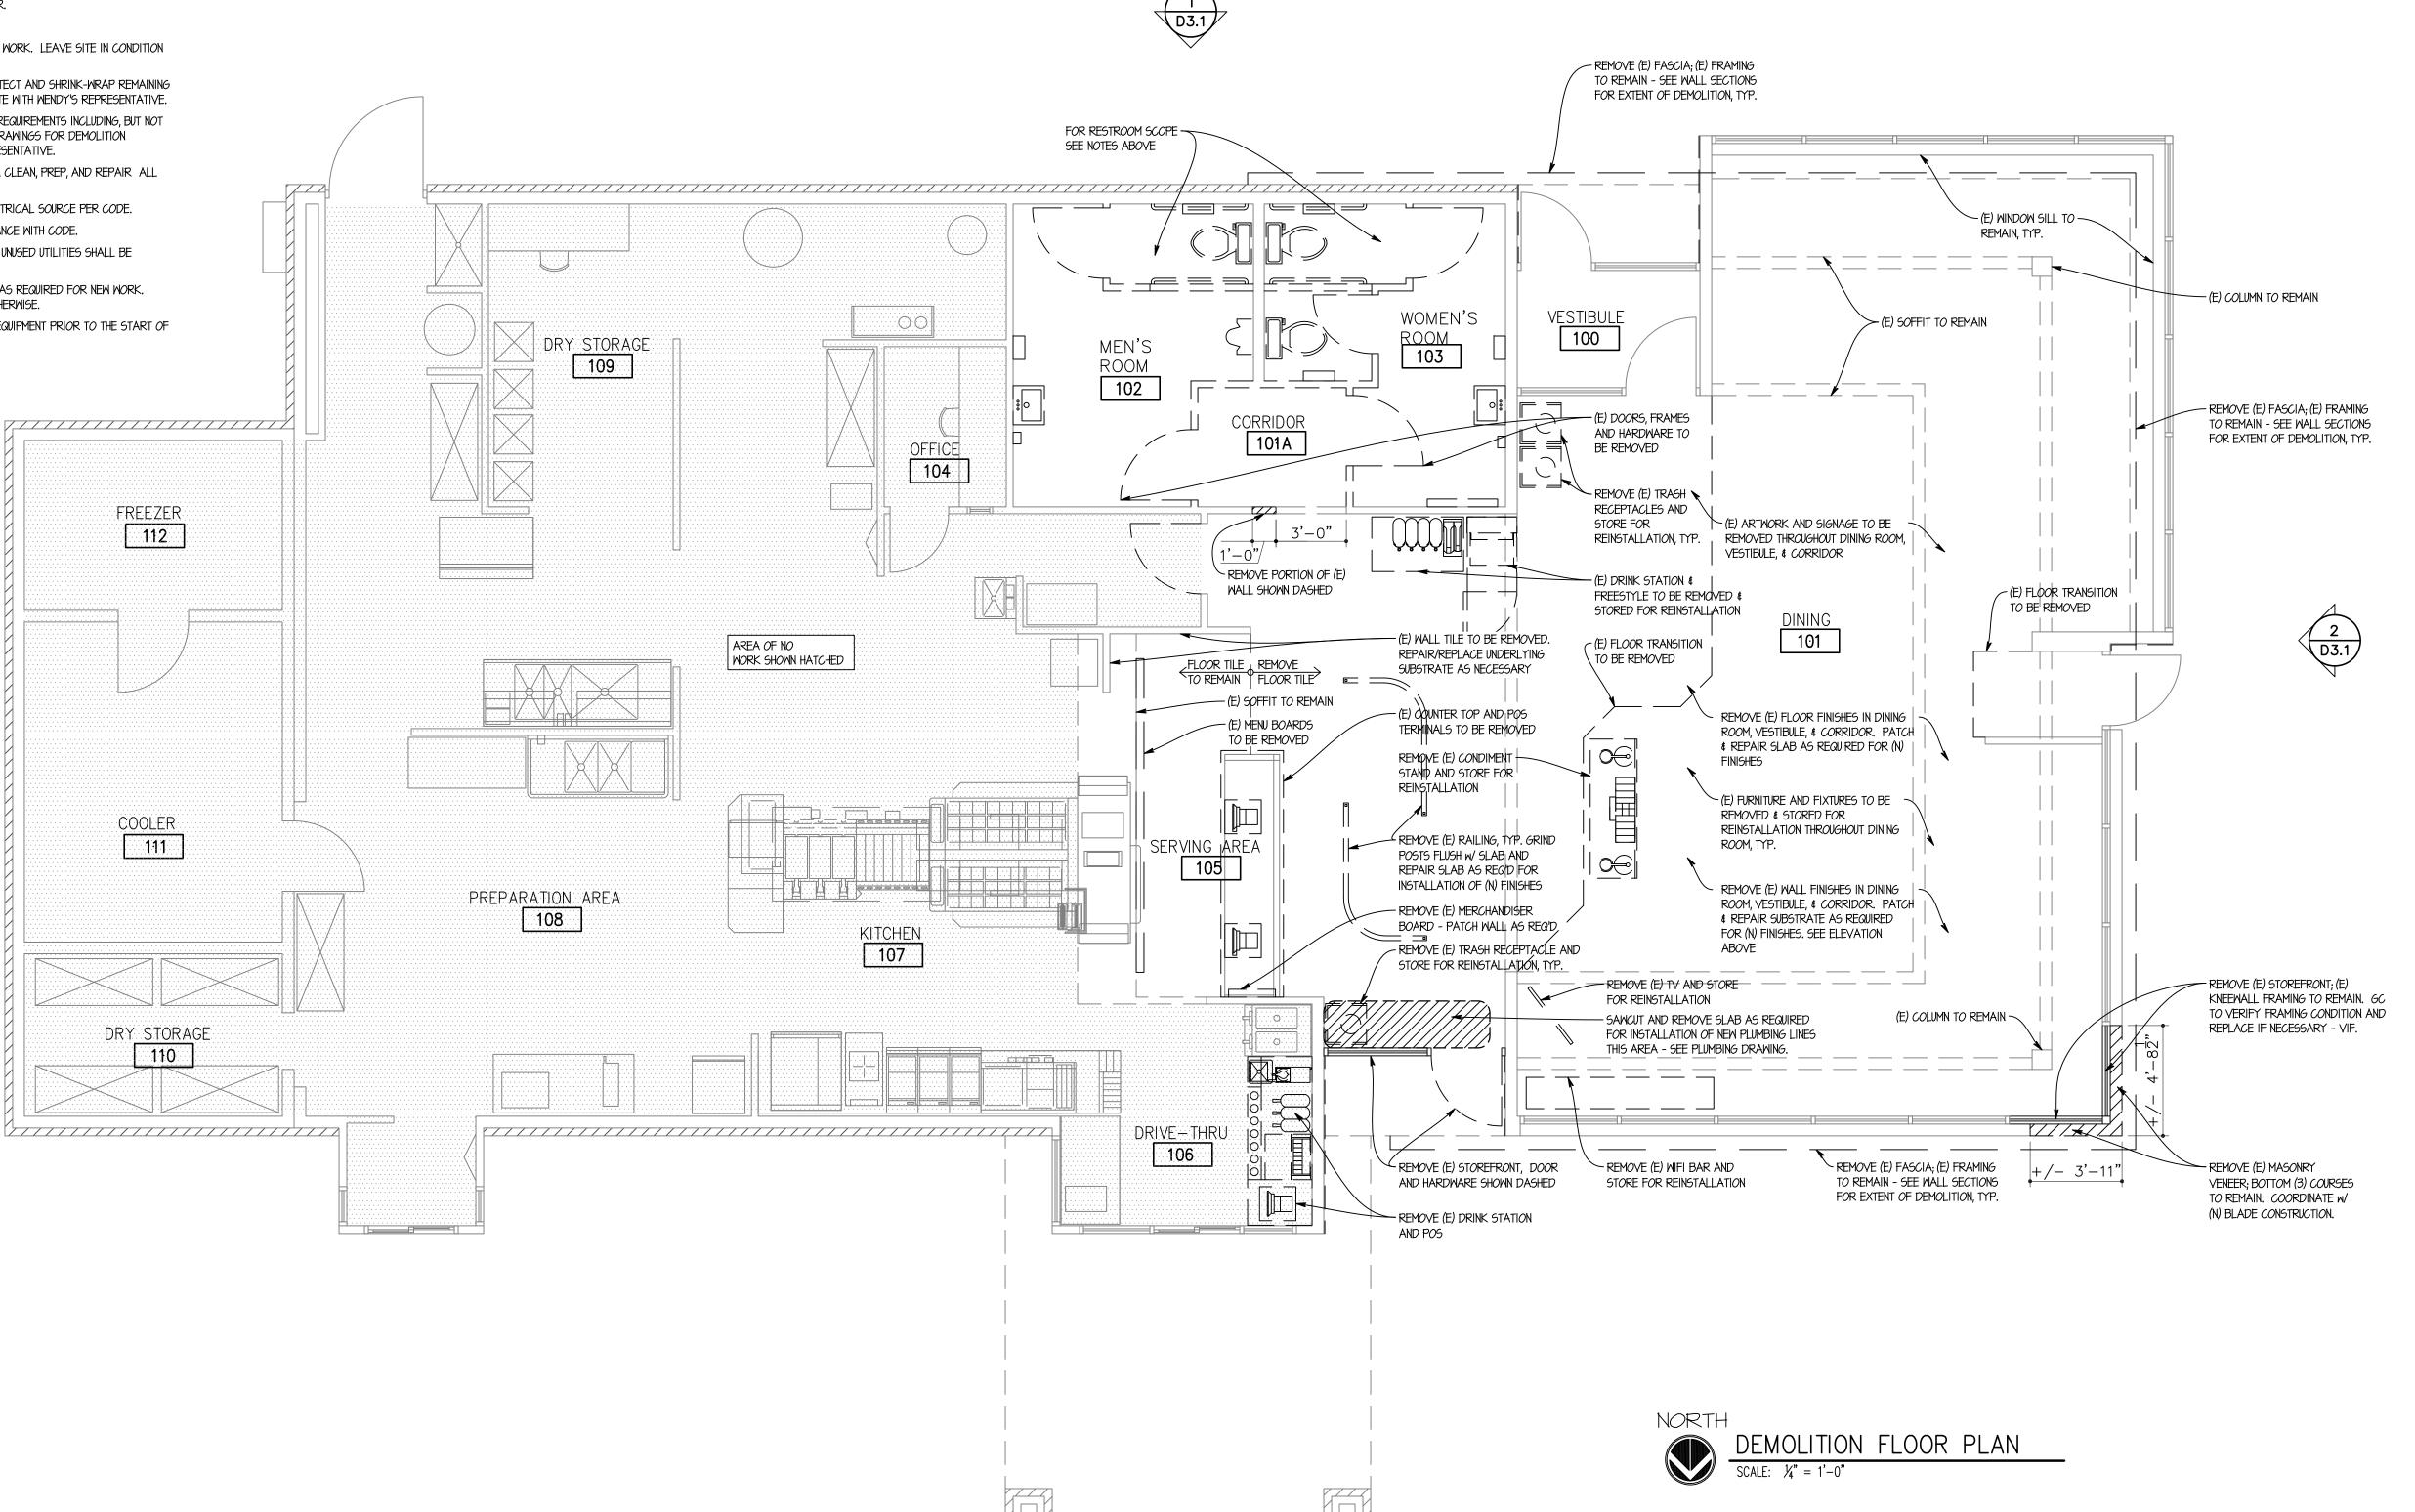

SITE NUMBER: 07588 BASE MODEL: CONVERSION ASSET TYPE: FRANCHISE CLASSIFICATION: REFRESH OWNER: JARO FOODS BASE VERSION: 2015 OCT 16 UPGRADE CLASSIFICATION:

STANDARD PROJECT YEAR: 2015 FURNITURE PACKAGE: DESIGN BULLETINS:

Wallin - Gomez Architects, Ltd

711 South Dearborn Street Suite 606 Chicago, IL 60605 Tel: 312-427-4702

Fax: 312-427-6611 e-mail: admin@wgaltd.com




	The state of the s					
٧.	DATE	DESCRIPTION				
	01-08-16	ISSUED FOR PERMIT & BID				

PLOT DATE 1/8/2016 PROJECT NUMBER 15130 DRAWN BY CL/KH CHECKED BY DJW


NOTICE: THIS DOCUMENT CONTA PROPRIETARY INFORMATION. IT SHALL NOT BE USED OR REPRODUCED OR ITS CONTENTS DISCLOSED, IN WHOLE OR IN PART WITHOUT THE PRIOR WRITTEN CONSENT OF WALLIN / GOMEZ ARCHITECTS, LTD.

THESE DRAWINGS HAVE BEEN PREPARED AT AND / OR UNDER MY SUPERVISION AND TO THE BEST OF MY KNOWLEDGE AND BELIEF CONFORM AND COMPLY WITH THE REQUIREMENTS OF THE DEPARTMENT OF BUILDING AND CODES HAVING JURISDICTION.

STATE OF INDIANA AR19500067 REGISTERED ARCHITECT DONALD J. WALLIN EXPIRATION DATE: 12/31/2017

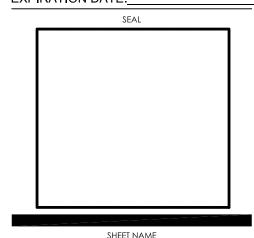

DEMOLITION **FLOOR PLAN**

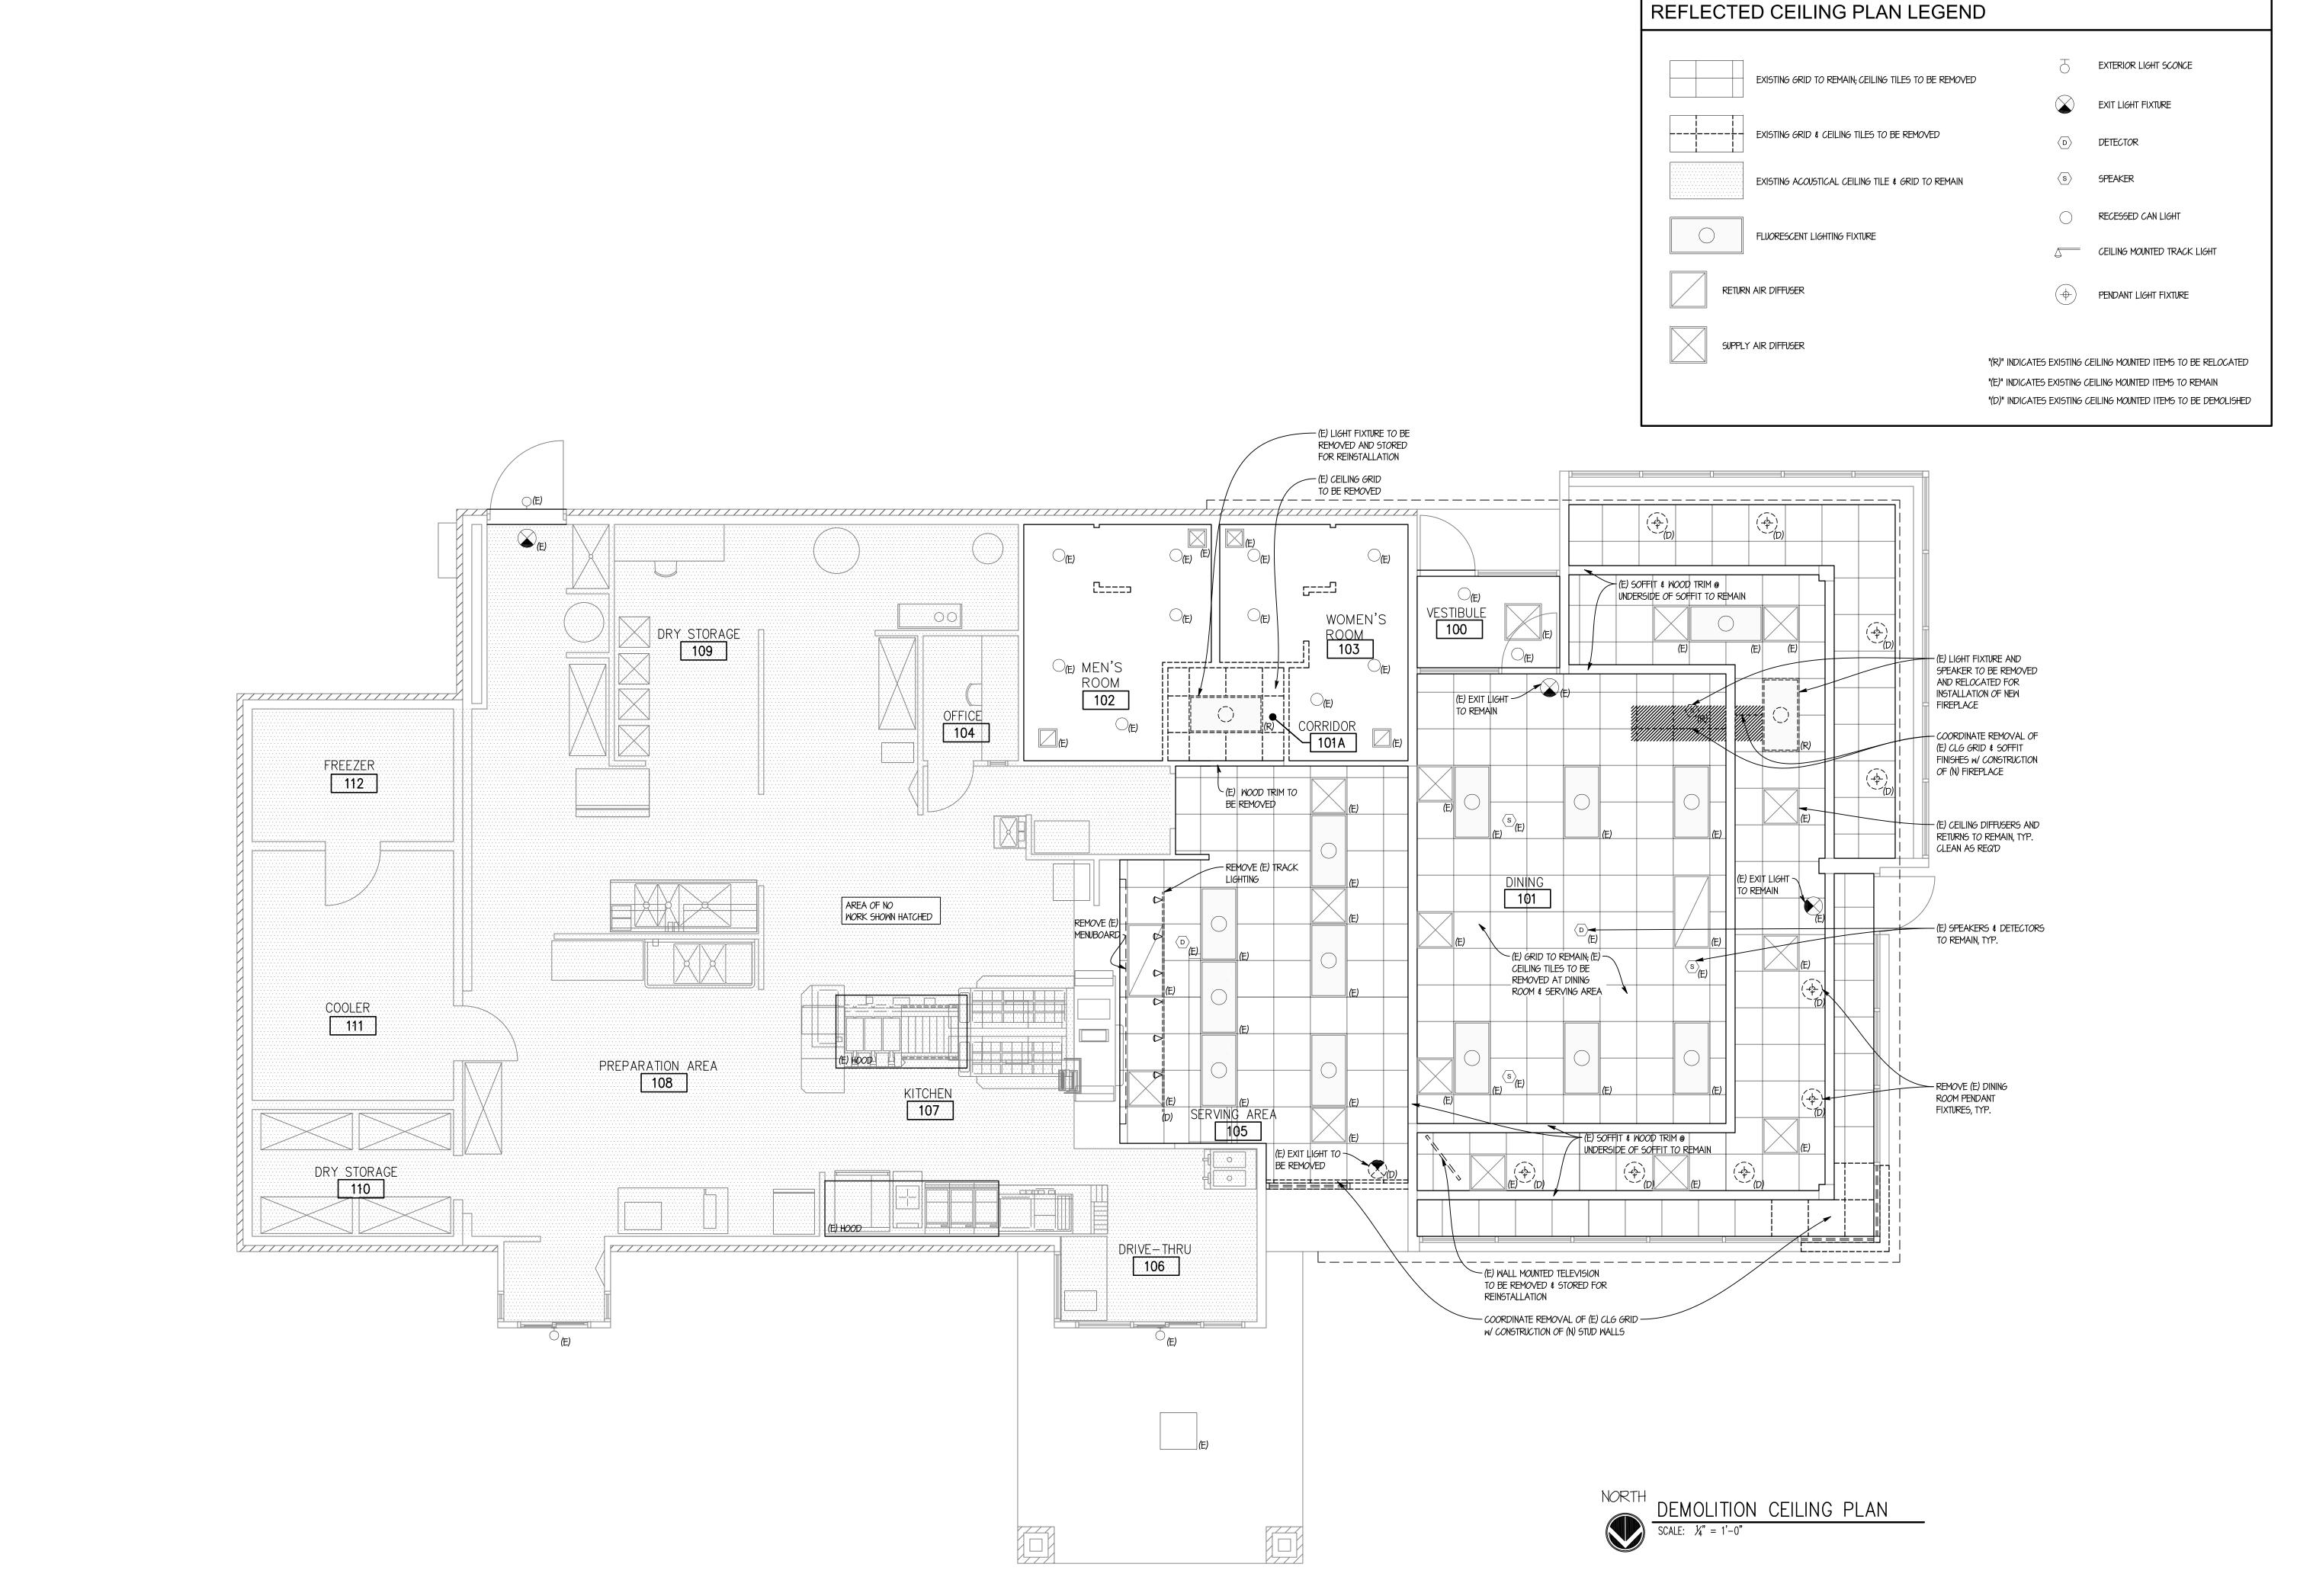

SITE NUMBER: 07588 BASE MODEL: CONVERSION ASSET TYPE: FRANCHISE CLASSIFICATION: REFRESH OWNER: JARO FOODS BASE VERSION: 2015 OCT 16 UPGRADE CLASSIFICATION: STANDARD PROJECT YEAR: 2015 FURNITURE PACKAGE: DESIGN BULLETINS:

Wallin - Gomez Architects, Ltd.

711 South Dearborn Street Suite 606 Chicago, IL 60605 Tel: 312-427-4702 Fax: 312-427-6611

Fax: 312-427-6611 e-mail: admin@wgaltd.com

STORE #07588

_	MORPHONISTY / / MARK	9714 0
REV.	DATE	DESCRIPTION
	01-08-16	ISSUED FOR PERMIT & BID
-		

PLOT DATE 1/8/2016
PROJECT NUMBER 15130
DRAWN BY CL/KH
CHECKED BY DJW


NOTICE: THIS DOCUMENT CONTAINS
PROPRIETARY INFORMATION. IT SHALL NOT
BE USED OR REPRODUCED OR ITS CONTENTS
DISCLOSED, IN WHOLE OR IN PART WITHOUT
THE PRIOR WRITTEN CONSENT OF WALLIN /
GOMEZ ARCHITECTS, LTD.


THESE DRAWINGS HAVE BEEN PREPARED AT AND / OR UNDER MY SUPERVISION AND TO THE BEST OF MY KNOWLEDGE AND BELIEF CONFORM AND COMPLY WITH THE REQUIREMENTS OF THE DEPARTMENT OF BUILDING AND CODES HAVING JURISDICTION.


STATE OF INDIANA
AR19500067
REGISTERED ARCHITECT
DONALD J. WALLIN
EXPIRATION DATE: 12/31/2017

SEAL

DEMOLITION
CEILING PLAN

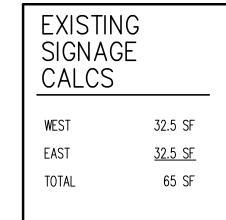

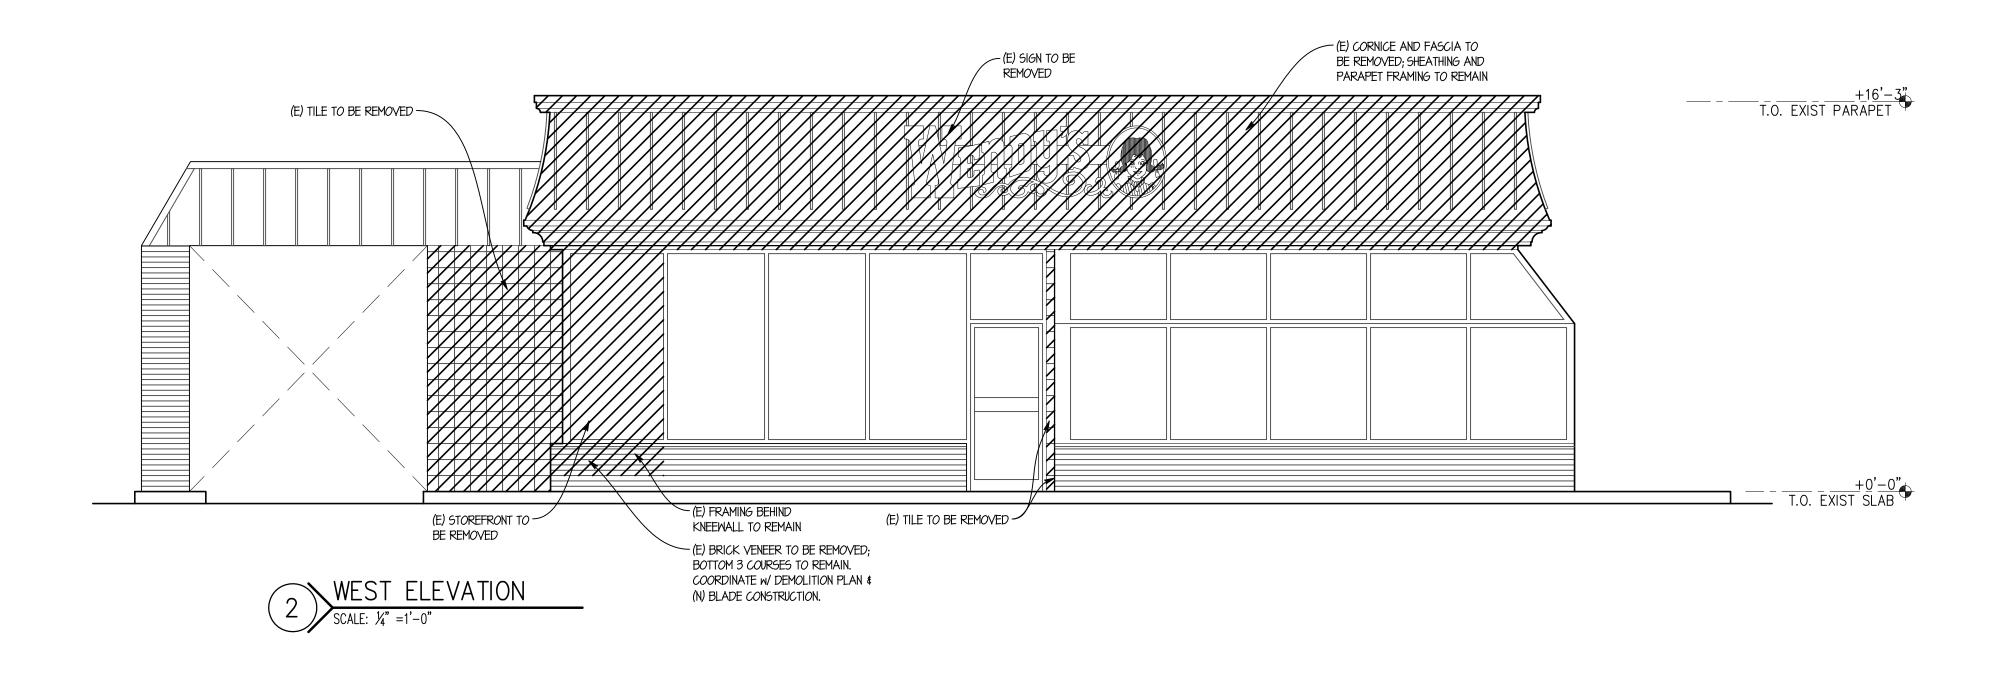

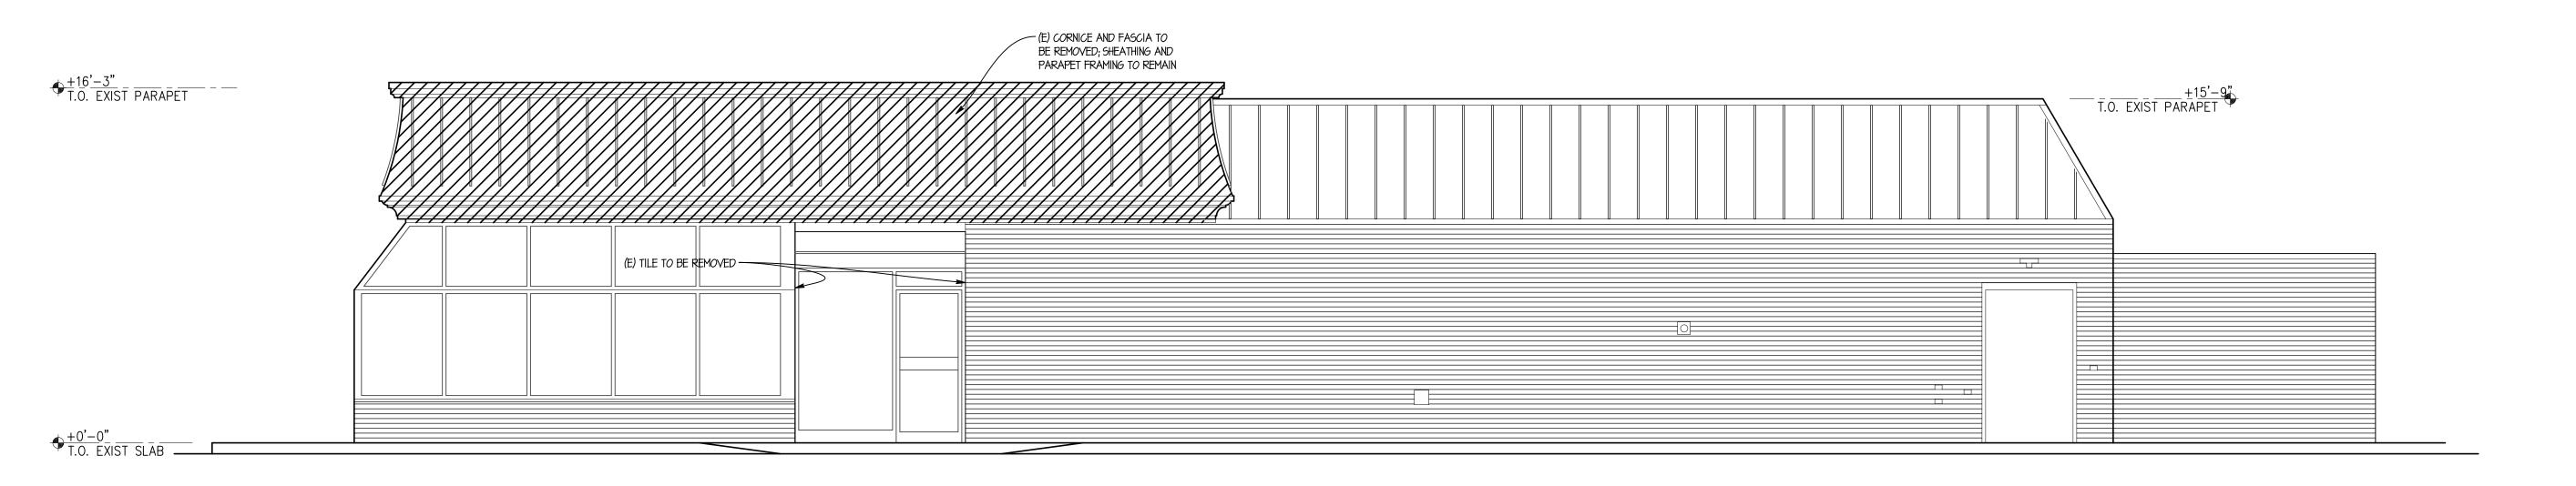

SITE NUMBER:	07588
BASE MODEL:	CONVERSION
ASSET TYPE:	FRANCHISE
CLASSIFICATION:	REFRESH
OWNER:	JARO FOODS
BASE VERSION:	2015 OCT 16
UPGRADE CLASSIFICAT	TION:
	STANDARD
PROJECT YEAR:	2015
FURNITURE PACKAGE:	2015
DESIGN BULLETINS:	

Wallin • Gomez Architects, Ltd.

711 South Dearborn Street Suite 606 Chicago, IL 60605

Tel: 312-427-4702 Fax: 312-427-6611 e-mail: admin@wgaltd.com


W	MINISTERNATION AND A MINISTER OF THE PART					
REV.	DATE	DESCRIPTION				
	01-08-16	ISSUED FOR PERMIT & BID				

PROJECT NUMBER 15130 DRAWN BY CL/KH CHECKED BY DJW


NOTICE: THIS DOCUMENT CONTAINS
PROPRIETARY INFORMATION. IT SHALL NOT
BE USED OR REPRODUCED OR ITS CONTENTS
DISCLOSED, IN WHOLE OR IN PART WITHOUT
THE PRIOR WRITTEN CONSENT OF WALLIN /
GOMEZ ARCHITECTS, LTD.


THESE DRAWINGS HAVE BEEN PREPARED AT AND / OR UNDER MY SUPERVISION AND TO THE BEST OF MY KNOWLEDGE AND BELIEF CONFORM AND COMPLY WITH THE REQUIREMENTS OF THE DEPARTMENT OF BUILDING AND CODES HAVING JURISDICTION.

STATE OF INDIANA AR19500067 REGISTERED ARCHITECT
DONALD J. WALLIN
EXPIRATION DATE: 12/31/2017

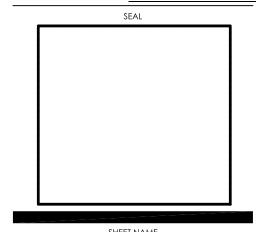


SHEET NAME
DEMOLITION
ELEVATIONS

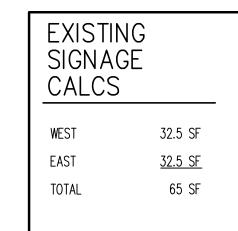

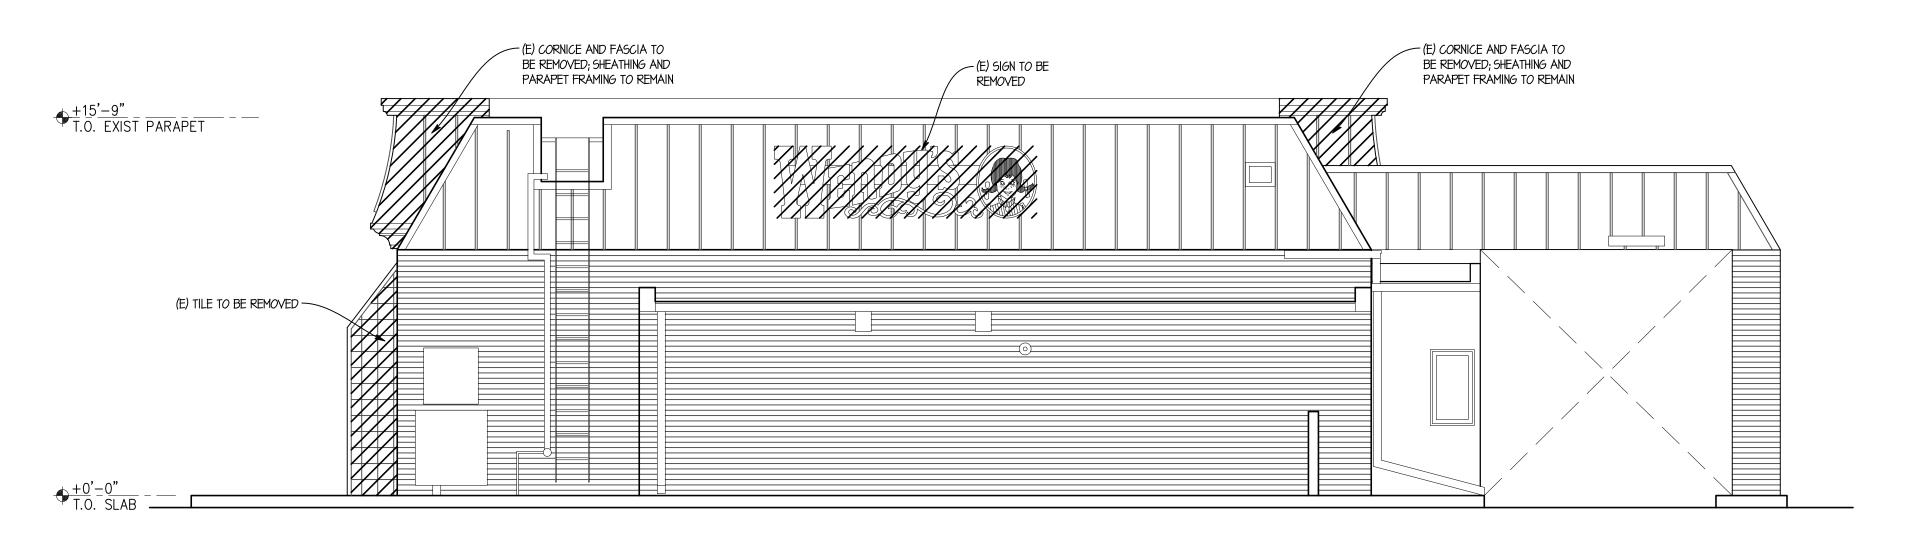



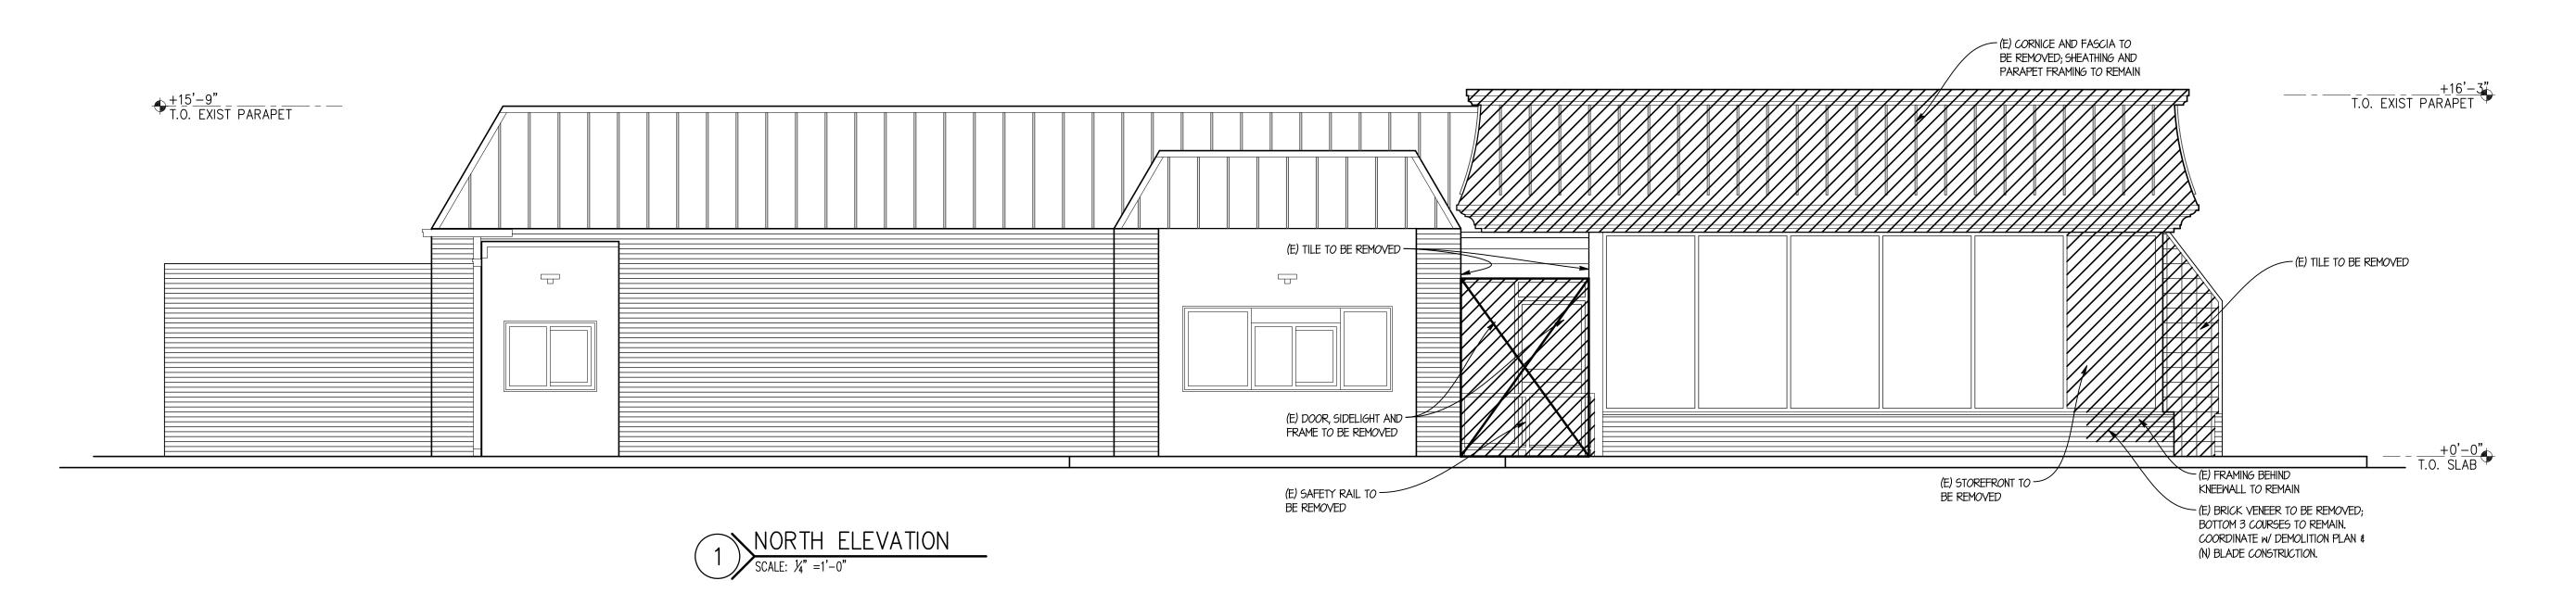

SITE NUMBER:	07588
BASE MODEL:	CONVERSION
ASSET TYPE:	FRANCHISE
CLASSIFICATION:	REFRESH
OWNER:	JARO FOODS
BASE VERSION:	2015 OCT 16
UPGRADE CLASSIFICA	TION:
	STANDARD
PROJECT YEAR:	2015
FURNITURE PACKAGE:	2015
DESIGN BULLETINS:	

Wallin • Gomez Architects, Ltd.

711 South Dearborn Street Suite 606 Chicago, IL 60605 Tel: 312-427-4702

Tel: 312-427-4702 Fax: 312-427-6611 e-mail: admin@wgaltd.com




	REV.	DATE	DESCRIPTION				
		01-08-16	ISSUED FOR PERMIT & BID				

PLOT DATE 1/8/2016
PROJECT NUMBER 15130
DRAWN BY CL/KH
CHECKED BY DJW

NOTICE: THIS DOCUMENT CONTAINS
PROPRIETARY INFORMATION. IT SHALL NOT
BE USED OR REPRODUCED OR ITS CONTENTS
DISCLOSED, IN WHOLE OR IN PART WITHOUT
THE PRIOR WRITTEN CONSENT OF WALLIN /
GOMEZ ARCHITECTS, LTD.

THESE DRAWINGS HAVE BEEN PREPARED AT AND / OR UNDER MY SUPERVISION AND TO THE BEST OF MY KNOWLEDGE AND BELIEF CONFORM AND COMPLY WITH THE REQUIREMENTS OF THE DEPARTMENT OF BUILDING AND CODES HAVING JURISDICTION.


STATE OF INDIANA
AR19500067
REGISTERED ARCHITECT
DONALD J. WALLIN
EXPIRATION DATE: 12/31/2017

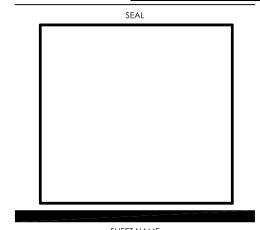

DEMOLITION ELEVATIONS

SHEET NUMBER

D3.2

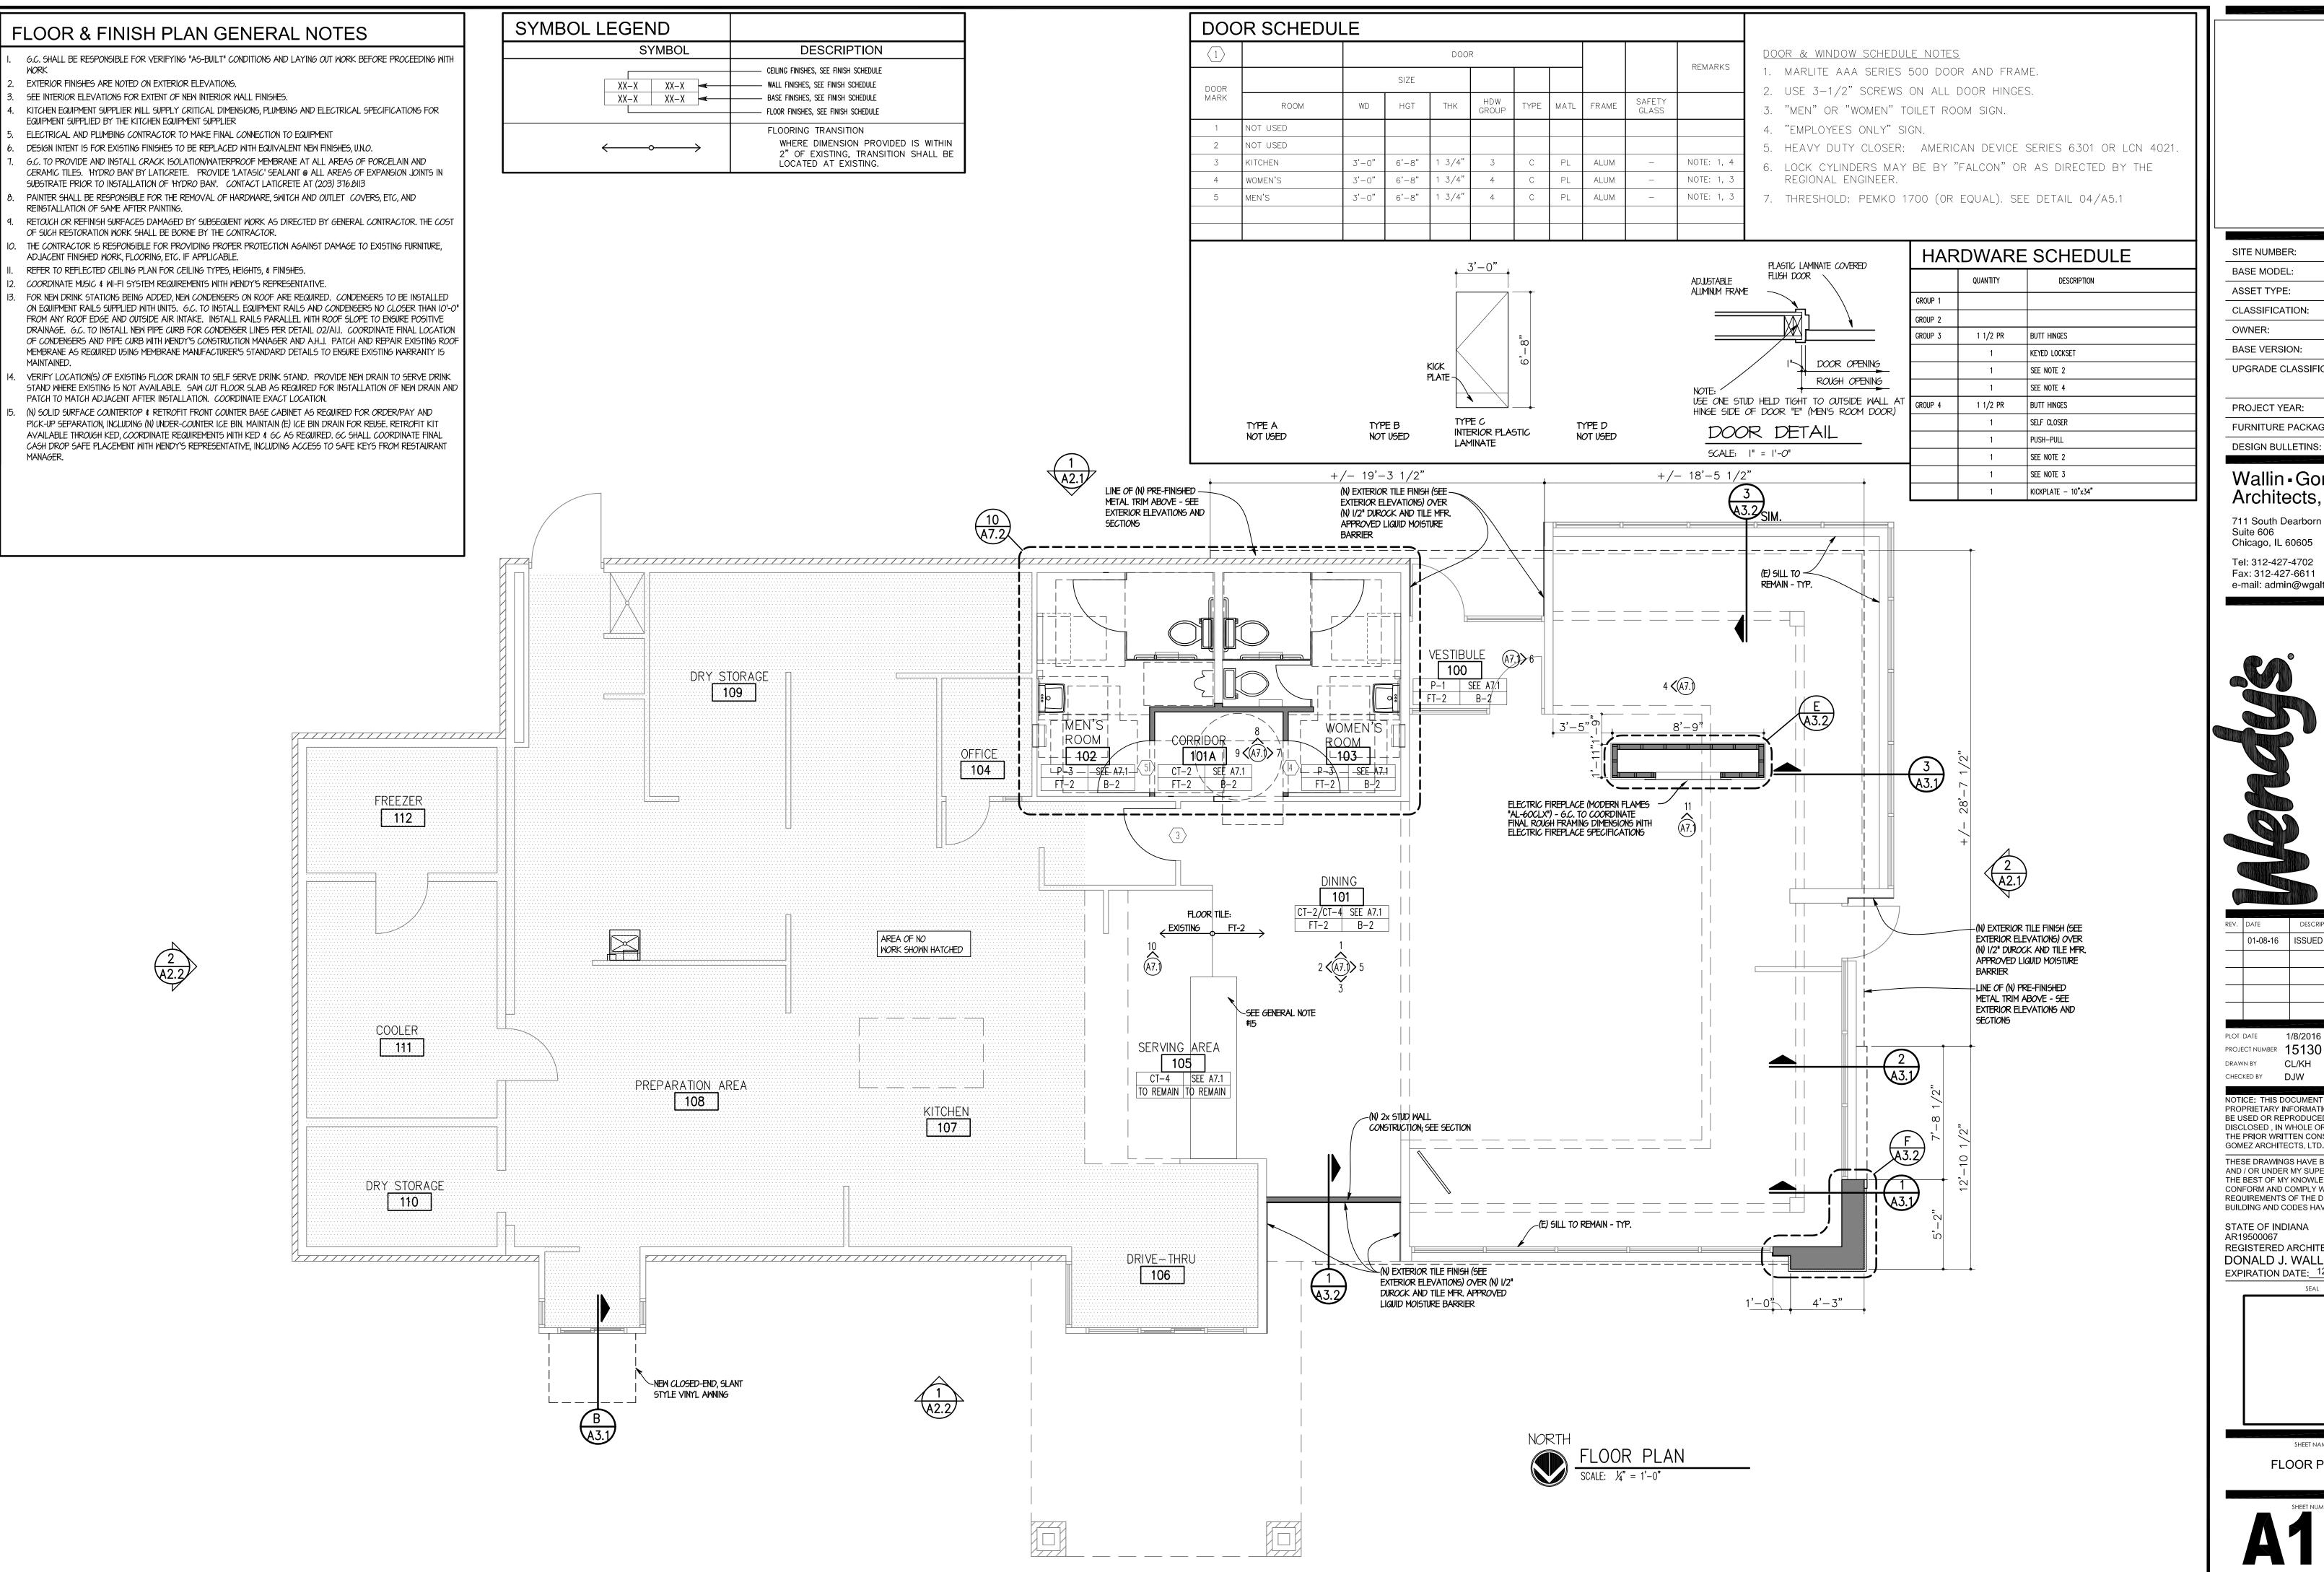

SITE NUMBER: BASE MODEL: CONVERSION ASSET TYPE: FRANCHISE CLASSIFICATION: REFRESH OWNER: JARO FOODS BASE VERSION: 2015 OCT 16 UPGRADE CLASSIFICATION:

STANDARD PROJECT YEAR: 2015 FURNITURE PACKAGE: 2015

Wallin - Gomez Architects, Ltd

711 South Dearborn Street Suite 606 Chicago, IL 60605 Tel: 312-427-4702

Fax: 312-427-6611 e-mail: admin@wgaltd.com


01-08-16 ISSUED FOR PERMIT & BID

PLOT DATE 1/8/2016 PROJECT NUMBER 15130 DRAWN BY CL/KH CHECKED BY DJW


NOTICE: THIS DOCUMENT CONT. PROPRIETARY INFORMATION. IT SHALL NOT BE USED OR REPRODUCED OR ITS CONTENTS DISCLOSED, IN WHOLE OR IN PART WITHOUT THE PRIOR WRITTEN CONSENT OF WALLIN / GOMEZ ARCHITECTS, LTD.


THESE DRAWINGS HAVE BEEN PREPARED AT AND / OR UNDER MY SUPERVISION AND TO THE BEST OF MY KNOWLEDGE AND BELIEF CONFORM AND COMPLY WITH THE REQUIREMENTS OF THE DEPARTMENT OF BUILDING AND CODES HAVING JURISDICTION.

STATE OF INDIANA AR19500067 REGISTERED ARCHITECT DONALD J. WALLIN EXPIRATION DATE: 12/31/2017

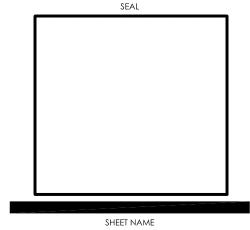

FLOOR PLAN

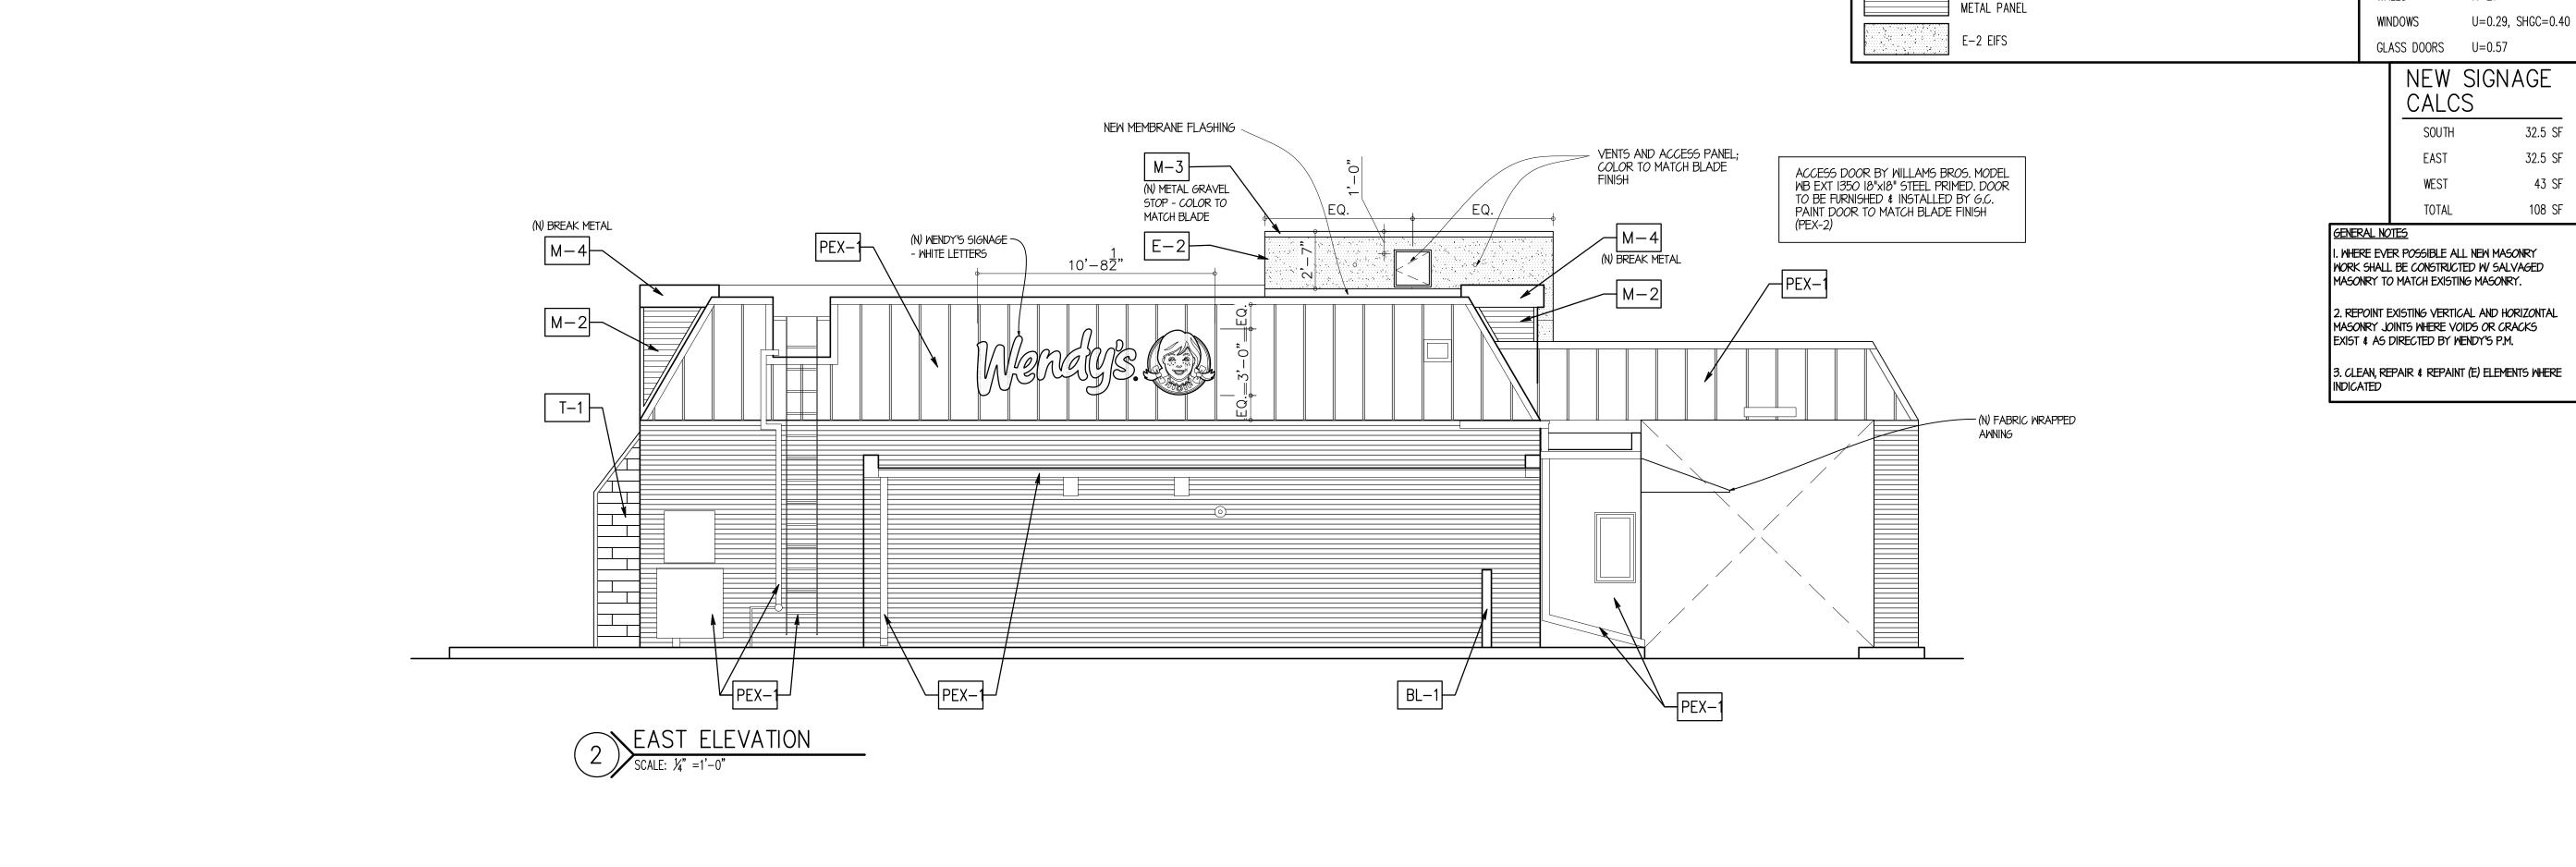

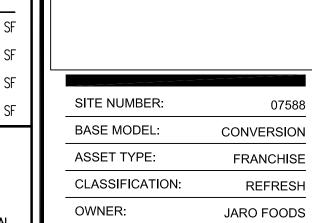

BASE VERSION:

DESIGN BULLETINS:

ENVELOPE

R00F

WALLS

COMPLIANCE

R-20

R-21

NOTE: REFER TO MATERIAL/FINISH/RESPONSIBILITY SCHEDULE ON SHEET A6.I FOR SPECIFICATIONS OF ALL EXTERIOR MATERIALS AND FINISHES.

T-1, EXTERIOR TILE

M-2, CORRUGATED

UPGRADE CLASSIFICATION: STANDARD PROJECT YEAR: 2015 FURNITURE PACKAGE: 2015

07588

2015 OCT 16

Wallin - Gomez Architects, Ltd.

711 South Dearborn Street Suite 606 Chicago, IL 60605 Tel: 312-427-4702

Fax: 312-427-6611 e-mail: admin@wgaltd.com


	umas s s ita ins as s & 14 A Alak IV	
REV.	DATE	DESCRIPTION
	01-08-16	ISSUED FOR PERMIT & BID

PLOT DATE 1/8/2016 PROJECT NUMBER 15130 DRAWN BY CL/KH CHECKED BY DJW


NOTICE: THIS DOCUMENT CONTAINS PROPRIETARY INFORMATION. IT SHALL NOT BE USED OR REPRODUCED OR ITS CONTENTS DISCLOSED , IN WHOLE OR IN PART WITHOUT THE PRIOR WRITTEN CONSENT OF WALLIN / GOMEZ ARCHITECTS, LTD.


THESE DRAWINGS HAVE BEEN PREPARED AT AND / OR UNDER MY SUPERVISION AND TO THE BEST OF MY KNOWLEDGE AND BELIEF CONFORM AND COMPLY WITH THE REQUIREMENTS OF THE DEPARTMENT OF BUILDING AND CODES HAVING JURISDICTION.


STATE OF INDIANA AR19500067 REGISTERED ARCHITECT DONALD J. WALLIN EXPIRATION DATE: 12/31/2017

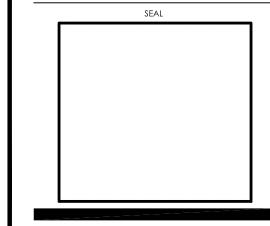


EXTERIOR ELEVATIONS

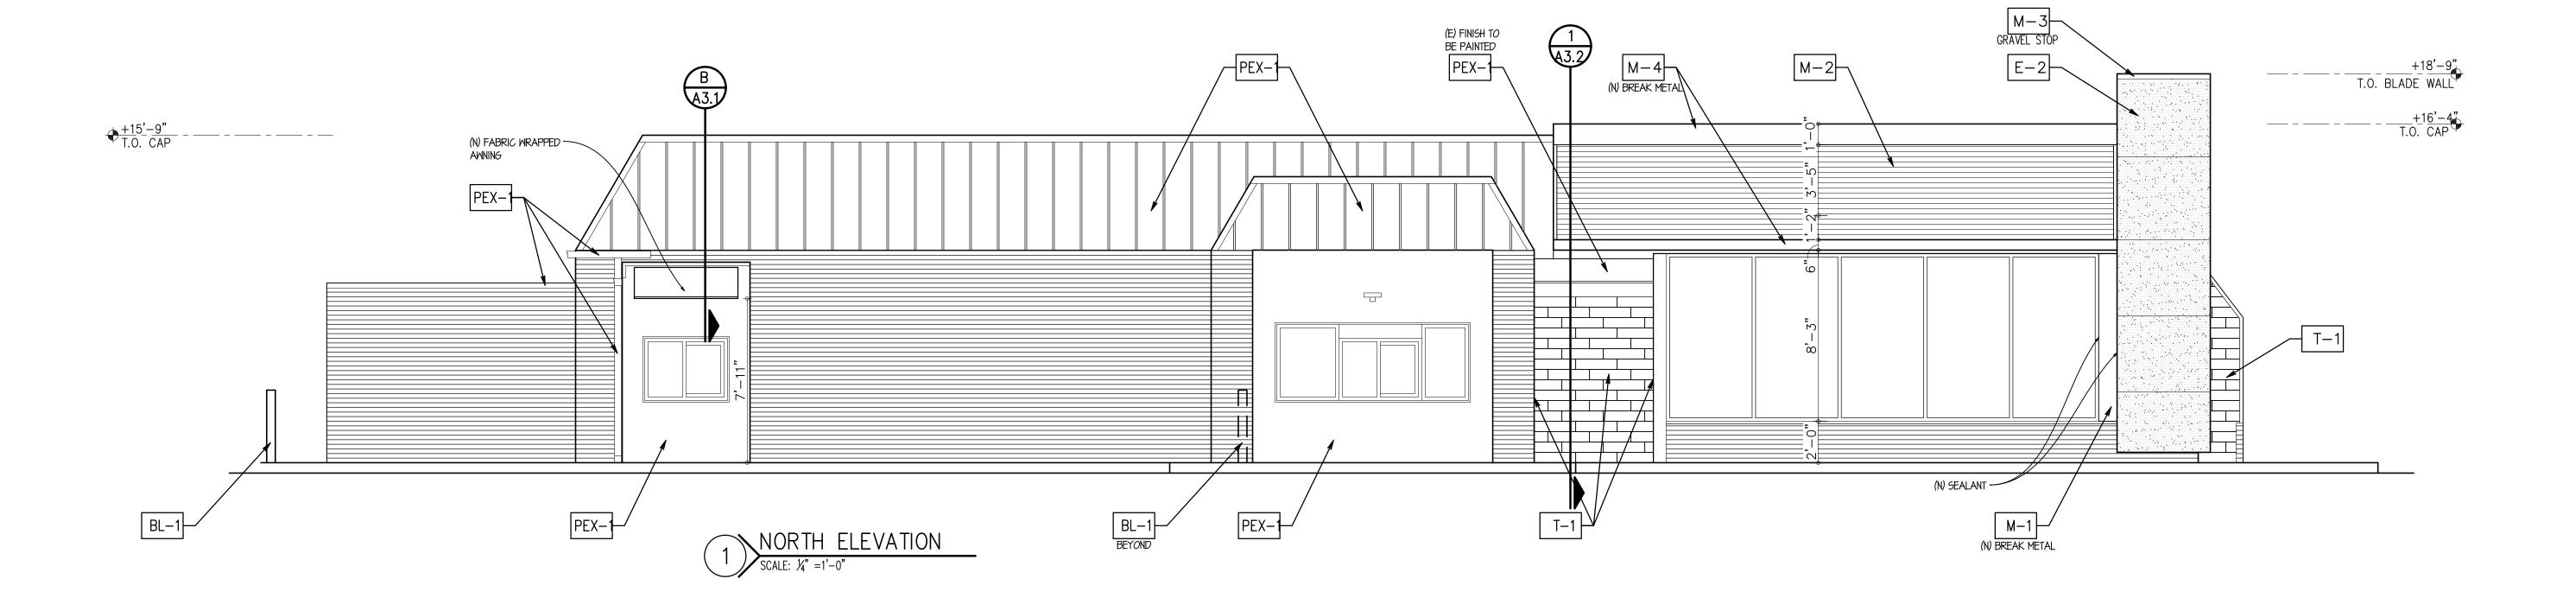

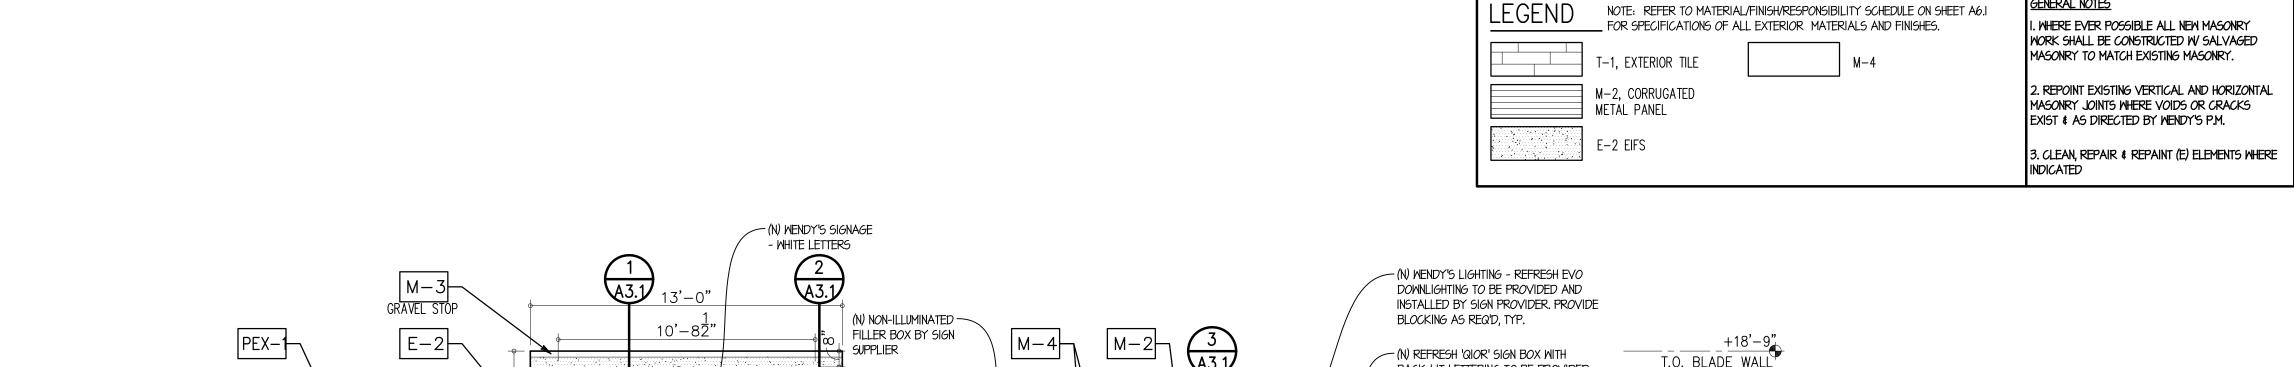

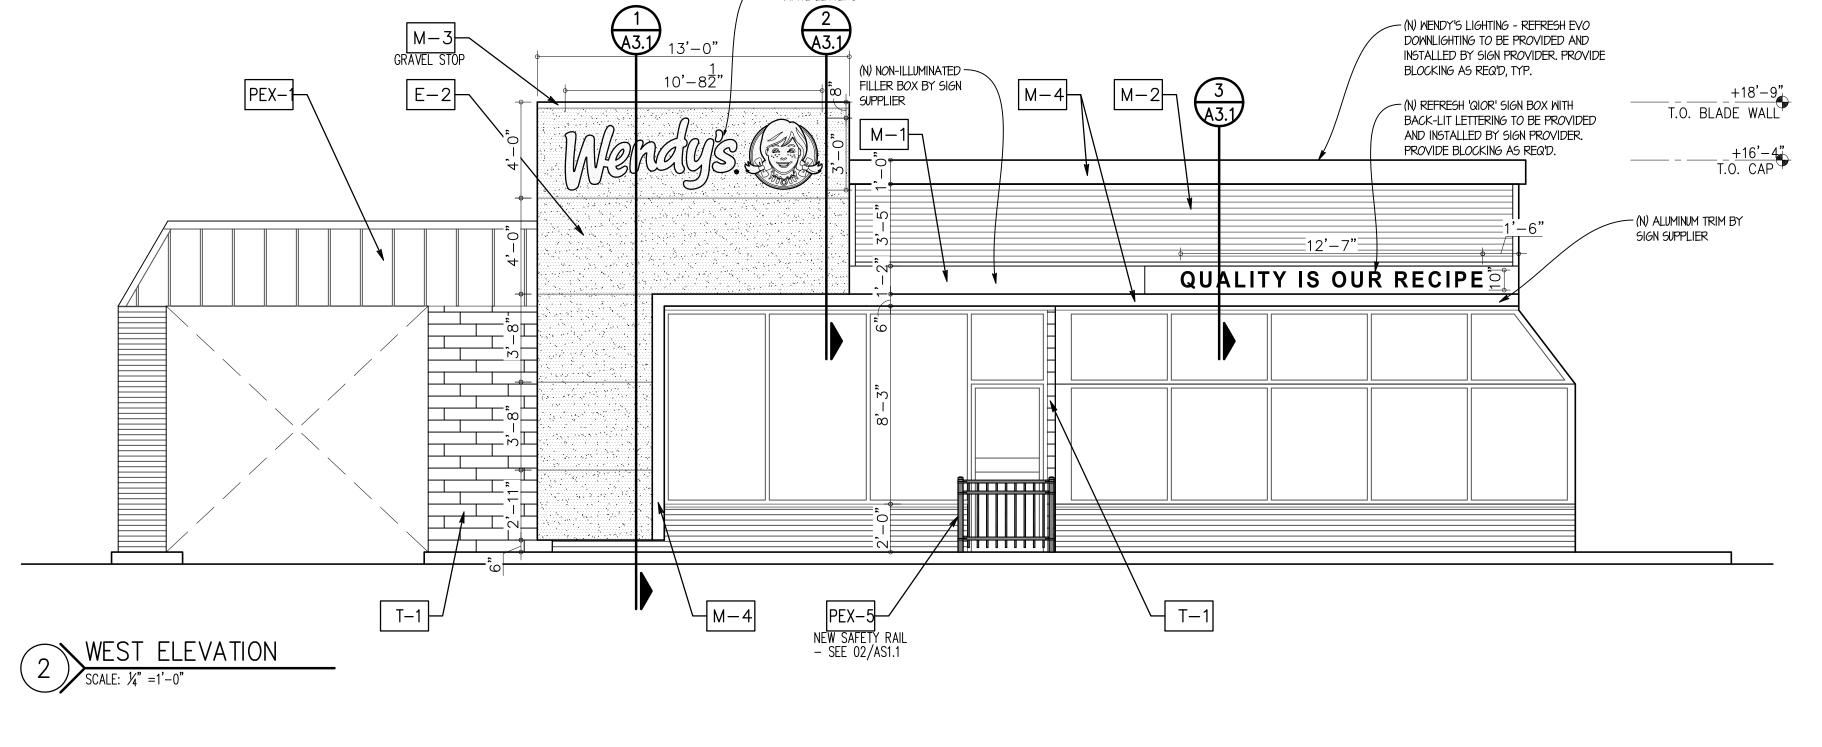

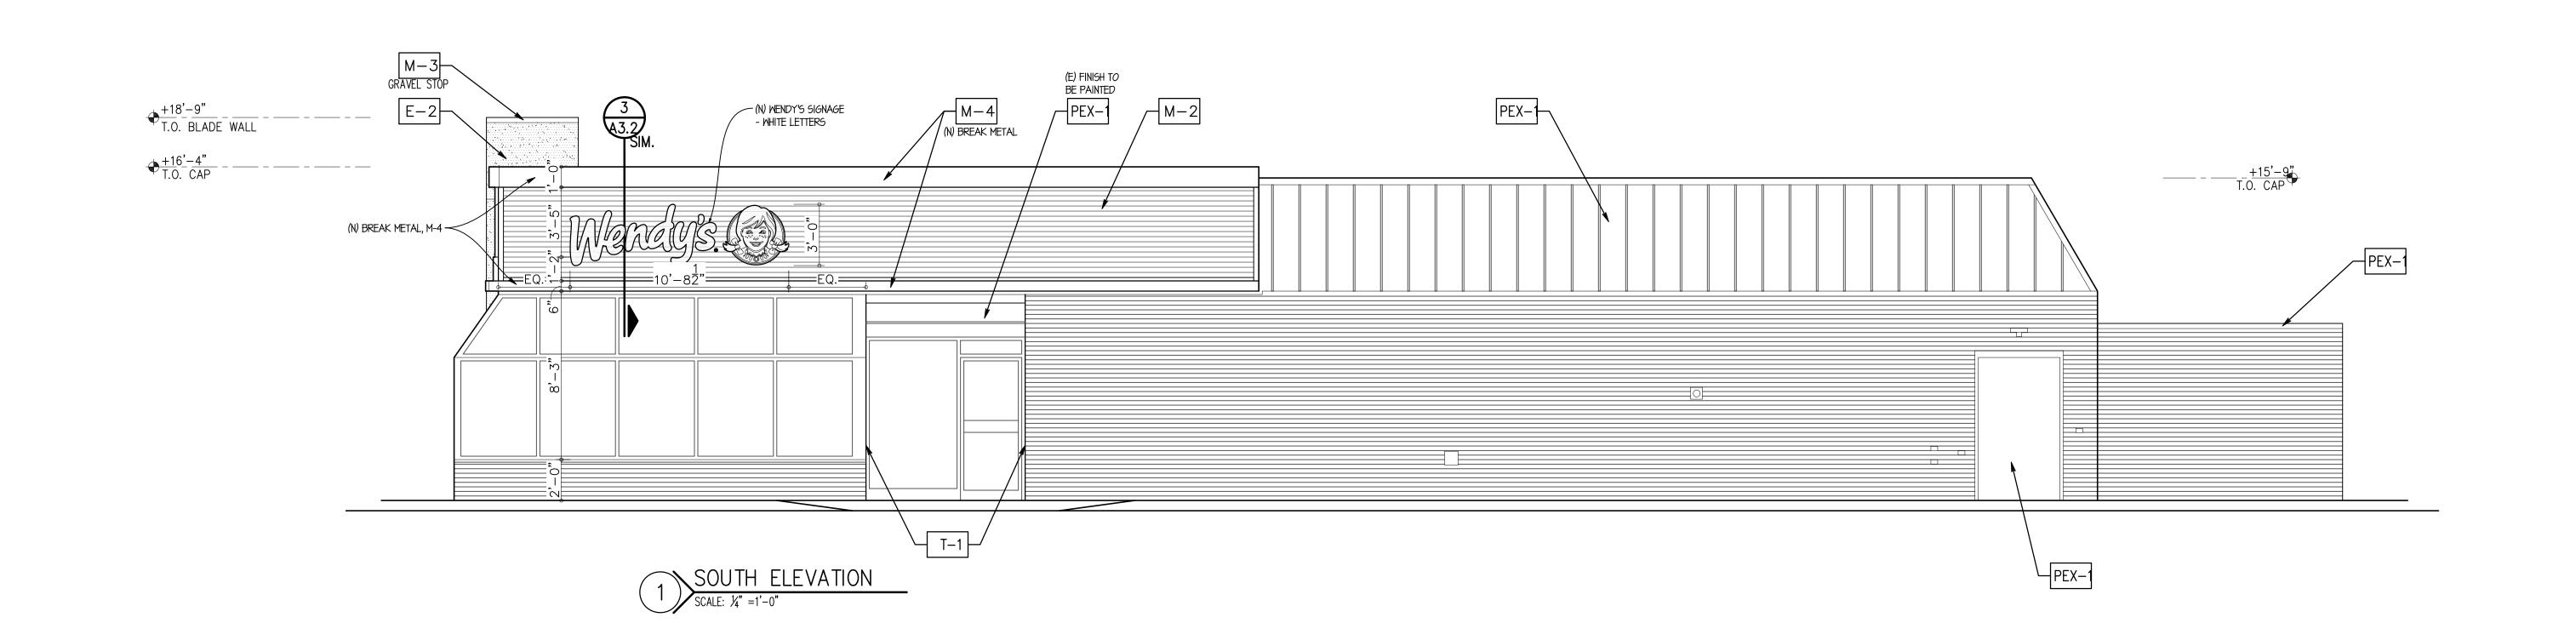

SITE NUMBER: 07588 BASE MODEL: CONVERSION ASSET TYPE: FRANCHISE CLASSIFICATION: REFRESH OWNER: JARO FOODS BASE VERSION: 2015 OCT 16 UPGRADE CLASSIFICATION: STANDARD PROJECT YEAR: 2015 FURNITURE PACKAGE: 2015 DESIGN BULLETINS:

Wallin - Gomez Architects, Ltd.

711 South Dearborn Street

Suite 606 Chicago, IL 60605 Tel: 312-427-4702 Fax: 312-427-6611 e-mail: admin@wgaltd.com

STORE #07588
747 SOUTH STATE ROAD 135

_		
REV.	DATE	DESCRIPTION
	01-08-16	ISSUED FOR PERMIT & BID


PROJECT NUMBER 1/8/2016
PROJECT NUMBER 15130
DRAWN BY CL/KH
CHECKED BY DJW

NOTICE: THIS DOCUMENT CONTAINS
PROPRIETARY INFORMATION. IT SHALL NOT
BE USED OR REPRODUCED OR ITS CONTENTS
DISCLOSED, IN WHOLE OR IN PART WITHOUT
THE PRIOR WRITTEN CONSENT OF WALLIN /
GOMEZ ARCHITECTS, LTD.

THESE DRAWINGS HAVE BEEN PREPARED AT

AND / OR UNDER MY SUPERVISION AND TO THE BEST OF MY KNOWLEDGE AND BELIEF CONFORM AND COMPLY WITH THE REQUIREMENTS OF THE DEPARTMENT OF BUILDING AND CODES HAVING JURISDICTION.


STATE OF INDIANA
AR19500067
REGISTERED ARCHITECT
DONALD J. WALLIN
EXPIRATION DATE: 12/31/2017

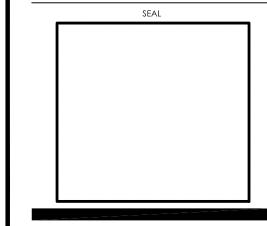

SHEET NAME
EXTERIOR
ELEVATIONS

SHEET NUMBER

A2.2

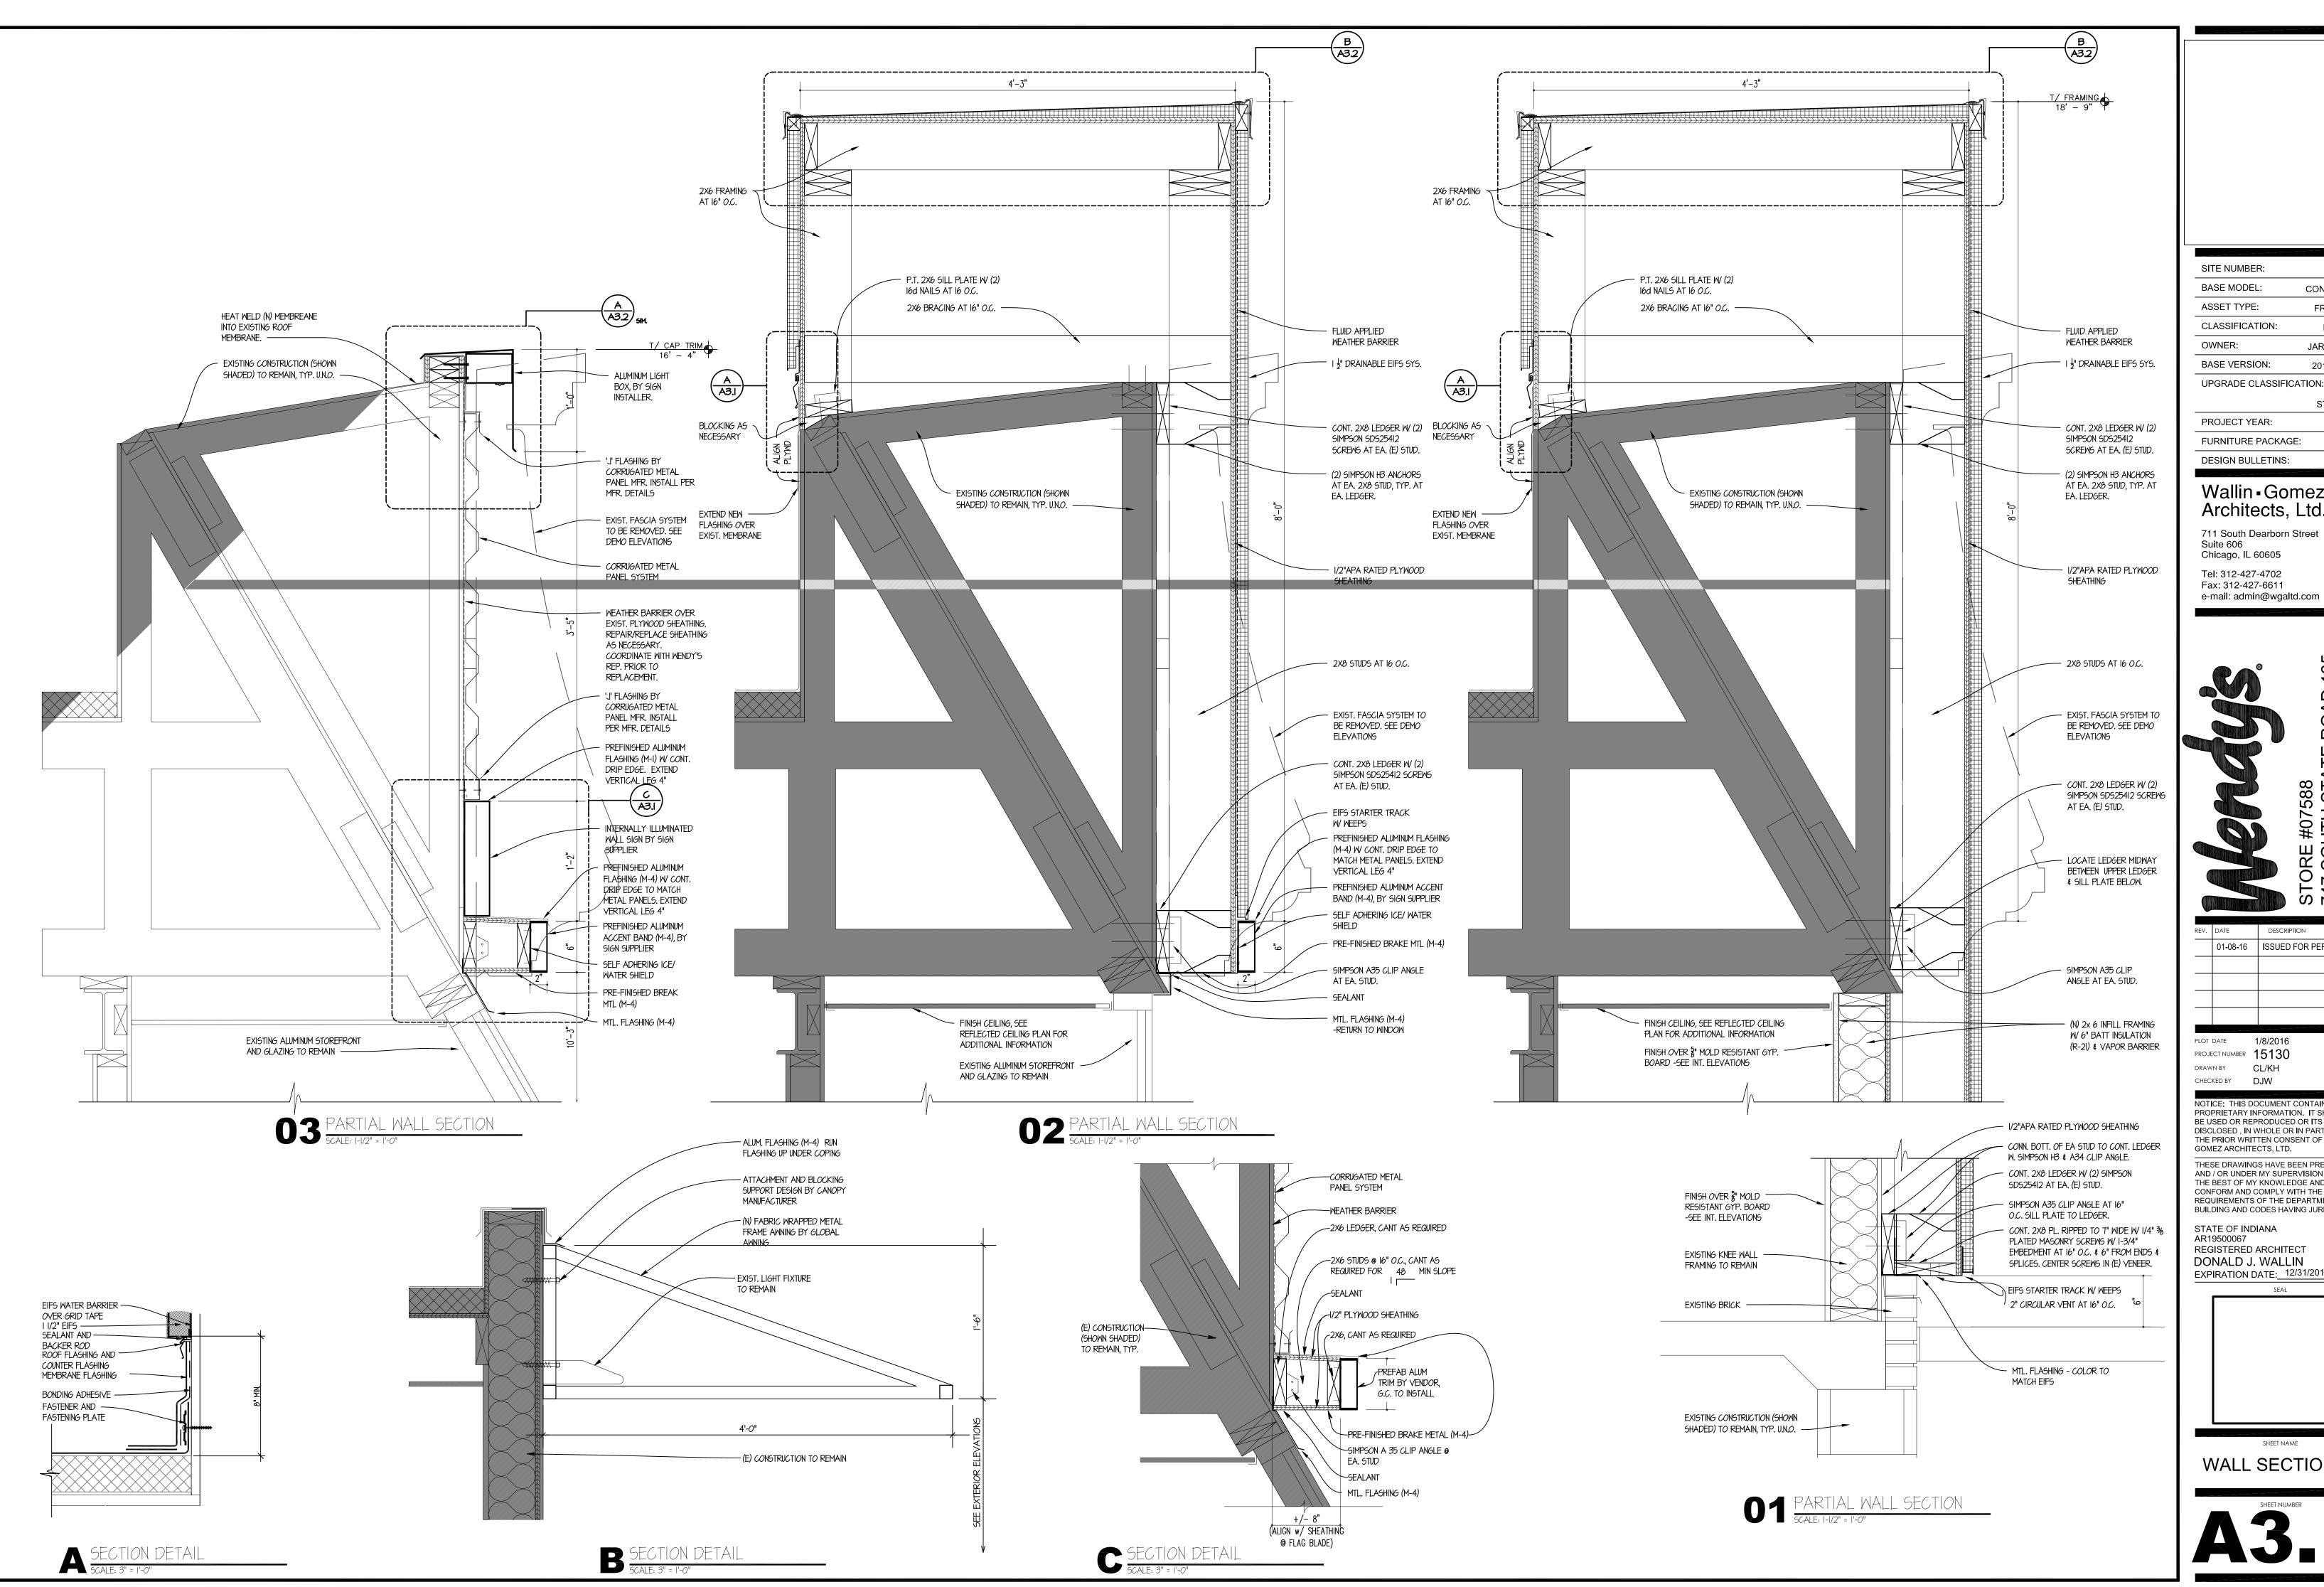


SITE NUMBER:	07588
BASE MODEL:	CONVERSION
ASSET TYPE:	FRANCHISE
CLASSIFICATION:	REFRESH
OWNER:	JARO FOODS
BASE VERSION:	2015 OCT 16

	STANDARD
PROJECT YEAR:	2015
FURNITURE PACKAGE:	2015

Wallin - Gomez Architects, Ltd.

711 South Dearborn Street Suite 606 Chicago, IL 60605 Tel: 312-427-4702 Fax: 312-427-6611 e-mail: admin@wgaltd.com

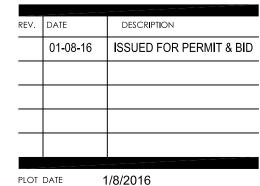


PROJECT NUMBER 15130 DRAWN BY CL/KH CHECKED BY DJW


NOTICE: THIS DOCUMENT CONTAINS PROPRIETARY INFORMATION. IT SHALL NOT BE USED OR REPRODUCED OR ITS CONTENTS DISCLOSED, IN WHOLE OR IN PART WITHOUT THE PRIOR WRITTEN CONSENT OF WALLIN / GOMEZ ARCHITECTS, LTD.


THESE DRAWINGS HAVE BEEN PREPARED AT AND / OR UNDER MY SUPERVISION AND TO THE BEST OF MY KNOWLEDGE AND BELIEF CONFORM AND COMPLY WITH THE REQUIREMENTS OF THE DEPARTMENT OF BUILDING AND CODES HAVING JURISDICTION.


AR19500067 REGISTERED ARCHITECT DONALD J. WALLIN EXPIRATION DATE: 12/31/2017

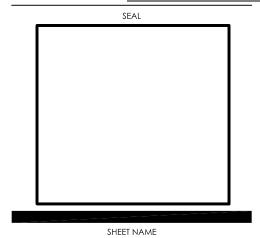

WALL SECTIONS

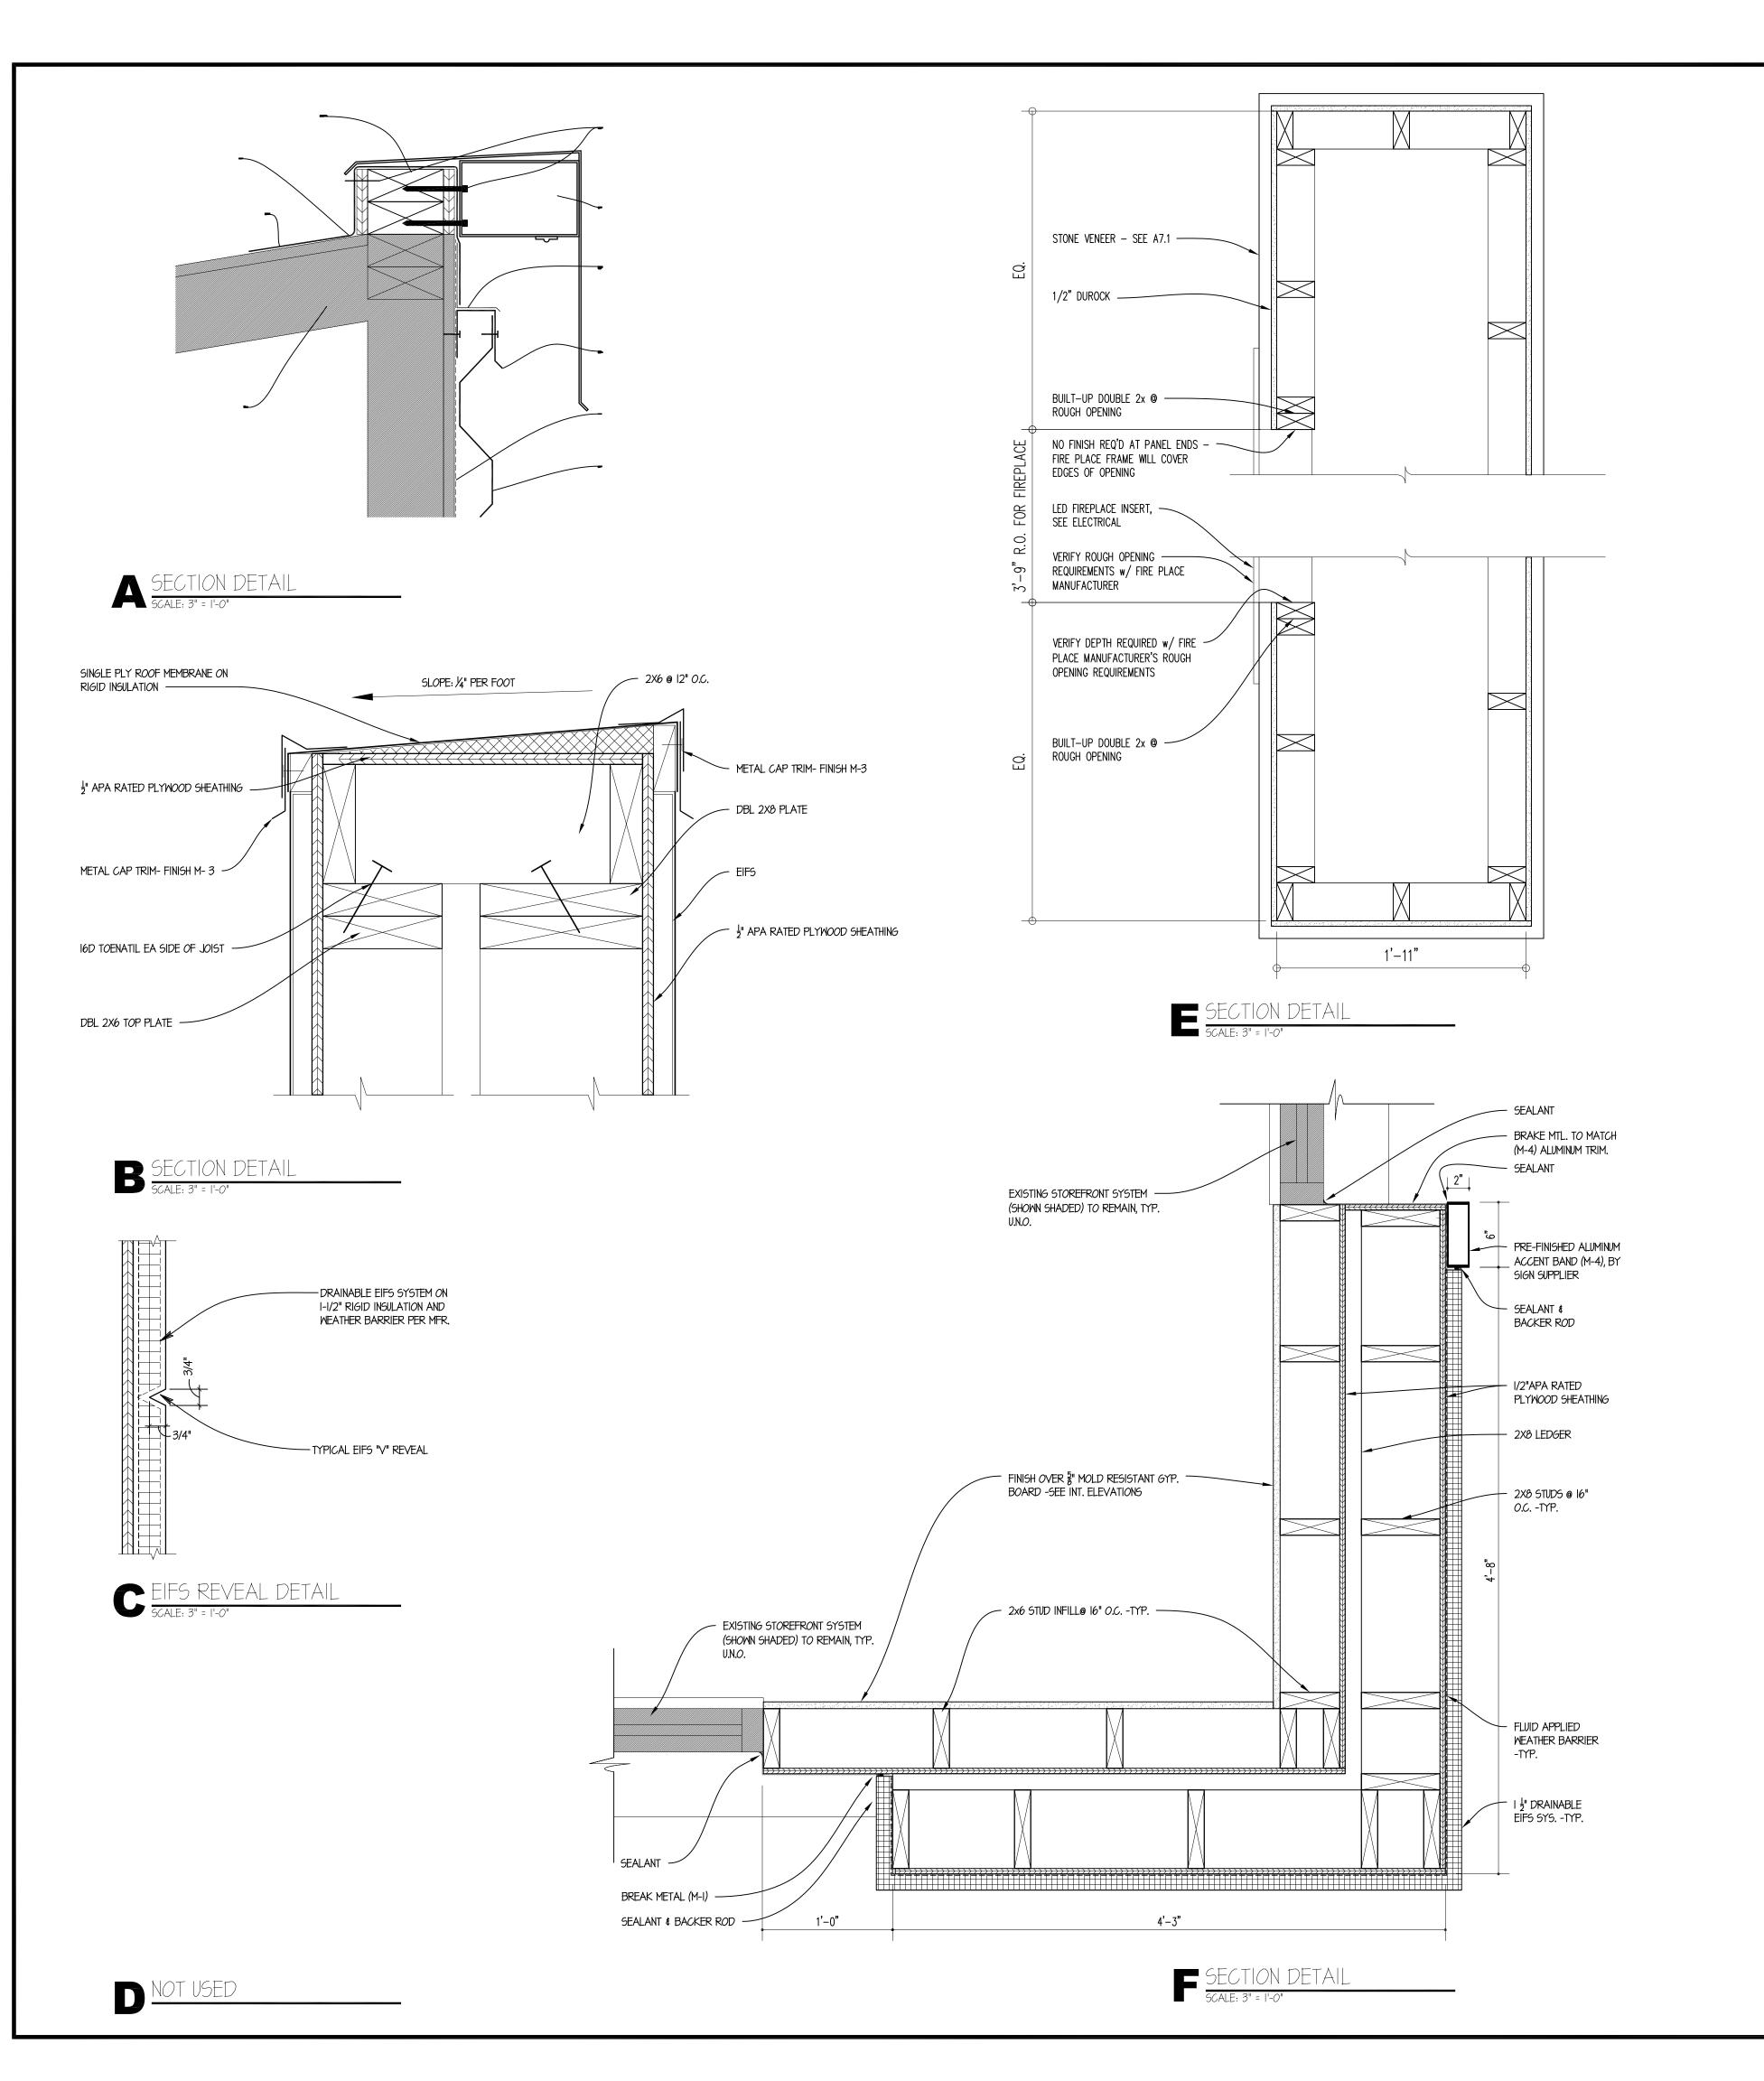

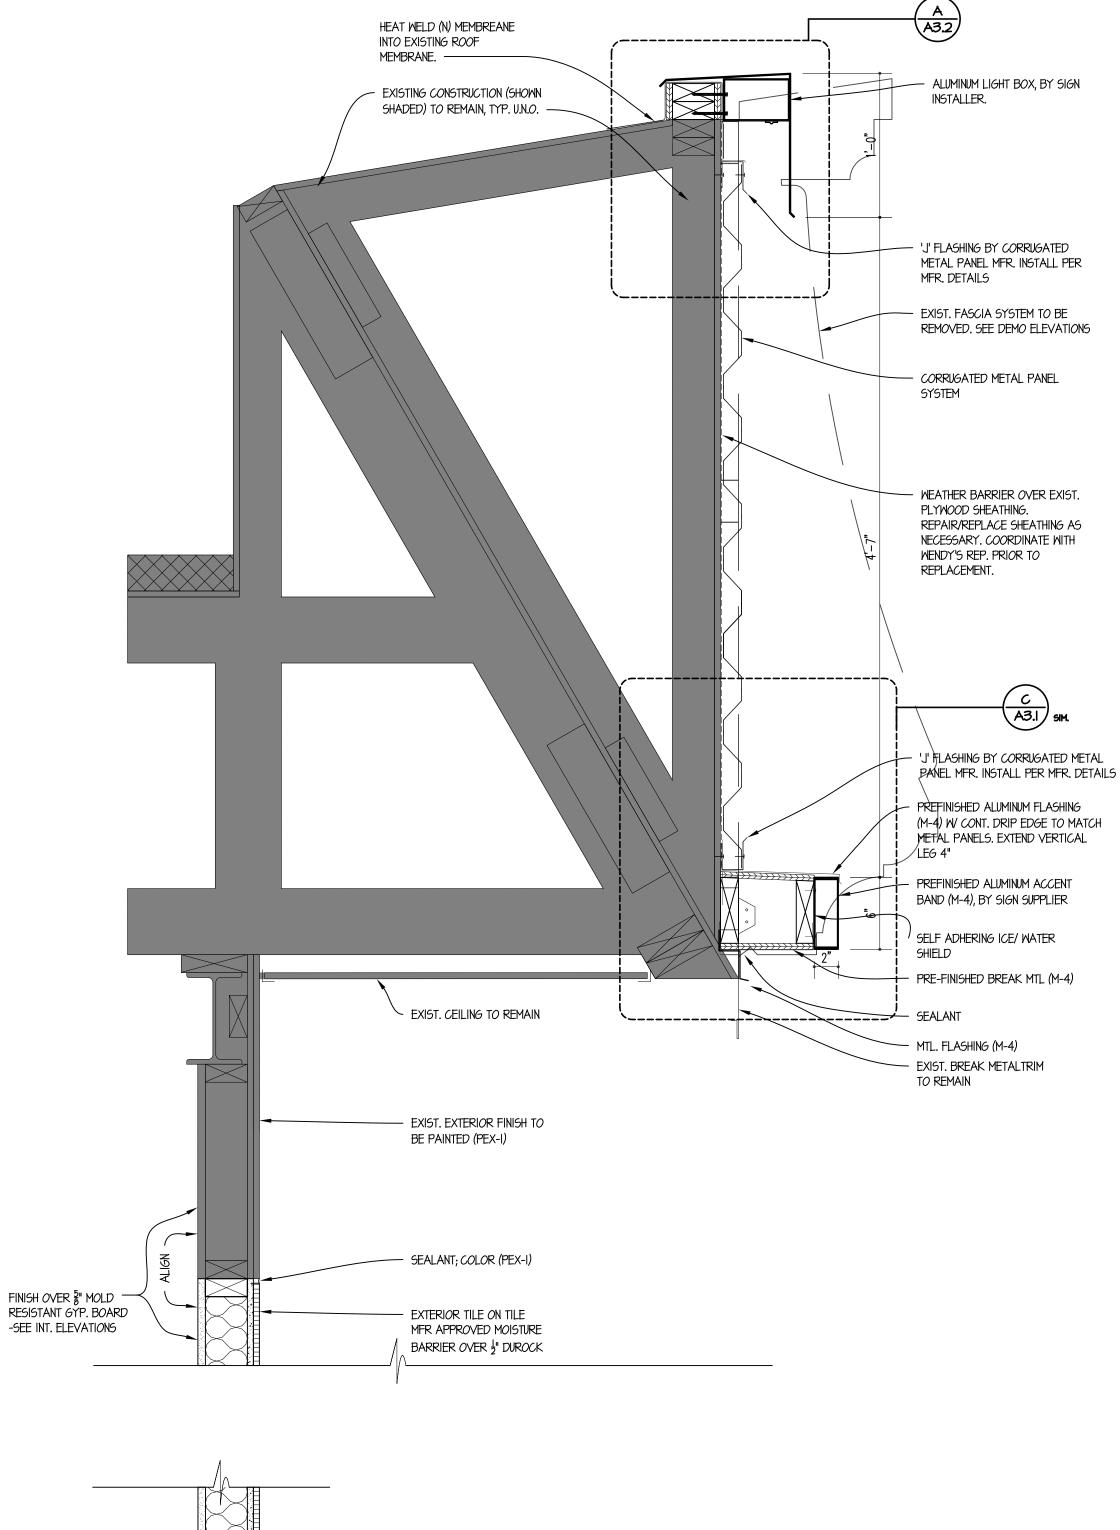

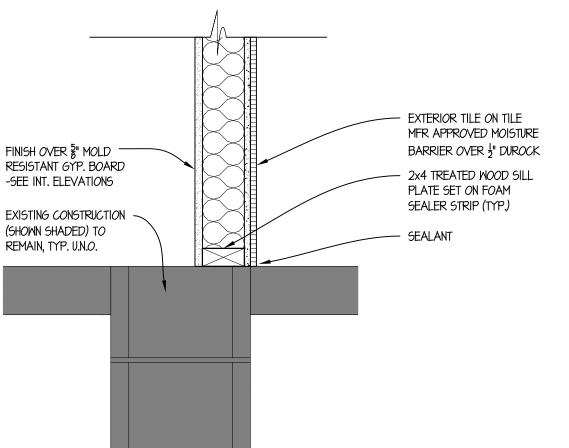

PARTIAL WALL SECTION

5CALE: 1-1/2" = 1'-0"

SITE NUMBER:	07588
BASE MODEL:	CONVERSION
ASSET TYPE:	FRANCHISE
CLASSIFICATION:	REFRESH
OWNER:	JARO FOODS
BASE VERSION:	2015 OCT 16

	STANDARD
PROJECT YEAR:	2015
FURNITURE PACKAGE:	2015

DESIGN BULLETINS:

UPGRADE CLASSIFICATION:

Wallin - Gomez Architects, Ltd.

711 South Dearborn Street Suite 606 Chicago, IL 60605 Tel: 312-427-4702

Tel: 312-427-4702 Fax: 312-427-6611 e-mail: admin@wgaltd.com


The second secon	
DATE	DESCRIPTION
01-08-16	ISSUED FOR PERMIT & BID
	DATE

PLOT DATE 1/8/2016
PROJECT NUMBER 15130
DRAWN BY CL/KH
CHECKED BY DJW

NOTICE: THIS DOCUMENT CONTAINS
PROPRIETARY INFORMATION. IT SHALL NOT
BE USED OR REPRODUCED OR ITS CONTENTS
DISCLOSED, IN WHOLE OR IN PART WITHOUT
THE PRIOR WRITTEN CONSENT OF WALLIN /
GOMEZ ARCHITECTS, LTD.

THESE DRAWINGS HAVE BEEN PREPARED AT AND / OR UNDER MY SUPERVISION AND TO THE BEST OF MY KNOWLEDGE AND BELIEF CONFORM AND COMPLY WITH THE REQUIREMENTS OF THE DEPARTMENT OF BUILDING AND CODES HAVING JURISDICTION.

STATE OF INDIANA AR19500067 REGISTERED ARCHITECT DONALD J. WALLIN EXPIRATION DATE: 12/31/2017

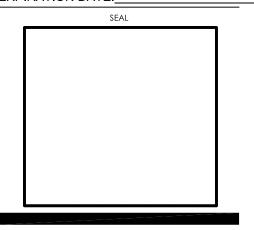

WALL DETAILS

SHEET NUMBER

SHEET NUMBER

07 NOT USED SCALE:" = 6"= 1'-0"

O4 NOT USED SCALE: 1/4" = 1'-0"

03 NOT USED

SCALE: 3" = 1'-0"

WALL COVERING

SEALANT

WOOD TRIM WITH EASED
EDGES FINISHED TO
MATCH L-2

(E) WOOD TRIM,
REFINISH TO MATCH
L-2

J-MOLD BY WALL
COVERING MFR.
WALL COVERING
(E) WALL SUBSTRATE

02 CHAIR RAIL TRIM DETAIL

SCALE: 3" = 1'-0"

PERMACOLOR GROUT
TILE
4-XLT - THIN SET
HYDRO BAN - WATERPROOFING /
CRACK ISOLATION MEMBRANE AT WET
AREAS AND CRACKS/CONTROL JOINTS
CONCRETE

08 DINING AREA TILE GROUT DETAIL
SCALE:1 1/2"= 1'-0"

09 NOT USED SCALE:1 1/2"= 1'-0"

08 NOT USED
SCALE:1 1/2"= 1'-0"

05 NOT USED
| SCALE:" = 6"= 1'-0"

06 NOT USED

SCALE:" = 6"= 1'-0"

01 NOT USED

SCALE:" = N.T.S.

SITE NUMBER: 07588 BASE MODEL: CONVERSION ASSET TYPE: FRANCHISE CLASSIFICATION: REFRESH OWNER: JARO FOODS BASE VERSION: 2015 OCT 16 UPGRADE CLASSIFICATION: STANDARD PROJECT YEAR: 2015 FURNITURE PACKAGE: 2015 DESIGN BULLETINS:

Wallin - Gomez Architects, Ltd.

711 South Dearborn Street Suite 606 Chicago, IL 60605 Tel: 312-427-4702

Tel: 312-427-4702 Fax: 312-427-6611 e-mail: admin@wgaltd.com




		0 2 0
REV.	DATE	DESCRIPTION
	01-08-16	ISSUED FOR PERMIT & BID

PLOT DATE 1/8/2016
PROJECT NUMBER 15130
DRAWN BY CL/KH
CHECKED BY DJW

NOTICE: THIS DOCUMENT CONTAINS
PROPRIETARY INFORMATION. IT SHALL NOT
BE USED OR REPRODUCED OR ITS CONTENTS
DISCLOSED, IN WHOLE OR IN PART WITHOUT
THE PRIOR WRITTEN CONSENT OF WALLIN /
GOMEZ ARCHITECTS, LTD.

THESE DRAWINGS HAVE BEEN PREPARED AT AND / OR UNDER MY SUPERVISION AND TO THE BEST OF MY KNOWLEDGE AND BELIEF CONFORM AND COMPLY WITH THE REQUIREMENTS OF THE DEPARTMENT OF BUILDING AND CODES HAVING JURISDICTION.

STATE OF INDIANA
AR19500067
REGISTERED ARCHITECT
DONALD J. WALLIN
EXPIRATION DATE: 12/31/2017

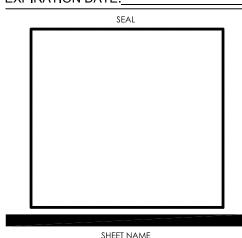

FINISH DETAILS

INTERIOR	R MATERIALS AND FINISHES		INTERIOR	MATERIALS AND FINISHES			PAI	NT SCH	EDULE						
CALL MATERIAL	DESCRIPTION	FURNISHED INSTA BY: BY: O GC KED O G	CALL	DESCRIPTION	FURNISHED BY: O GC KES	BY:		R BASE	SHEEN	SHERWIN WILLIAMS		XTERIOR BENJAMIN MOOF	E	PPG	
FLOORING			SEATING - TABLE CHAIR	GRAND RAPIDS E946 "TAN ECHO"; LEGS: "SPARKLE SILVER"				DY'S DARK BRONZE		BRONZETONE CUSTOM COLORS: "MISSISSIPPI BR		P23-60 "BRONZETONE"		530-7 "PHANTOM MIST"	
			- TALL TABLE CHAIR - FREESTANDING TABL BASES	22"x22" PUB HT (26" CROP ROUND); 30"x30" STND HT (36" ROUND TOP @ BOOTH); 36"x36" STND HT (42" ROUND TOP FAMILY); 22"X30" STND HT (FREESTANDING BOOTH TABLES);	•		•								
FLOOR TILE (DINING ROOM, RESTROOMS			- TABLE TOPS	DUAL T-BASES STND HT (HNDCP 24X42 TOP) FREE STANDING 20"x24", 24"x42" (ADA): FORMICA "CRÈME QUARSTONE" (6218-58 MATTE FINISH) w/ REHAU ANTIQUE BRUSH EDGE; 24"x42" BOOTHS, 36" ROUND, 42" ROUND FAMILY: FORMICA "PLANKED PEAR" (ARTISAN FINISH #43) w/ REHAU MULTIPLEX EDGE (592E); CROPPED CIRCLE HIGH-TOP 26"Dx24": NEVAMAR "CREST MAHOGONY" w/ REHAU EDGE TO MATCH (CP30079 1MM)	•		•	METAL	SATIN	RECOMMENDED: SEE PPG PRODUCT INFO ALTERNATE PRIME: PROCRYL UNIVERSAL METAL		RECOMMENDED: SEE PPG PR ALTERNATE PRIME: SELF PRI		COLOR: CORAFLON "STATUARY BROWN" (ADS8022030) RECOMMENDED PRIME: CORAFLONTM ADS EPOXY PRIMER, ADS 572/574	
B-2 VESTIBULE) TILE BASE (DINING ROOM, RESTROOMS, VESTIBULE)	GROUT: MAPEI #47 "CHARCOAL"OR LATICRETE #45 "RAVEN" CROSSVILLE; 6"x18" PLANKED; MAINSTREET; COLOR: "BISTRO BROWN" (ALSO AVAILABLE: 6"x12" COVE BASE) GROUT: MAPEI #47 "CHARCOAL"OR LATICRETE #45 "RAVEN" CORNER TRIM (AT CURTAIN WALL CURBS ONLY): SCHLUTER "QUADEC" w/ CORNER INSERTS (ABGB: BRUSHED ANTIQUE BRONZE ANOD. ALUM.)		- LOUNGE CHAIR - BOOTH AND BENCH SEATING - BOOTH DIVIDER	GRAND RAPIDS: E10019L; UPHOLSTERY: UP-2 (SEE BELOW) UPHOLSTERED BOOTH SEAT AND BACK: UP-1, UP-2 (SEE BELOW) FRAME FINISHED IN WILSONART "AMBER CHERRY" (#7919-38-107); CORIAN "CANYON" CAP GRASS DIGITAL GRAPHICS PRINTED ON 3/8" THICK PLEX PANELS	•		•			ALTERNATE FINISH: SHER-CRYL HPA (SMIE-GLOSS	OR GLOSS)	ALTERNATE FINISH: P23-60 D1	M ALKYD LOW LUSTRE ENAMEL	RECOMMENDED FINISH: CORAFLON ADS ALTERNATE FINISH: PITTHANE ULTRA (COORD. PRIME WITH MFR)	SITE NUMBER: 079 BASE MODEL: CONVERSION
	INSERTS (ABGB: BROSHED ANTIQUE BRONZE ANOD. ALUM.)		BACK)	H MORBERN; STYLE: "FLAIR"; COLOR: "MINERAL" (FA-307) H NASSIMI; STYLE: "SYMPHONY CLASSIC"; COLOR: "BRITISH TAN" (SCL-008)	•		•	PLASTIC (HERITAGE II)	SATIN	PRIME: MULTI PURPOSE LATEX PRIMER FINISH: SHER-CRYL HPA (SEMI-GLOSS)		PRIME: 023 FRESH START ALL FINISH: P23-60 DTM ACRYLIC I		PRIME: PPG SEAL GRIP 17-921 ACRYLIC UNIVERSIAL PRIMER FINISH: PPG SPEED HIDE 6-2045XI EXTERIOR SATIN ACRYLIC	ASSET TYPE: FRANCH CLASSIFICATION: REFRE
CEILING			SEAT, LOUNGE CHAIR	(3)			•								OWNER: JARO FOC BASE VERSION: 2015 OCT
			MISCELLAN	EOUS											UPGRADE CLASSIFICATION:
CT-2 CEILING TILE (DINING ROOM)	CERTAINTEED; SYTLE: "SYMPHONY M"; 24"x24"x3/4" (1222BB-IOF-1); COLOR: "WHITE"; REVEAL EDGE GRID: 15/16"; COLOR: STANDARD WHITE		SS-2 / FRONT COUNTER	TOP: CORIAN "CANYON" BODY: WILSONART "AMBER CHERRY" (#7919-38-107)	•		PEX-3 DARK	BRONZE METAL PYLON SI	IGN -	NO SUBSTITUTE (AVAILABLE THRU SIGN VENDOR SW 7022 "ALPACA"	DNLY)	NO SUBSTITUTE (AVAILABLE 1	HRU SIGN VENDOR ONLY)	NO SUBSTITUTE (AVAILABLE THRU SIGN VENDOR ONLY)	PROJECT YEAR: 20 FURNITURE PACKAGE: 20 DESIGN BULLETINS:
CEILING TILE (CONDIMENT AREA 8 SERVING AREA)	CERTAINTEED; STYLE: VINYLROCK GYPSUM (1142-CRF-1); COLOR: WHITE, 24"x24"x1/2"; TRIM EDGE GRID: 15/16"; COLOR: STANDARD WHITE	•	•												Wallin • Gomez Architects, Ltd.
P-3 G.W.B. CEILING	SEE PAINT SCHEDULE: EQUALS THRU SHERWIN-WILLIAMS, BENJAMIN MOORE, PPG, & MDC CERAMIC COLOR: "CEILING WHITE"	•					PEX-5 BLAC	K		BLACK		BLACK		BLACK	711 South Dearborn Street — Suite 606 Chicago, IL 60605
WALLS	FINISH: EGGSHELL (DINING & RESTROOMS), SEMI-GLOSS (KITCHEN)		DOORS	SATIN FINISH STAINLESS STEEL	•	•		WROUGHT IRON	SATIN	PRIME: PROCRYL UNIVERSAL METAL PRIMER FINISH: SHER-CRYL HPA GLOSS		PRIME: P06-20 METAL PRIMER FINISH: P22-21 URETHANE ALF		PRIME: PPG PITT-TECH 90-721 ACRYLIC METAL PRIMER FINISH: PPG PITT-TECH PLUS 90-1306 DTM GLOSS	Tel: 312-427-4702 Fax: 312-427-6611
		•	L-2 DOORS (RESTROOMS CLOSET, SERVING AREA)	WILSONART "AMBER CHERRY" (#7919-38-107); BOTH FACES (OUTSIDE/INSIDE) DOOR FRAMES: "BRUSHED ALUMINUM"	•	•									e-mail: admin@wgaltd.com
WC-1 WALL COVERING	KOROSEAL (RJF31346)OR MDC LEN-TEX; STYLE: "CORONADO LX"; COLOR: "OYSTER" (#3603CR/4734); 54" WIDE CORNERS: 'CP-2' (SEE BELOW)	•	- "ARTPACK" AND "WAYFINDING"	WALL DÉCOR & INTERIOR SIGNAGE	•	•									35
				R MATERIALS AND FINISHES											
WC-3 RED ACCENT WALL	KOROSEAL; STYLE "DESERT SAND"; COLOR: "ROASTED PEPPER"				FURNISHED	INSTALLE	D								40 A
(DINING ROOM) RED WALL COVERIN	CORNERS: 'CP-3' (SEE BELOW)		CALL MATERIAL	DESCRIPTION 0.040 ALUMINUM, FORMED-TO-SHAPE, CUSTOM BRONZE POWDER COATED FINISH TO MATCI	O GC KES										
WC-4 (GRAPHIC)	CUSTOM PRINTED WENDY'S GRAPHIC WALLCOVERING MURAL (FROM GTC); 72" VERSION CORNERS: 'CP-3' (SEE BELOW)		M-1 METAL TRIM & BRAKE METAL	"DARK BRONZE" STOREFRONT SYSTEM, CONTACT AMERICAN PRODUCTS, INC. (API), (813) 925-0144, BIDS@AMERICANPROD.COM; ATTN: KERRI BEALS											STATI
WALL COVERING	VODOSEAL TRAFFIO RATTERNO (O 000II). COLOR I VODOSEAL CANICIOTALIBRIO VII (0004 00).		M-2 CORRUGATED METAL PANEL	REYNOLUX 7.2" RIB PANEL, 20 GA, FACTORY FINISH COLOR: "CLASSIC BRONZE", AS MFG BY ALCOA CLADDING SYSTEMS. 20 GA. GALVANIZED STEEL.											TORE #07588 47 SOUTH STA
WC-6 WALL COVERING (WAINSCOT)	KOROSEAL: TRAFFIC PATTERNS (0.060"), COLOR: KOROSEAL, SAILCLOTH "BUOY" (8321-32) OUTSIDE CORNER TRIM: CP-5 / CP-6 (SEE BELOW) CAULK: C100 COLOR-MATCHED		M-3 METAL COPING ON BLADE	0.040 ALUMINUM, FORMED-TO-SHAPE, CUSTOM RED POWDER COATED FINISH TO MATCH "WENDY'S RED" STOREFRONT SYSTEM. CONTACT: AMERICAN PRODUCTS, INC. (API), (813) 925-0144,	•	•	P-1: WENDY	'S REIGE	'	SW 7036 "ACCESSIBLE BEIGE"		NTERIOR OC-15 "BABY FAWN"		515-4 "MOTH GRAY"	RE SOL
				BIDS@AMERICANPROD.COM; ATTN: KERRI BEALS			T II WENDT	G.W.B.	EGGSHELL	PRIME: PROMAR 200 ZERO VOC PRIMER FINISH: PROMAR 200 ZERO VOC EGG-SHELL		PRIME: 046 SUPERIOR PRIME! FINISH: 524 AURA WATERBOR		PRIME: PPG SPEEDHIDE 6-2 INTERIOR QD ACRYLIC PRIMER FINISH: PPG SPEEDHIDE 6-411 INTERIOR EGGSHELL ENAMEL	STO STO
WT-2 WALL TILE (RESTROOM)	TRANSCERAMICA; 12"x24"; COLOR: "EXTRA IVORY"; PATTERN: STACKED BOND GROUT: MAPEI #06 "HARVEST"OR LATICRETE #39 "MUSHROOM" HORIZONTAL TRIM: SCHLUTER "SCHEINE" (AE: SATIN ANOD. ALUM.) OUTSIDE CORNER TRIM: SCHLUTER "QUADEC" w/ CORNER INSERTS (AE: SATIN ANOD. ALUM.)	•	M-4 METAL TRIM & BRAKE METAL	0.040 ALUMINUM, FORMED-TO-SHAPE, CUSTOM POWDER COATED "GG BRUSHED ALUMINUM"	•	•			I						REV. DATE DESCRIPTION
WALL TILE WT-3 (DINING RM FIREPLACE)	REALSTONE; SHADOWSTONE; 6"x24" PANELS; COLOR: "SIERRA"; 6"x24" CORNER PANELS, (SPLIT 8"X6" AND 16"X6" WITH INTERLOCKING CORNER), 6"x24" END PANELS, PATTERN: OFFSET RUNNING BOND	•	PEX-1 REAR DOOR, DOWNSPOUTS, COLLECTOR BOXES, TRASH ENCLOSURE,	"WENDY'S DARK BRONZE" (SEE PAINT SCHEDULE)	•	•	P-3: CEILING	RESTROOM G.W.		SW 7006 "EXTRA WHITE" PRIME: PROMAR 200 ZERO VOC PRIMER		PM-1195 "SUPER WHITE" PRIME: 046 SUPERIOR PRIME		518-1 "DELICATE WHITE" PRIME: PPG SPEEDHIDE 6-2 INTERIOR QD ACRYLIC PRIMER	01-08-16 ISSUED FOR PERMIT &
			PEX-3 EXTERIOR SIGNAGE / POLES	"WENDY'S DARK BRONZE" (SEE PAINT SCHEDULE)	•	•		VESTIBULE G.W.		FINISH: PROMAR 200 ZERO VOC FLAT		FINISH: 522 AURA WATERBOR	NE INTERIOR MATTE FINISH	FINISH: PPG SPEEDHIDE 6-70 INTERIOR ACRYLIC FLAT	
			PEX-5 SAFETY RAILING	NEW: POWDER COAT BLACK				•	•						PLOT DATE 1/8/2016 PROJECT NUMBER 15130
			PEX-5 SAFETY RAILING	REMODEL: PAINT BLACK (SEE PAINT SCHEDULE)											DRAWN BY CL/KH CHECKED BY DJW
			T-1	CROSSVILLE, SWW-2; CUSTOM COLOR: "WENDY'S WOODGRAIN", 6"X26",											NOTICE: THIS DOCUMENT CONTAINS PROPRIETARY INFORMATION. IT SHALL N
	ON KOROGARD G875 CORNER GUARD; 3/4"x3/4"; COLOR: PUMICE			PATTERN: 1/3 RUNNING BOND GROUT: MAPEI #42 MOCHA, WITH 1/8" GROUT JOINT RECOMMENDED. PROVIDE SCHLUTER "RONDEC" TRIM AT VERTICAL OUTSIDE CORNERS AND EDGES; COLOR: SATIN COPPER/BRONZE ANODIZED ALUMINUM.			T 11 1			N COUEDIUE					BE USED OR REPRODUCED OR ITS CONTED DISCLOSED, IN WHOLE OR IN PART WITHOUTHE PRIOR WRITTEN CONSENT OF WALLINGOMEZ ARCHITECTS, LTD.
CP-3 (FOR WC-1) CP-3 (FOR WC-3 & WC-4)	ON KOROGARD G875 CORNER GUARD; 3/4"x3/4"; CUSTOM COLOR: MATCH 'WC-3'		BL-1 BOLLARD SLEEVE	NEW: PAWLING, PRO-TEK BOLLARD SLEEVE (RED); 6" DIA, 48" HEIGHT REMODEL: SAME AS ABOVE, VERIFY EXISTING DIAMETER & HEIGHT	•	•	LOCAT			N SCHEDULE TILE SIZE MORTAR (2) GROUT	(1,2) JOIN	IT MEMBRANE (2	REMARKS		THESE DRAWINGS HAVE BEEN PREPARED AND / OR UNDER MY SUPERVISION AND TO
	WORKS AND SATE AS THE SATE AS						INTERIOR FI		, , (-			THE BEST OF MY KNOWLEDGE AND BELIE CONFORM AND COMPLY WITH THE REQUIREMENTS OF THE DEPARTMENT OF BUILDING AND CODES HAVING JURISDICT
(FOR WC-6) CP-6 CORNER PROTECTION	N KOROGARD G875 90 DEGREE CORNER GUARD; 3/4"x3/4"; COLOR: FLAGSTONE N KOROGARD G815 135 DEGREE CORNER GUARD; 1-1/2"x1-1/2"; COLOR: FLAGSTONE						DINING	ROOMS	FT-2 6"x		1/8"	1004	EVERYD MEMODANIE OU OUT	AND JOHUD DEDINETED WALLS	STATE OF INDIANA AR19500067
(FOR WC-6)							RESTR	OOMS	FT-2 6"x	24" MR-1 GR-2	1/8"	WM-1	EXTEND MEMBRANE 24" OUT	AND 12" UP PERIMETER WALLS	REGISTERED ARCHITECT DONALD J. WALLIN
							INTERIOR W	ROOMS							EXPIRATION DATE: 12/31/2017 SEAL
									B-2 6"x	18" MR-1 GR-1	1/8"				-
							RESTR	OOMS		X24" MR-1 GR-3 18" MR-1 GR-3	1/8"	WM-1	EXTEND MEMBRANE 24" OUT	AND 12" UP PERIMETER WALLS	
															_
			SEE APPROVED SUPPLIERS	· ·			MORTA	AR AND GRO	UT PRODUC	MORTAR (2) GROUT	(1,2)		DESCRIPTION MEDIUM BED, MODIFIED-POR	TLAND CEMENT THIN SET MORTAR	
			KEY: O = Owner, GC=General Co KES=Kitchen Equipment Supplier												FINISH SCHEDULES
										GR-1			POLYMER-MODIFIED HIGH PE	RFORMANCE CEMENT TILE GROUT	SHEET NUMBER
										GR-2 GR-3			CHEMICAL RESISTANT, WATE WATER-CLEANABLE, TILE-GR	ER-CLEANABLE, INDUSTRIAL GRADE, TILE-GROUTING EPOXY	A C
								ER TO INTERIOR/EXTE		JLE FOR ADDITIONAL INFORMATION, INCLUDING COLOF			,,22 3/		HOIL

APPROVED	SUPPLIER LIST								
PRODUCT	CONTACT INFORMATION /ISION 3 - CONCRETE	PRODUCT	CONTACT INFORMATION 8 - DOORS AND WINDOWS	PRODUCT	CONTACT INFORMATION 9 - FINISHES (CONTINUED)	DIVISION 10	- SPECIALTIES (CONTINUED)		DIVISION 23 - HVAC
PRE-TINTED CONCRETE	CHEMMASTERS MADISON, OHIO 800-486-7866 ATTN: CLAUDIA BENTLEY 4 - MASONRY AND STONE	DOORS AND HARDWARE	***BASIS OF DESIGN*** LA FORCE, INC. COLUMBUS, OH 1-800-762-7301 ATTN: DAVE CARIDAS	TILE (FT-1, B-1, B-2, WT-1)	CROSSVILLE CERAMICS CROSSVILLE, TENNESSEE 931-456-3997 ATTN: TONI HALE	RESTROOM PARTITIONS AND ACCESSORIES	***BASIS OF DESIGN*** LA FORCE, INC. COLUMBUS, OH 1-800-762-7301 ATTN: DAVE CARIDAS	HVAC EQUIPMENT	***BASIS OF DESIGN*** PREFERRED EQUIPMENT (AAON) DAYTON, OH 877-435-4655, 937-432-6099 ATTN: MELISSA NEU
FACE BRICK	BOWERSTON SHALE COMPANY 740-269-2921 ATTN: CUSTOMER SERVICE		HAMILTON PARKER COLUMBUS, OHIO 614-358-7806 ATTN: JIM CAMPBELL	TILE (FT-2, WT-2)	TRANSCERAMICA TILE CROSSVILLE, TN 312-506-2856 ATTN: JAN WERNER		HAMLITON PARKER COLUMBUS, OHIO 614-358-7806 ATTN: JIM CAMPBELL		TRANE AIR CONDITIONING COLUMBUS, OH 866-986-4822 ATTN: MARTY CUSICK
WT-3 (ONLY) CONTACT HAMILTON PARKER	HAMILTON PARKER (OHIO) 614-358-7800 ATTN: GABRIEAL CANTRELL	STOREFRONT AND CURTAIN WALL	***BASIS OF DESIGN*** US ALUMINUM 213-309-3628 (CELL)	LUXURY VINYL TILE (WC-2)	DAVIS FLOORS 1-888-338-1029 ATTN: KERRY BISHOP		MARLITE PRODUCTS DOVER, OHIO		LENNOX INDUSTRIES INC. DALLAS, TX
MANUFACTURED STONE	DUTCH QUALITY STONE MT. EATON, OHIO 330-401-2115 ATTN: WENDALL MAST OWENS CORNING MASONRY PRODUCTS		ATTN: BRAD THURMAN (DIRECTOR OF SALES & MARKETING) KAWNEER COMPANY, INC. FRANKLIN, INDIANA 317-771-9263	WALLCOVERINGS (WC-1, WC-3, WC-6, WC-7) CORNER GUARDS	KOROSEAL/KORGUARD CINCINNATI, OH 866-628-2280 ATTN: MICHEAL GROSS	WINDOW SHADES	800-377-1221; 330-343-6621 ATTN: CUSTOMER SERVICE/TJ RHINE INSIDE OUTFITTERS COLUMBUS, OHIO	EXHAUST HOODS	800-367-6285 ATTN: ERIK LAWSON AEROLATOR SYSTEMS INC. MONROE, NC
D	MEDINA, OHIO 866-315-5081 ATTN: KATHY MANNON (FOR NEAREST DISTRIBUTOR) IVISION 5 - METALS		TUBELITE WALKER, MICHIGAN 616-808-2529	WALLCOVERINGS (WC-4) SOLID SURFACE SILLS (SS-2, SS-3)	(SEE "ART PACK ELEMENTS" BELOW) OHIO VALLEY SUPPLY CINCINNATI, OHIO 614-975-6700 ATTN: DAVE GREENING		800-742-3372; 614-798-3500 ATTN: STEVE JASZEK ROLL-A-SHADE LAKE ELSINORE, CA		866-841-0318 ATTN: STEVEN LUDDY ACTION AIR (VENTMASTER) ALPHARETTA, GA
DUMPSTER GATES AND HARDWARE	FORTIN WELDING COLUMBUS, OHIO 614-291-4342 ATTN: DAN FORTIN		ATTN: BRIAN MCGINNIS OLDCASTLE BUILDING ENVELOPE TERRELL, TEXAS 651-253-5062 ATTN: MARK LEHMAN	CANOPY (PUW & ORDER)	SION 10 - SPECIALTIES ***BASIS OF DESIGN*** GLOBAL AWNING MONROE, LOISIANNA	SAFETY EQUIPMENT	951-245-5077 x113 ATTN: RIC BERG (VP OF BUSINESS DEVELOPMENT) FRONT LINE SALES	AIR CURTAINS (ABOVE PUW, AS REQUIRED	866-844-1896 ATTN: BRENT COX BERNER INTERNATIONAL CORP NEW CASTLE, PA
DIVISION 6 - WC ROOF JOIST, MICRO-LAM BEAMS	OD, PLASTICS AND COMPOSITES REDBUILT COLUMBUS, OHIO 877-371-0445	GLAZING	***BASIS OF DESIGN*** GUARDIAN GLASS INDIANAPOLIS, IN		318-699-0088 ATTN: FRED MURPHY UNI-STRUCTURES, INC.	DIVI	630-226-5309 ATTN: TIM HAYES SION 11 - EQUIPMENT	BY CODE)	724-658-3551 ATTN: KAREN RYDER EASI-SERV
	ATTN: HENRY GRUESEN NATIONAL BUILDING SYSTEMS SUGAR GROVE, OHIO 937-291-2950		765-404-0964 ATTN: DALE HAUSER (ARCH SALES MGR) PPG INDUSTRIES INDIANAPOLIS, IN		KENNESAW, GEORGIA 678-974-1753 ATTN: KRISTINE WATTS AWNING TEC USA INC.	KITCHEN EQUIPMENT (KED)	N. WASSERSTROM AND SONS COLUMBUS, OHIO 800-444-4697 x8869 ATTN: ADAM CALTRIDER		VANCOVER, BC 604-422-8611 ATTN: FELIPE MONTIEL QUIKSERV
MILLWORK	ATTN: KEN DUVALL S & G DISTRIBUTING HILLIARD, OH 888-529-1992 x3635 ATTN: JOE URASKI, JR	PICK-UP WINDOW (PUW)	630-962-4800 ATTN: JOSEPH SENNESE (ARCHITECTURAL MGR) ***BASIS OF DESIGN*** QUIKSERV	EXTERIOR MENUBOARD	CORYDON, IN 812-734-0423 ATTN: ANDREW ENGLEMAN CUSTOM SIGN CENTER		S & G DISTRIBUTING HILLIARD, OH 888-529-1992 x3635 ATTN: JOE URASKI, JR	DIVISION	HOUSTON, TX 800-388-8307 ATTN: Jackie Brady 24 - ELECTRICAL SYSTEMS
	N. WASSERSTROM AND SONS COLUMBUS, OHIO 800-444-4697 x8869 ATTN: ADAM CALTRIDER		(STANDARD PUW & IMPACT RATED) HOUSTON, TX 800-388-8307; 713-462-1936 ATTN: STEVE BERT (NATIONAL SALES MGR) EASI-SERV	EXTERIOR PRE-SALE BOARDS INTERIOR QUEING BOARDS (STATIC)	COLUMBUS, OHIO 800-522-2934 ATTN: MICHAEL ANDERSON NATIONAL SIGN SYSTEMS		AEI AYDELOTT EQUIPMENT INC. CENTERVILLE, OHIO 888-293-3568, 937-435-8220 ATTN: HERB AYDELOTT	ELECTRICAL DISTRIBUTION PANELS	***BASIS OF DESIGN*** WESCO (WR CONTROLS) COLUMBUS, OH 800-417-7543; 614-875-6522 ATTN: WENDY'S PROJECT TEAM
	AEI AYDELOTT EQUIPMENT INC. CENTERVILLE, OHIO 888-293-3568; 937-435-8220	D)	(STANDARD PUW ONLY) VANCOVER, BC 604-422-8611 ATTN: FELIPE MONTIEL VISION 9 - FINISHES	INTERIOR MENUBOARD	COLUMBUS, OHIO 800-544-6726 ATTN: CUSTOMER SERVICE ***BASIS OF DESIGN***	DIVIS DINING ROOM FURNITURE PATIO FURNITURE	(SEE "KITCHEN EQUIPMENT" ABOVE) ***BASIS OF DESIGN***		GEXPRO (GE SUPPLY) GAHANNA, OH 800-336-5718; 614-308-2753 ATTN: ANN GILLMAN
DIVISION 7 - THEF ROOFING PRODUCTS	ATTN: HERB AYDELOTT RMAL AND MOISTURE PROTECTION ***BASIS OF DESIGN*** DUROLAST ROOFING, INC.	SUSPENDED ACOUSTICAL CEILING (CT-1, CT-2, CT-3, CT-4)	CERTAINTEED (FORMERLY BPB CELOTEX) 800-346-7978 x2263 ATTN: CHRISTINA HOPEWELL	(STATIC)	C3 LIGHTING SYSTEMS LOS ANGELES, CA 800-733-6661 x108 ATTN: MIKE MCINNIS NATIONAL SIGN SYSTEMS	PATIO FORNITURE	RECYCLE DESIGN ANDERSON, IN 765-374-0316 ATTN: JOSH BOUTWELL	LIGHTING	***BASIS OF DESIGN*** CAPITAL LIGHTING COLUMBUS, OH 877-841-1200; 614-841-1200 ATTN: BOB BEATTIE
	SAGINAW, MICHIGAN 800-248-0280 ATTN: JASON DARK SARNAFIL ROOFING SYSTEMS CANTON, MASSACHUSETTS	FRP PANELING	MARLITE PRODUCTS DOVER, OHIO 800-377-1221; 330-343-6621 ATTN: CUSTOMER SERVICE/TJ RINE	INTERIOR MENUBOARD	COLUMBUS, OHIO 800-544-6726 ATTN: CUSTOMER SERVICE THE WENDY'S COMPANY: IT DEPARTMENT		WAUSAU TILE WAUSAU, WI 715-359-3121 ATTN: PETE JANDA		LOUISVILLE LIGHTING LOUISVILLE, KY 800-678-1532 ATTN: ROBERT LARSON
EIFS	608-270-0053 ATTN: BEN BIEDRZYCKI ***BASIS OF DESIGN***	LAMINATE	HAMILTON PARKER COLUMBUS, OHIO 614-358-7806 ATTN: JIM CAMPBELL	(DIGITAL) INTERIOR QUEUING BOARDS (DIGITAL) TELEVISIONS	THE WEIGHT & COMPANT, IT DELIANTMENT	WALK-IN COOLER / FREEZER / DRY STORAGE	3 - SPECIAL CONSTRUCTION ***BASIS OF DESIGN*** INTERNATIONAL COLD STORAGE WICHITA, KS 319-230-8889		LSI INDUSTRIES (SITE LIGHTING ONLY) CINCINNATI, OH 800-436-7800; 513-793-3200 ATTN: GAIL HOPKINS
	STO CORP ATLANTA, GA 407-466-5371 ATTN: TIM SALERNO (STRATEGIC ACCOUNTS MANAGER)	PAINT (PEX-1, PEX-2, PEX-4, PEX-5,	WILSONART 254-718-7907 ATTN: JOHN HILL, hillj@wilsonart.com AVAILABLE THRU LOCAL RETAIL LOCATIONS; CONTACT NATIONAL ACCOUNT REP'S BELOW	EXTERIOR SIGNAGE (INCLUDING EXTERIOR BRANDING MOMENT & PREMANUFACTURED ACM PANELS)	CUSTOM SIGN CENTER COLUMBUS, OHIO 800-522-2934 ATTN: MICHAEL ANDERSON		ATTN: MARK NORVOLD KOLPAK PARSONS, TN 1-800-826-7036 x5623 ATTN: TABITHA KING		PEPCO (EDISON EQ) HILLIARD, OH 614-883-5710 ATTN: JENNIFER THOMAS
	DRYVIT SYSTEMS, INC. WARWICK, RI 734-276-0404 ATTN: ROBERT DAZEL (MARKETING MGR)	PEX-6, PEX-7, PEX-8)	FOR TECHNICAL QUESTIONS ONLY. BENJAMIN MOORE & COMPANY CLEVELAND, OHIO 330-353-3850		EVERBRITE GREENFIELD, WI 414-786-5470 ATTN: STEVE GLASENAPP	DIV WATER HEATER	RHEEM RUUD MONTGOMERY, AL	DIVISION 32 PARKING BLOCKS, BOLLARD COVERS	2 - EXTERIOR IMPROVEMENTS ***BASIS OF DESIGN*** PAWLING CORPORATION
ACM PANEL FABRICATOR	CLADDING & COMPONENT SOLUTIONS CUMMING, GA 770-887-2777 ATTN: STEPHEN ROEGGE		ATTN: DOROTHY HAZINSKI (NATIONAL ACCOUNT MANAGER) MDC WALLCOVERING ELK GROVE VILLAGE, IL 800-621-4006 x8338		NATIONAL SIGN SYSTEMS COLUMBUS, OHIO 800-544-6726 ATTN: CUSTOMER SERVICE		800-330-6935 ATTN: PAT POWELL (NATIONAL ACCOUNTS MGR) AO SMITH ALPHARETTA, GA	OT FREESTYLE MACHINE	WASSAIC, NY 800-431-3456 x3345 ATTN: MARCELLA FARRELL HER VENDORS COKE
	LSI GRAPHICS SOLUTIONS HOUSTON, TX 713-744-4178 ATTN: ANDREW HAREY		ATTN: JAN PREWITT ***BASIS OF DESIGN*** (FOR STOREFRONT REFINISHING) PPG INDUSTRIES		ID ASSOCIATES DOTHAN, AL 615-579-1818 ATTN: MANISH JAISINGHANI	LAVATORY PACKAGE (VANITY, MOUNTING	800-447-1953 (OPT #1) ATTN: NATIONL ACCT. OHIO VALLEY SUPPLY CINCINNATI, OH	- ALLOTTEL WAY COLLING	404-676-7952 ATTN: STEVE MULDOWNY
CORRUGATED METAL	ALCOA BULIDING & CONSTRUCTION SYSTEMS MACON, GEORGIA 478-319-0139 ATTN: KEVIN R. JUEDEMAN (RETAIL PROGRAM MANAGER)		317-318-5800 cell ATTN: RICK GARLIN (BUSINESS DEVELOPMENT MGR) SHERWIN-WILLIAMS 216-341-5553	ART PACK ELEMENTS AND WAYFINDING	GTC COLUMBUS, OHIO 614-252-6342 ATTN: APRIL ANDRICK	PLUMBING FIXTURES (WC AND URINALS)	GC SUPPLIED		
PREMANUFACTURED FASCIA AND SOFFITS	CLADDING & COMPONENT SOLUTIONS CUMMING, GA 770-887-2777	SIGN PAINT (PEX-3)	ATTN: BRAD HARRINGTON (NATIONAL ACCOUNTS MGR) (SEE SIGN VENDORS BELOW)	LADDER RECEIVER	LADDERTECH, LLC BRIGHTON, MICHIGAN 800-770-8851 ATTN: MICHELE ORAS OR CUSTOMER SERVICE	FAUCETS	MOEN INC. CLEVELAND, OH 800-321-8809 ATTN: CUSTOMER SERVICE		
	ATTN: STEPHEN ROEGGE	WALLCOVERINGS (WC-1, WC-5)	MDC WALLCOVERING ELK GROVE VILLAGE, IL 800-621-4006 x8338 ATTN: JAN PREWITT	FIREPLACE	MODERN FLAMES PHOENIX, AZ 877-246-9353 ATTN: TOM FOY		AMERICAN STANDARD 800-442-1902		
		GROUT, THINSET, AND WATERPOOFING MEMBRANE	LATICRETE INTERNATIONAL, INC. 1710 111th STREET GRAND PRAIRIE, TX 75050-1913, USA Phone: +1.972.641.3266 Fax: +1.972.660.5365				SLOAN VALVE COMPANY OHIO: 513-681-9999 ATTN: JIM NOLAN OUTSIDE OHIO: 800-982-5839		
			MAPEI AMERICAS HEADQUARTERS 1144 E. NEWPORT CENTER DRIVE DEERFIELD BEACH, FLORIDA 33442 Phone: 1-800-992-6273						

07588 SITE NUMBER: BASE MODEL: CONVERSION ASSET TYPE: FRANCHISE CLASSIFICATION: REFRESH OWNER: JARO FOODS BASE VERSION: 2015 OCT 16 UPGRADE CLASSIFICATION: STANDARD PROJECT YEAR: 2015

FURNITURE PACKAGE: 2015
DESIGN BULLETINS:

Architects, Ltd.
711 South Dearborn Street
Suite 606
Chicago, IL 60605

Wallin - Gomez

Tel: 312-427-4702 Fax: 312-427-6611 e-mail: admin@wgaltd.com

REV. DATE DESCRIPTION


01-08-16 ISSUED FOR PERMIT & BID

PLOT DATE 1/8/2016
PROJECT NUMBER 15130
DRAWN BY CL/KH
CHECKED BY DJW


NOTICE: THIS DOCUMENT CONTAINS
PROPRIETARY INFORMATION. IT SHALL NOT
BE USED OR REPRODUCED OR ITS CONTENTS
DISCLOSED, IN WHOLE OR IN PART WITHOUT
THE PRIOR WRITTEN CONSENT OF WALLIN /
GOMEZ ARCHITECTS, LTD.

THESE DRAWINGS HAVE BEEN PREPARED AT AND / OR UNDER MY SUPERVISION AND TO THE BEST OF MY KNOWLEDGE AND BELIEF CONFORM AND COMPLY WITH THE REQUIREMENTS OF THE DEPARTMENT OF BUILDING AND CODES HAVING JURISDICTION.

STATE OF INDIANA
AR19500067
REGISTERED ARCHITECT
DONALD J. WALLIN
EXPIRATION DATE: 12/31/2017

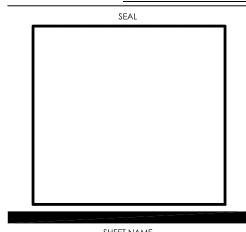

SHEET NAME
APPROVED SUPPLIERS

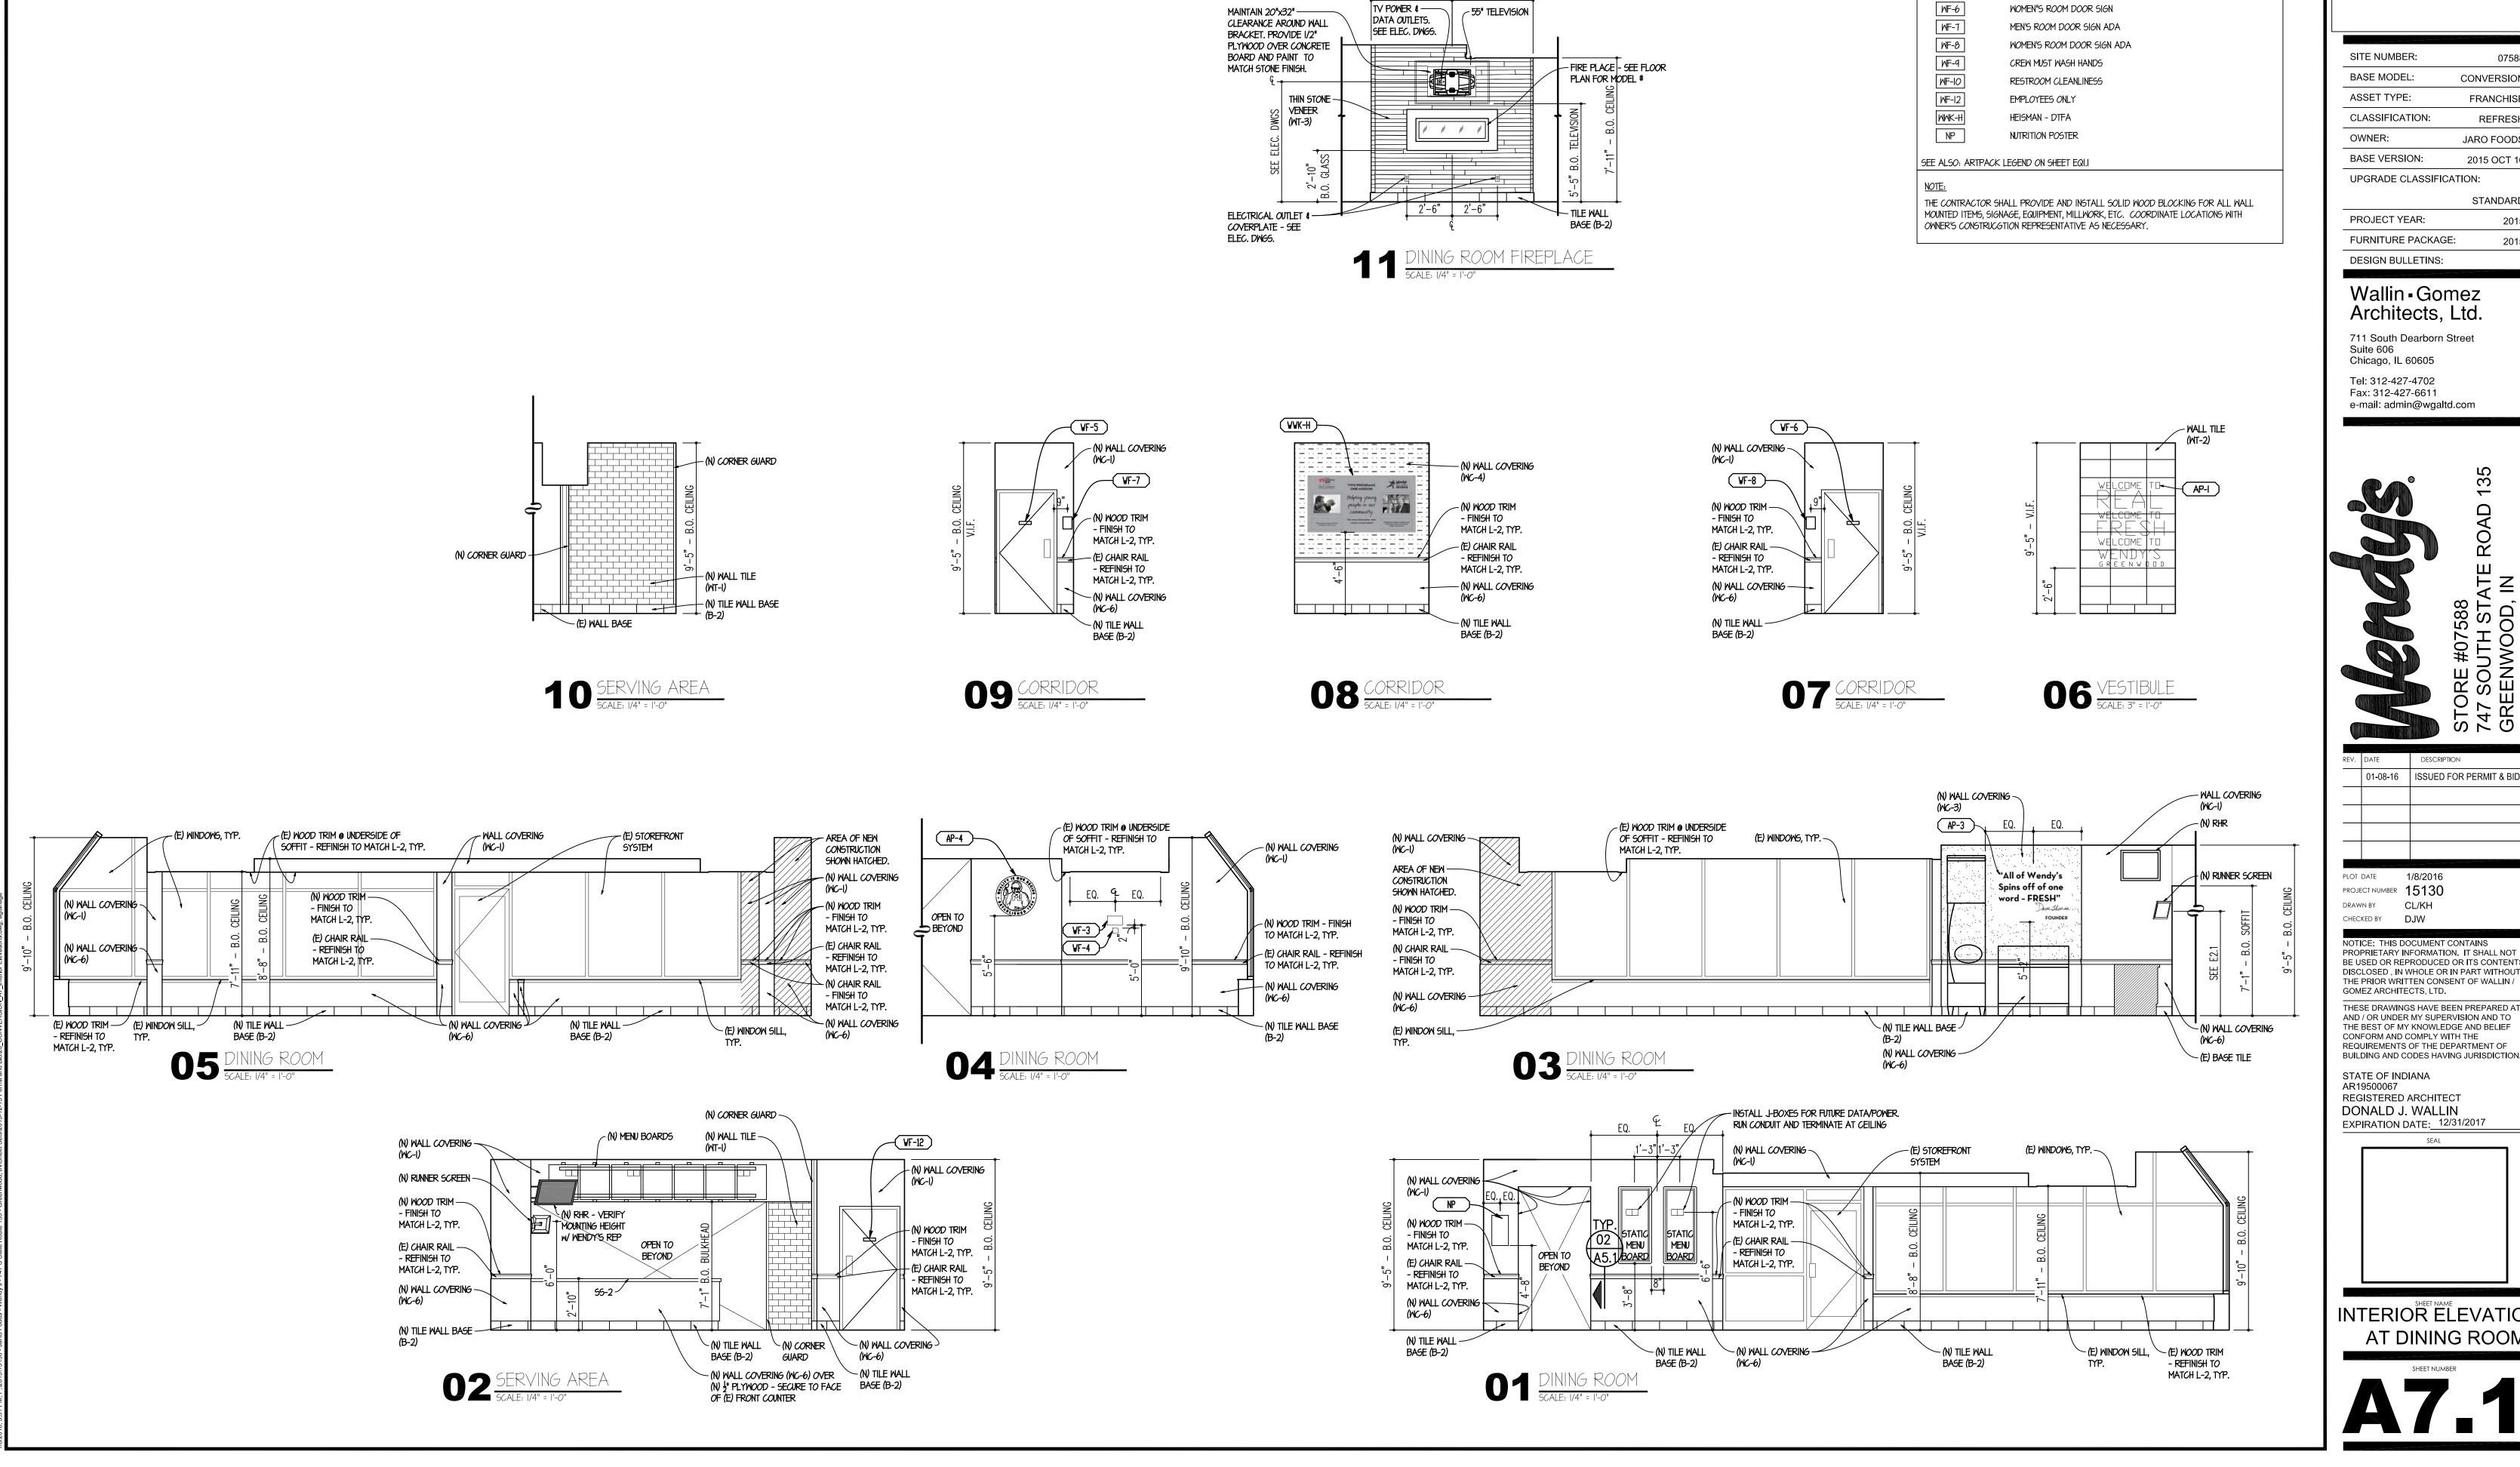

EQ

ARTPACK & WAYFINDING LEGEND

ENTRY BRAND MOMENT

QUALITY IS OUR RECIPE DAVE THOMAS QUOTE

MEDALLION WENDY'S SEAL

MEN'S ROOM DOOR SIGN

WI-FI SIGN

NO SMOKING SIGN

AP-3

AP-4

WF-3

WF-4

SITE NUMBER: 07588 BASE MODEL: CONVERSION ASSET TYPE: FRANCHISE CLASSIFICATION: REFRESH OWNER: JARO FOODS BASE VERSION: 2015 OCT 16

STANDARD PROJECT YEAR: 2015 FURNITURE PACKAGE: 2015

Wallin - Gomez

711 South Dearborn Street Suite 606 Chicago, IL 60605 Tel: 312-427-4702

Fax: 312-427-6611 e-mail: admin@wgaltd.com


01-08-16 ISSUED FOR PERMIT & BID

PROJECT NUMBER 15130 DRAWN BY CL/KH CHECKED BY DJW

PROPRIETARY INFORMATION. IT SHALL NOT BE USED OR REPRODUCED OR ITS CONTENTS DISCLOSED, IN WHOLE OR IN PART WITHOUT THE PRIOR WRITTEN CONSENT OF WALLIN / GOMEZ ARCHITECTS, LTD.

AND / OR UNDER MY SUPERVISION AND TO THE BEST OF MY KNOWLEDGE AND BELIEF CONFORM AND COMPLY WITH THE REQUIREMENTS OF THE DEPARTMENT OF BUILDING AND CODES HAVING JURISDICTION.

STATE OF INDIANA AR19500067 REGISTERED ARCHITECT DONALD J. WALLIN EXPIRATION DATE: 12/31/2017

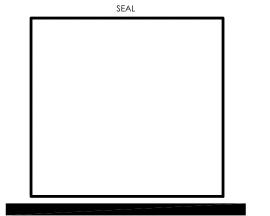

INTERIOR ELEVATIONS AT DINING ROOM

FIXTURE LEGEND

- A NOT USED
- SEMI-RECESSED HAND DRYER: XLERATOR XL-SB W 40502 ACCESSIBLE RECESS KIT & STAINLESS STEEL PANEL BELOW
- TOILET TISSUE DISPENSERS: WALL MOUNTED JUMBO ROLL TISSUE DISPENSER BY ASI MODEL NO 0042.
- (D) NOT USED
- (E) BABY CHANGING STATION
- F) 42" SIDE GRAB BAR
- (G) 36" REAR GRAB BAR
- H) MIRROR
- J VERTICAL GRAB BAR
- (K) WALL MOUNTED "ECOLAB" HANDS-FREE SOAP DISPENSER, BLACK


GRAB BARS: STAINLESS STEEL WITH EXPOSED MOUNTING. FINISH SHALL BE SMOOTH AND FURNISHED COMPLETE WITH MOUNTING KIT.

RESTROOM SCOPE OF WORK

MINIMUM SCOPE AS NOTED BELOW CONTRACTOR SHALL FURNISH, INSTALL, AND COMPLETE ALL WORK AS NOTED BELOW . CONTRACTOR SHALL VERIFY COMPLETE SCOPE OF RESTROOM WORK WITH THE OWNER'S CONSTRUCTION REPRESENTATIVE PRIOR TO COMPLETING BID PROPOSAL.

- NEW FLOOR, BASE & WALL TILE NEW SEMI-RECESSED HAND DRYER
- NEW DOORS & FRAMES
- NEW RESTROOM SIGNAGE
- NEW PLUMBING FIXTURES AS SCHEDULED ON PLUMBING DRAWING.
 PROVIDE AND INSTALL NEW SOLID WALL BLOCKING IN WALLS AS
- REQUIRED FOR ANY NEW OR RELOCATED FIXTURES OR ACCESSORIES.

NOTE: CONTRACTOR TO PROVIDE 2x WOOD BLOCKING IN WALL FOR ANCHORAGE OF GRAB BARS AS REQUIRED.

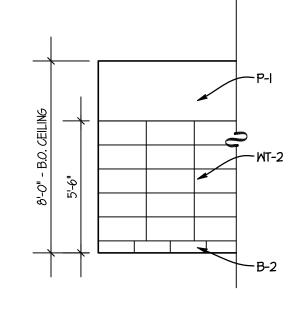

O9 TYPICAL WALL FINISHES

SCALE: 1/4" = 1'-0"

SITE NUMBER:

BASE MODEL:

ASSET TYPE:

OWNER:

CLASSIFICATION:

BASE VERSION:

PROJECT YEAR:

Suite 606 Chicago, IL 60605 Tel: 312-427-4702

Fax: 312-427-6611

FURNITURE PACKAGE:

DESIGN BULLETINS:

UPGRADE CLASSIFICATION:

Wallin - Gomez Architects, Ltd.

711 South Dearborn Street

e-mail: admin@wgaltd.com

01-08-16 | ISSUED FOR PERMIT & BID

PROPRIETARY INFORMATION. IT SHALL NOT BE USED OR REPRODUCED OR ITS CONTENTS DISCLOSED, IN WHOLE OR IN PART WITHOUT THE PRIOR WRITTEN CONSENT OF WALLIN / GOMEZ ARCHITECTS, LTD.

THESE DRAWINGS HAVE BEEN PREPARED AT

AND / OR UNDER MY SUPERVISION AND TO THE BEST OF MY KNOWLEDGE AND BELIEF CONFORM AND COMPLY WITH THE REQUIREMENTS OF THE DEPARTMENT OF BUILDING AND CODES HAVING JURISDICTION.

PLOT DATE 1/8/2016
PROJECT NUMBER 15130
DRAWN BY CL/KH
CHECKED BY DJW

STATE OF INDIANA AR19500067

REGISTERED ARCHITECT

DONALD J. WALLIN EXPIRATION DATE: 12/31/2017

07588

CONVERSION

FRANCHISE

JARO FOODS


2015 OCT 16


STANDARD


2015

2015

REFRESH

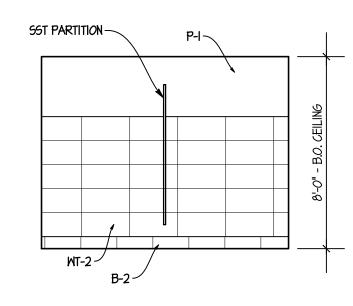


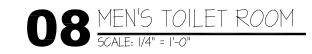

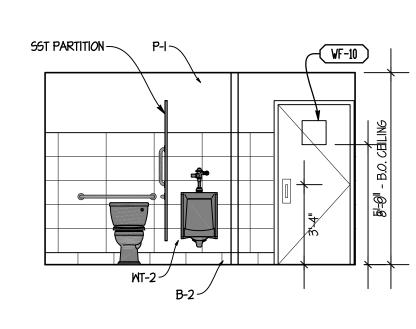


07 MEN'S TOILET ROOM

SCALE: 1/4" = 1'-0"

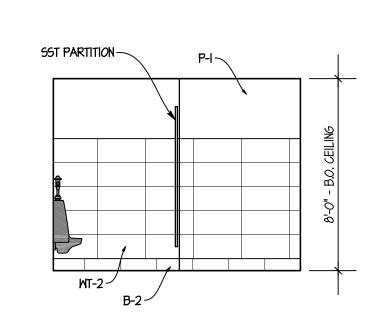


06 MEN'S TOILET ROOM

SCALE: 1/4" = 1'-0"

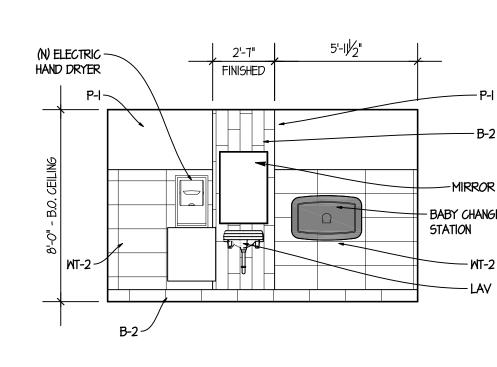


05 MEN'S TOILET ROOM

SCALE: 1/4" = 1'-0"

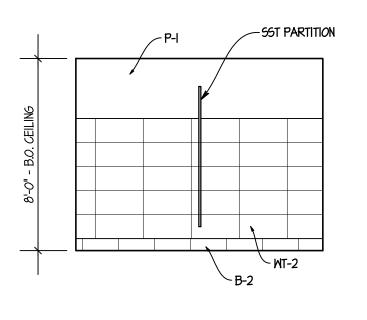


O4 MOMEN'S TOILET ROOM

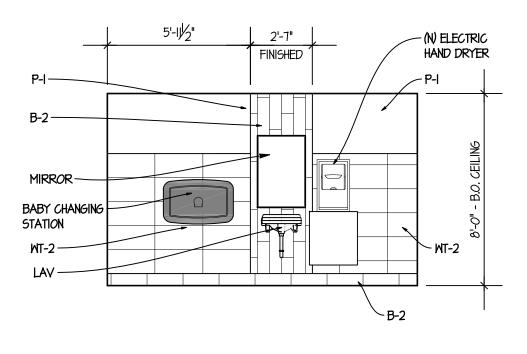


03 MOMEN'S TOILET ROOM


SCALE: 1/4" = 1'-0"

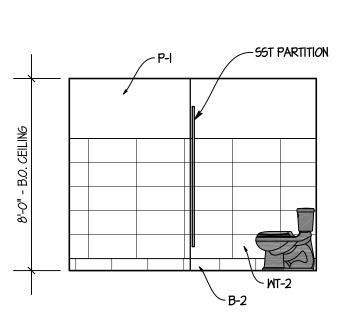


02 <u>MOMEN'S TOILET ROOM</u> <u>5CALE: 1/4" = 1'-0"</u>

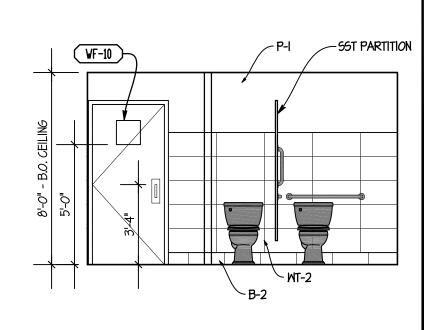





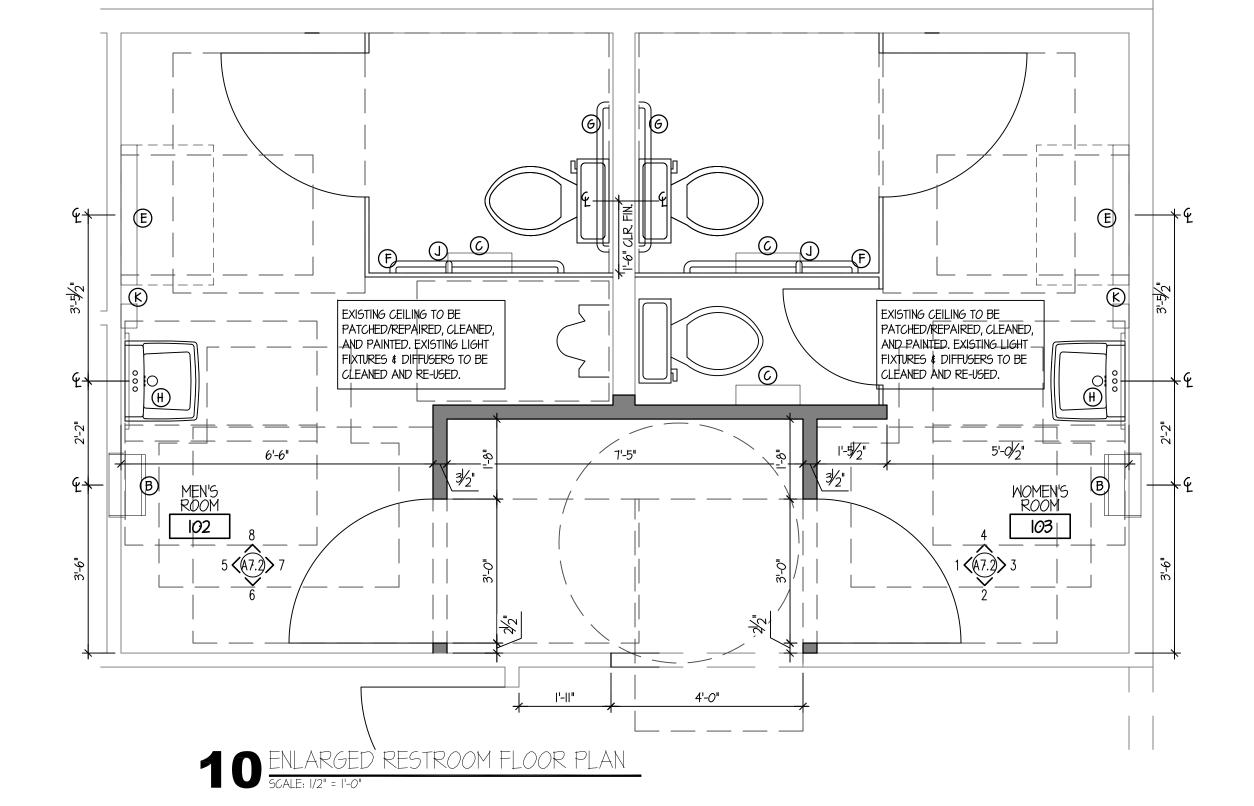

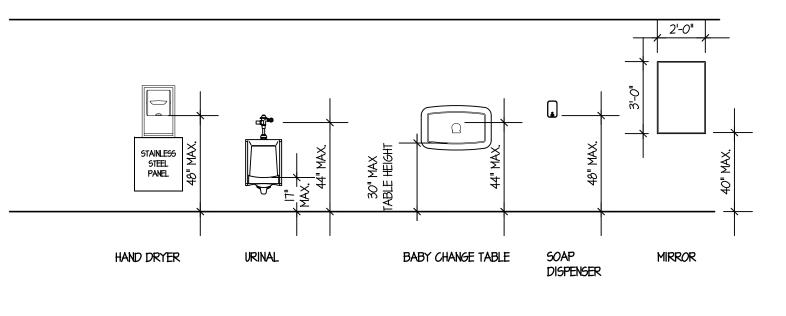


TYPICAL TOILET ROOM DIMENSIONS

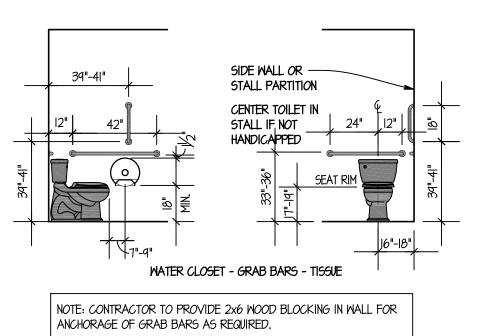

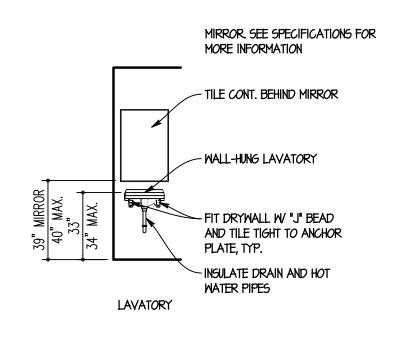

INTERIOR ELEVATIONS

AT RESTROOMS

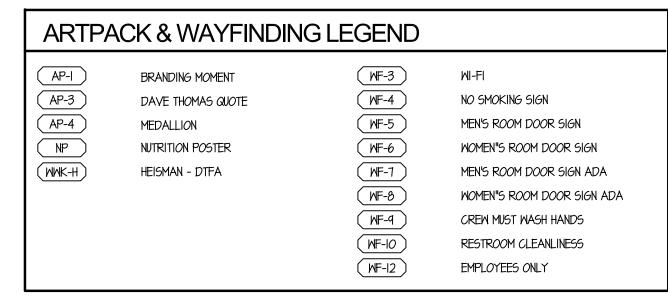

NOTE: THE CONTRACTOR SHALL PROVIDE AND INSTALL SOLID WOOD BLOCKING FOR ALL WALL MOUNTED ITEMS, SIGNS, EQUIPMENT, MILLWORK, ETC. COORDINATE LOCATIONS WITH OWNER'S CONSTRUCTION REP AS NECESSARY.

FREEZER 112 COOLER 111 PREPARATION AREA	N-BOX WF-4 WF-4 WF-6 WF-6 WF-6 WF-6 WF-10 W	WESTIBULE 100 AP-1 FRICARIED RESERVALES RESERVALE
		NORTH EQUIPMENT PLAN SCALE: 1/4" = 1'-0"

MARK	QTY.	EQUIPMENT SCHE	DULE	FURNISHED BY	2
2		DESCRIPTION OF EQUIPMENT	REMARKS	FURNI	T I I VI
A0100	ı	BEVERAGE SYSTEM DRIVE-THRU (BEVARIETY)		0	0
CO2O#	3	SOAP DISPENSERS	*OWNER TO VERIFY ACTUAL EQUIPMENT/MODEL TO BE USED	0	0
CO30#	2	HAND DRYER	*OWNER TO VERIFY ACTUAL EQUIPMENT/MODEL TO BE USED	0	0
CO30#	1	PAPER TOWEL DISPENSER - KITCHEN	*OWNER TO VERIFY ACTUAL EQUIPMENT/MODEL TO BE USED	E5	GO
CO102	<u> </u>	6 HOLE CUP DISPENSER (SADDLE TYPE)		E5	ES
	<u> </u>				+
C0700	3	TOILET TISSUE DISPENSER		E5	ES
C1801		LID/STRAW DISPENSER		E5	ES
D0100		POS MONITOR	_	0	0
D0200	2	POS TERMINAL	-	0	0
El405	1	FRONT COUNTER (COUNTER TOP ONLY)	-	E5	ES
	<u> </u>				+
					+
					+
			1		+
NO202	2	CASH DROP BOX		E5	ES
					\top
					T
					1
U0501	1	STATIC MENU BOARDS	*OWNER TO VERIFY ACTUAL EQUIPMENT/MODEL TO BE USED	0	0
UO5O2	2	STATIC QUEUING BOARDS	*OWNER TO VERIFY ACTUAL EQUIPMENT/MODEL TO BE USED	0	0
V0503	I	STATIC RHR BOARD	*OWNER TO VERIFY ACTUAL EQUIPMENT/MODEL TO BE USED	0	0
T0302	ı	FAUCET - HAND SINK (HANDS FREE)		ES	GC
T270I	-	HAND SINK		ES	GC

SITE NUMBER:	07588
BASE MODEL:	CONVERSION
ASSET TYPE:	FRANCHISE
CLASSIFICATION:	REFRESH
OWNER:	JARO FOODS
BASE VERSION:	2015 OCT 16
UPGRADE CLASSIFICA	TION:
	STANDARD
PROJECT YEAR:	2015
FURNITURE PACKAGE:	2015

Wallin - Gomez Architects, Ltd.

711 South Dearborn Street Suite 606 Chicago, IL 60605

DESIGN BULLETINS:

Tel: 312-427-4702 Fax: 312-427-6611 e-mail: admin@wgaltd.com

STORE #07588
747 SOUTH STATE ROAD 13

		0) 0
REV.	DATE	DESCRIPTION
	01-08-16	ISSUED FOR PERMIT & BID

PLOT DATE 1/8/2016
PROJECT NUMBER 15130
DRAWN BY CL/KH
CHECKED BY DJW


NOTICE: THIS DOCUMENT CONTAINS
PROPRIETARY INFORMATION. IT SHALL NOT
BE USED OR REPRODUCED OR ITS CONTENTS
DISCLOSED, IN WHOLE OR IN PART WITHOUT
THE PRIOR WRITTEN CONSENT OF WALLIN /
GOMEZ ARCHITECTS, LTD.


THESE DRAWINGS HAVE BEEN PREPARED AT AND / OR UNDER MY SUPERVISION AND TO THE BEST OF MY KNOWLEDGE AND BELIEF CONFORM AND COMPLY WITH THE REQUIREMENTS OF THE DEPARTMENT OF BUILDING AND CODES HAVING JURISDICTION.


STATE OF INDIANA
AR19500067
REGISTERED ARCHITECT
DONALD J. WALLIN
EXPIRATION DATE: 12/31/2017

. . .

SHEET NAME
EQUIPMENT PLAN
AND SCHEDULE

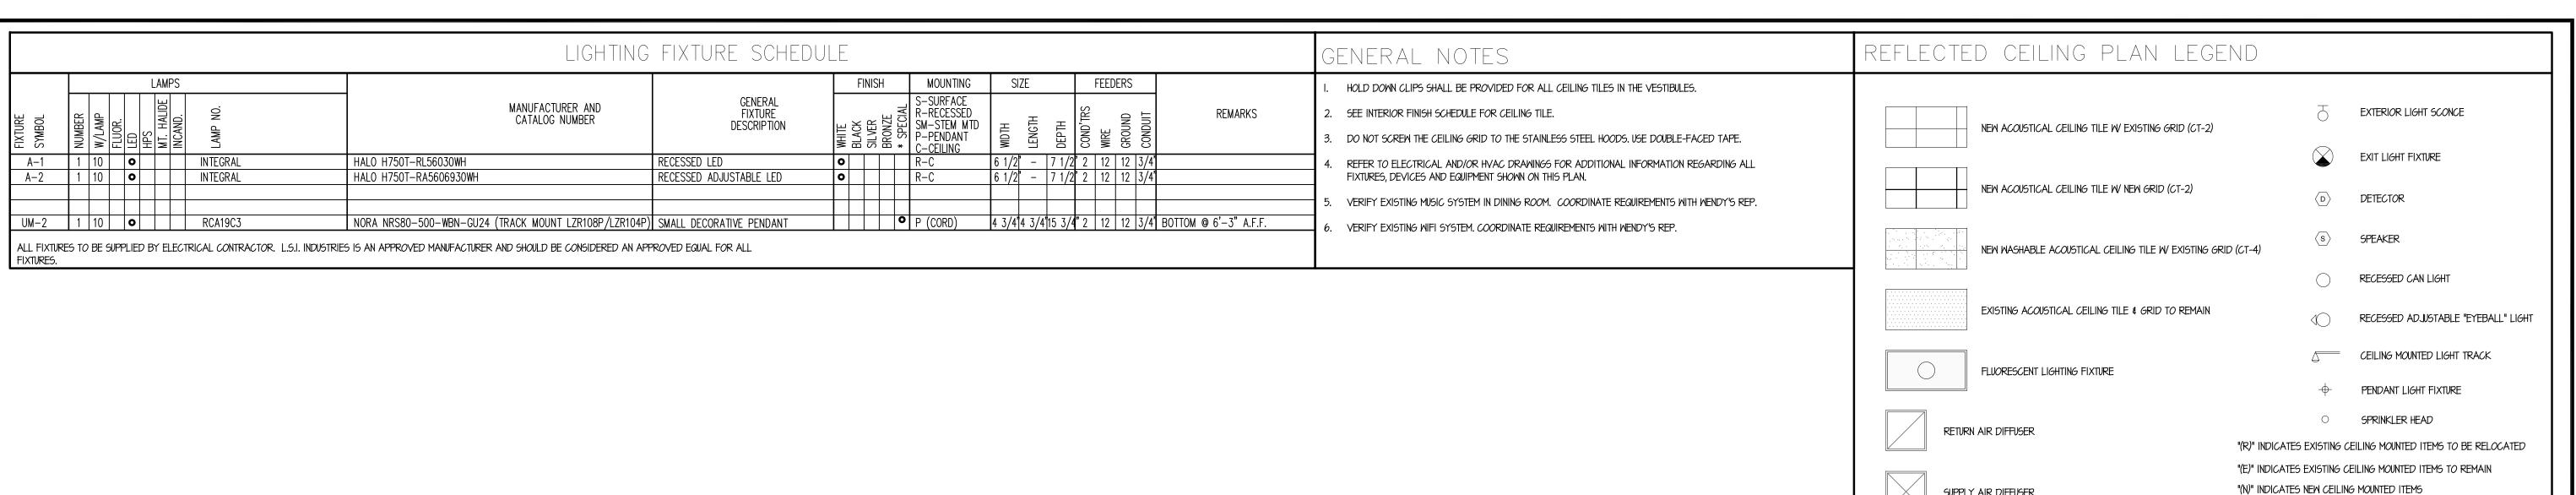

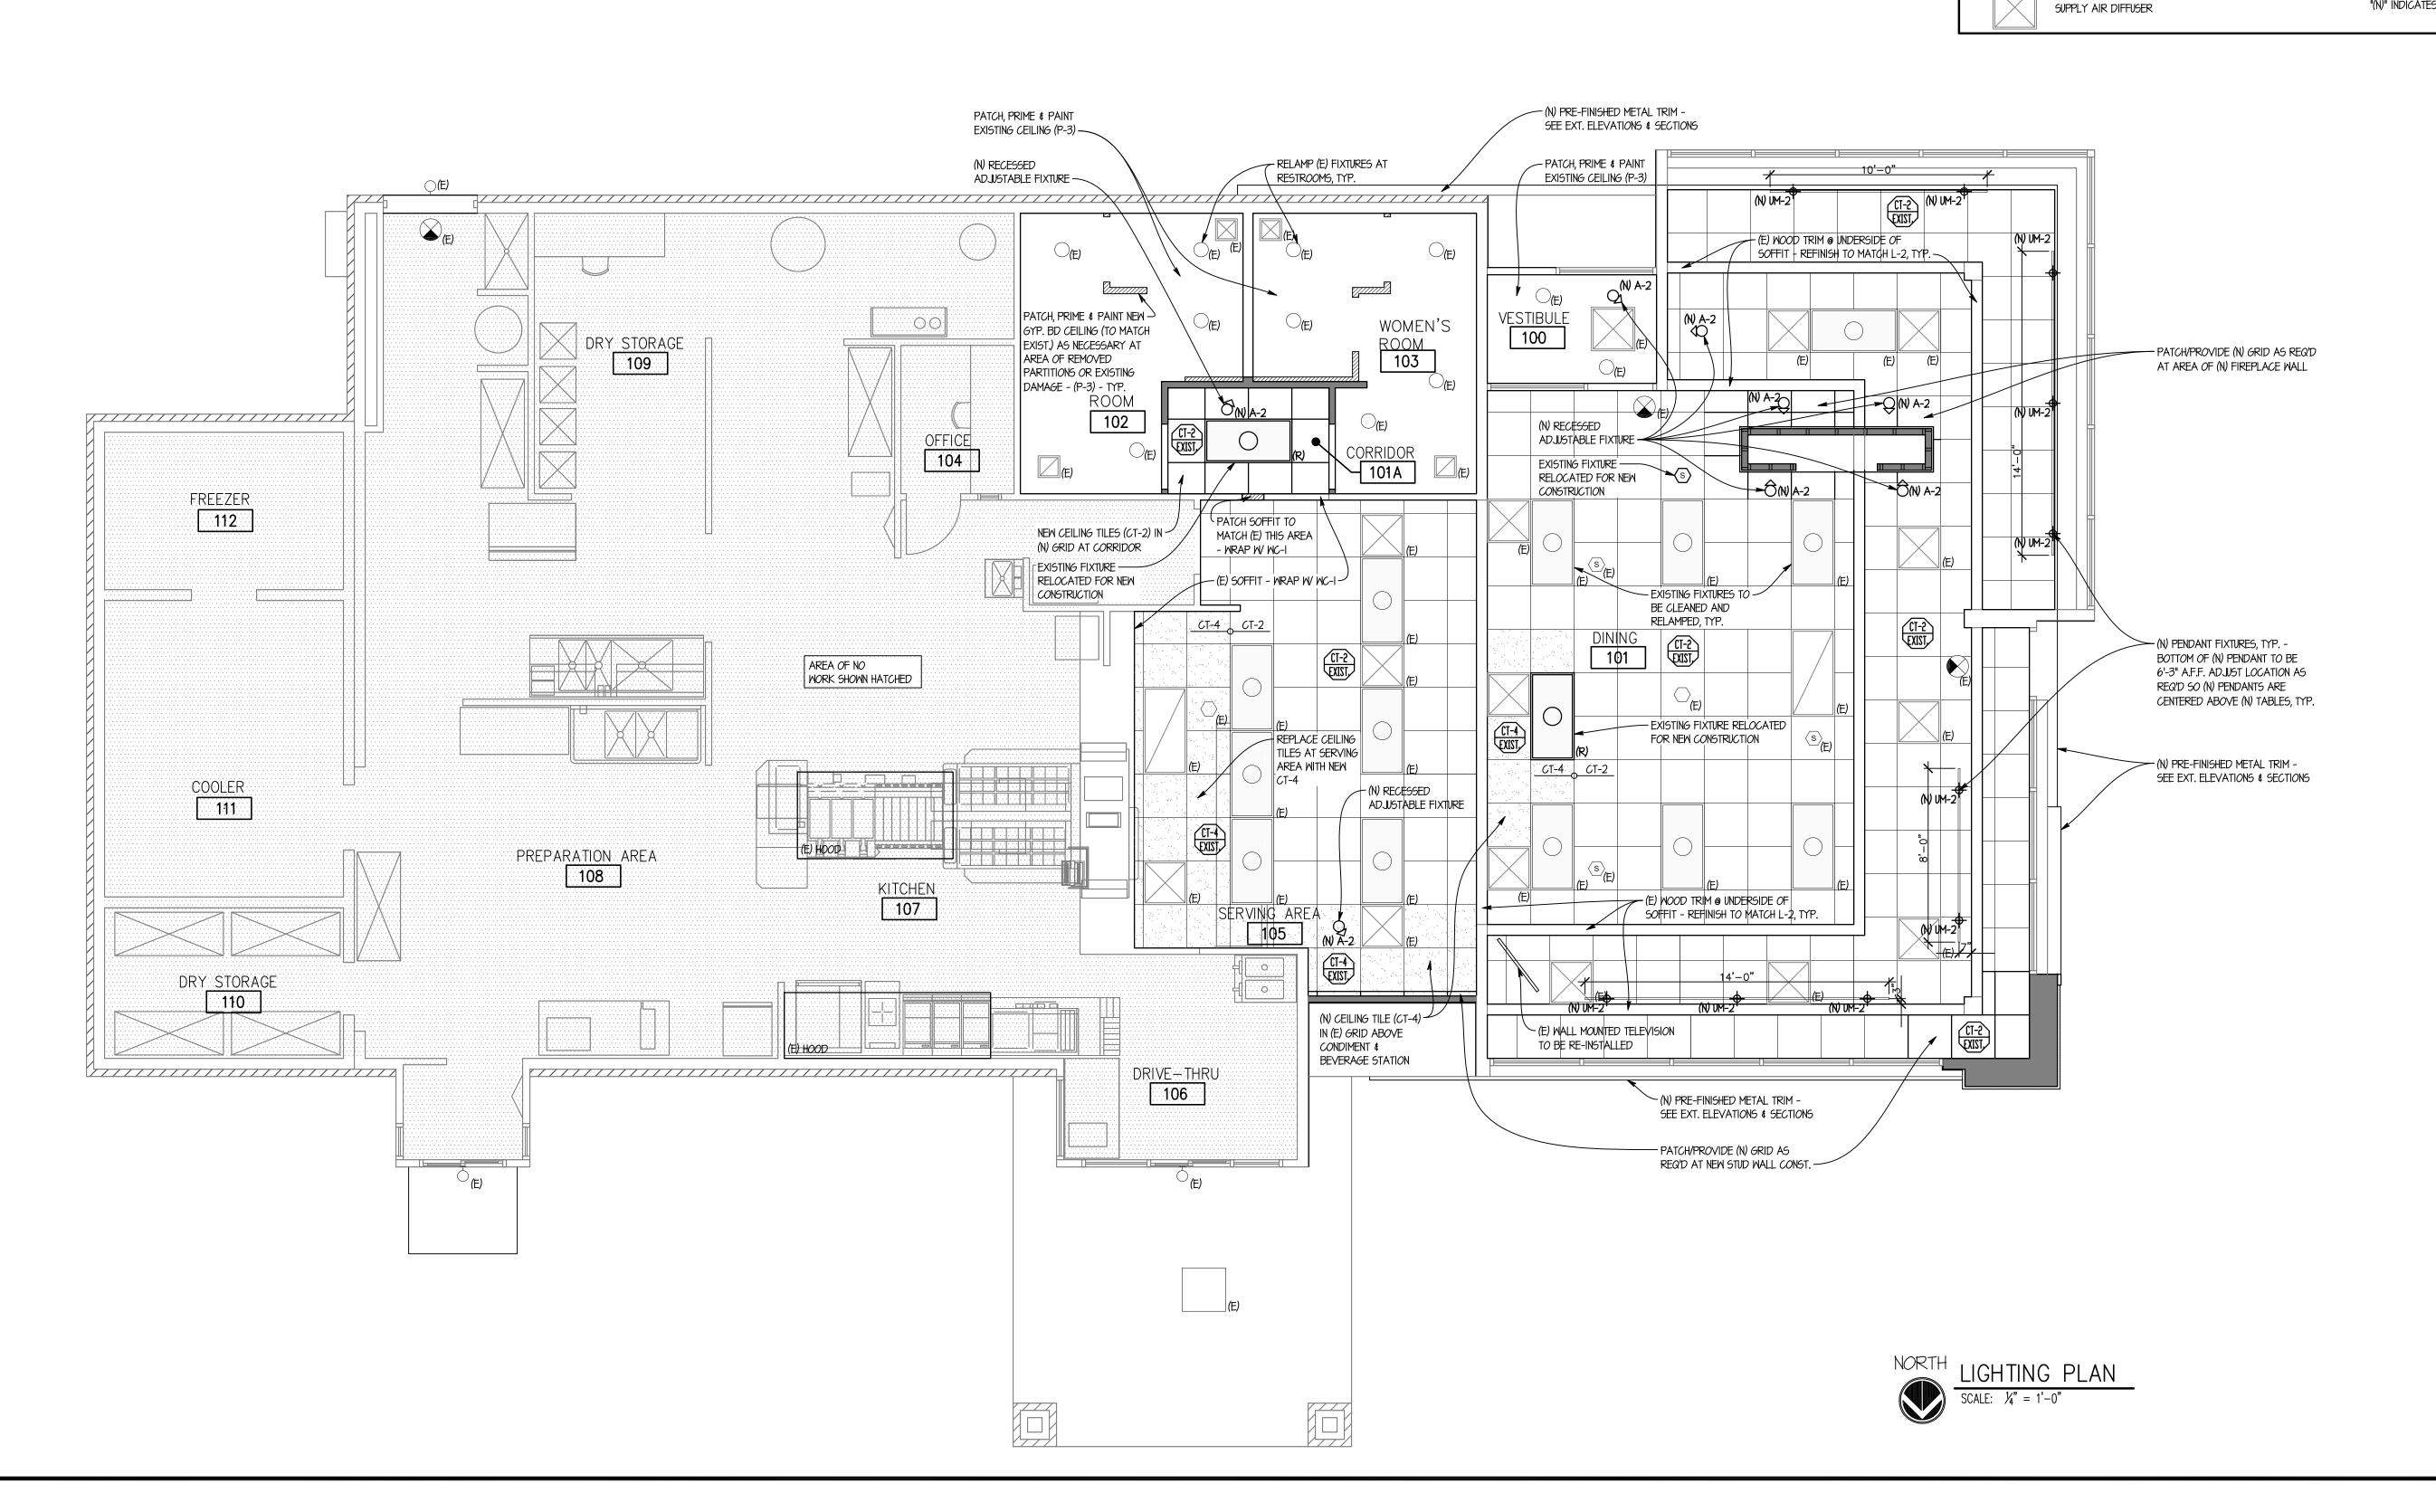

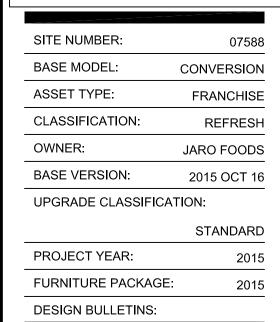

Wallin - Gomez Architects, Ltd.

711 South Dearborn Street Suite 606 Chicago, IL 60605 Tel: 312-427-4702 Fax: 312-427-6611

Tel: 312-427-4702 Fax: 312-427-6611 e-mail: admin@wgaltd.com



	TOTAL STATE STATE OF THE STATE	
REV.	DATE	DESCRIPTION
	01-08-16	ISSUED FOR PERMIT & BID


PLOT DATE 1/8/2016
PROJECT NUMBER 15130
DRAWN BY CL/KH
CHECKED BY DJW

NOTICE: THIS DOCUMENT CONTAINS
PROPRIETARY INFORMATION. IT SHALL NOT
BE USED OR REPRODUCED OR ITS CONTENTS
DISCLOSED, IN WHOLE OR IN PART WITHOUT
THE PRIOR WRITTEN CONSENT OF WALLIN /
GOMEZ ARCHITECTS, LTD.


THESE DRAWINGS HAVE BEEN PREPARED AT

AND / OR UNDER MY SUPERVISION AND TO THE BEST OF MY KNOWLEDGE AND BELIEF CONFORM AND COMPLY WITH THE REQUIREMENTS OF THE DEPARTMENT OF BUILDING AND CODES HAVING JURISDICTION.

STATE OF INDIANA
AR19500067
REGISTERED ARCHITECT
DONALD J. WALLIN
EXPIRATION DATE: 12/31/2017

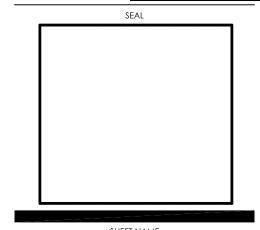

REFLECTED CEILING & LIGHTING PLAN

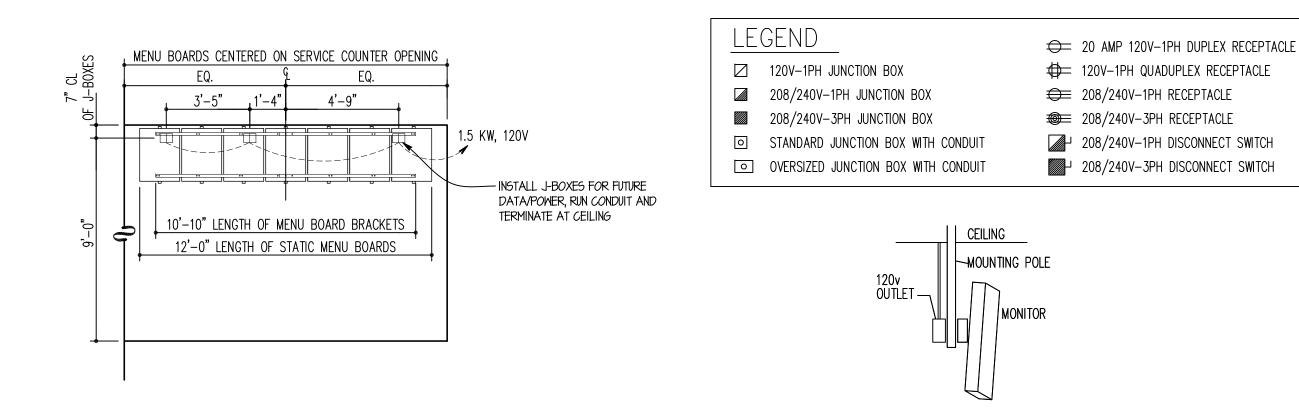


O1 STATIC MENU BOARD ROUGH-IN ELEVATION

SCALE: 1/4" = 1'-0"

02 MONITOR SCHEMATIC

	LOAD				VOLT	AGE		CONNECTIONS			FEE	DER		
CIRCUIT NUMBER	DESCRIPTION HE WAS A STATE OF THE PROPERTY OF		KILOWATTS	120V-IPH	208V-1PH	208V-3PH	120/208V-1РН	TYPE	PLUG CORD FURNISHED *	CONDUCTORS *	WIRE SIZE	GROUND SIZE	CONDUIT SIZE	NOTES
_	VERTICAL MENUBOARD		.5	0				DIRECT	ES	2	12	12	3/4"	
_	MENUBOARD		1.5	0				DIRECT	ES	2	12	12	3/4"	
_	REDHEAD ROASTER		.5	0				RECEPTACLE	ES	2	12	12	3/4"	
-	RUNNER SCREEN		.2	0				RECEPTACLE	ES	2	12	12	3/4"	
(E)	SELF SERVE FREESTYLE		1.4	0				RECEPTACLE	ES	2	12	12	3/4"	
(E)	CONDENSER		2.5		0			WP DISC SWITCH @ UNIT	ES	3	10	10	3/4"	
-	TV		8.	0				RECEPTACLE	ES	2	12	12	3/4"	
-	WIFI/CONVENIENCE OUTLETS		1.5	0				DIRECT	ES	2	12	12	3/4"	
-	ELECTRIC FIREPLACE		.2	0				DIRECT	EC	2	12	12	3/4"	

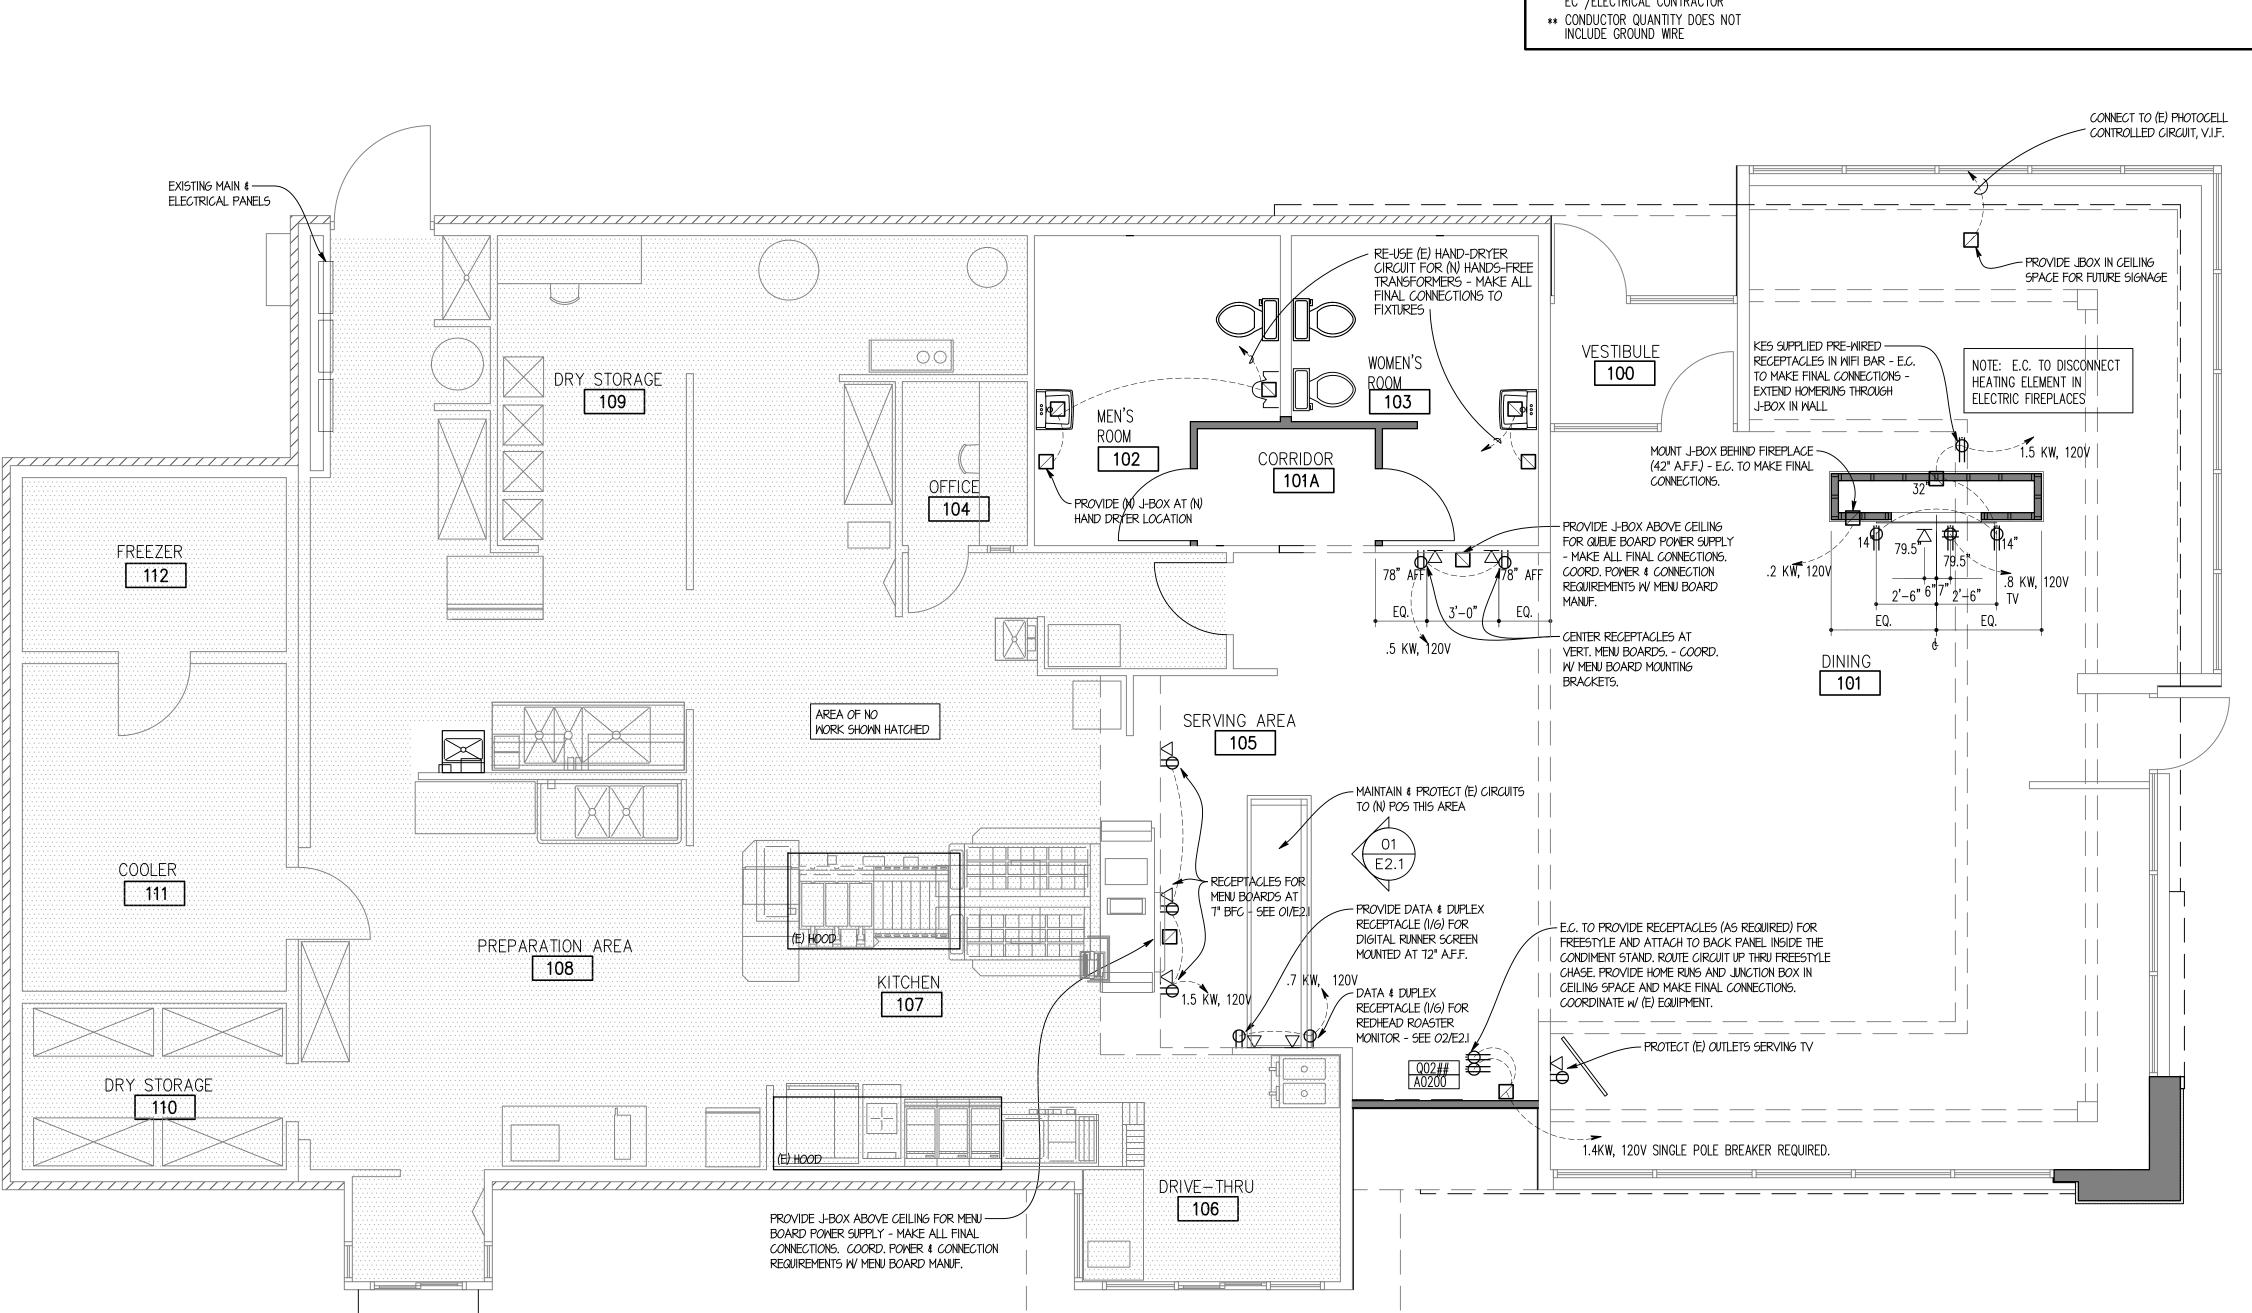

ELECTRIC MOTOR

□ DATA CONNECTION

TELEPHONE TERMINATION

BFC BELOW FINISHED CEILING

AFF ABOVE FINISHED FLOOR

GENERAL NOTES

- 1. REFER TO "WIRING AND SITE PREPARATION GUIDE" AS PREPARED BY 'WENDY'S INTERNATIONAL' "INFORMATION SYSTEMS DEPARTMENT" FOR INSTALLATION OF POINT OF SALE CASH REGISTER SYSTEM.
- 2. ELECTRICAL CONTRACTOR TO COORDINATE WORK WITH MECHANICAL, REFRIGERATION AND EQUIPMENT CONTRACTORS, INCLUDING COOLER/FREEZER WORK. (IF APPLICABLE)
- 3. ELECTRICAL CONTRACTOR TO VERIFY ALL ROUGH—IN DIMENSIONS AND POWER REQUIREMENTS WITH
- KITCHEN EQUIPMENT SUPPLIER PRIOR TO ROUGH-IN.
- 4. ELECTRICAL CONTRACTOR TO HOOK UP FIELD CONNECTIONS WITHIN FRONT COUNTER, AND ICE MACHINE REMOTE UNIT (ON ROOF) AT TIME OF INSTALLATION.
- TO THE CENTER OF THE BOX UNLESS OTHERWISE NOTED.

 6. ELECTRICAL CONTRACTOR IS RESPONSIBLE FOR INSTALLING ALL TELEPHONE LINES AND
- TERMINATIONS. VERIFY QUANTITY AND LOCATIONS WITH OWNER PRIOR TO BIDDING.
- ALL CIRCUITS MAY BE CORRECTED TO THE LEAST AMOUNT OF CONDUIT RUN UNLESS OTHERWISE NOTED.

HEIGHTS INDICATED FOR RECEPTACLES AND JUNCTION BOXES ARE MEASURED FROM FINISH FLOOR

- 8. ALL COVER PLATES TO BE SATIN FINISH STAINLESS STEEL THROUGHOUT UNLESS OTHERWISE
- ALL NEW 120V RECEPTACLES IN KITCHEN TO HAVE GROUND—FAULT CIRCUIT INTERRUPTER PROTECTION. OTHER GFI'S SHOWN SEPARATELY.
- 10. FOR THE IBM POINT OF SALE REGISTER SYSTEM ONLY: ALTERNATE P.O.S. SUPPLIERS MUST CONFORM TO THE REGISTER LAYOUT OR PROVIDE THE OWNER AND/OR GENERAL CONTRACTOR WITH WIRING DIAGRAMS AND INSTALLATION DETAILS BEFORE THE ELECTRICAL CONTRACTOR STARTS ANY WORK
- 11. ALL CONDUITS SHOULD BE STEEL FLEX OR PLASTIC STUBBED OUT ABOVE THE CEILING LINE AND TERMINATED INTO A J-BOX AS NOTED AND CAPABLE OF ACCEPTING A FACEPLATE COVER. SEE
- 12. ALL J-BOXES SHOULD BE INSTALLED IN SUCH A WAY THAT THEY ARE NOT BLOCKED BY OTHER EQUIPMENT OR STRUCTURAL COMPONENTS.
- 13. ALL I/G OUTLETS (HUBBELL IG5362 ORANGE OR EQUAL) MUST BE CLEARLY LABELED.
- 14. ALL CABLE ACCESS OPENINGS THRU S/S MUST HAVE RUBBER OR PLASTIC GROMMETS INSTALLED.
- 15. THE ELECTRIC SERVICE FOR THE GFI OUTLET/SCOREBOARD MUST BE ON A SEPARATE BREAKER (NOT CONNECTED TO THE MENU BOARD OR OUTSIDE LIGHT FEED).
- 16. HEIGHTS INDICATED FOR RECEPTACLES AND J-BOXES ARE MEASURED FROM FINISH FLOOR TO THE CENTER OF BOX. U.N.O.
- 17. EXISTING ENERGY MANAGEMENT SYSTEM TO REMAIN AND BE FULLY OPERATIONAL AT COMPLETION OF REMODEL.

SITE NUMBER: 07588

BASE MODEL: CONVERSION

ASSET TYPE: FRANCHISE

CLASSIFICATION: REFRESH

OWNER: JARO FOODS

BASE VERSION: 2015 OCT 16

UPGRADE CLASSIFICATION:

STANDARD

	STANDARD	
ROJECT YEAR:	2015	
URNITURE PACKAGE:	2015	
ESIGN BULLETINS:		

Wallin - Gomez Architects, Ltd.

711 South Dearborn Street Suite 606 Chicago, IL 60605

Tel: 312-427-4702 Fax: 312-427-6611 e-mail: admin@wgaltd.com

STORE #07588
747 SOUTH STATE ROAD 1

REV. DATE DESCRIPTION


01-08-16 ISSUED FOR PERMIT & BID

PLOT DATE 1/8/2016
PROJECT NUMBER 15130
DRAWN BY CL/KH
CHECKED BY DJW

NOTICE: THIS DOCUMENT CONTAINS
PROPRIETARY INFORMATION. IT SHALL NOT
BE USED OR REPRODUCED OR ITS CONTENTS
DISCLOSED, IN WHOLE OR IN PART WITHOUT
THE PRIOR WRITTEN CONSENT OF WALLIN /
GOMEZ ARCHITECTS, LTD.

THESE DRAWINGS HAVE BEEN PREPARED AT AND / OR UNDER MY SUPERVISION AND TO THE BEST OF MY KNOWLEDGE AND BELIEF CONFORM AND COMPLY WITH THE REQUIREMENTS OF THE DEPARTMENT OF BUILDING AND CODES HAVING JURISDICTION.

STATE OF INDIANA
AR19500067
REGISTERED ARCHITECT
DONALD J. WALLIN
EXPIRATION DATE: 12/31/2017

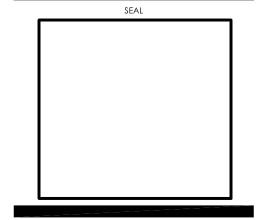

ELECTRICAL



INDEX TO SPECIFICATIONS

DIVISION 1 — GENERAL SPECIFICATIONS (OMITTED)

DIVISION 3 - CONCRETE

FOOTINGS SLABS AND FOOTINGS SIDEWALKS AND RAMPS PAVING CONCRETE PADS

DIVISION 4 - MASONRY

GENERAL MORTAR FOR FACE BRICK FACE BRICK

DIVISION 5 - METALS

GENERAL ORNAMENTAL METAL RAILING (OUTSIDE - REQUIRED)

DIVISION 6 - WOOD, PLASTICS, AND COMPOSITES

ROUGH CARPENTRY STRUCTURAL LUMBER FINISH CARPENTRY SOLID SURFACING MATERIAL BUILDING WRAP/WEATHER BARRIER

DIVISION 7 - THERMAL AND MOISTURE PROTECTION

BUILDING INSULATION INSULATION ATTACHMENT (MECHANICAL) GENERAL ROOFING DELIVERY HANDLING STORAGE OVERNIGHT COVER ROOFING AND SHEET METAL SURFACE PREPARATION WOOD DECKS MEMBRANE FLASHING PERIMETER LAPS PROJECT / SITE CLEAN-UP INSPECTIONS CONTRACTOR QUALIFICATION ASSURANCE METAL TRIMS CORRUGATED METAL PANELS SEALANT SEALANT MATERIALS

DIVISION 8 - OPENINGS

E.I.F.S.

ALUMINUM ENTRANCE DOORS AND STOREFRONT GLAZING STEEL SERVICE DOORS AND FRAMES PREFINISHED DOORS PICK-UP WINDOW ACCESS PANELS

DIVISION 9 - FINISHES

ACM PANELS FLOOR AND WALL TILE INSTALLATION GYPSUM DRYWALL SUSPENDED CEILING SYSTEM WALLCOVERING NON-TILE FIBERGLASS REINFORCED POLYESTER (FRP) PANELS LUXURY VINYL TILE (LVT) PAINTING

PAINT SCHEDULE

DIVISION 10 - SPECIALTIES

EXTERIOR TRASH ENCLOSURE SIGNAGE ROOM IDENTIFICATION SIGN A.D.A. RESTROOM IDENTIFICATION SIGNSMOKELESS SNUFFER TOILET COMPARTMENTS PUBLIC RESTROOM ACCESSORIES LADDER RECEIVER

WALL DECOR HEIGHT WARNING DEVICE ORDER STATION CANOPY SMOKELESS SNUFFER STAINLESS STEEL CORNERS

KITCHEN EQUIPMENT HOOD FIRE SUPPRESSION SYSTEM AND PORTABLE FIRE EXTINGUISHERS WALK-IN COOLER/FREEZER/DRY STORAGE

DIVISION 22 - PLUMBING

COMMUNICATION SYSTEM

WATER CLOSETS LAVATORY URINALS MOP SINK FIXTURES AND EQUIPMENT

DIVISION 23 - HEATING, VENTILATING & AIR CONDITIONING

DIVISION 26 - ELECTRICAL

DIVISION 31 - EARTHWORK

EXCAVATION, BACK FILLING, GRADING

DIVISION 32 - EXTERIOR IMPROVEMENTS ASPHALT PAVING

CONCRETE PAVING STRIPPING AND PARKING BLOCKS LANDSCAPING

DIVISION 33 - UTILITIES

UTILITIES

CONTRACTOR BID SHEET APPROVED SUPPLIERS LIST

DIVISION 3 - CONCRETE

NOTE: FURNISH LABOR, MATERIALS AND EQUIPMENT NECESSARY TO COMPLETE CONCRETE WORK INCLUDING EXCAVATION, TRENCHING, FORM WORK, REINFORCING, CEMENT FINISH AND PRECAST CONCRETE.

SIDEWALKS AND RAMPS

DIVISION 5 - METALS

A-36.

NOTE: FURNISH LABOR, MATERIAL, AND EQUIPMENT NECESSARY TO COMPLETE THE MISCELLANEOUS STRUCTURAL AND DECORATIVE METAL WORK INDICATED ON THE DRAWINGS, MATERIALS TO MEET ASTM

A. PROVIDE METAL RAILINGS AS INDICATED ON THE DRAWINGS, RAILINGS SHALL BE COMPLETE WITH

POSTS, CAPS, PICKETS, RAILS AND FITTINGS. FINISH AS NOTED ON DRAWINGS.

ORNAMENTAL METAL RAILINGS (OUTSIDE - SAFETY RAIL)

A. 4,000 PSI AIR ENTRAINED CONCRETE, 4" THICK, BROOM FINISH SCORE WITH 3/4" DEEP CONTRACTION JOINTS INTO APPROXIMATELY 4'-0" SQUARES AS SHOWN ON DETAIL ON THE FOUNDATION PLAN.

DIVISION 6 - WOOD, PLASTICS, AND COMPOSITES

FURNISH LABOR, TOOLS, EQUIPMENT AND MATERIALS TO COMPLETE WORK UNDER THIS HEADING AS INDICATED ON THE DRAWINGS AND DESCRIBED IN THE SPECIFICATIONS.

ROUGH CARPENTRY

LOCAL ORDINANCES.

- A. PROVIDE AND MAINTAIN TEMPORARY ENCLOSURES, AND BARRICADES AS REQUIRED BY GOVERNING
- B. PROVIDE TEMPORARY DOOR AND WINDOW ENCLOSURES AS REQUIRED. C. HEADERS TO BE SIZED AS DETAILED IN THE STRUCTURAL DRAWINGS.

FINISH CARPENTRY

- A. FURNISH LABOR AND MATERIALS TO COMPLETE WORK UNDER THIS SECTION AS INDICATED ON DRAWINGS AND DESCRIBED IN THESE SPECIFICATIONS.
- B. HARDWARE DIMENSIONS ARE TO BE NET SIZE AND NOT NOMINAL SIZE. MATERIAL FOR INTERIOR FINISH SHALL BE AS FOLLOWS:
- 1. DINING ROOM TRIM REFER TO FINISH SCHEDULE & DETAILED DRAWINGS. 2. COUNTERTOPS TO BE FURNISHED AND INSTALLED BY KITCHEN EQUIPMENT SUPPLIER.

SOLID SURFACING MATERIAL

A. VANITY TOPS AND WINDOW SILLS: DUPONT CORIAN, COLORS AS NOTED ON DRAWINGS. B. PROVIDE IN THICKNESS, FINISH AND EDGE TREATMENT AS REQUIRED AND COORDINATED WITH THE

BUILDING WRAP/WEATHER BARRIER

- A. ASTM F1677, TYPE 1: DUPONT TYVEK COMMERCIALWRAP.
- B. BUILDING-WRAP TAPE: PRESSURE-SENSITIVE PLASTIC TAPE RECOMMENDED BY BUILDING-WRAP MANUFACTURER FOR SEALING JOINTS AND PENTRATIONS IN BUILDING WRAP.

DIVISION 7 - THERMAL AND MOISTURE PROTECTION

BUILDING INSULATION

- A. FURNISH LABOR, MATERIALS AND EQUIPMENT NECESSARY TO COMPLETE WORK AS INDICATED ON THE
- CONSTRUCTION DOCUMENTS AND DESCRIBED IN THE SPECIFICATIONS. B. EXTERIOR WALL INSULATION: REFER TO INSULATION SCHEDULE ON DRAWINGS.
- C. VAPOR BARRIER SHALL BE GRIFFOLYN T-65 BY REEF INDUSTRIES, INC. OR EQUAL. THE MATERIAL SHALL HAVE A 3-PLY, HIGH DENSITY POLYETHYLENE AND NYLON YARN LAMINATE. MATERIAL SHALL HAVE A REINFORCED NON-WOVEN GRID WITH A PPT TEAR STRENGTH OF AT LEAST 15.0 LBS. VAPOR BARRIER SHALL BE APPLIED IN THE WIDEST PRACTICAL WIDTHS. SIDE AND END JOINTS SHALL BE LAPPED AT LEAST 6". LAPS SHALL BE SEALED USING FAB TAPE. PUNCTURES OR TEARS ARE TO BE REPAIRED USING GRIFFOLYN'S GRIFF TAPE, FAB TAPE OR EQUAL. VAPOR BARRIER MUST PROVIDE A COMPLETE SEAL TO PREVENT MOISTURE TRANSFER. NOTE: FOR SOUTHERN COASTAL AREAS, THE VAPOR BARRIER SHOULD BE USED ON THE EXTERIOR OF THE WALL. WHERE THERE IS UNCERTAINTY, FOLLOW LOCAL PRACTICE.
- D. RIGID ROOF INSULATION: FURNISHED AND INSTALLED BY THE ROOFING CONTRACTOR. INSULATION TO BE MINIMUM OF (2) LAYERS OF ROOF MANUFACTURER'S RECOMMENDED INSULATION BOARDS. INSTALL IN THICKNESS REQUIRED TO MEET THE R-VALUES INDICATED IN THE INSULATION SCHEDULE ON DRAWINGS. CONTRACTOR TO PROVIDE BID UTILIZING DURO-GUARD ISO II BOARDS. 'ENRGY 3' INSULATION BOARDS BY JOHNS MANVILLE ARE AN ACCEPTABLE EQUAL.
- E. PERIMETER INSULATION: REFER TO INSULATION SCHEDULE ON DRAWINGS..

FLASHING

- A. FLASHING ON PARAPET WALLS SHALL BE FASTENED 12" ON CENTER ALONG BOTTOM ON MAIN DECK WITH A MINIMUM 6" LAP WELDABLE TO DECK MEMBRANE, COVERING APPROVED FASTENERS. PARAPET WALLS SHALL BE COVERED MINIMUM OF 12" HIGH.
- B. PROVIDE AND INSTALL FLASHING FOR PARAPET WALLS. (FINISH AS NOTED ON EXTERIOR ELEVATIONS AND SCHEDULES.)
- C. FLASH AND COUNTER-FLASH ITEMS THAT PASS THROUGH THE ROOF PROVIDE "PITCH POCKETS" AS REQUIRED TO FORM A COMPLETE JOB.
- D. PROVIDE NECESSARY MOUNTING CLIPS, CLOSURES, FASTENINGS, ETC., REQUIRED TO COMPLETE THE COUNTER-FLASHING, GRAVEL STOPS, CAPS AND COPINGS, INDICATED ON THE DRAWINGS.

PERIMETER LAPS

A. ANY TIME A ROOF EDGE DOES NOT HAVE A PARAPET WALL OR ROOF TIE-IN, (I.E. DRIP EDGE, WATER/GRAVEL STOP, TERMINATION BAR ON EDGE, GUTTER, ETC.) THEN THE ROOF SECTION MUST HAVE A LAP 27" IN FROM THE EDGE AND REVERSED. THIS HELPS REDUCE WIND UP-LIFT AROUND PERIMETERS AND REVERSING THE LAP, ALLOWS CONTRACTOR APPLICATOR TO PLACE ROOF SECTION AWAY FROM THE EDGE.

PROJECT/SITE CLEAN-UP

A. UPON COMPLETION, THE ROOFING CONTRACTOR SHALL REMOVE RUBBISH, WASTE MATERIALS, ETC. FROM THE ROOF, LEAVING THE ROOF IN A CLEAN CONDITION AND FURTHER REMOVING SUCH ROOFING DEBRIS FROM THE WORK SITE. A RIGOROUS INSPECTION FOR WATERTIGHT FIELD SEAMS SHALL BE MADE AFTER COMPLETION OF JOB.

INSPECTIONS

A. UPON COMPLETION OF EACH ROOFING JOB, CONTRACTOR SHALL FILL OUT INSPECTION CARD AND RETURN TO MANUFACTURER. EACH ROOF SHALL BE INSPECTED BY AN AUTHORIZED QUALITY CONTROL FIELD INSPECTOR TO MAKE SURE APPLICATION MEETS MANUFACTURERS SPECIFICATIONS, BEFORE ISSUANCE OF WARRANTY. CONTRACTOR SHALL ACCOMPANY INSPECTOR ON INSPECTIONS AND OBTAIN SIGNED WARRANTY FROM CUSTOMER AND RETURN TO MANUFACTURER, WITH NO FINAL PAYMENT BEING MADE UNTIL AN OWNER'S REPRESENTATIVE HAS WARRANTY.

CONTRACTOR QUALIFICATION ASSURANCE

A. THE ROOFING CONTRACTOR SHALL BE DULY CERTIFIED BY ROOFING MANUFACTURER FOR COMPLETE APPLICATION AND INSTALLATION OF THIS ROOFING SYSTEM. TO MAINTAIN ROOF WARRANTY, FUTURE REPAIRS AND ALTERATIONS SHALL BE MADE BY PERSONNEL DULY CERTIFIED BY ROOFING MANUFACTURER.

METAL TRIMS

A. THIS SECTION INCLUDES METAL TRIM AT PARAPET CAPS, WALL CAPS, BREAK METAL TRIMS, AND THE BOTTOM TRIM ON THE FASCIAS. TRIM MATERIAL SHALL CONSIST OF PREFINISHED (REFER TO FINISH SCHEDULE FOR COLOR), .040" ALUMINUM SHEETS OR 24 GA. GALVALUME STEEL, FORMED TO THE PROFILES SHOWN ON THE DRAWINGS. ATTACHMENT TO THE SUB STRUCTURE SHALL BE BY NON-FERROUS FASTENERS THAT ARE CONCEALED FROM VIEW WHERE POSSIBLE. FASTENERS NOT CONCEALED FROM VIEW MUST MATCH THE COLOR OF THE TRIM BEING FASTENED.

CORRUGATED METAL PANEL SYSTEM

- A. MANUFACTURER: ALCOA ARCHITECTURAL PRODUCTS, 50 INDUSTRIAL BLVD., EASTMAN, GA 31023. 1. SYSTEM: 7.2" RIB PANEL.
- B. DESIGN REQUIREMENTS: 1. CONTINUOUS, ONE-PIECE, PREFORMED, PREFINISHED SINGLE LENGTH METAL WALL PANELS WITH
- EXPANSION JOINTS AT 20'-0" INTERVALS.
- 2. PANELS, FASTENERS AND OTHER COMPONENTS REQUIRED FOR SPECIFIC PROJECT CONDITIONS. 3. EXPOSED ADJACENT FLASHING SHALL BE OF THE SAME MATERIAL AND FINISH AS THE PANELS.
- 4. SEALANT PER MANUFACTURER'S WRITTEN SPECIFICATIONS. C. SHEET MATERIALS:
- 1. PREFINISHED BASE SHEET MATERIAL SHALL BE 7.2" RIB PANEL, 20 GAUGE. 2. FINISH COLOR SHALL BE CLASSIC BRONZE. UNLESS NOTED OTHERWISE, PRODUCTS SHALL BE OF THE
- SAME FINISH AND COLOR.
- 1. FABRICATE METAL WALL PANELS AND RELATED SHEET METAL WORK IN ACCORDANCE WITH APPLICABLE STANDARDS SET FORTH IN THE SMACNA ARCHITECTURAL SHEET METAL MANUAL.
- 2. WALL PANELS AND SHEET METAL FLASHING SHALL BE FABRICATED IN MINIMUM 10'-0" LENGTHS
- UNLESS NOTED OTHERWISE. E. EXECUTION:
- 1. G.C. IS RESPONSIBLE FOR ALL INSPECTION, INSTALLATION, FIELD QUALITY CONTROL AND CLEANING REQUIREMENTS OUTLINED IN THE MANUFACTURER'S WRITTEN SPECIFICATIONS.

- A. SURFACES TO RECEIVE SEALANT ARE TO BE DRY AND THOROUGHLY CLEANED OF LOOSE PARTICLES OF DIRT AND DUST, OIL, GREASE, OR OTHER FOREIGN MATTER.
- B. SEAL AT EXTERIOR DOOR FRAMES, WINDOW FRAMES, AND OPENINGS FOR PLUMBING, ELECTRICAL REFRIGERANT AND GAS LINES IN EXTERIOR WALLS, FLOORS AND ROOFS.

SEALANT MATERIALS

- A. JOINT LOCATIONS AND JOINT SEALANT TYPES ARE NOTED ON DRAWINGS. ACCEPTABLE
- MANUFACTURER/TYPE PER EACH JOINT TREATMENT TYPE IS AS FOLLOWS:
- B. JS-1 SINGLE COMPONENT SILICONE
- 1. DOW CORNING 791 2. GE SILICONES SILPURFLM SCS2700
- 3. PECORA 865 C. JS-2 SINGLE COMPONENT SILICONE
- 1. DOW CORNING 791
- 2. GE SILICONES SILPURFLM SCS2700 3. PECORA 865
- D. JS-3 SINGLE COMPONENT SILICONE
- 1. DOW CORNING 890-SL 2. PECORA 300 PAVEMENT SEALANT (NONSAG)
- E. JS-4 SINGLE COMPONENT SILICONE
- 1. DOW CORNING 890-SL 2. PECORA 300 PAVEMENT SEALANT (NONSAG)
- F. JS-5 SINGLE COMPONENT SILICONE
- 1. DOW CORNING 786 MILDEW RESISTANT 2. GE SILICONES SANITARY SCS1700
- 3. PECORA 860

SITE NUMBER: BASE MODEL: CONVERSION ASSET TYPE: FRANCHISE CLASSIFICATION: REFRESH OWNER: JARO FOODS BASE VERSION: 2015 OCT 16

UPGRADE CLASSIFICATION:

STANDARD PROJECT YEAR: 2015 FURNITURE PACKAGE: 2015

DESIGN BULLETINS:

Wallin - Gomez Architects, Ltd

711 South Dearborn Street Suite 606 Chicago, IL 60605

Tel: 312-427-4702 Fax: 312-427-6611 e-mail: admin@wgaltd.com




DESCRIPTION 01-08-16 ISSUED FOR PERMIT & BID

PLOT DATE 1/8/2016 PROJECT NUMBER 15130 DRAWN BY CL/KH CHECKED BY DJW

NOTICE: THIS DOCUMENT CONTAINS PROPRIETARY INFORMATION. IT SHALL NOT BE USED OR REPRODUCED OR ITS CONTENTS DISCLOSED, IN WHOLE OR IN PART WITHOUT THE PRIOR WRITTEN CONSENT OF WALLIN / GOMEZ ARCHITECTS, LTD.

THESE DRAWINGS HAVE BEEN PREPARED AT AND / OR UNDER MY SUPERVISION AND TO THE BEST OF MY KNOWLEDGE AND BELIEF CONFORM AND COMPLY WITH THE REQUIREMENTS OF THE DEPARTMENT OF BUILDING AND CODES HAVING JURISDICTION.

STATE OF INDIANA AR19500067 REGISTERED ARCHITECT DONALD J. WALLIN EXPIRATION DATE: 12/31/2017 SEAL

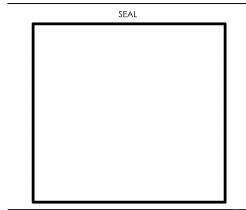

SPECIFICATIONS

DIVISION 8 - OPENINGS

ALUMINUM ENTRANCE DOORS, STOREFRONT

- DOORS AND WINDOWS SHALL HAVE PRODUCT LABELS INDICATING U-VALUE, SHGC AND AIR LEAKAGE RATE IN COMPLIANCE WITH LATEST ENERGY CODES. ALLOWED AIR LEAKAGE SHALL NOT EXCEED 1.0 CFM/FT2 FOR GLAZED DOORS AND 0.3 CFM/FT2 FOR WINDOWS.
- A. SYSTEMS: REFER TO EXTERIOR MATERIALS AND FINISHES SCHEDULE ON DRAWINGS.
- B. DOORS SHALL BE "350 MEDIUM STILE" DOOR, MANUFACTURED BY US ALUMINUM.
- C. HARDWARE FOR ENTRANCE DOORS: SEE HARDWARE SCHEDULE ON DRAWINGS. D. EXPOSED ALUMINUM MATERIAL SHALL BE KAWNEER #40 DARK BRONZE, OR US ALUMINUM DARK BRONZE
- OR OLD CASTLE DARK BRONZE. HARDWARE SHALL MATCH.
- E. MISCELLANEOUS TRIMS, SHAPES, SPACERS, AND ADAPTERS AS REQUIRED.

GLAZING

- A. EXTERIOR GLASS SHALL BE 1" INSULATED (UNLESS NOTED OTHERWISE) WITH U-VALUE AND SHGC AS NOTED ON EXTERIOR ELEVATIONS. SEE THE FINISH SCHEDULE FOR COLOR. GLAZING MUST MEET SAFETY CODES AS REQUIRED. GLASS MUST HAVE 5-YEAR WARRANTY AGAINST SEAL FAILURE. 1. GLASS THICKNESSES: SELECT MIN. GLASS THICKNESSES PER ASTM E 1300, PER FOLLOWING
 - a. SPECIFIED DESIGN WIND LOADS: DESIGN WIND LOADS APPLICABLE TO PROJECT FROM BASIC WIND SPEED - IN MILES PER HOUR (METERS PER SECOND) AT 33 FEET (10 M) ABOVE GRADE, ACCORDING TO ASCE 7, "MINIMUM DESIGN LOADS FOR BUILDINGS AND OTHER STRUCTURES": SECTION 6.4.2, "ANALYTIC PROCEDURE," BASED ON MEAN ROOF HEIGHTS ABOVE GRADE
- INDICATED ON DRAWINGS. b. Probability of Breakage for Vertical Glazing: 8 lites per 1000 for lites set VERTICALLY OR NOT MORE THAN 15 DEGREES OFF VERTICAL AND UNDER WIND ACTION.
- 1) LOAD DURATION: 60 SECONDS OR LESS. c. MINIMUM GLASS THICKNESS FOR EXTERIOR LITES: NOT LESS THAN 6 MM.
- d. THICKNESS OF TINTED AND HEAT-ABSORBING GLASS: 1) PROVIDE THE SAME THICKNESS FOR EACH TINT COLOR INDICATED THROUGHOUT PROJECT.
- B. PRODUCTS AND MANUFACTURERS 1. AVAILABLE PRODUCTS: SUBJECT TO COMPLIANCE WITH REQUIREMENTS, PRODUCTS THAT MAY BE INCORPORATED INTO THE WORK INCLUDE, BUT ARE NOT LIMITED TO, THE PRODUCTS INDICATED IN SCHEDULES ON THE DRAWINGS.
- C. PRIMARY FLOAT GLASS 1. ASTM C 1036, TYPE I (TRANSPARENT GLASS, FLAT), QUALITY Q3 (GLAZING SELECT); CLASS I
- (CLEAR). D. HEAT-TREATED FLOAT GLASS
- 1. ASTM C 1048; TYPE I (TRANSPARENT GLASS, FLAT); QUALITY Q3 (GLAZING SELECT); CLASS, KIND, AND CONDITION AS INDICATED. . INSULATING GLASS
- PREASSEMBLED UNITS CONSISTING OF SEALED LITES OF GLASS SEPARATED BY A DEHYDRATED INTERSPACE, AND COMPLYING WITH ASTM E 774 FOR CLASS CBA UNITS AND WITH REQUIREMENTS
- a. PROVIDE KIND HS (HEAT-STRENGTHENED) FLOAT GLASS IN PLACE OF ANNEALED GLASS WHERE NEEDED TO RESIST THERMAL STRESSES INDUCED BY DIFFERENTIAL SHADING OF INDIVIDUAL GLASS LITES AND TO COMPLY WITH GLASS DESIGN REQUIREMENTS SPECIFIED IN "PERFORMANCE REQUIREMENTS" ARTICLE. PROVIDE KIND FT (FULLY TEMPERED) WHERE SAFETY GLASS IS
- OVERALL UNIT THICKNESS AND THICKNESS OF EACH LITE: DIMENSIONS INDICATED IN THE GLASS SCHEDULE ARE NOMINAL AND THE OVERALL THICKNESSES OF UNITS MEASURED PERPENDICULARLY FROM OUTER SURFACES OF GLASS LITES AT UNIT'S EDGE.
- 3. SEALING SYSTEM: DUAL SEAL, WITH PRIMARY AND SECONDARY SEALANTS AS FOLLOWS: a. RETAIN ONE SEALANT SYSTEM BELOW OR REVISE TO INSERT OTHER COMBINATIONS; CORRELATE WITH PRODUCTS/MANUFACTURERS SELECTED.
- 1) MANUFACTURER'S STANDARD SEALANTS. 4. SPACER SPECIFICATIONS: MANUFACTURER'S STANDARD SPACER MATERIAL AND CONSTRUCTION COMPLYING WITH THE FOLLOWING REQUIREMENTS:
- a. ALUMINUM WITH DARK BRONZE COLOR-ANODIZED FINISH.
- b. DESICCANT: MOLECULAR SIEVE OR SILICA GEL, OR BLEND OF BOTH.
- c. CORNER CONSTRUCTION: MANUFACTURER'S STANDARD CORNER CONSTRUCTION. 5. LOW E - SPUTTER-COATED FLOAT GLASS; ASTM C1376 APPLIED TO SURFACE #2.
- . MISCELLANEOUS GLAZING MATERIALS GENERAL: PROVIDE PRODUCTS OF MATERIAL, SIZE, AND SHAPE COMPLYING WITH REFERENCED GLAZING STANDARD, REQUIREMENTS OF MANUFACTURERS OF GLASS AND OTHER GLAZING MATERIALS FOR APPLICATION INDICATED, AND WITH A PROVEN RECORD OF COMPATIBILITY WITH SURFACES CONTACTED IN INSTALLATION.
- . CLEANERS, PRIMERS, AND SEALERS: TYPES RECOMMENDED BY SEALANT OR GASKET MANUFACTURER. 3. SETTING BLOCKS: ELASTOMERIC MATERIAL WITH A SHORE TYPE A DUROMETER HARDNESS OF 85,
- 4. SPACERS: ELASTOMERIC BLOCKS OR CONTINUOUS EXTRUSIONS WITH A SHORE TYPE A DUROMETER HARDNESS REQUIRED BY GLASS MANUFACTURER TO MAINTAIN GLASS LITES IN PLACE FOR
- 5. EDGE BLOCKS: ELASTOMERIC MATERIAL OF HARDNESS NEEDED TO LIMIT GLASS LATERAL MOVEMENT (SIDE WALKING).
- H. FABRICATION OF GLASS AND OTHER GLAZING PRODUCTS
- FABRICATE GLASS AND OTHER GLAZING PRODUCTS IN SIZES REQUIRED TO GLAZE OPENINGS INDICATED FOR PROJECT, WITH EDGE AND FACE CLEARANCES, EDGE AND SURFACE CONDITIONS, AND BITE COMPLYING WITH WRITTEN INSTRUCTIONS OF PRODUCT MANUFACTURER AND REFERENCED GLAZING STANDARD. TO COMPLY WITH SYSTEM PERFORMANCE REQUIREMENTS. 2. GRIND SMOOTH AND POLISH EXPOSED GLASS EDGES.
- EXAMINATION
- EXAMINE FRAMING GLAZING, WITH INSTALLER PRESENT, FOR COMPLIANCE WITH THE FOLLOWING: a. MANUFACTURING AND INSTALLATION TOLERANCES, INCLUDING THOSE FOR SIZE, SQUARENESS, AND OFFSETS AT CORNERS.
- b. PRESENCE AND FUNCTIONING OF WEEP SYSTEM.
- c. MINIMUM REQUIRED FACE OR EDGE CLEARANCES
- d. EFFECTIVE SEALING BETWEEN JOINTS OF GLASS-FRAMING MEMBERS.

THIN COURSE OF COMPATIBLE SEALANT SUITABLE FOR HEEL BEAD.

- 2. PROCEED WITH INSTALLATION ONLY AFTER UNSATISFACTORY CONDITIONS HAVE BEEN CORRECTED. PREPARATION
- 1. CLEAN GLAZING CHANNELS AND OTHER FRAMING MEMBERS RECEIVING GLASS IMMEDIATELY BEFORE GLAZING. REMOVE COATINGS NOT FIRMLY BONDED TO SUBSTRATES. K. GLAZING, GENERAL
- COMPLY WITH COMBINED WRITTEN INSTRUCTIONS OF MANUFACTURERS OF GLASS, SEALANTS, GASKETS, AND OTHER GLAZING MATERIALS, UNLESS MORE STRINGENT REQUIREMENTS ARE INDICATED, INCLUDING THOSE IN REFERENCED GLAZING PUBLICATIONS. GLAZING CHANNEL DIMENSIONS, AS INDICATED ON DRAWINGS, PROVIDE NECESSARY BITE ON GLASS,
- MINIMUM EDGE AND FACE CLEARANCES, AND ADEQUATE SEALANT THICKNESSES, WITH REASONABLE TOLERANCES. ADJUST AS REQUIRED BY PROJECT CONDITIONS DURING INSTALLATION. PROTECT GLASS EDGES FROM DAMAGE DURING HANDLING AND INSTALLATION. REMOVE DAMAGED GLASS FROM PROJECT SITE AND LEGALLY DISPOSE OF OFF PROJECT SITE. DAMAGED GLASS IS
- GLASS WITH EDGE DAMAGE OR OTHER IMPERFECTIONS THAT, WHEN INSTALLED, COULD WEAKEN GLASS AND IMPAIR PERFORMANCE AND APPEARANCE. 4. APPLY PRIMERS TO JOINT SURFACES WHERE REQUIRED FOR ADHESION OF SEALANTS, AS DETERMINED
- BY PRECONSTRUCTION SEALANT-SUBSTRATE TESTING. . INSTALL SETTING BLOCKS IN SILL RABBETS, SIZED AND LOCATED TO COMPLY WITH REFERENCED GLAZING PUBLICATIONS, UNLESS OTHERWISE REQUIRED BY GLASS MANUFACTURER. SET BLOCKS IN
- 6. DO NOT EXCEED EDGE PRESSURES PER GLASS MANUFACTURERS FOR INSTALLING GLASS LITES. a. PROVIDE SPACERS FOR GLASS LITES WHERE THE LENGTH PLUS WIDTH IS LARGER THAN 50 INCHES: LOCATE SPACERS DIRECTLY OPPOSITE EACH OTHER ON BOTH INSIDE AND OUTSIDE FACES OF GLASS. INSTALL CORRECT SIZE AND SPACING TO PRESERVE REQUIRED FACE CLEARANCES. UNLESS GASKETS AND GLAZING TAPES ARE USED THAT HAVE DEMONSTRATED ABILITY TO MAINTAIN REQUIRED FACE CLEARANCES AND TO COMPLY WITH SYSTEM PERFORMANCE
- REQUIREMENTS. b. PROVIDE 1/8-INCH (3-MM) MINIMUM BITE OF SPACERS ON GLASS AND USE THICKNESS EQUAL TO SEALANT WIDTH. WITH GLAZING TAPE, USE THICKNESS LESS THAN FINAL THICKNESS OF
- PROVIDE EDGE BLOCKING WHERE INDICATED OR NEEDED TO PREVENT GLASS LITES FROM MOVING SIDEWAYS IN GLAZING CHANNEL, AS RECOMMENDED IN WRITING BY GLASS MANUFACTURER AND ACCORDING TO REQUIREMENTS IN REFERENCED GLAZING PUBLICATIONS.

8. SET GLASS LITES IN EACH SERIES WITH UNIFORM PATTERN, DRAW, BOW, AND SIMILAR

CHARACTERISTICS. 9. GLASS STOPS ARE EXTRUDED ALUMINUM SNAP-IN TYPE FOR INTERIOR GLAZING OF GLASS OF PANELS 5/8" THICK (CUSTOM STOPS FOR THICKNESSES UP TO AN 1" ARE AVAILABLE) AND HAVE A

FIXED GASKET OF HIGH QUALITY ELASTOMERIC MATERIAL PERIMETER WOOL PILE AND ELASTOMERIC

10. GLASS MUST HAVE (5) FIVE YEAR WARRANTY AGAINST SEAL FAILURE. L. GLASS TYPES: REFER TO EXTERIOR MATERIALS AND FINISHES SCHEDULE ON DRAWINGS.

WEATHER-STRIP IS FACTORY APPLIED.

DIVISION 9 - FINISHES

NOTE: IT IS THE CONTRACTOR'S RESPONSIBILITY TO DETERMINE USE OF "CLASS A" OR "CLASS C" MATERIAL.

FLOOR AND WALL TILE INSTALLATION

- A. PROVIDE TILE WORK COMPLETE IN PLACE AS INDICATED ON DRAWINGS, SPECIFIED HEREIN. B. TILE WORK SHALL BE SUBJECT TO PERFORMANCE STANDARDS AS SET BY THE AMERICAN NATIONAL STANDARDS INSTITUTE (ANSI) SPECIFICATION A-137J-80 FOR CERAMIC TILE OR CTI-69-5 FOR SPECIAL
- PURPOSE TILE AND THE TILE COUNCIL OF AMERICA (TCA) CURRENT HANDBOOK FOR CERAMIC TILE
- C. DELIVER MATERIAL TO THE JOB SITE AND STORE IN ORIGINAL UNOPENED CARTONS WITH LABELS INTACT
- D. TILE SHOULD BE STORED IN A DRY COVERED AREA. E. TILE SHALL BE STANDARD GRADE IN ACCORDANCE WITH SPECIFICATIONS PUBLISHED BY ANSI A-137J-80 FOR CERAMIC TILE OR CTI-69-5 FOR SPECIAL PURPOSE TILE.
- 1. EXTERIOR DECORATIVE WALL TILE: SEE FINISH SCHEDULE. 2. INTERIOR FLOOR TILE: SEE FINISH SCHEDULE
- F. TILE SETTING, GROUTING MATERIALS, AND WATERPROOFING MEMBRANE: 1. BASIS-OF-DESIGN: LATICRETE INTERNATIONAL, INC.
- 2. APPROVED EQUAL: MAPEL CORPORATION. G. [MR-1] MEDIUM BED, MODIFIED-PORTLAND CEMENT THIN SET MORTAR: ISO 13007: C2EP1 / C2TES1PA

AND ANSI A118.15 AND CAPABLE OF BEING INSTALLED UP TO 1/4-INCH THICK.

- 1. PRODUCTS: LATICRETE: 4XLT OR MAPEI: ULTRA FLEX LFT. H. [MR-2] MODIFIED-PORTLAND CEMENT THIN SET MORTAR: ISO 13007: C2EP1 / C2TES1PA AND ANSI
- 1. PRODUCTS: LATICRETE: 254 PLATIUM THINSET OR MAPEI: ULTRA FLEX 2. I. [MR-3] FREEZE-THAW REGIONS - FAST SETTING, SECOND GENERATION, TWO-COMPONENT MORTAR
- CONSISTING OF LATEX ADDITIVE AND MORTAR; COMPLY WITH ANSI A118.4 AND ISO 13007 CLASSIFICATION: C2FS2P2. 1. PRODUCTS: LATICRETE: 4XLT RAPID OR MAPEI: GRANDI-RAPID.
- J. [MR-4] MODERATE REGIONS (NOT SUBJECT TO FREEZE-THAW CONDITIONS) FAST SETTING SINGLE COMPONENT POLYMER MODIFIED THIN SET MORTAR; COMPLY WITH ANSI A118.4 AND ISO 13007
- 1. PRODUCTS: LATICRETE: 4XLT RAPID OR MAPEI: ULTRA FLEX LFT.
- K. [GR-1] POLYMER-MODIFIED HIGH PERFORMANCE CEMENT TILE GROUT: ISO 13007: CG-2WAF AND
- 1. PRODUCTS: FOR JOINTS 1/8-INCH OR WIDER (SANDED GROUT): LATICRETE: PERMACOLOR OR MAPEI:
- 2. COLORS: SEE INTERIOR AND EXTERIOR FINISH SCHEDULES.
- _. [GR-2] CHEMICAL RESISTANT, WATER-CLEANABLE, INDUSTRIAL GRADE, TILE-GROUTING EPOXY: ISO 13007: R2 AND ANSI A118.5, RESISTANT TO ENZYMATIC CLEANERS. TEMPERATURE RESISTANT: PRODUCT CAPABLE OF WITHSTANDING CONTINUOUS AND INTERMITTENT EXPOSURE TO TEMPERATURES OF UP TO 140 DEG F AND 212 DEG, RESPECTIVELY, AND CERTIFIED IN WRITING BY MANUFACTURER FOR INTENDED
- 1. PRODUCTS: LATICRETE: SPECTRALOCK 2000 IG OR MAPEI: KERAPOXY IEG. 2. COLORS: SEE INTERIOR FINISH SCHEDULE.
- M. [GR-3] WATER-CLEANABLE, TILE-GROUTING EPOXY: ISO 13007: RG AND ANSI 118.5. 1. PRODUCTS: LATICRETE: SPECTRA LOCK PRO (USE SPECTRALOCK 2000 IG IF USING ENZYMATIC CLEANERS) OR MAPEI: KERAPOXY CQ.
- 2. COLORS: SEE INTERIOR FINISH SCHEDULE. N. [WM-1] INTERIOR WATERPROOFING MEMBRANE: COMPLY WITH ANSI A118.10. ADJOINING FLOOR AND WALL AREAS AT MOP SINK LOCATIONS OR WHERE INDICATED ON DRAWINGS, AND ELSEWHERE AS REQUIRED FOR WATERPROOFING TILE ASSEMBLY AS SPECIFIED IN ANSI A108.13.
- 1. PRODUCTS: LATICRETE: HYDROBAN OR MAPEI: AQUA DEFENSE O. [WM-2] EXTERIOR WATERPROOFING MEMBRANE: FLEXIBLE WATERPROOFING MEMBRANE.
- I. PRODUCTS: LATICRETE: HYDROBAN OR MAPEI: MAPELASTIC 315; MAPELASTIC FIBERGLASS MESH. P. THRESHOLDS: PROVIDE THRESHOLDS TO ADJUST BETWEEN TILE AND OTHER FLOOR FINISHES. Q. ACCEPTABILITY OF SURFACES: SURFACES TO BE TILED SHALL BE SMOOTH AND LEVEL FOR MORTAR BED
- AT THE REQUIRED FINISH ELEVATION, AND A STEEL TROWEL FINISH WITH A LIGHT BROOM TEXTURED FINISH WITHOUT MORE THAN THE FOLLOWING MAXIMUM VARIATIONS: 1. PORTLAND CEMENT MORTAR: WALLS AND CEILINGS - 1/4" IN 8"; FLOORS - 1/8" IN 10'-0".
- R. PREPARATION: PRIOR TO THE START OF LAYING TILE, SWEEP OR VACUUM AND WASH SURFACES TO BE COVERED. SURFACE SHOULD BE FREE FROM COATING, CURING COMPOUNDS, OIL, GREASE, WAX AND

2. DRY SET, LATEX AND CEMENT MORTARS: WALLS AND CEILINGS - 1/8" IN 8"; FLOORS - 1/8" IN

- S. JOB CONDITIONS: A MINIMUM TEMPERATURE OF 50 DEGREES F (10 DEGREES C) SHOULD BE MAINTAINED DURING TILE WORK AND FOR SEVEN (7) DAYS THEREAFTER. PROVIDE ADEQUATE LIGHTING
- FOR GOOD GROUTING AND CLEAN-UP. T. LAYOUT OF WORK: INTERIOR WALL AND FLOOR FINISH LAYOUTS AND PATTERNS FOR KITCHEN, RESTROOMS AND DINING ROOM SHALL BE AS SHOWN ON INTERIOR ELEVATIONS AND FLOOR TILE PLAN. REFER TO THE FINISH SCHEDULE. DETERMINE LOCATIONS OF MOVEMENT (EXPANSION) JOINTS BEFORE STARTING TILE WORK. LAYOUT TILE WORK SO AS TO MINIMIZE CUTS LESS THAN ONE HALF TILE IN SIZE. LOCATE CUTS IN BOTH WALLS AND FLOORS SO AS TO BE LEAST CONSPICUOUS.
- U. SETTING METHODS: SET TO TILE COUNCIL OF AMERICA SPECIFICATIONS WALLS W242-98 AND FLOORS F113-98.

V. GROUTING: FOLLOW MANUFACTURER'S RECOMMENDATIONS AS TO GROUTING PROCEDURES AND PRECAUTIONS. REMOVE GROUT HAZE, OBSERVING GROUT MANUFACTURER'S RECOMMENDATIONS AS TO THE USE OF VARIOUS CLEANERS. FLOOR TILE GROUT TO BE 1/4" WIDE; WALL TILE GROUT TO BE 1/16"

- W. FINISHING: THOROUGHLY RINSE TILE WORK. USE NEUTRAL CLEANER WITH ABRASIVE ADDITIVE (WALTER G. LEGGE'S "TEXSPAR" OR EQUAL) FOR FINAL CLEANING. ACID CLEANERS ARE NOT RECOMMENDED
- 1. USE MIXTURE OF 75% WATER AND 25% MAPEI KARACLEAN TO CLEAN TILE SURFACE (EQUAL LATICRETE TILE CLEANER 1:3 DILUTION RATIO). APPLY AND BUFF.
- 2. USE PHOSPHORIC ACID OR SULFAMIC ACID ONLY FOR REMOVAL OF GROUT RESIDUE. DO NOT USE MURIATIC ACID.

GYPSUM DRYWALL

- A. FURNISH MATERIAL AND LABOR NECESSARY TO PROVIDE FINISHED DRYWALL SURFACES IN AREAS SCHEDULED TO RECEIVE THIS FINISH ON THE DRAWINGS. TAPE, SPACKLE AND SAND SURFACES TO RECEIVE PAINT. REPEAT AS REQUIRED.
- B. DRYWALL OVER FURRING AND WOOD STUDS SHALL BE 5/8" FIRECODE GYPSUM. MATERIALS SHALL BE STANDARD PRODUCTS MANUFACTURED BY US GYPSUM, NATIONAL GYPSUM OR GOLD BOND GYPSUM COMPANY.

SUSPENDED CEILING SYSTEM

- A. FURNISH MATERIALS AND LABOR TO PROVIDE A COMPLETE SUSPENDED CEILING INCLUDING CEILING TILE, HANGERS, GRID TEES, AND MOLDINGS.
- B. ACOUSTICAL CEILING MATERIALS IN THE DINING ROOM AT THE PERIMETER CEILING, RE: CT-2 ON FINISH
- C. ACOUSTICAL CEILING MATERIALS IN THE DINING ROOM AT CENTRAL ACCENT CEILINGS, RE: CT-3 ON FINISH SCHEDULE
- D. CEILING IN THE KITCHEN, RE: CT-1 ON FINISH SCHEDULE
- E. THE CEILING IN THE RESTROOMS SHALL BE SMOOTH, PAINTED GYPSUM DRYWALL. 1. COLOR: SEE THE FINISH SCHEDULE.
- F. THE CEILING SOFFITS IN THE DINING AREA SHALL BE SMOOTH, PAINTED GYPSUM DRYWALL. 1. COLOR: SEE THE FINISH SCHEDULE.

WALLCOVERING

- A. WALLCOVERINGS INDICATED ON THE DRAWINGS TO BE SUPPLIED BY APPROVED SUPPLIERS AND INSTALLED BY GENERAL CONTRACTOR. REFER TO THE FINISH SCHEDULE FOR MATERIAL SPECIFICATIONS. (CONTRACTOR TO VERIFY QUANTITIES PRIOR TO START OF CONSTRUCTION).
- B. PREPARATION: SURFACES MUST BE STRUCTURALLY SOUND, SMOOTH, CLEAN AND DRY. MOISTURE CONTENT OF WALLS SHOULD NOT EXCEED (5%) 5-PERCENT.
- C. DRYWALL SURFACES MUST BE FINISHED AS TO RECEIVE PAINT. APPLY ONE COAT OF A WATER BASED PRIMER SUCH AS ZINSSER SHIELDZ #2501 VINYL PRIMER TO SEAL AND SIZE THE SURFACE.
- D. INSTALLATION: APPLY VINYL WALLCOVERINGS USING A PRE-MIXED VINYL ADHESIVE WITH MILDEW INHIBITOR (ZINSSER SURE GRIP-122, #2881 OR EQUAL). BRUSH OR ROLL ADHESIVE UNIFORMLY GIVING ATTENTION TO EDGES. USE APPROXIMATELY ONE GALLON PER 10-12 LINEAR YARDS. PASTE AND ROLL ALLOWING MATERIAL TO STAND FOR AT LEAST FIVE MINUTES. HANG ON WALL USING BUTT PROCEDURE. ROLL SEAMS LIGHTLY AND SMOOTH OUT BLISTERS AS REQUIRED.

NON-TILE FIBERGLASS REINFORCED POLYESTER (FRP) PANELS

- A. NON TILE WALL FINISH FRP (FOOD PREP AREA): SEE FINISH SCHEDULE B. TEXTURED FIBERGLASS REINFORCED POLYESTER (FRP) PANELS SANITARY WALL SYSTEMS TO BE FRP PANEL. INSTALL 4'X9'X1/8 PANEL WITH HARMONIZING PVC MOLDINGS, ADHESIVE AND SEALANTS IN STRICT ACCORDANCE WITH MANUFACTURERS WRITTEN INSTALLATION INSTRUCTIONS, AS MANUFACTURED BY MARLITE OR KEMLITE GLASBORD.
- C. NON-TILE WALL FINISH (DINING ROOM AREA): SEE FINISH SCHEDULE.

- A. PROVIDE MATERIALS, LABOR, TOOLS AND EQUIPMENT REQUIRED TO COMPLETE THE PAINTING OF BUILDING AS SPECIFIED.
- B. WORKMANSHIP 1. MATERIALS SHALL BE APPLIED FREE FROM RUNS, SAGS, WRINKLES, STREAKS, SHINERS AND BRUSH
- 2. MATERIALS SHALL BE APPLIED UNIFORMLY. IF REDUCTION OF THE COATINGS VISCOSITY IS
- NECESSARY, IT SHALL BE DONE IN ACCORDANCE WITH THE MANUFACTURER'S LABEL DIRECTIONS. . NEW PLASTER AND OTHER MASONRY SURFACES SHALL NOT BE PRIMED UNTIL IT HAS BEEN DETERMINED THESE SUBSTRATES HAVE DRIED SUFFICIENTLY TO SAFELY ACCEPT PAINT. A RELIABLE ELECTRONIC MOISTURE METER SHOULD BE USED TO MAKE THIS DETERMINATION. UNACCEPTABLE
- 4. A MINIMUM INTERIOR TEMPERATURE OF 65 DEGREES F SHALL BE MAINTAINED DURING THE ACTUAL APPLICATION AND DRYING OF THE PAINT, AND UNTIL OCCUPANCY OF THE BUILDING OCCURS. ADEQUATE VENTILATION SHALL BE MAINTAINED TO CONTROL EXCESSIVE HUMIDITY WHICH WILL ADVERSELY AFFECT THE CURING OF COATINGS. THE GENERAL CONTRACTOR IS SOLELY RESPONSIBLE FOR MAINTAINING SUITABLE TEMPERATURES AND VENTILATION.
- 5. BEFORE PAINTING BEGINS, VERIFY WORK THAT CREATES DUST OR DEBRIS HAS BEEN COMPLETED. THE ROOMS OR AREAS ARE TO BE LEFT IN BROOM CLEAN CONDITION.
- 6. ENAMEL AND VARNISH UNDERCOATS ARE TO BE SANDED PRIOR TO THE RECOATING. TOP AND BOTTOMS OF DOORS ARE TO BE FINISHED IN THE SAME MANNER AS DOOR FACING. 7. NO EXTERIOR PAINTING SHALL BE UNDERTAKEN IF AIR OR SURFACE TEMPERATURE IS BELOW 50 DEGREES F. NOR IMMEDIATELY FOLLOWING RAIN OR UNTIL FROST. DEW OR CONDENSATION HAS EVAPORATED. SURFACES SHOULD ALWAYS BE TESTED WITH MOISTURE METER BEFORE PROCEEDING.

MOISTURE CONTENT SHOULD BE REPORTED TO THE ARCHITECT OR HIS REPRESENTATIVE.

- C. PREPARATION OF SURFACES:
- 1. DO NOT COMMENCE WORK UNTIL SURFACE IS IN PROPER CONDITION. 2. SURFACES ARE TO BE CLEAN. IF FOR ANY REASON THE SURFACE CANNOT BE CLEANED, THIS CONDITION SHALL BE PROMPTLY REPORTED TO THE GENERAL CONTRACTOR AND OWNER.
- 3. THE PRIME COAT SHOULD BE APPLIED SOON AFTER SURFACE PREPARATION HAS BEEN COMPLETED. TO PREVENT CONTAMINATION OF THE SUBSTRATE.

OF THE OWNER, SHALL BE REMOVED OR CORRECTED AND/OR REPAINTED AS APPROVED BY THE OWNER.

D. INSPECTION: WORK NOT CONFORMING TO THE SPECIFICATIONS OR NOT MEETING WITH THE APPROVAL

- PAINT SCHEDULE
- A. EXTERIOR ITEMS: REFER TO EXTERIOR FINISH SCHEDULE. B. INTERIOR WOOD TRIM: EXISTING OR NEW INTERIOR WOOD TRIM TO BE FINISHED TO MATCH WALL FINISH. REFER TO FINISH SCHEDULE.

DIVISION 10 - SPECIALTIES

GENERAL SIGNAGE

- A. FOR BUILDING, FREE-STANDING PYLON, AND GROUND AND DIRECTIONAL SIGNS: 1. NEW STORES: WHITE WENDY'S LETTERS ON RED BACKGROUND, POLES AND HARDWARE PAINTED PPG
- "BRILLIANT RED." 2. REMODEL STORES: NEW SIGN FACE, BODY REPAINTED PPG "BRILLIANT RED."
- B. SIGNAGE INCLUDING MENU AND SPEAKER SIGNS SHALL BE FURNISHED BY OWNER AND INSTALLED BY LICENSED SIGN ERECTOR. SEE APPROVED SIGN MANUFACTURERS LIST.
- C. BUILDING SIGNS: 1. COORDINATE BUILDING IDENTITY SIGNS WITH WENDY'S REGIONAL ENGINEER.
- 2. SIGNS TO BE PROVIDED AND INSTALLED BY MANUFACTURER FROM APPROVED SIGN MANUFACTURERS
- D. MENU BOARDS (INTERIOR AND EXTERIOR): SEE LISTING OF APPROVED SIGN MANUFACTURERS. 1. BUILDINGS REQUIRE:
- a. ONE EXTERIOR BURGUNDY MENU BOARD WITH ORDER CONFIRMATION SYSTEM WITHIN SPEAKER
- PEDESTAL.
- b. ONE INTERIOR MENU BOARD, SOFFIT MOUNTED: 1) FOUNDER'S LITE DESIGN ONLY: ONE BACKLIT BURGUNDY 8 PANEL MENU BOARD.

2) FRESH, SIMPLE AND FOUNDERS DESIGNS: ONE FRAMED MAGNETIC 7 PANEL MENU BOARD. (SEE FINISH SCHEDULE FOR FRAME AND MAGNETIC STRIP COLOR)

ROOM IDENTIFICATION SIGN A. IDENTIFICATION SIGNS FURNISHED BY OWNER AND INSTALLED BY GENERAL CONTRACTOR. PRODUCED BY

A.D.A. RESTROOM IDENTIFICATION SIGN

- A. SIGN SHALL BE 6" X 8" BEIGE WITH CONTRASTING BROWN ICONS IN COMPLIANCE WITH CURRENT ADAAG STANDARDS SECTION 703. SIGN SHALL BE MOUNTED ON WALL (LATCH SIDE OF DOOR).
- TOILET COMPARTMENTS A. FLOOR MOUNTED, OVERHEAD BRACED STAINLESS STEEL TOILET PARTITIONS: ACCURATE PARTITIONS CORP
- 1. URINAL SCREEN STYLE: WALL HUNG. 2. HARDWARE: HEAVY DUTY STAINLESS STEEL TAMPER-RESISTANT FASTENERS.
- a. HINGES: CONTINUOUS PIANO HINGES. b. LATCH AND KEEPER: SURFACE MOUNTED SLIDE WITH ADA PADDLE HANDLES AT ACCESSIBLE
- c. DOOR PULLS: STANDARD UNITS.

PROJECT DRAWINGS FOR ACCESSORY SPECIFICATION AND LOCATIONS.

d. BRACKETS: CONTINUOUS STAINLESS STEEL.

SCHEDULE AND WENDY'S REGIONAL ENGINEER.

- B. FINISH: SATIN FINISH. C. PROVIDE BLOCKING IN THE WALLS WHERE REQUIRED FOR TOILET PARTITION ATTACHMENT.
- D. INSTALL PARTITIONS ACCURATELY PER ADA REQUIREMENTS.

PUBLIC RESTROOM ACCESSORIES

1. OPTIONAL WHERE REQUIRED BY LOCAL AUTHORITIES: HAND DRYER: XLERATOR #XL-SB HAND DRYER WITH ADA COMPLIANCE RECESS KIT. FURNISHED BY OWNER AND INSTALLED BY CONTRACTOR.

A. TOILET ROOM ACCESSORIES TO BE PROVIDED AND INSTALLED BY THE GENERAL CONTRACTOR. SEE

DECOR. REFER TO "MISCELLANEOUS—FINISH SCHEDULE" AND WENDY'S REGIONAL ENGINEER FOR ALL

1. MISCELLANEOUS ITEMS: FURNISHINGS: VERIFY ALL MATERIALS AND FINISHES WITH THE FINISH

A. FRAMED ARTWORK TO BE MOUNTED TO WALLS WITH CONCEALED SECURITY HARDWARE SUPPLIED WITH

STAINLESS STEEL CORNERS A. 18 GAUGE STAINLESS STEEL WRAP STYLE CORNER PROTECTORS IN KITCHEN AREA. INSTALL PRIOR TO FLOOR AND WALL TILE IN ACCORDANCE WITH LOCATIONS NOTED ON EQUIPMENT PLAN. SUPPLIED BY S&G METAL WORKS OR EQUAL, INSTALLED BY GENERAL CONTRACTOR.

SITE NUMBER: BASE MODEL: CONVERSION ASSET TYPE: FRANCHISE CLASSIFICATION: REFRESH OWNER: JARO FOODS BASE VERSION: 2015 OCT 16

UPGRADE CLASSIFICATION:

STANDARD
2015
2015

Wallin - Gomez Architects, Ltd.

711 South Dearborn Street Suite 606 Chicago, IL 60605

DESIGN BULLETINS:

Tel: 312-427-4702 Fax: 312-427-6611 e-mail: admin@wgaltd.com



01-08-16 ISSUED FOR PERMIT & BID

PLOT DATE 1/8/2016 PROJECT NUMBER 15130 DRAWN BY CL/KH

CHECKED BY DJW


STATE OF INDIANA

REGISTERED ARCHITECT

AR19500067

NOTICE: THIS DOCUMENT CONTAINS PROPRIETARY INFORMATION, IT SHALL NOT BE USED OR REPRODUCED OR ITS CONTENTS DISCLOSED . IN WHOLE OR IN PART WITHOUT THE PRIOR WRITTEN CONSENT OF WALLIN / GOMEZ ARCHITECTS, LTD.

THESE DRAWINGS HAVE BEEN PREPARED AT AND / OR UNDER MY SUPERVISION AND TO THE BEST OF MY KNOWLEDGE AND BELIEF CONFORM AND COMPLY WITH THE REQUIREMENTS OF THE DEPARTMENT OF BUILDING AND CODES HAVING JURISDICTION.

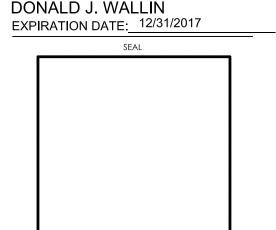

SPECIFICATIONS

DIVISION 22 - PLUMBING

- A. PROVIDE LABOR, EQUIPMENT, AND MATERIALS NECESSARY TO EXECUTE THE PLUMBING WORK INDICATED A. PROVIDE A COMPLETE ELECTRICAL SYSTEM AS INDICATED ON THE DRAWINGS AND DESCRIBED HEREIN. ON THE DRAWINGS, AND AS REQUIRED BY LOCAL CODES AND ORDINANCES.
- B. INCLUDE PIPING; DOMESTIC HOT AND COLD WATER, SANITARY AND SUPPLY AND HOOK-UP OF FIXTURES PIPING AND EQUIPMENT CONNECTIONS WHERE REQUIRED.
- C. INCLUDE ITEMS, SUCH AS FITTINGS, ETC. NOT MENTIONED BUT UNDERSTOOD AS NECESSARY TO COMPLETE THE PLUMBING SYSTEM.
- D. WASTE, AND VENT PIPING TO BE OF MATERIAL APPROVED BY LOCAL CODES.
- E. PROVIDE CLEANOUTS FOR WASTE LINES AS SHOWN ON DRAWINGS, AND OF TYPE APPROVED BY LOCAL
- F. WATER SUPPLY PIPING BELOW GROUND SHALL BE TYPE K SOFT COPPER TUBING, (AVOID FITTINGS BELOW SLAB WHENEVER POSSIBLE). WATER SUPPLY PIPING ABOVE GROUND SHALL BE TYPE L HARD COPPER
- G. PROVIDE FOR DRAINING WATER SYSTEM, AND CAP STUBS UNTIL FINISH WORK IS INSTALLED.
- H. PROVIDE STOPS ON WATER SUPPLIES TO EACH FIXTURE. I. INCLUDE GAS PIPING FOR HEATING SYSTEMS WITH GAS-FIRED EQUIPMENT. GAS PIPING SHALL BE STANDARD WEIGHT, BLACK STEEL PIPE, SCHEDULE 40. PIPING EXPOSED TO ATMOSPHERE OR RUN BELOW GRADE SHALL HAVE POLYETHYLENE PLASTIC COATING. GAS PIPING, FITTINGS AND INSTALLATION SHALL BE IN ACCORDANCE WITH REQUIREMENTS OF UTILITY COMPANY AND GOVERNING BODIES.
- J. INSULATE COLD AND HOT WATER PIPING WITH ARMSTRONG COMPANY ARMAFLEX "11" PIPE INSULATION. SEAL JOINTS WITH ARMSTRONG 520 ADHESIVE. IMPORTANT - HOLD COLD AND HOT WATER PIPING TO WARM SIDE OF INSULATION TO PROHIBIT FREEZING. INSULATION SHALL MEET FLAME SPREAD AND SMOKE DEVELOPED RATINGS REQUIRED BY LOCAL CODES.
- K. PLUMBING FIXTURES SHALL BE FURNISHED AND INSTALLED WHERE SHOWN ON THE DRAWINGS. FIXTURE FITTINGS AND EXPOSED FIXTURE PIPING SHALL BE BRASS CHROMIUM PLATED. TRAPS SHALL BE CAST BRASS. FIXTURES SHALL BE WHITE, FIXTURES SHALL BE AS MANUFACTURED BY AMERICAN STANDARD, KOHLER OR CRANE AND EQUAL IN ALL RESPECTS TO FIXTURES SPECIFIED. CLOSET SEATS SHALL BE
- L. FIXTURES AND EQUIPMENT FIXTURES AND EQUIPMENT BY OTHERS. ROUGH-IN FINAL CONNECTIONS OF REQUIRED WASTE, VENT, AND WATER SUPPLY PIPING BY CONTRACTOR. SUPPLY PIPING SHALL BE
- M. GUARANTEE WORK INSTALLED UNDER THE CONTRACT TO BE FREE FROM DEFECTIVE WORKMANSHIP OR MATERIALS, USUAL WEAR EXPECTED, AND SHOULD SUCH DEFECTS DEVELOP WITHIN A PERIOD OF ONE YEAR AFTER ACCEPTANCE OF THE BUILDING BY THE OWNER, THIS CONTRACTOR SHALL REPAIR AND/OR REPLACE DEFECTIVE ITEMS AND DAMAGE RESULTING FROM FAILURE OF THESE ITEMS, AT NO EXPENSE WHATSOEVER TO THE OWNER.
- N. BACKFLOW PREVENTOR TO BE INSTALLED WHEN REQUIRED BY LOCAL CODE AND IS TO BE PROVIDED BY AND INSTALLED BY THE CONTRACTOR.
- O. SUPPLY AND INSTALL PREMADE GAS COOKING EQUIPMENT MANIFOLD AS SHOWN IN DRAWINGS SUPPLIED BY S&G METAL WORKS.

DIVISION 23 - HEATING. VENTILATING & AIR CONDITIONING

- WORK INDICATED ON THE DRAWINGS AND AS REQUIRED BY LOCAL CODES AND ORDINANCES.
- B. INCLUDED IN THIS SECTION IS WORK TO INSTALL ROOM VENTS AS SHOWN ON THE DRAWINGS. SCHEDULED ON THE DRAWINGS; AND INSULATION OF DESIGNATED PIPING RUNS SHALL ALSO INCLUDE GAS C. FURNISH AND INSTALL HEATING AND COOLING UNITS AS INDICATED ON THE DRAWINGS. HEATING AND VENTILATING UNITS INDICATED ON THE DRAWINGS AND HEREINAFTER SPECIFIED ARE DESIGNED TO MEET ASHRAE 90-65 BASED ON COLUMBUS, OHIO DESIGN CONDITIONS OF 93 DEG. F SUMMER AND O DEG. F
 - D. DIFFUSERS, REGISTERS, LOUVERS SHALL BE AS PER MODEL AND SIZE INDICATED ON DRAWINGS. NO SUBSTITUTES SHALL BE ACCEPTED UNLESS APPROVED BY THE OWNER OR ARCHITECT IN WRITING. DIFFUSERS AND LOUVERS NOT MEETING SPECIFICATION AS SHOWN ON DRAWINGS SHALL BE REPLACED AT CONTRACTOR'S EXPENSE.
 - E. BEFORE FINAL ACCEPTANCE BY OWNER, AN OWNER'S REPRESENTATIVE SHALL CHECK ENTIRE HVAC SYSTEM AND SUBMIT A WRITTEN REPORT TO THE OWNER. FINAL BALANCE OF HVAC SYSTEM SHALL BE PERFORMED BY MECHANICAL CONTRACTOR. NO FINAL PAYMENT WILL BE MADE UNTIL THE ABOVE REPORT HAS BEEN RECEIVED AND HVAC SYSTEMS ARE IN BALANCE.
 - F. WHERE REQUIRED BY GOVERNING ORDINANCES, PROVIDE FIRE DAMPERS CONFORMING TO NFPA 90A. SUPPLY DUCTS TO HAVE 1 1/2" (R-8 MIN) FIBERGLASS INSULATION. EXHAUST INSTALLATION SHALL
 - CONFORM TO NFPA 96. G. WHERE REQUIRED, PROVIDE CLASS "B" GAS VENT FLUES COMPLETE WITH CAP, COLLAR AND FLASHING.
 - THE DRAWINGS. THERMOSTAT SHALL PROVIDE FOR AUTOMATIC AND MANUAL FAN OPERATION. I. INSTALL AND CONNECT THE COMPLETE SYSTEM IN STRICT ACCORDANCE WITH GOVERNING CODES,
 - ORDINANCES AND THE LATEST CODES AND MANUALS OF THE NATIONAL WARM AIR HEATING AND AIR CONDITIONING ASSOCIATION. J. ADJUST CONTROLS AND EQUIPMENT FOR PROPER OPERATION. LUBRICATE AND CLEAN EQUIPMENT PRIOR
 - TO ACCEPTANCE OF BUILDING OWNER.
 - K. FURNISH THE OWNER WITH OPERATING MANUALS AND MAINTENANCE INSTRUCTIONS FOR EQUIPMENT INSTALLED.
 - L. GUARANTEE WORK INSTALLED UNDER THE CONTRACT TO BE FREE FROM THE DEFECTIVE WORKMANSHIP AND MATERIALS, USUAL WEAR EXPECTED, AND SHOULD SUCH DEFECTS DEVELOP WITHIN A PERIOD OF ONE YEAR AFTER ACCEPTANCE OF THE BUILDING BY THE OWNER, REPAIR AND/OR REPLACE DEFECTIVE ITEMS AND DAMAGE RESULTING FROM FAILURE OF THESE ITEMS, AT NO EXPENSE WHATSOEVER TO THE

DIVISION 26 - ELECTRICAL

- B. ELECTRIC WORK SHALL COMPLY WITH THE LATEST NATIONAL ELECTRIC CODE AS WELL AS STATE AND LOCAL GOVERNING CODES.
- C. PAY FOR PERMITS AND INSPECTIONS AND PROVIDE A CERTIFICATE OF INSPECTION.
- D. PROVIDE REQUIRED SERVICE AND EQUIPMENT GROUNDING SYSTEMS. THE CONDUIT SYSTEM SHALL BE ELECTRICALLY CONTINUOUS AND SHALL BE SAFELY GROUNDED AT THE DISTRIBUTION PANEL. DEVICES SHALL BE BONDED TO THE CONDUIT SYSTEM. PROVIDE A SEPARATE GROUNDING CONDUCTOR IN EACH CONDUIT, #12 MINIMUM OR AS SHOWN ON DRAWINGS.
- E. MATERIALS SHALL BE NEW WITH MANUFACTURER'S NAME PRINTED THEREON AND UNDERWRITER'S LABORATORY LISTED. THE SELECTION OF MATERIALS AND EQUIPMENT TO BE PROVIDED UNDER THIS CONTRACT SHALL BE IN STRICT ACCORDANCE WITH THE SPECIFICATIONS AND DRAWINGS. F. SUBMIT TO THE ARCHITECT FOR APPROVAL 8 COPIES OF EQUIPMENT AS FOLLOWS: PANELBOARDS,
- DISCONNECT SWITCHES AND LIGHTING FIXTURES. G. IDENTIFY DISCONNECT SWITCHES WITH LAMINATED PHENOLIC NAME PLATES WITH 1/4" MINIMUM HEIGHT
- H. PROVIDE POWER WIRING AND HOOK-UP FOR EACH MECHANICAL AND KITCHEN EQUIPMENT ITEM. MOUNT, PROVIDE WIRING, AND MAKE FINAL CONNECTIONS TO EQUIPMENT CONTROL PANELS (WHICH INCLUDE PREWIRED STARTERS, RELAYS, ETC.). FURNISH AND INSTALL STARTERS WHICH ARE NOT FURNISHED AS A PART OF MECHANICAL EQUIPMENT.
- H. INSTALL THERMOSTAT COMPLETE WITH NECESSARY WIRING AND CONTROLS, LOCATION AS INDICATED ON I. PROVIDE DEVICES, WIRING AND HOOK—UP FOR THE EMERGENCY KITCHEN SHUTDOWN SYSTEM AS DESCRIBED AND SPECIFIED ON DRAWINGS. WIRING SHALL BE IN CONDUIT. J. DISCONNECT SWITCHES SHALL BE THE HEAVY DUTY TYPE IN NEMA I ENCLOSURE OR EQUAL BY SQUARE D OR ARROW-HART. SWITCHES SHALL BE QUICK-MAKE, QUICK-BREAK, EXTERNALLY OPERATED AND
 - INTERLOCKED. K. SWITCHES SHALL BE 20 AMP HUBBELL 1221-1 SINGLE POLE OR 1223-1 THREE WAY. DUPLEX RECEPTACLES SHALL BE 20 AMP HUBBELL 5362-1. PASS AND SEYMOUR, ARROW-HART AND BRYANT SHALL BE CONSIDERED AS EQUAL. GROUND FAULT INTERRUPTING SHALL BE G.E. TGTR115F. COVER PLATES SHALL BE SIERRA (PASS AND SEYMOUR). SWITCH PLATES TO BE SERIES #S-IN. DUPLEX PLATES TO BE SERIES #S-IN. DUPLEX PLATES IN DINING ROOM TO BE #P-8 ETC. COVER PLATES TO HAVE SATIN FINISH #302 STAINLESS STEEL.
 - L. TEST ELECTRICAL SYSTEM FOR SHORT CIRCUITS AND MEGGER TEST FEEDERS AND BRANCH CIRCUIT WIRING, INSURE LOW IMPEDANCE GROUND SYSTEM.
 - M. FOR SERVICE AND PANEL FEEDER WIRING, USE TYPE THHN CABLE. USE TW CABLE FOR INTERIOR BRANCH CIRCUIT WIRING EXCEPT AS NOTED. DESIGN IS BASED ON COPPER CONDUCTORS AND COPPER WIRING. MINIMUM #12 AWG. WIRING SHALL BE IN CONDUIT. SPLICE WIRES #6 AWG. AND LARGER WITH APPROVED SOLDERLESS CONNECTORS SUCH AS ILSCO PROPERLY TAPED AND INSULATED. SPLICE SMALLER WIRES WITH MECHANICAL CONNECTORS SUCH AS 3M "SCOTCHLOCK" TYPE R.
 - N. PROVIDE RIGID GALVANIZED STEEL HEAVY WALL CONDUIT OR PLASTIC CONDUIT FOR SERVICE AND PANEL FEEDER CONDUITS. FITTINGS SHALL BE STEEL. THREADED, SET-SCREW TYPE WITH INSULATED THROATS. FURNISH EMT CONDUIT FOR INTERIOR WIRING WHERE PHYSICAL DAMAGE IS NOT A CONSIDERATION. MINIMUM CONDUIT SIZE IS 3/4" EXCEPT FOR FLEXIBLE RUNOUTS TO FIXTURES, MOTORS, ETC. WHICH MAY BE 1/2".
 - O. CONDUIT SHALL BE CONCEALED WHEREVER POSSIBLE AND SHALL BE RUN PARALLEL OR PERPENDICULAR TO BUILDING WALLS AND CEILINGS.
 - P. CONDUIT INSTALLED IN OR BELOW SLAB SHALL BE GALVANIZED RIGID CONDUIT OR PLASTIC CONDUIT. NO CONDUIT LARGER THAN 1-1/2" DIAMETER WILL BE INSTALLED IN SLAB.
 - Q. PROVIDE STRUCTURAL STEEL FRAMEWORK AND HANGING RODS WITH BRACES AND ACCESSORIES WHERE REQUIRED TO HOLD EQUIPMENT IN FINAL POSITION. PROVIDE STEEL SHAPES AND FRAMES TO SUPPORT
 - WALL MOUNTED EQUIPMENT WHERE NORMAL WALL STRENGTH MAY BE INADEQUATE. R. ELECTRICAL DEVICES, MOTOR STARTERS, DISCONNECT SWITCHES, ETC. SHALL BE SUPPORTED
 - INDEPENDENT OF AND ISOLATED FROM EQUIPMENT VIBRATION. S. COORDINATE INTERIOR WIRING CONNECTIONS NEEDED DURING ASSEMBLY OF KITCHEN EQUIPMENT WITH
 - KITCHEN EQUIPMENT SUPPLIER . T. PROVIDE POWER TO CASH REGISTERS WITH THE FOLLOWING GROUNDING REQUIREMENTS.
 - 1. SYSTEM POWER AND GROUND MUST BE MADE ONLY AT THE MAIN ENTRANCE PANEL. THE GROUND CONDUCTOR MUST BE OF INSULATED WIRE EQUAL IN SIZE TO THE POWER CONDUCTOR (CONDUIT MAY NOT BE USED AS THE GROUND CONDUCTOR).
 - 2. THE GROUND CONDUCTOR MUST NOT BE USED AS A RETURN OR NEUTRAL CONDUCTOR FOR ANY EQUIPMENT AND MUST NOT BE USED AS A GROUND FOR ANY EQUIPMENT OTHER THAN CASH REGISTER EQUIPMENT.
 - 3. RECEPTACLES FOR THE REGISTERS MUST BE 2 POLE, 3 WIRE, 120 VOLTS, 20 AMPERES. THE
 - GROUND MUST BE INSULATED FROM THE MOUNTING HARDWARE (HUBBEL 1G5362). 4. FOR ADDITIONAL INFORMATION, IF REQUIRED, CONTACT WENDY'S INTERNATIONAL, INC., 4288 W.
 - DUBLIN-GRANVILLE ROAD, DUBLIN, OH. 5. THE REGISTER CONDUITS MUST NOT BE USED FOR OTHER EQUIPMENT.
 - T. PROVIDE FIXTURES AS LISTED ON LIGHTING FIXTURE SCHEDULE. PROVIDE NECESSARY MOUNTING HARDWARE FOR A COMPLETE INSTALLATION. PROVIDE LAMPS, BALLASTS AND SPECIAL CONTROLS.
 - RECESSED LIGHT FIXTURES SHALL BE GASKETED OR CAULKED AND IC RATED. U. GUARANTEE WORK INSTALLED UNDER THE CONTRACT TO BE FREE FROM DEFECTIVE WORKMANSHIP AND MATERIALS, USUAL WEAR EXPECTED, AND SHOULD SUCH DEFECTS DEVELOP WITHIN A PERIOD OF ONE YEAR AFTER ACCEPTANCE OF THE BUILDING BY THE OWNER, REPAIR AND/OR REPLACE DEFECTIVE ITEMS AND DAMAGE RESULTING FROM FAILURE OF THESE ITEMS, AT NO EXPENSE WHATSOEVER TO THE OWNER.

SITE NUMBER:	07588
BASE MODEL:	CONVERSION
ASSET TYPE:	FRANCHISE
CLASSIFICATION:	REFRESH
OWNER:	JARO FOODS
BASE VERSION:	2015 OCT 16
UPGRADE CLASSIFICATION:	

STANDARD PROJECT YEAR: 2015 FURNITURE PACKAGE: 2015

DESIGN BULLETINS:

Wallin - Gomez Architects, Ltd.

711 South Dearborn Street Suite 606 Chicago, IL 60605

Tel: 312-427-4702 Fax: 312-427-6611 e-mail: admin@wgaltd.com

01-08-16 ISSUED FOR PERMIT & BID

PROJECT NUMBER 15130

DRAWN BY CL/KH

CHECKED BY DJW PROPRIETARY INFORMATION. IT SHALL NOT BE USED OR REPRODUCED OR ITS CONTENTS DISCLOSED, IN WHOLE OR IN PART WITHOUT THE PRIOR WRITTEN CONSENT OF WALLIN /

GOMEZ ARCHITECTS, LTD. THESE DRAWINGS HAVE BEEN PREPARED AT AND / OR UNDER MY SUPERVISION AND TO THE BEST OF MY KNOWLEDGE AND BELIEF CONFORM AND COMPLY WITH THE REQUIREMENTS OF THE DEPARTMENT OF BUILDING AND CODES HAVING JURISDICTION.

STATE OF INDIANA AR19500067 REGISTERED ARCHITECT DONALD J. WALLIN EXPIRATION DATE: 12/31/2017

